


**TOTAL
INSULATED WALL AREA 4122 SQFT
UNPROTECTED OPENINGS 818 SQFT
PERCENTAGE USED 19.5 %**

GROUND FLOOR 1549 SQFT	143.96 sm
SECOND FLOOR 1370 SQFT	127.32 sm
TOTAL 2919 SQFT	271.78 sm
IN-LAW SUITE 654 SQFT	
GARAGE 791 SQFT	73.51 sm

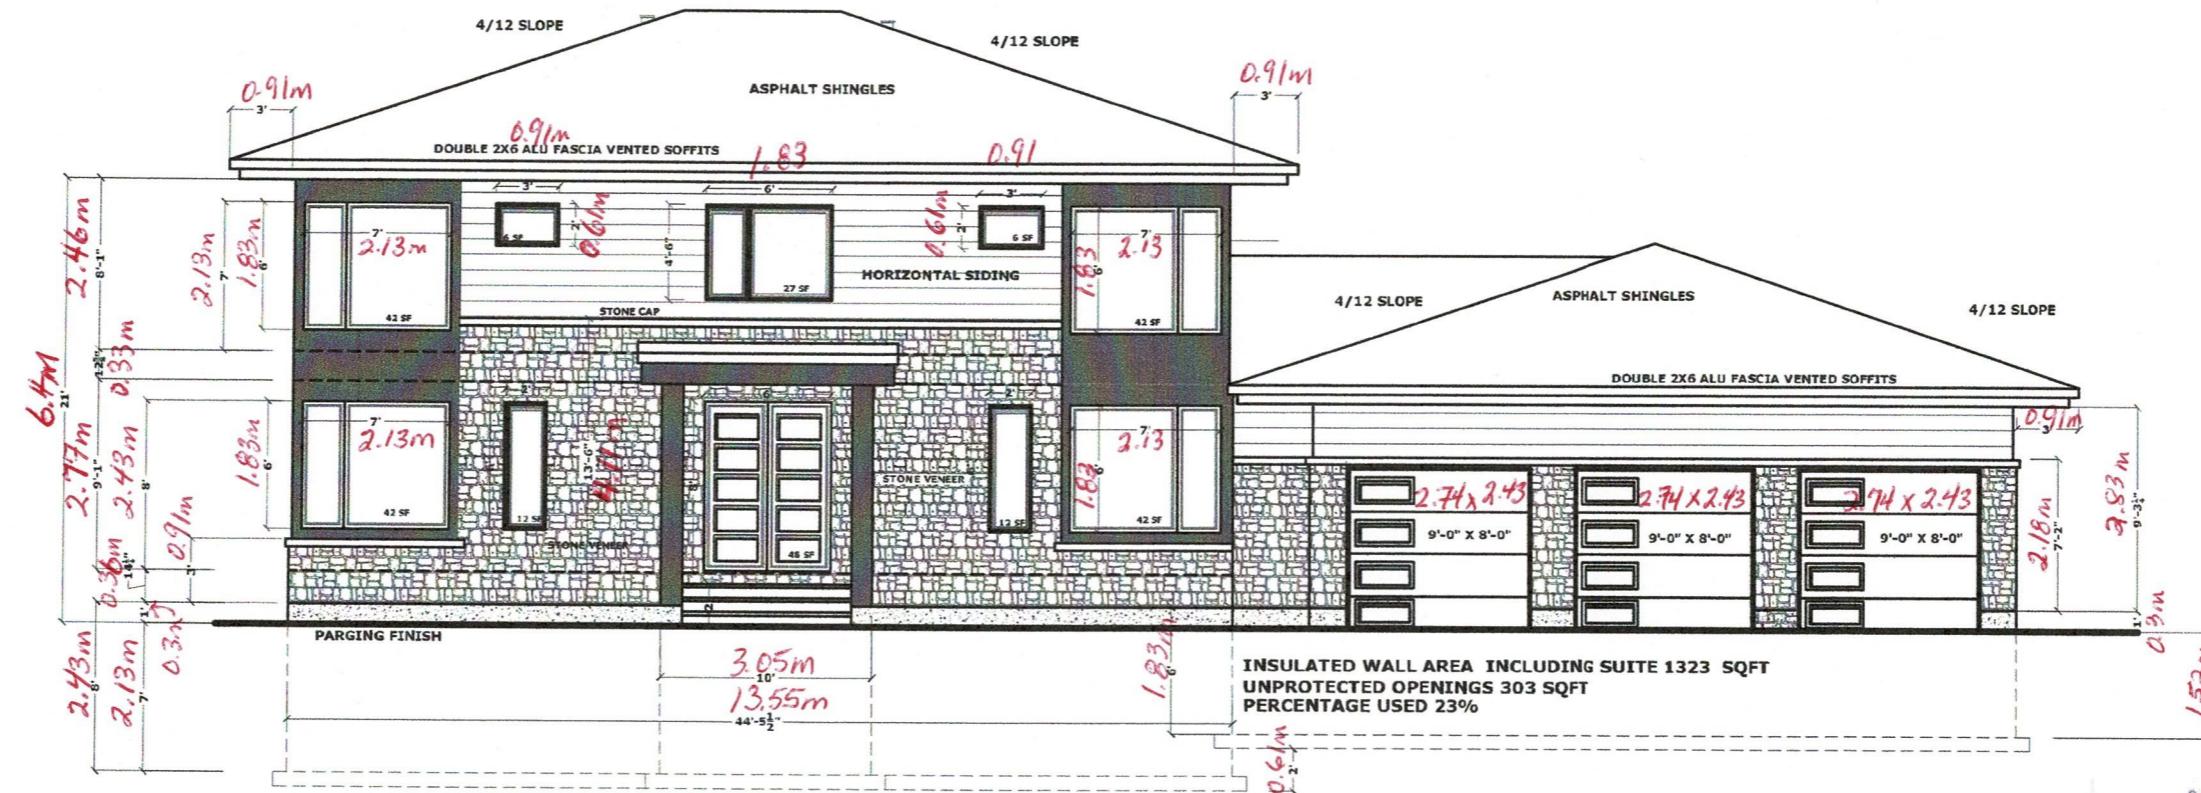

(STRUCTURAL ENGINEERING ONLY)

responsibilities

All design and construction to be in accordance with the Ontario Building Code 2017.

The undersigned has reviewed and takes responsibility for this design, and has the qualifications and meets the requirements set out in the Ontario Building Code to be a designer.

Dear Sirs

BRIAN ELDER/VOAHANGY THORP

NAVAR, ONTARIO

15 HORNED CRES LOT 4

FRONT ELEVATION

1000


PROJECT 6

13

三

3/16" = 1'-0"

A01

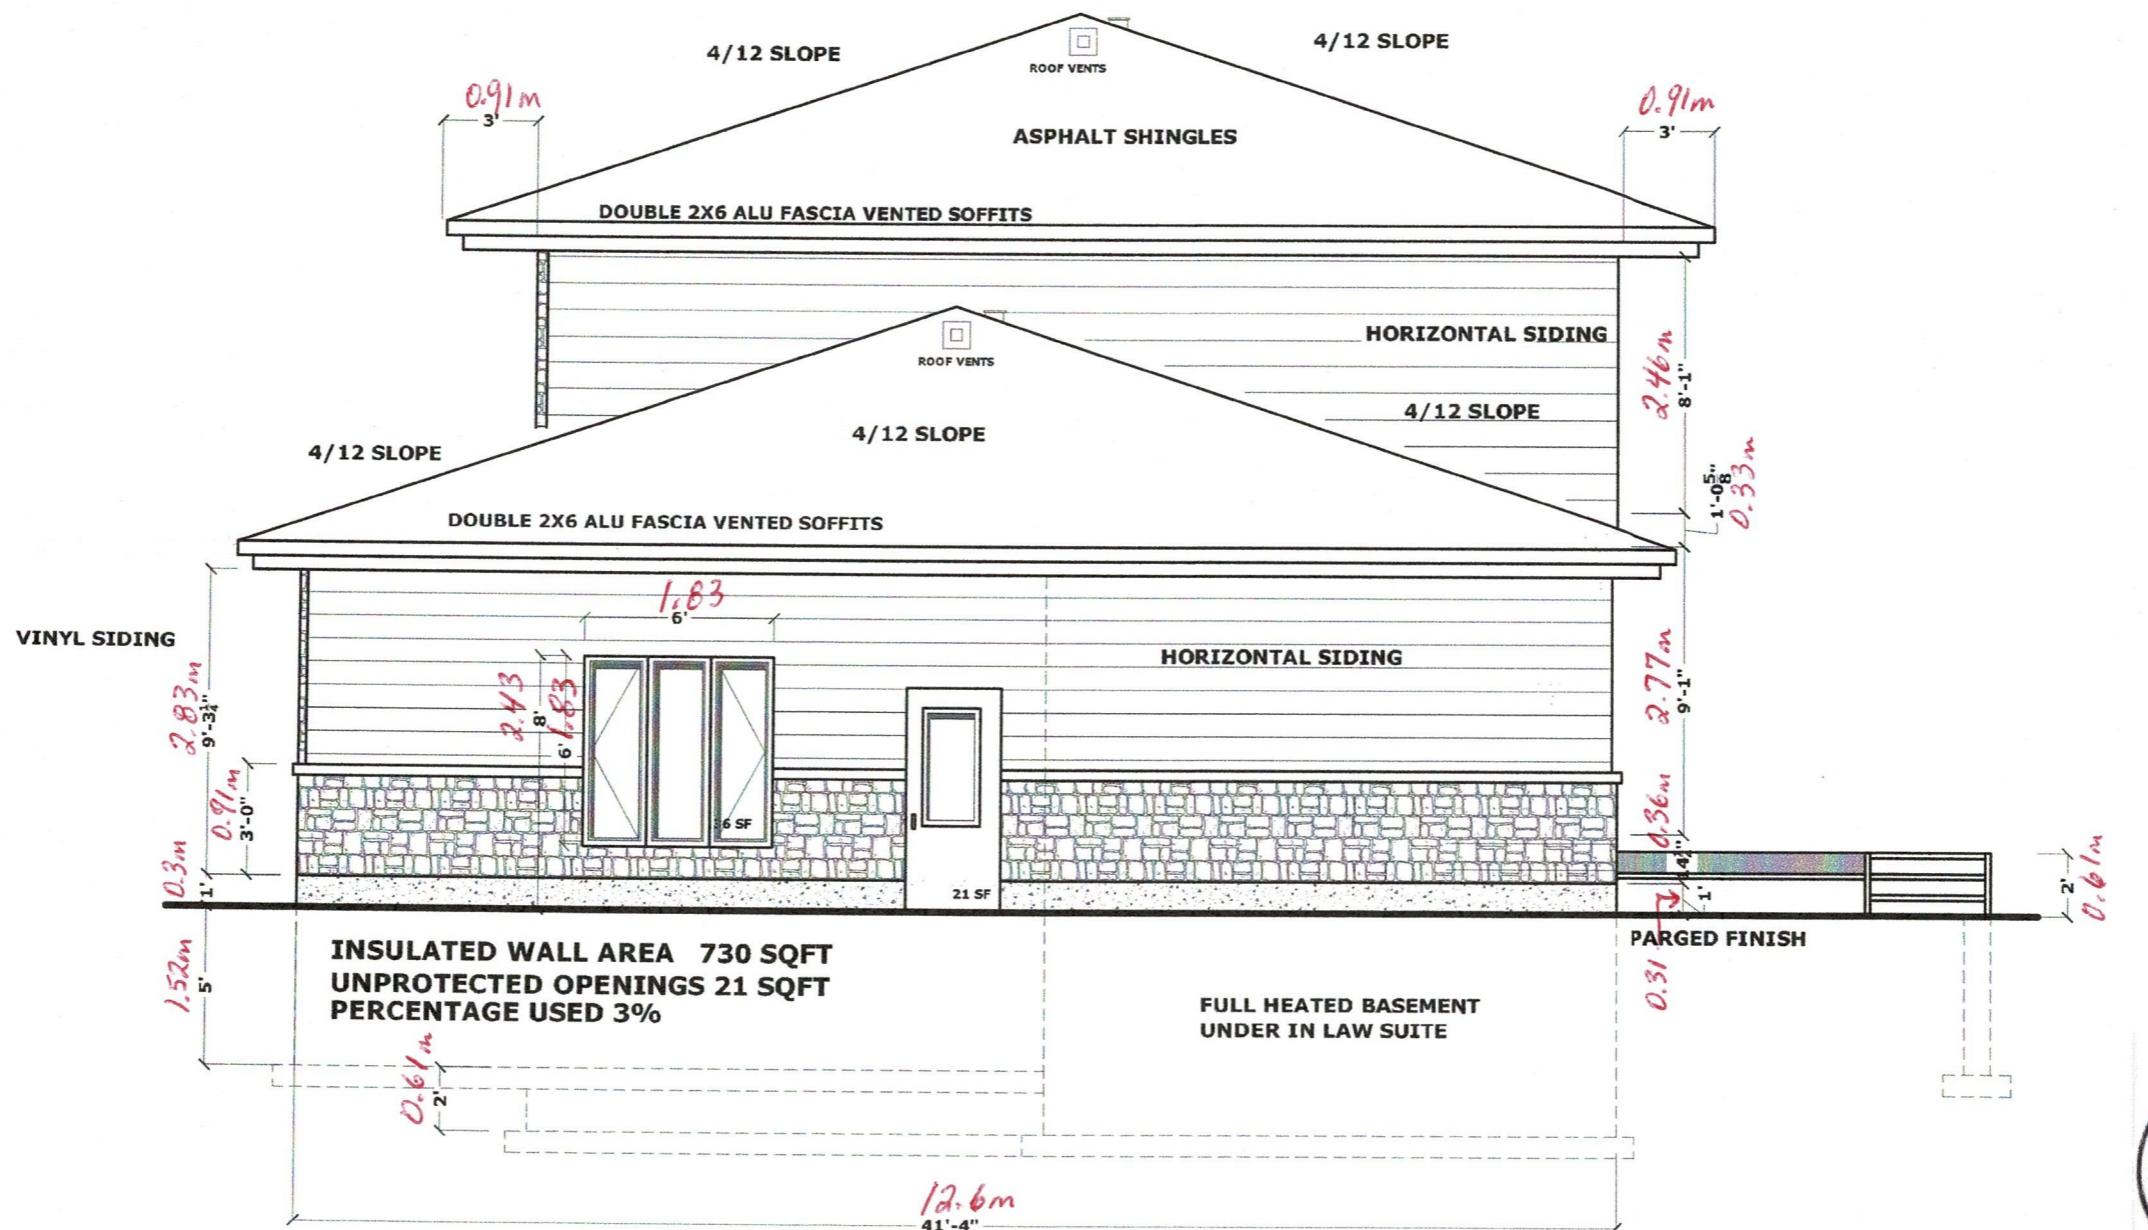

(STRUCTURAL ENGINEERING ONLY)

responsibilities

All design and construction to be in accordance with the Ontario Building Code 2017.

The undersigned has reviewed and takes responsibility for this design, and has the qualifications and meets the requirements set out in the Ontario Building Code to be a designer.



BRIAN ELDER/VOAHANGY THORP

NAVAN, ONTARIO
15 HORNED CRES, LOT 4
RIGHT ELEVATION

DRAWN BY:
PROJECT #:
SCALE:
DATE:

3/16" = 1'-0"
OCTOBER 6, 2020

A05

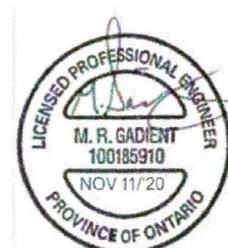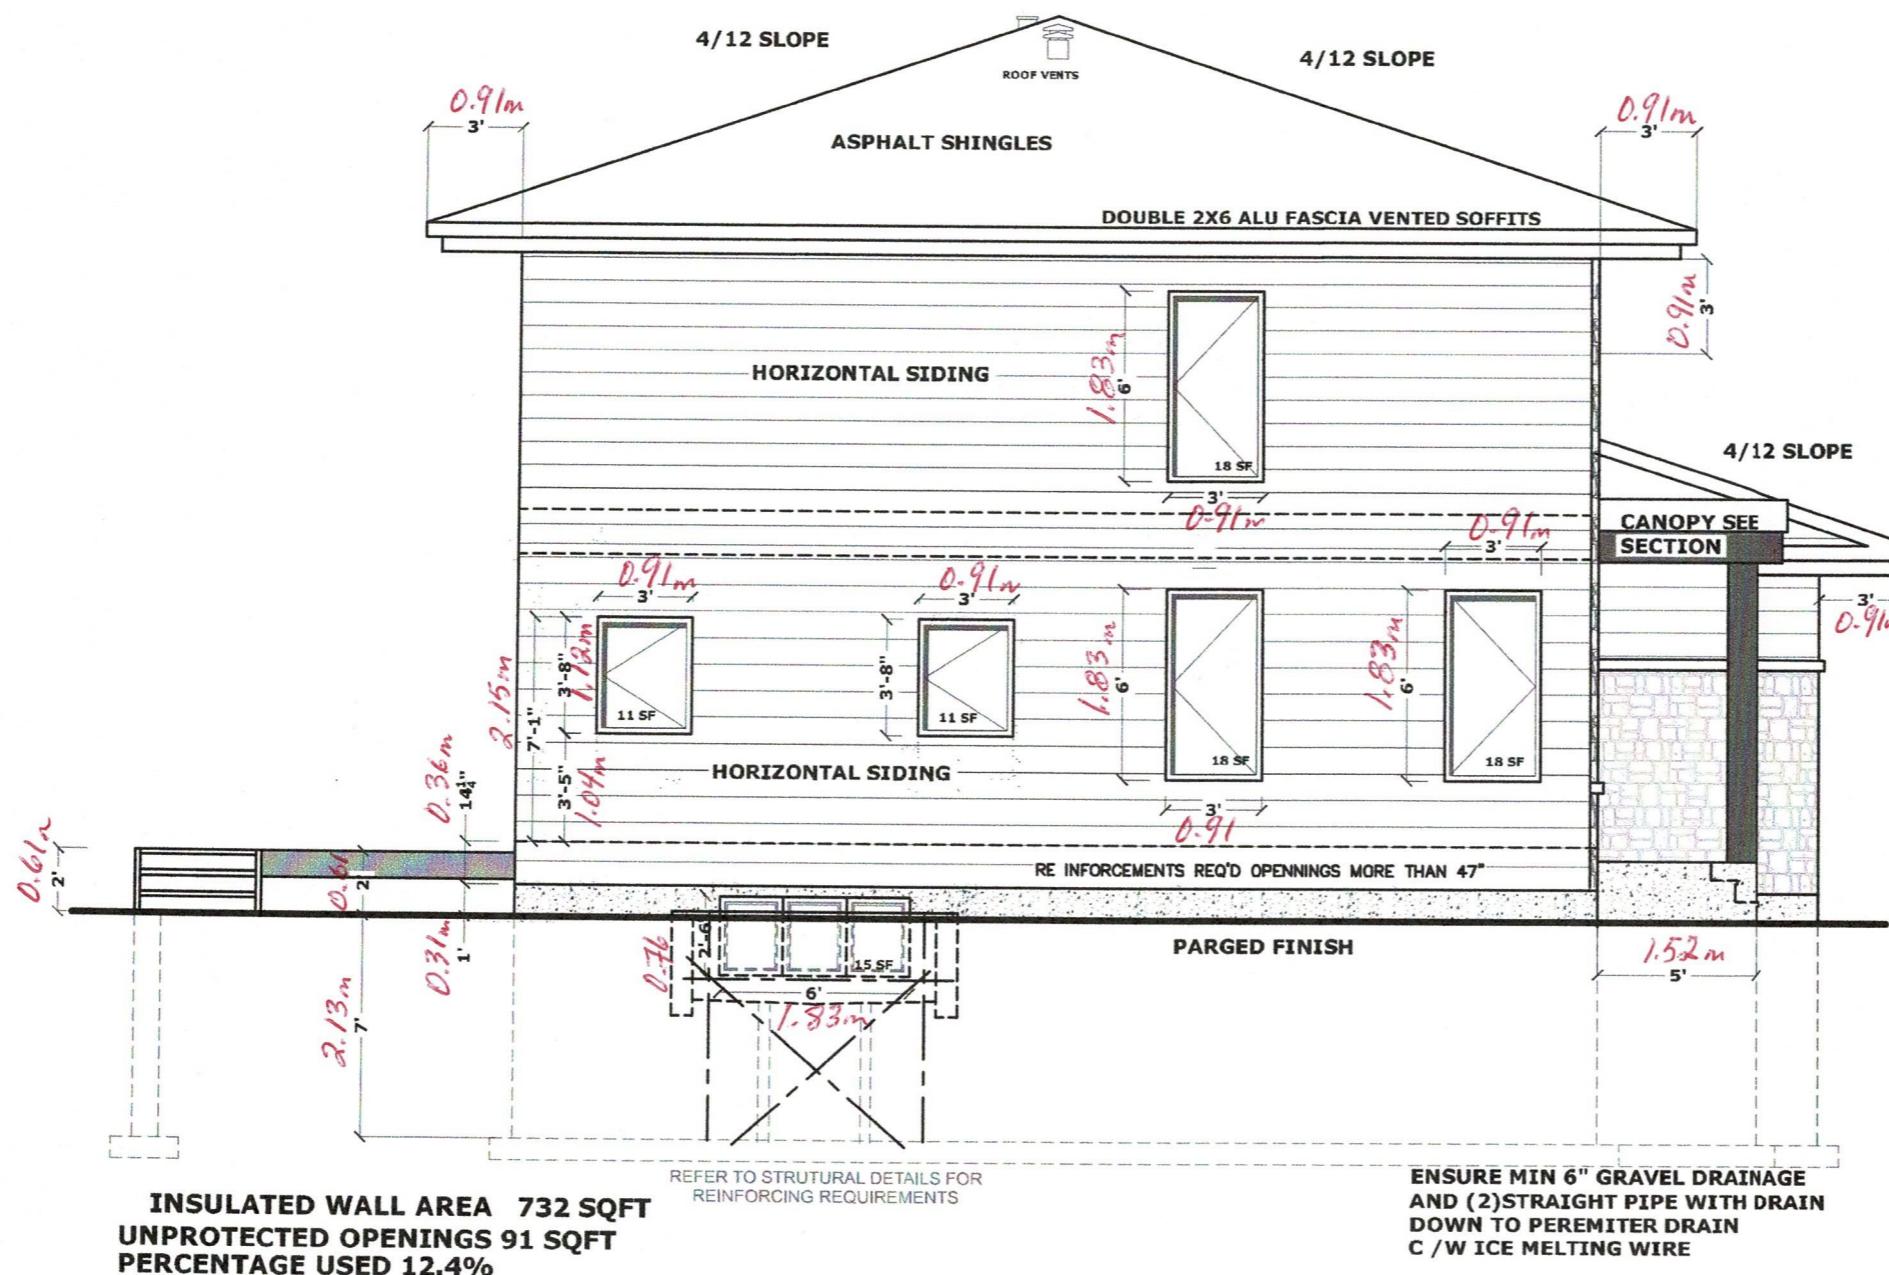

(STRUCTURAL ENGINEERING ONLY)

responsibilities

All design and construction to be in accordance with the Ontario Building Code 2017.

The undersigned has reviewed and takes responsibility for this design, and has the qualifications and meets the requirements set out in the Ontario Building Code to be a designer.

BRIAN ELDER/VOAHANGY THORP


NAVAN, ONTARIO
15 HORNED CRES, LOT 4

LEFT ELEVATION

DRAWN BY:
PROJECT #:
SCALE:
DATE:

3/16'=1'-0"
OCTOBER 6, 2020

A06

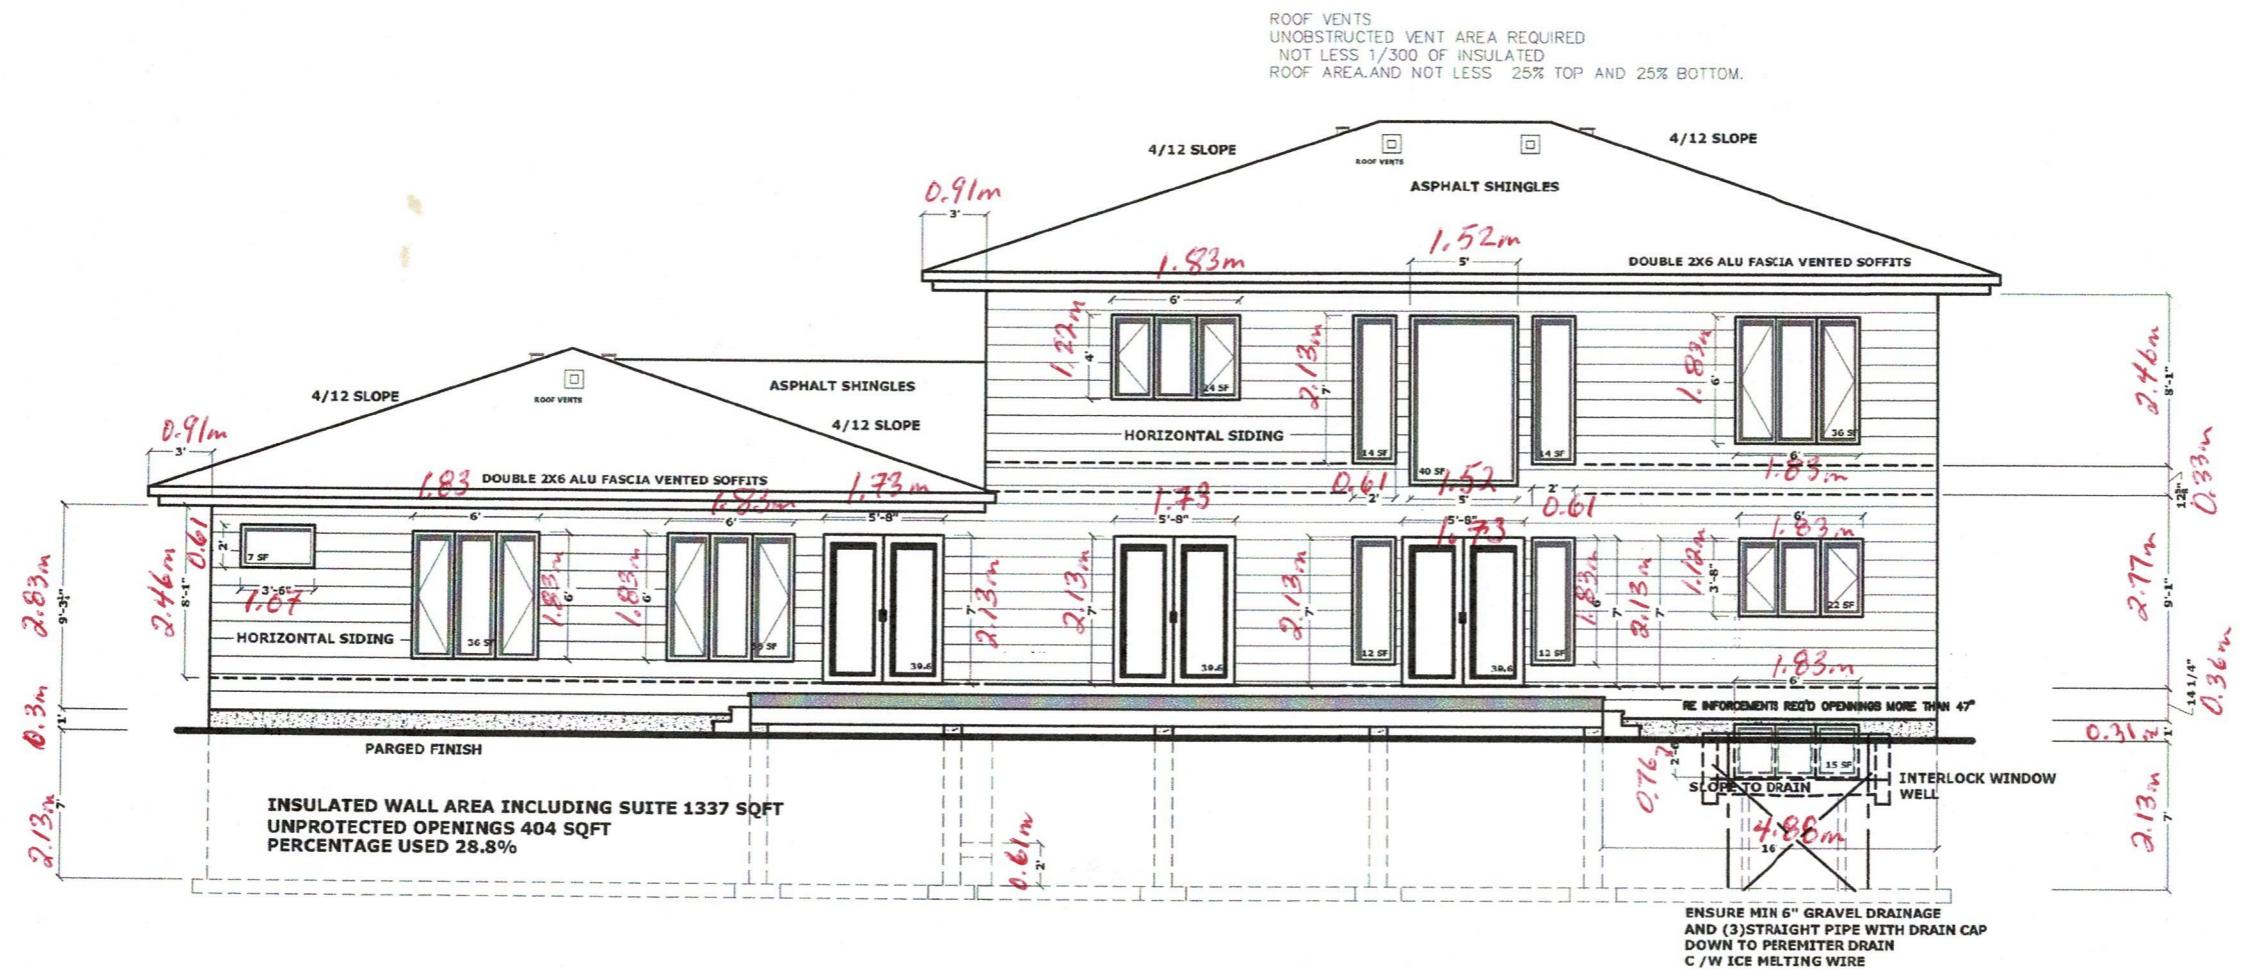

responsibilities

All design and construction to be in accordance with the Ontario Building Code 2017.

The undersigned has reviewed and takes responsibility for this design, and has the qualifications and meets the requirements set out in the Ontario Building Code to be a designer.

Dear Sirs

BRIAN ELDER/VOAHANGY THORP

DRAWN BY:
PROJECT #:
SCALE: 1/8" = 1'-0"
DATE: OCTOBER 6, 2020

A07

STRUCTURAL ENGINEERING ONLY)
(STRUCTURAL ENGINEERING ONLY)

