

TOPOGRAPHIC PLAN OF SURVEY OF

### **LOTS 10 AND 11 REGISTERED PLAN 189537** CITY OF OTTAWA

FARLEY, SMITH & DENIS SURVEYING LTD. 2017

Scale 1: 150

#### Metric Note

Distances and coordinates on this plan are in metres and can be converted to feet by dividing by 0.3048.

## Distance Note

Distances shown on this plan are ground distances and can be converted to grid distances by multiplying by the combined scale factor of 0.99995.

#### **Bearing Note**

Bearings are MTM grid, derived from the Smart-Net Real Time Network. GPS observations on reference points A and B, shown hereon, having a bearing of N 7° 02' 20" E and are referred to the Central Meridian of MTM Zone 9 (76°30' West

For bearing comparisons, a rotation of  $0^{\circ}27'40''$  counter-clockwise was applied to bearings on P1, P2 & P3.

#### **Elevation Notes**

- 1. Elevations shown are geodetic and are referred to Geodetic Datum CGVD-1928
- 2. Elevations derived from Vertical Benchmark No.G-31 (INDEX #300) having a published elevation of 57.406.
- 3. It is the responsibility of the user of this information to verify that the job benchmark has not been altered or disturbed and that it's relative elevation and description agrees with the information shown on this drawing.

#### **Utility Notes**

- This drawing cannot be accepted as acknowledging all of the utilities and it will be the responsibility of the user to contact the respective utility authorities for confirmation.
- 2. Only visible surface utilities were located. 3. Underground utility data derived from City of Ottawa utility sheet reference: Sheet no. C-16-09, C-16-14 & 13377.
- 4. Sanitary and storm sewer grades and inverts were derived from: City of Ottawa
- A field location of underground plant by the pertinent utility authority is mandatory before any work involving breaking ground, probing, excavating etc.

OBSERVATIONS, MTM ZONE 9, N.A.D. 1983 (ORIGINAL). POINT ID NORTHING 369549.83 5034125.34 369548.15 5027191.26 361496.76

373971.65 01919680105 5024915.16 CO-ORDINATES ARE MTM ZONE 9, N.A.D. 1983 (ORIGINAL), TO URBAN ACCURACY PER SEC. 14 (2) OF O.REG. 216/10, AND CANNOT, IN THEMSELVES, BE USED TO RE-ESTABLISH CORNERS OR BOUNDARIES SHOWN ON THIS PLAN.

### Notes & Legend

—□— Denotes Survey Monument Planted Survey Monument Found Standard Iron Bar Iron Bar Round Iron Bar Registered Plan 189537 Plan 5R-13317 Maintenance Hole (Storm) Maintenance Hole (Sanitary) Maintenance Hole (Unidentified) Underground Storm Sewer Underground Sanitary Sewer Overhead Wires Underground Gas Utility Pole Catch Basin Fire Hydrant Water Valve Top of Grate Water Stand Post Chain Link Fence **Depressed Curb** Top of Slope Bottom of Slope Underside of Eave Top of Foundation Centreline Location of Elevations
Top of Concrete Curb/Wall Elevation **Deciduous Tree** 

### **Revision Note:**

Revised to show additional elevation shots, all trees and new Benchmark shown near Southeast corner of property at utility pole. Field work completed November 8th, 2018.

Coniferous Tree

November 14, 2018 Date

<sup>→</sup>Ontario Land Surveyor

### Surveyor's Certificate

This survey and plan are correct and in accordance with the Surveys Act, the Surveyors Act and the Regulations made under them.


The survey was completed on the 23rd day of August, 2017.


SEPTEMBER\_06, \_2017 Date

Ontario Land Surveyor


FARLEY, SMITH & DENIS SURVEYING LTD. ONTARIO LAND SURVEYORS CANADA LAND SURVEYORS

190 COLONNADE ROAD, OTTAWA, ONTARIO K2E 7J5

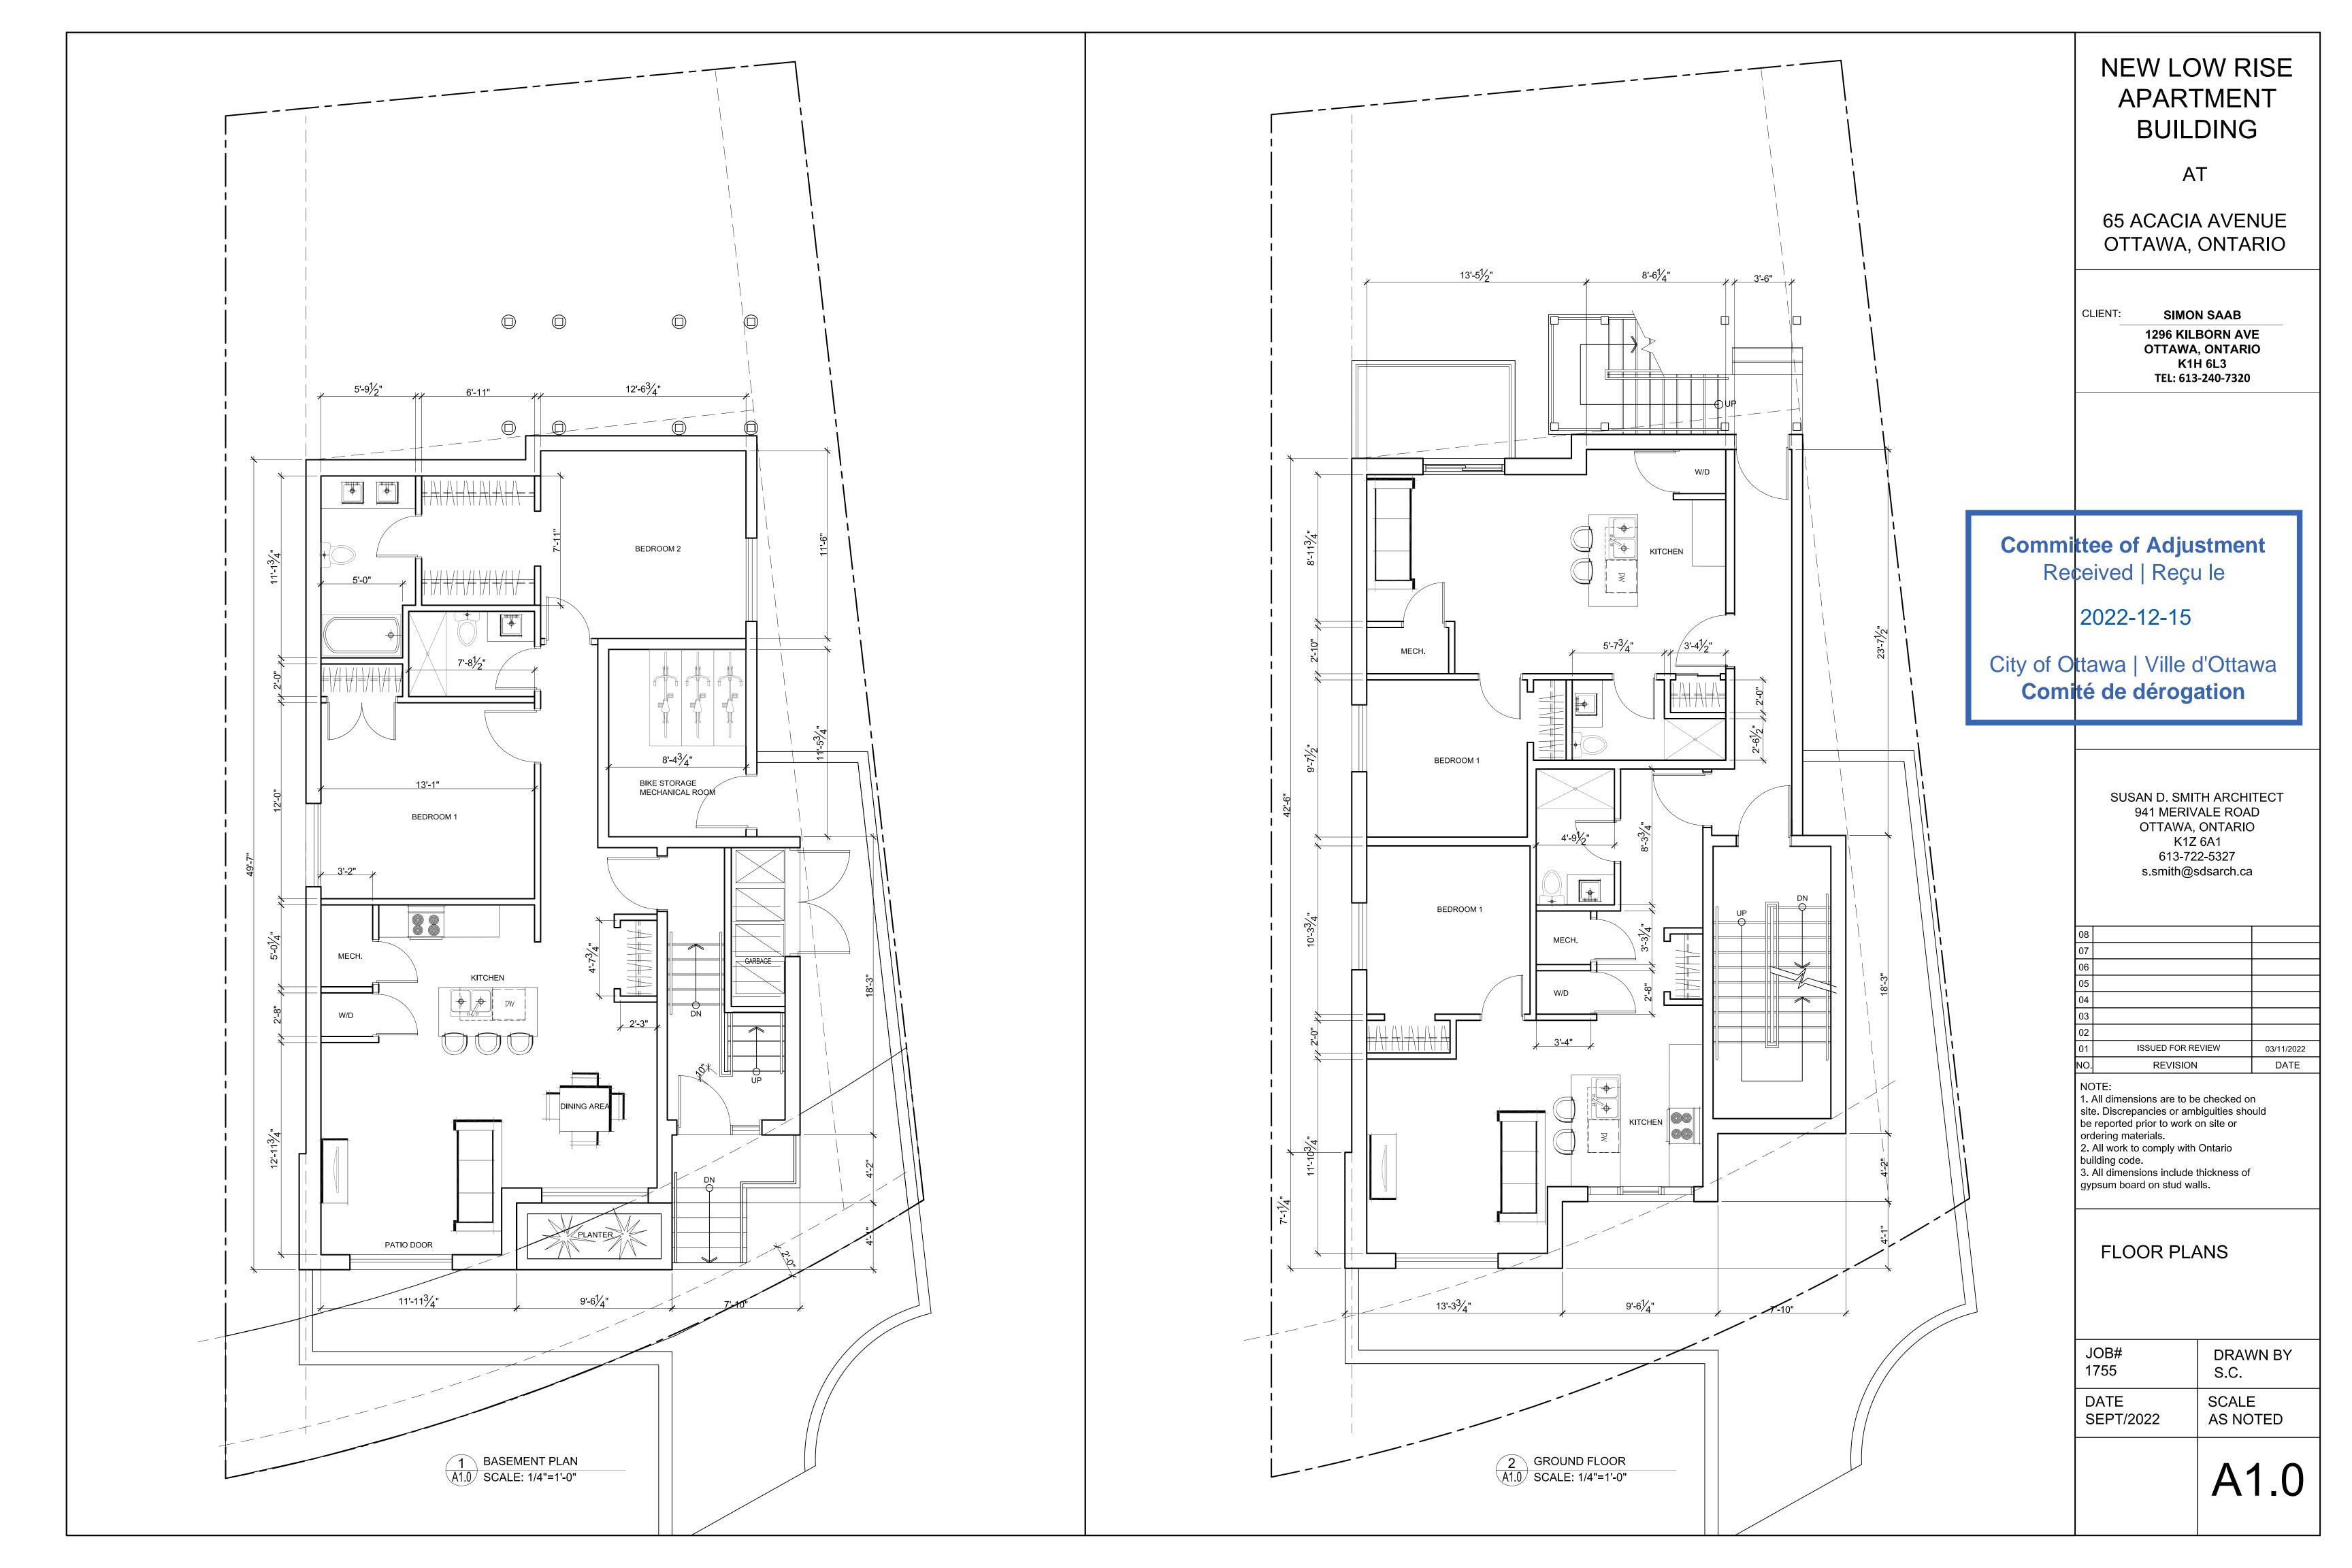

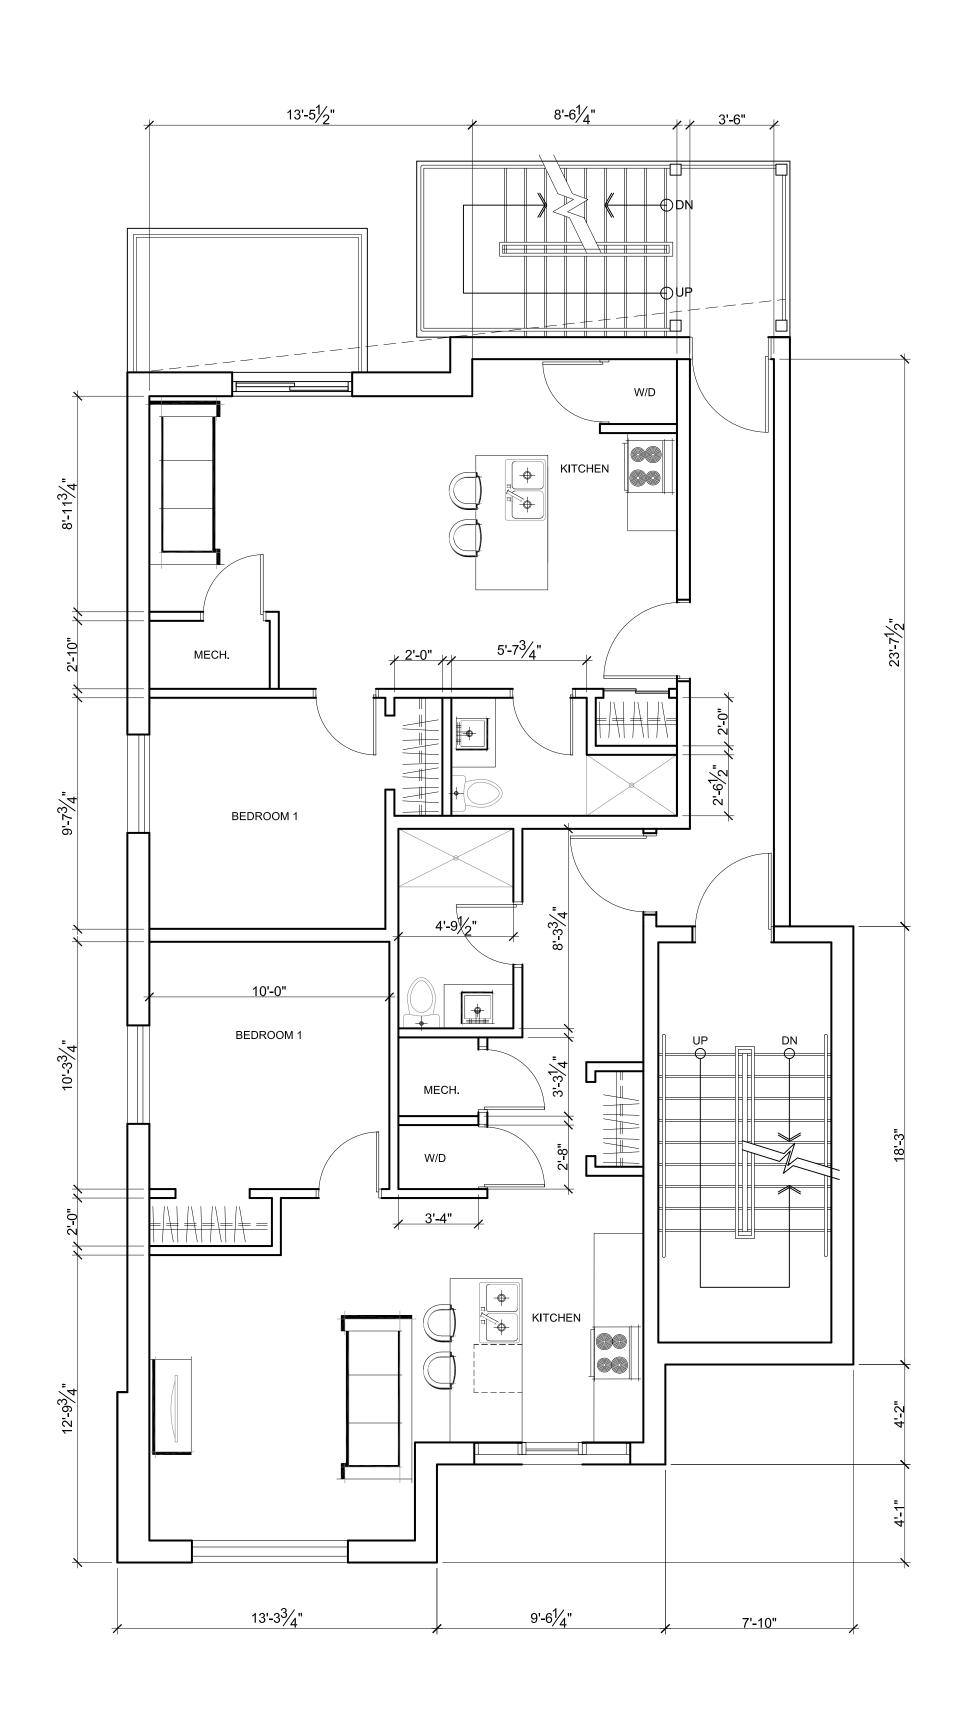

1 SECOND FLOOR A1.1 SCALE: 1/4"=1'-0"

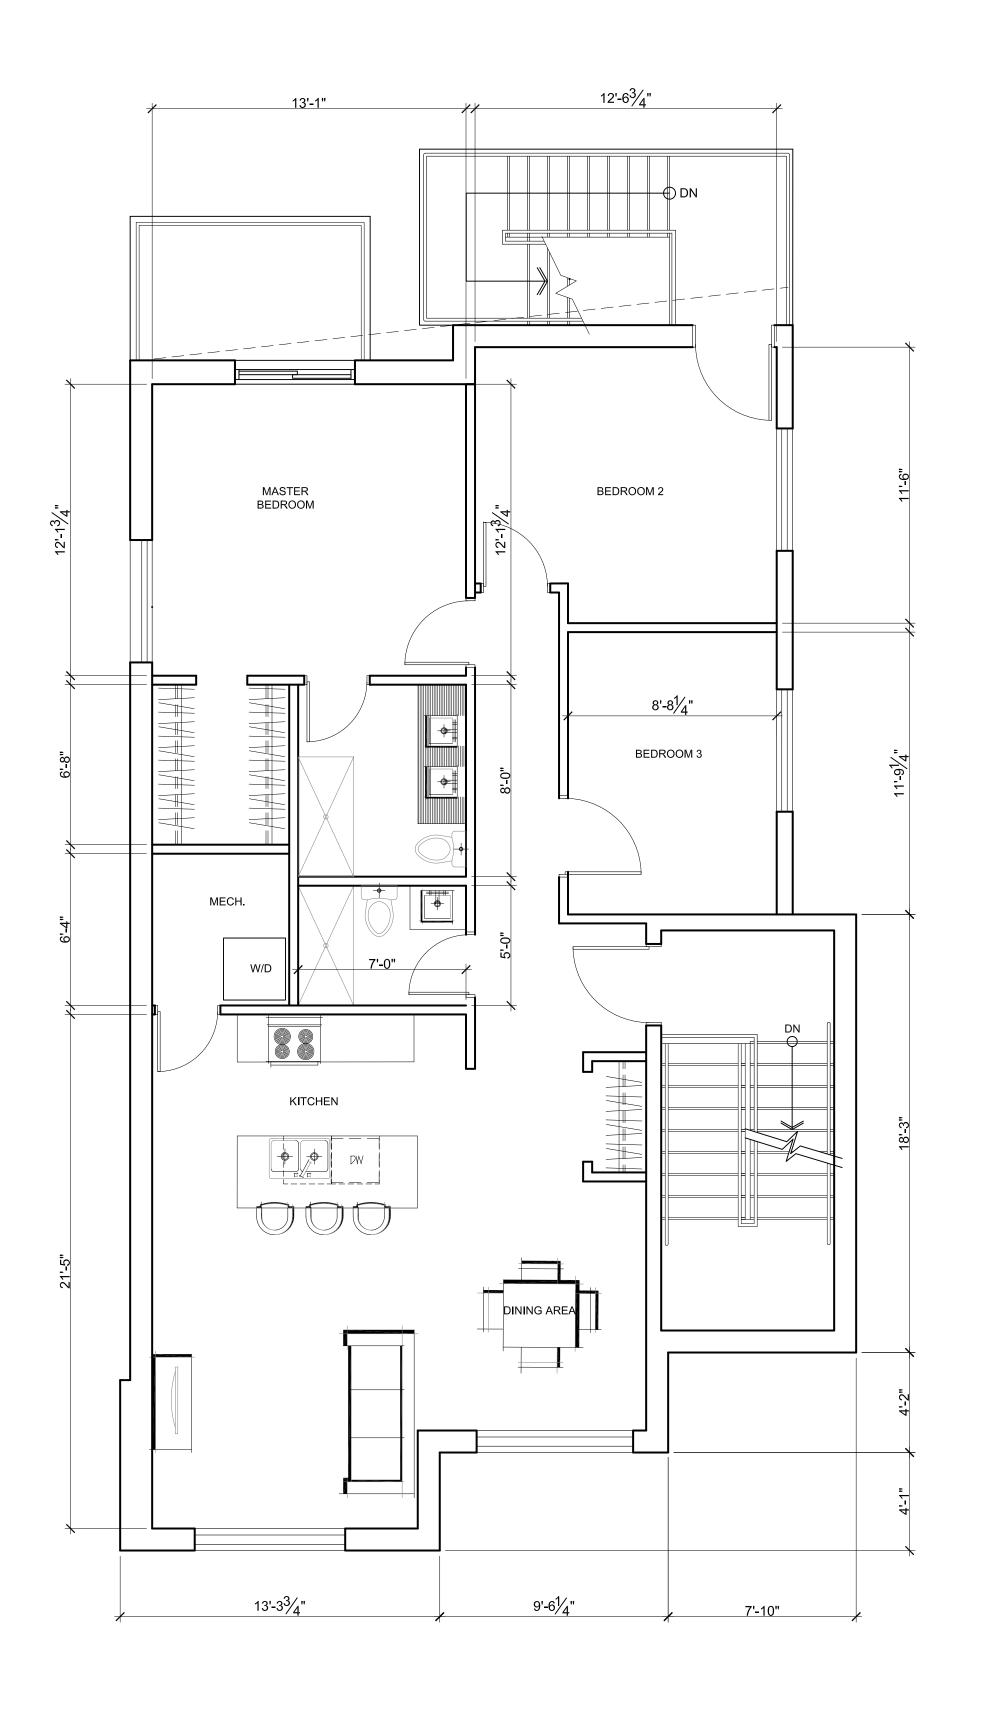

2 THIRD FLOOR A1.1 SCALE: 1/4"=1'-0"

# **NEW LOW RISE APARTMENT** BUILDING

AT

65 ACACIA AVENUE OTTAWA, ONTARIO

CLIENT: SIMON SAAB 1296 KILBORN AVE OTTAWA, ONTARIO K1H 6L3 TEL: 613-240-7320

> SUSAN D. SMITH ARCHITECT 941 MERIVALE ROAD OTTAWA, ONTARIO K1Z 6A1 613-722-5327 s.smith@sdsarch.ca

08		
07		
06		
05		
04		
03		
02		
01	ISSUED FOR REVIEW	03/11/2022
NO.	REVISION	DATE


NOTE:
1. All dimensions are to be checked on site. Discrepancies or ambiguities should be reported prior to work on site or ordering materials.
2. All work to comply with Ontario building code.
3. All dimensions include thickness of gypsum board on stud walls.

FLOOR PLANS

JOB# DRAWN BY 1755 S.C. DATE SCALE

SEPT/2022

AS NOTED

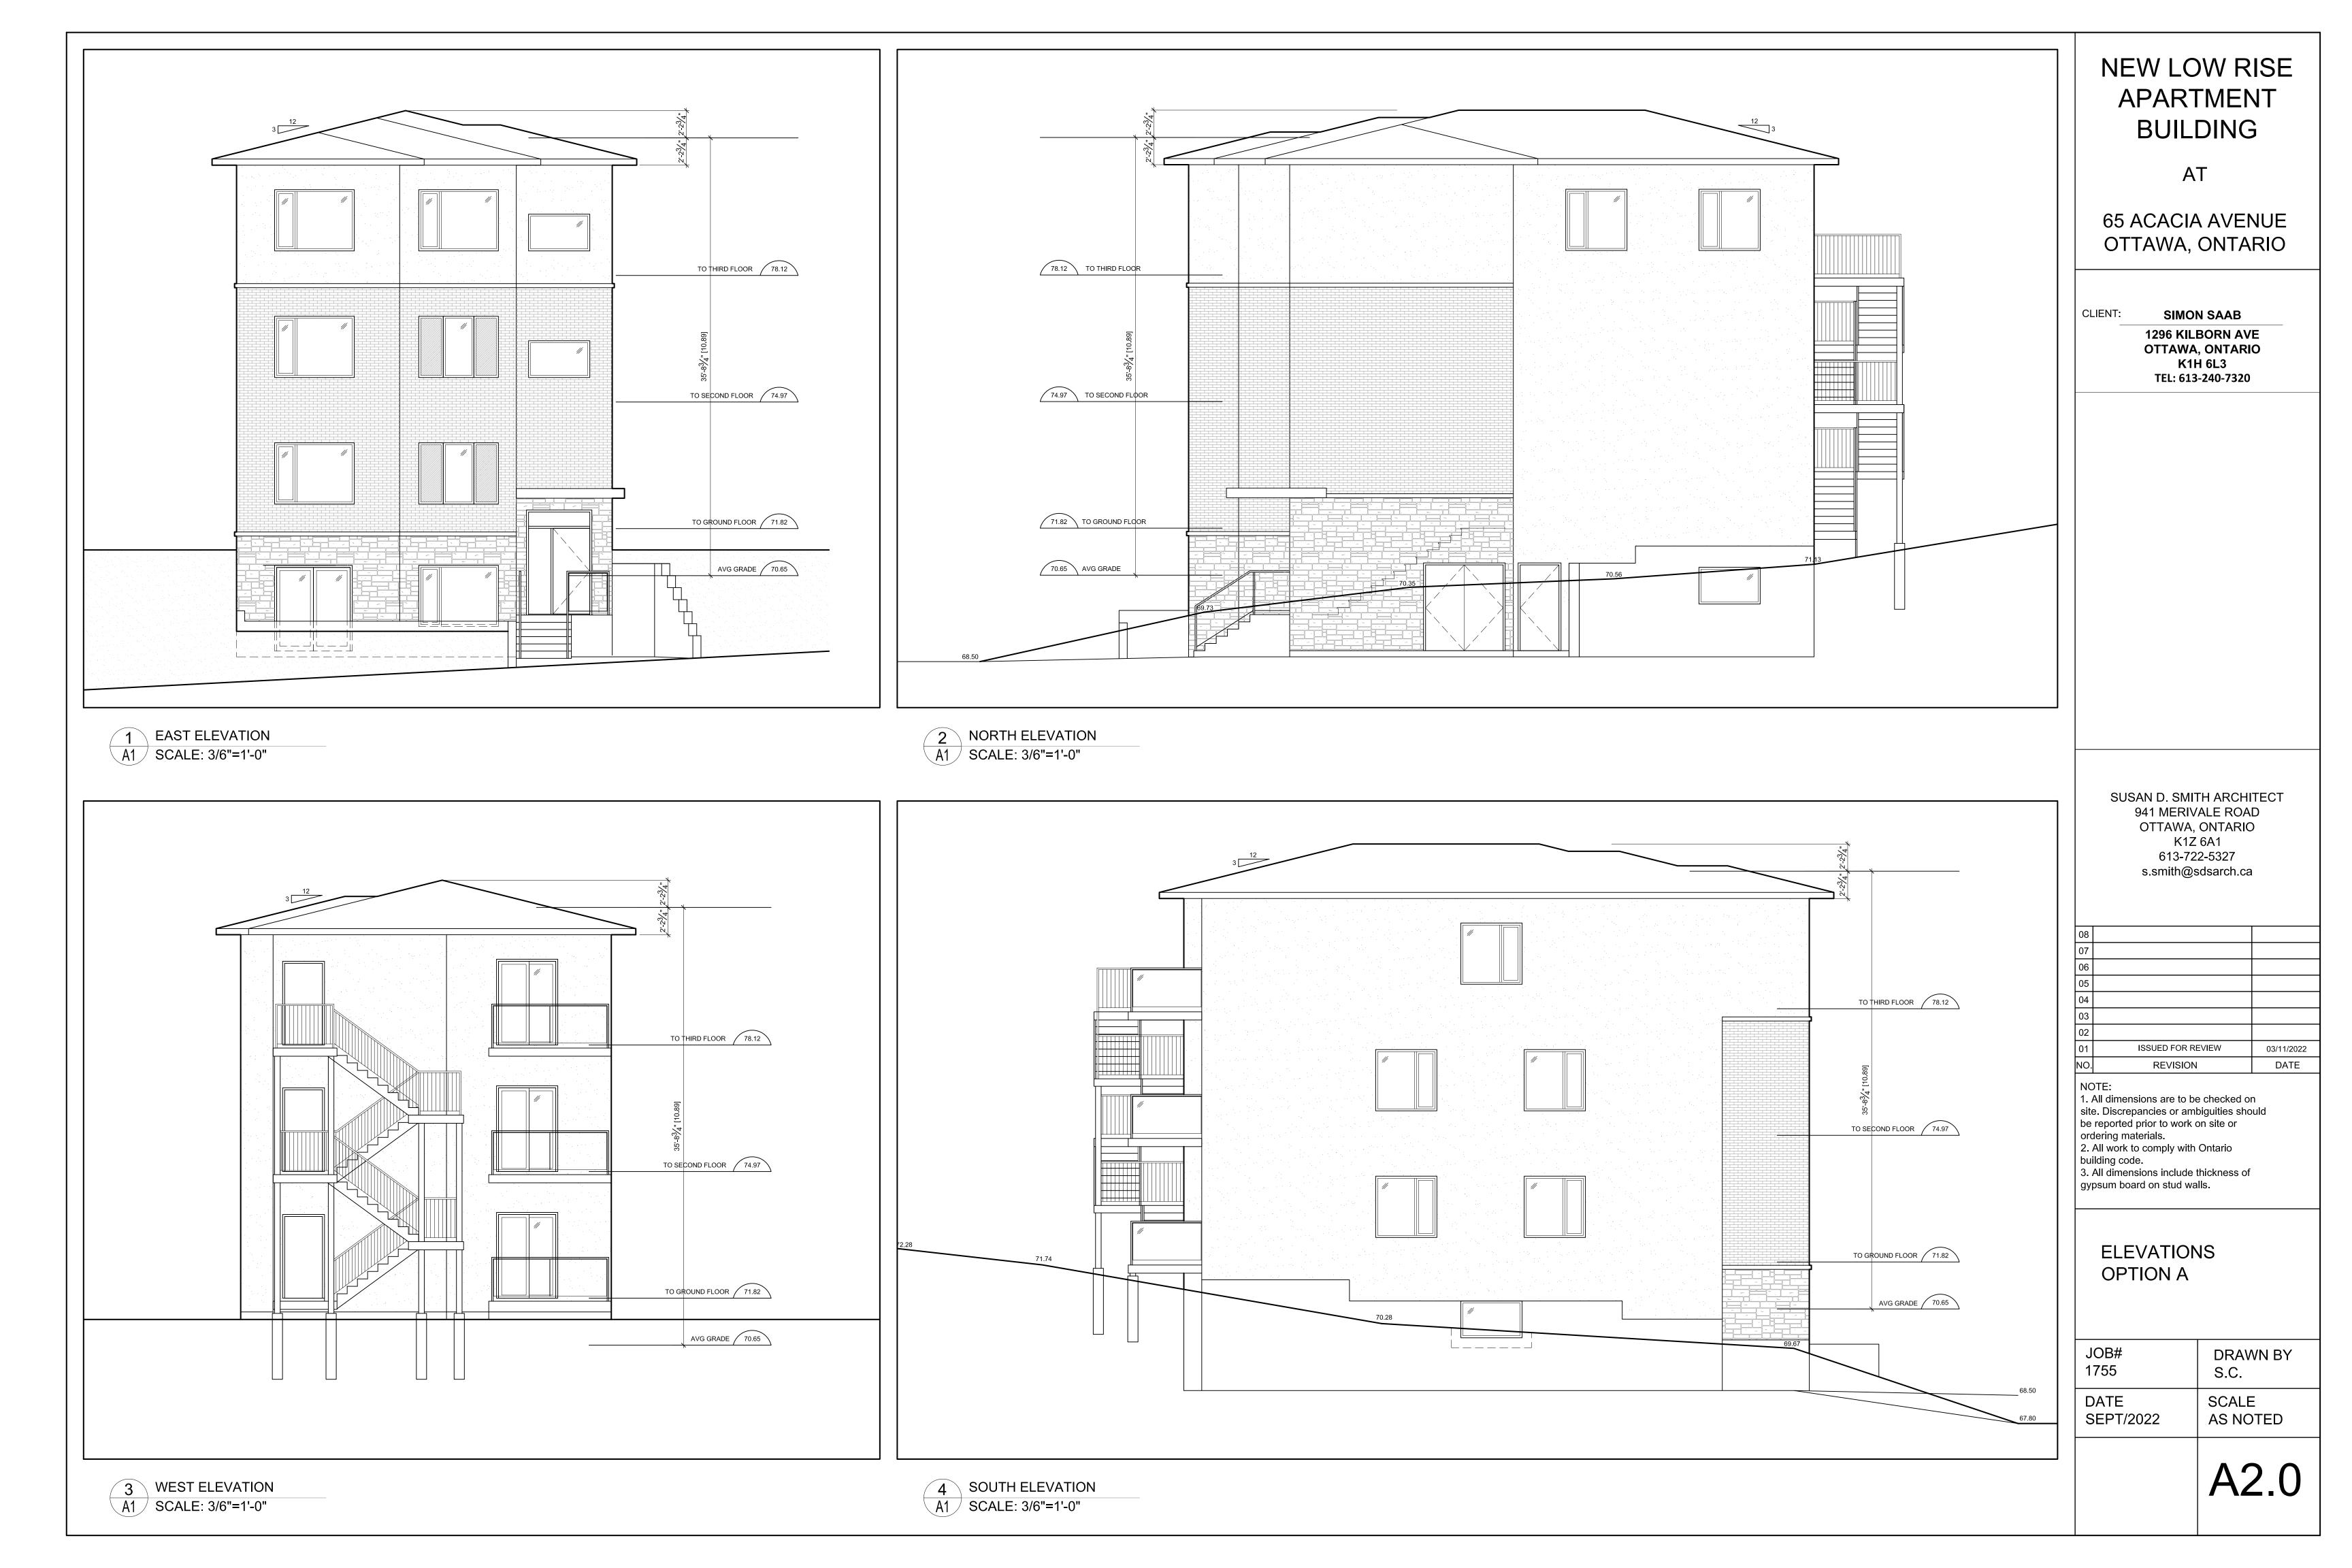



# Farley, Smith & Denis Surveying Ltd. Since 1908

## ONTARIO LAND SURVEYORS CANADA LANDS SURVEYORS



S. E. FARLEY, O.L.S., Q.L.S. (1886-1980) H. R. FARLEY, O.L.S., P. ENG. (1913-2001) P. G. SMITH, O.L.S., C.L.S. (1948-2006) R. A. DENIS, B.Sc., O.L.S., C.L.S. (RETIRED) D. B. ROBINSON, O.L.S., O.L.I.P. E. M. ALREFAAI, O.L.S., O.L.I.P. J. W. LESLIE, P. ENG., O.L.S., O.L.I.P., C.L.S., N.S.L.S. 275-30 Colonnade Road Ottawa, Ontario K2E 7J6 Telephone (613) 727-8226 Email: fsdsurveys@bellnet.ca

File No. 594-22

#### **Simon Saab**

11 Oakland Avenue Unit #2 Ottawa, Ontario K1S 2T1

Cell: 613-240-7320 Email: s.saab@live.com

#### **SURVEYOR'S CERTIFICATE**

RE: #65(63) Acacia Avenue Lot 11 Registered Plan 189537 City of Ottawa (Being PIN 04225-0274) Committee of Adjustment Received | Reçu le

2022-12-15

City of Ottawa | Ville d'Ottawa

Comité de dérogation

I, Daniel Robinson an Ontario Land Surveyor registered under the Surveyors Act of Province of Ontario hereby certify the area of the above noted lands to be **285.7m².** I also hereby certify the lot width to be **13.77m**, calculated at the 4.50m setback limit.


Date: November 15, 2022

Daniel Robinson O.L.S., O.L.I.P.

President

Farley Smith & Denis Surveying Ltd



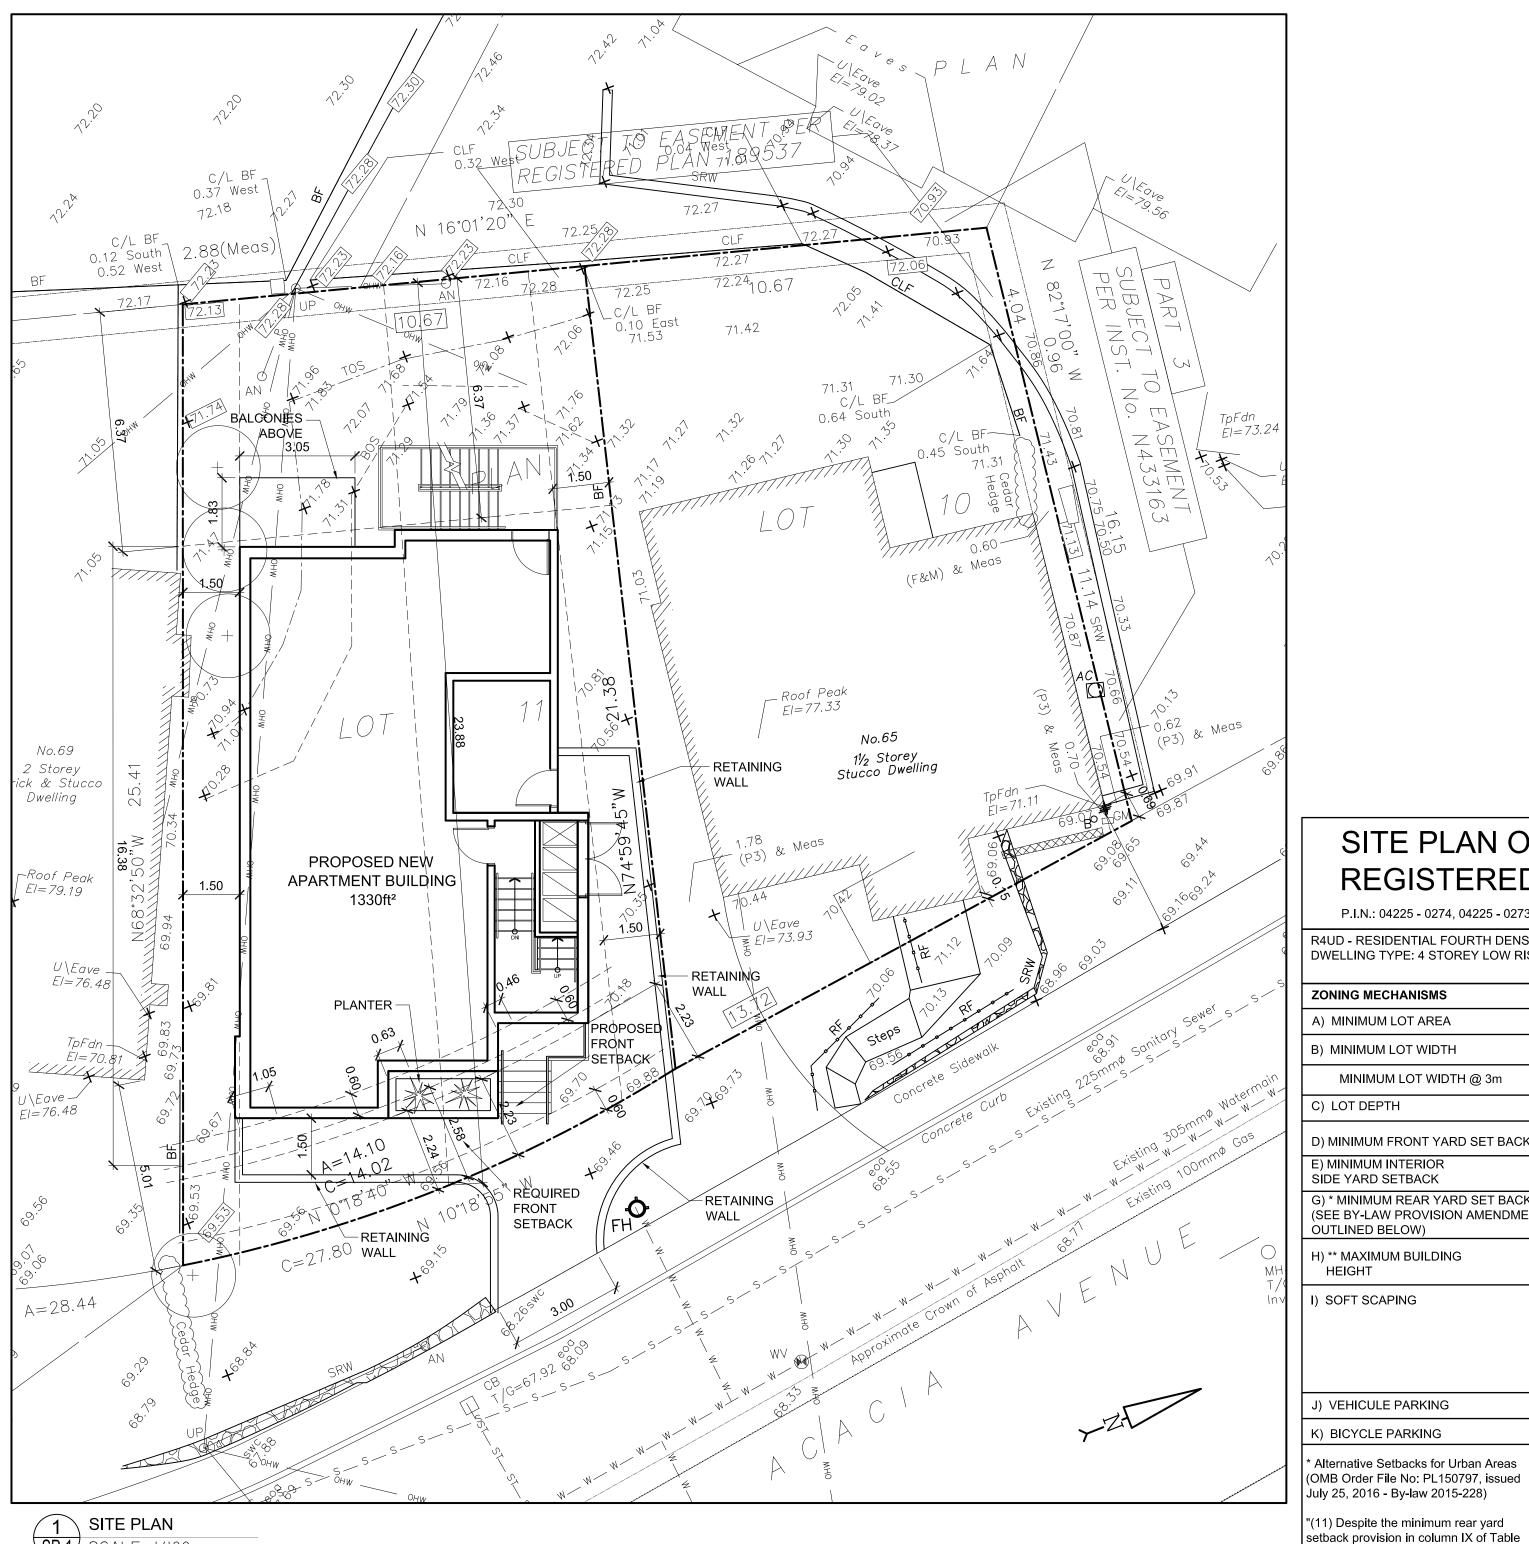

SP-1 SCALE: 1/100

**Committee of Adjustment** Received | Reçu le

2022-12-15

City of Ottawa | Ville d'Ottawa Comité de dérogation



# **NEW LOW RISE APARTMENT** BUILDING

65 ACACIA AVENUE OTTAWA, ONTARIO

SIMON SAAB CLIENT:

> **1296 KILBORN AVE** OTTAWA, ONTARIO K1H 6L3 TEL: 613-240-7320

CONSULTANTS:

SURVEYOR:
FARLEY SMITH & DENIS SURVEYING LTD 10-190 Colonnade Rd, Nepean, ON K2E 7J5

> SUSAN D. SMITH ARCHITECT 941 MERIVALE ROAD OTTAWA, ONTARIO KIZ 6AI 613-722-5327 S.SMITH@SDSARCH.CA

ISSUED FOR REVIEW 03/11/2022 REVISION DATE

NOTE:

I. ALL DIMENSIONS ARE TO BE CHECKED ON SITE. DISCREPANCIES OR AMBIGUITIES SHOULD BE REPORTED PRIOR TO WORK ON SITE OR ORDERING MATERIALS. 2. ALL WORK TO COMPLY WITH ONTARIO BUILDING CODE.

3. ALL DIMENSIONS INCLUDE THICKNESS OF GYPSUM BOARD ON STUD WALLS.

SITE PLAN

JOB# DRAWN BY 1755 SCALE DATE AS NOTED SEPT 2022

SITE PLAN OF SURVEY LOT 11 REGISTERED PLAN 189537, CITY OF OTTAWA										+	PROPOSED TREE
P.I.N.: 04225 - 0274, 04225 - 0273	(+)	EX. TREE TO BE REMOVED									
R4UD - RESIDENTIAL FOURTH DENSITY ZONE (SEC. 161-162) CITY OF OTTAWA; DWELLING TYPE: 4 STOREY LOW RISE APARTMENT BUILDING								)		EX. TREE TO REMAIN	
ZONING MECHANISMS	REQUIREMENT			PROVIDED	NOTES	SURVEY INFO TAKEN FROM			[ + + ]		
A) MINIMUM LOT AREA				300.0 m²	285.7 m²	MV	LOT 11			* * *	DENOTES SOFT LANDSCAPING (SOD)
B) MINIMUM LOT WIDTH				10.0 m	13.77 m		REGISTERED PLAN 189537				
MINIMUM LOT WIDTH @ 3m				N/A	N/A		CITY OF OTTAWA				DENOTES HARD LANDSCAPING (PERMEABLE PAVER)
C) LOT DEPTH				N/A	23.876 m		PREPARED BY FARLEY, SMITH & DENIS SURVEYING LTD.				
D) MINIMUM FRONT YARD SET BACK	AVERAGE			2.584 m	2.23 m	MV	FIELD WORK COMPLETED AUG. 23, 2017				PROPOSED RIVERWASH
E) MINIMUM INTERIOR SIDE YARD SETBACK				1.5 m	1.5 m		GARBAGE REQUIREMENT				STONE
G) * MINIMUM REAR YARD SET BACK (SEE BY-LAW PROVISION AMENDMENTS	SEE ZONE PROVISIONS ACCORDING TO OMB DEPTH	ЕВТИ	6.37 m	6.43 m			REQUIREMENT	PROVIDED		PROPOSED BUILDING FOOTPRINT	
OUTLINED BELOW)	ORDER FILE NO. PL	150797		23.88-17.5	0.40 111		GARBAGE	0.231 CUBIC YARDS PER UNIT: 5x0.231=2.7	2 YARD		FOOTPRINT
H) ** MAXIMUM BUILDING HEIGHT				11.0 m	10.9 m		RECYCLING	FOR EVERY 6 UNITS, PROVIDE ONE 360L BLUE	ONE 360L BLUE CART& 1-360L	~~~~~~~~~~~~~~~~~~~~~~~~~~~~~~~~~~~~~~	PROPOSED SHRUB (SEE
I) SOFT SCAPING	35 m²		69.4 m²			CART AND ONE 360L BLACK CART	BLACK CART		LANDSCAPE PLAN)		
				6.4m² (20%)	IN THE REAR YARD 10.8m² (33.7%)		ORGANICS	"KITCHEN CATCHER" CONTAINER FOR EACH DWELLING UNIT AND ONE	"KITCHEN CATCHER" CONTAINER FOR EACH DWELLING UNIT AND ONE		DDODOSED DETAINING WALL
		OF 32m² FRONT	DF 32m² FRONT YARD	O OF 32m² FRONT YARD			COMMUNAL 240L GREEN CONTAINER PER 50 UNITS			PROPOSED RETAINING WALL	
J) VEHICULE PARKING				0	0		GARBAGE, RECYCLING AND COMPOSTING			TREE PROTECTION FENCING	
K) BICYCLE PARKING	0.5 PER UNITS			3	3 INSIDE THE BASEMENT		ARE TO BE STORED IN A PUBLIC ROOM (AS PER THE BASEMENT PLAN) AND REMOVED PRIVATELY DURING COLLECTION			PROPOSED/EXISTING ENTRY/EXIT	
* Alternative Setbacks for Urban Areas  ** Alternative Height Limits for Urban Areas											

Alternative Height Limits for Urban Areas (OMB Order File No: PL150797, issued July 25, 2016 - By-law 2015-228)

162A, the minimum required rear yard

setback on through lots or interior lots

where the rear lot line abuts R1, R2, R3, and R4 zones, and where the minimum

front yard setback is up to and including

as follows:

4.5 metres in Area A on Schedule 342 are

(i) up to and including 23.5 metres, except for a lot containing a Planned Unit

Development: a distance equal to 25 per cent of the lot depth which must comprise

at least 25 per cent of the area of the lot,

(ii) greater than 23.5 metres and up to and including 25 metres, except for a lot

containing a Planned Unit Development: a

distance equal to the lot depth minus 17.5 metres which must comprise at least 25

per cent of the area of the lot,..."

SNOW REMOVAL REQUIREMENT PROPERTY OWNER WILL BE RESPONSIBLE FOR THE REMOVAL AND STORAGE OF SNOW FOR ALL WALKWAYS THROUGHOUT THE WINTER

PROPERTY LINE OVERHEAD HYDRO LINES PROPOSED STORM MANHOLE



PROPOSED CATCH BASIN MANHOLE

EX. UTILITY POLE

EX. CHAINED LINK/BOARD