

DRAWING No.

**ASK** 

# D-++019

## **GENERAL NOTES:**

- 1. ALL DRAWINGS ARE THE PROPERTY OF ARCHITECT. NO REPRODUCTION MAY BE MADE WITHOUT THE WRITTEN CONSENT OF THE ARCHITECT. ALL REPRODUCTIONS MUST BEAR THE NAMES OF THE ARCHITECT.
- 2. ALL WORK SHALL BE COMPLETE IN ACCORDANCE WITH THE LATEST EDITION OF 2012 ONTARIO BUILDING CODE, PART 9 AND ALL APPLICABLE SUPPLEMENTS AND ANY MUNICIPAL BYLAWS.
- THESE DRAWINGS SHALL NOT BE SCALED. FOLLOW GIVEN DIMENSIONS ONLY.
- 4. ALL DIMENSIONS ARE IMPERIAL UNLESS OTHERWISE NOTED.
- 5. UNLESS OTHERWISE NOTED, DIMENSIONS ARE TO FACE OF WOOD STUDS, FACE OF CONCRETE FOUNDATION WALLS AND SLABS, TOP OF FLOOR JOISTS AND UNDERSIDE OF ROOF TRUSSES.
- PRIOR TO COMMENCEMENT OF WORK REPORT ANY DISCREPANCIES TO THE ARCHITECT AND ENGINEER.
- 7. VARIATIONS AND MODIFICATIONS TO WORK SHOWN SHALL NOT BE ALLOWED WITHOUT THE WRITTEN PERMISSION OF ARCHITECT.
- DISPOSE OF CONSTRUCTION WASTE AND ANY UNWANTED MATERIALS IN ACCORDANCE WITH LOCAL AND PROVINCIAL BYLAWS, CODES AND REGULATIONS.
- CONTRACTOR SHALL ENSURE THAT ALL AREAS ADJACENT TO WORK AREA ARE PROTECTED FROM DAMAGE THAT MAY RESULT FROM NEW CONSTRUCTION.
- 10. APPLICATIONS AND COSTS OF ALL NOTICES, PERMITS, FEES, TESTS AND REPORTS SHALL BE THE CONTRACTOR'S RESPONSIBILITY.
- 11. SITE VERIFY ALL ROUGH OPENING DIMENSIONS OF DOORS AND WINDOWS, PRIOR TO ORDER AND FABRICATION.
- 12. ALL BATHROOM, LAUNDRY ROOM AND KITCHEN EXHAUSTS SHALL BE VENTED TO OUTDOOR.
- 13. ALL HANDRAILS SHALL BE 915mm HIGH AND ALL GUARDRAILS SHALL BE 1100mm HIGH, CONFORMING TO OBC SB-3.
- 14. 6 mil (0.15mm) POLYETHYLENE SHEET VAPOR BARRIER SHALL BE CONTINUOUS ON UNDERSIDE OF CONCRETE SLABS, INTERIOR OF FOUNDATION WALLS, INTERIOR OF EXTERIOR WALL WOOD STUDS, UNDERSIDE OF SUBFLOORS AND TOP OF DRYWALL CEILING BELOW ATTIC SPACE. TAPE AND SEAL ALL PENETRATIONS THROUGH VAPOR BARRIER.
- 15. PROVIDE POLY SHEET SEPARATOR BETWEEN WOOD STUDS AND CONCRETE.
- 16. ROOF VENT AREA SHALL BE A MINIMUM 1/300 OF THE INSULATEDCEILING AREA WITH MINIMUM OF 25% AT TOP OF ATTIC SPACE AND MINIMUM 25% AT SOFFIT. PROVIDE CROSS VENTILATION BETWEEN DIFFERENT ATTIC SPACE COMPARTMENTS
- 17. INSTALL 13mm DENSSHIELD TILE BACKER SHEATHING OR CEMENT BOARD AT SHOWER AND BATHTUB LOCATIONS.

## **EXTERIOR WALL TYPES:**



WOOD STUD WALL, LOAD BEARING, EXISTING

- NEW EXTERIOR STUCCO FINISH W/ REINFORCING MECH & CORNER PROTECTION. STUCCO COLOUR & TEXTURE TO MATCH EXISTING
- EXISTING 1" (25mm) RIGID INSULATION (R5)
- EXISTING AIR BARRIER
- EXISTING 7/16" (11mm) OSB SHEATHING
- EXISTING 2X6 (38X140mm) WOOD STUDS AT 16" (400mm) O.C.
- EXISTING 5-1/2" (140mm) BATT INSULATION (R22)
- NEW 6mil (0.15mm) POLYETHYLENE VAPOR BARRIER (V.B.)
- NEW 13mm (1/2") GYPSUM BOARD
- \* REPLACE EXISTING V.B. W/ NEW, LAP & SEAL TO EXISTING

## (ES1)

## WOOD STUD WALL, LOAD BEARING

- EXTERIOR STUCCO FINISH W/ REINFORCING MECH & CORNER PROTECTION. STUCCO COLOUR & TEXTURE TO MATCH EXISTING
- RIGID INSULATION, THICKNESS TO MATCH EXISTING, MIN. 1" (R5)
- AIR BARRIER, LAP & SEAL ONTO EXISTING
- 7/16" (11mm) OSB SHEATHING
- 2X6 (38X140mm) WOOD STUDS AT 16" (400mm) O.C.
- 3-1/2" THICK SPRAYED FOAM INSULATION, CLOSED CELL, MEDIUM DENSITY (R21), LAP & SEAL ONTO EXISTING POLY SHEEL V.B.
- NEW 13mm (1/2") GYPSUM BOARD



#### WOOD STUD WALL, GABLE, NON-LOAD BEARING

- EXTERIOR STUCCO FINISH TO BE FLUSH W/ STUCCO FINISH BELOW
- RIGID INSULATION
- 7/16" (11mm) OSB SHEATHING
- 2X6 (38X140mm) WOOD STUDS AT 16" (400mm) O.C. TO ALIGN UP STUD WALL BELOW

## **INTERIOR WALL TYPES:**



## INTERIOR WOOD STUD WALL, NON-LOAD BEARING

- 1/2" (12mm) GYPSUM BOARD
- 2X4 (38X89mm) WOOD STUDS @ 24" (600mm) O.C.
- 1/2" (12mm) GYPSUM BOARD (CEMENT BOARD AT WET AREA)

IS1\* - NO GYPSUM BOARD SHEATHING AT CONCEALED SIDE



## INTERIOR WOOD STUD NON-LOAD BEARING WALL

- 1/2" (13mm) GYPSUM BOARD
- 2X6 (38X140mm) WOOD STUDS @ 24" (600mm O.C.)
- 1/2" (13mm) GYPSUM BOARD

 $\langle$  IS3angle

## MINTERIOR FURRING WALL + SPRAYED FOAM INSUL

- EXISTING CONC. BLOCK EXTERIOR STRUCTURAL WALL
- 1/2" (13mm) AIR GAP
- 2X4 (38X89mm) WOOD STUDS @ 24" (600mm O.C.)
- 4" (102mm) SPRAYED FOAM INSUL.. CLOSED CELL AS V.B.
- 1/2" (13mm) GYPSUM BOARD

## FLOOR CONSTRUCTION:



### WOOD FLOOR JOISTS, EXISTING

- FLOOR FINISH AND UNDERLAY, FINISHED FLOOR TO BE FLUSH W/ ADJACENT EXISTING FINISHED FLOOR
- 5/8" (16mm) T&G PLYWOOD SUBFLOOR, GLUED & NAILED
   2X4 (2X6) WOOD SLEEPER @ 16"(400mm) O.C., CUT TO SUIT
- EXISTING HARDWOOD FLOOR
- EXISTING 5/8" (16mm) T&G OSB SUBFLOOR
- EXISTING 6mil POLY SHEET VAPOUR BARRIER
- EXISTING 2X12 WOOD JOISTS @ 12" O.C.
- EXISTING R32 BATT INSULATION
- EXISTING 2" RIGID INSULATION



#### WOOD FLOOR JOISTS

- FLOOR FINISH AND UNDERLAY, FINISHED FLOOR TO BE FLUSH W/ ADJACENT EXISTING FINISHED FLOOR
- PLYWOOD SUBFLOOR TO SUIT
- 5/8" (16mm) T&G PLYWOOD FLOOR SHEATHING, GLUED & NAILED
- REINSTALL & LEVEL EXISTING 2X12 WOOD JOISTS @ 12" O.C., PROVIDE WD BLOCK @ MID SPAN
- 1/2"X2" (13X50mm) WOOD STRAPPING
- 1/2" (13mm) GYPSUM BOARD CEILING

## **ROOF CONSTRUCTION:**



ROOF WOOD RAFTERS, SEE ELEVATIONS FOR SLOPE, MIN. R31

- ASPHALT SHINGLE
- SHINGLE UNDERLAY

APPLY ICE & WATER SHIELD MIN. 900mm UP ROOF AND MIN. 450mm INSIDE OF INTERIOR FACE OF EXTERIOR WALL.

- 7/16" (11mm) EXTERIOR GRADE PLYWOOD ROOF SHEATHING W/ "H" CLIP
- 2X6 WOOD RAFTERS @16"(400mm)
- $5\,\%$  " (140mm) MEDIUM DENSITY CLOSED CELL MEDIUM DENSITY SPRAYED FOAM INSULATION, R31 MIN.
- FURRING CHANNELS @ 16" (400mm) O.C. TO ACCOMMODATE CONDUITS AND RECESSED LIGHT FIXTURES
- ½" (13mm) GYPSUM BOARD CEILING, SLOPED
- ALONG ALL ROOF VALLEYS & CONJUNCTIONS WITH WALL, PROVIDE CONTINUOUS PRE-FINISHED METAL FLASHINGS & SELF-ADHESIVE V.B. MEMBRANE UNDERNEATH. EXTEND MTL FLASHING MIN. 4" AND V.B. MEMBRANE MIN. 10" @ EACH SIDE.



11-11-2022

## **LEGEND & ABBREVIATION:**



DOOR NUMBER



WINDOW NUMBER



EXTERIOR STUD WALL TYPE



CEILING TYPE



ROOF CONSTRUCTION TYPE

INTERIOR STUD WALL TYPE



FLOOR CONSTRUCTION TYPE



ROOM NAME AND NUMBER

FLOOR DRAIN



REMOVE EXISTING
CONSTRUCTION & ASSEMBLIES

CONSTRUCTION TO REMAIN



EXISTING DOOR, FRAME & HARDWARE TO REMAIN

**EXISTING BUILDING AND** 



NEW DOOR, FRAME & HARDWARE

## STRUCTURAL TABLES:

POST LEGEND

 $p3 = 3 - 38 \times 140 (2"x6") - POST$ 

### WOOD BEAMS AND LINTELS

- 1: 3-1.75" X 11.875" LVL NORDIC LAM INDUSTRIAL 24F - 1.9E,
- L2: 2-1.75" X 11.875" LVL NORTIC LAM INDUSTRIAL 24F 1.9E,
- L3: 2-1.75" X 9.5" LVL NORTIC LAM INDUSTRIAL 24F 1.9E.

LVL BEAMS SHALL BE LP LVL, 2900Fb-2,0E OR EQUIVALENT. NAIL EACH PLY OF LVL WITH 89mm LONG COMMON WIRE NAILS @300mm(12") O/C. STAGGERED IN 2 ROWS FOR 184,240 AND 300MM DEPTHS AND STAGGERED IN 3 ROWS FOR GREATER DEPTHS, FOR 4 PLY MEMBERS, ADD 13mm Dia. GALVANIZED BLOTS BOLTED AT MID-DEPTH OF BEAM@915mm O/C.

LUMBER S.P.F. SPRUCE NO.2 MIN.

# BING PROFESSIONAL ENGINEERING INC.

150 Katimavik Rd, Unit 204, Ottawa, ON K2L 2N2 Phone: (613) 435 - 6665 E-mail: welcome@bingpro.ca JOB EXISTING 3-STOREY DETACHED SINGLE HOUSE ALTERATION
241 HILLCREST RD, OTTAWA, ON K1M 0J4

DRAWING INFORMATION SHEET

DATE: 2022-11-08
REV DATE: No:
SCALE: AS NOTED OF:

DRAWING No.

REV.
No:
PART
OF:
PROJ.
No:O-22-GEN-37

## **DEMOLITION GENERAL NOTES:**

- LOCALLY SAWCUT AND REMOVE EXISTING CONCRETE SLAB AS REQUIRED FOR INSTALLATION OF NEW UNDER-SLAB PLUMBING, REINSTATE CONCRETE SLAB & UNDER-SLAB VAPOR BARRIER.
- 2. LOCALLY REMOVE EXISTING CONSTRUCTION AND FINISHES AS REQUIRED FOR NEW WORK. REINSTATE TO MATCH EXISTING.

## **DEMOLITION DRAWING NOTES:**

- COMPLETELY REMOVE ALL EXISTING INTERIOR
  DRYWALL SHEATHING IN ROOMS INCLUDING WALL AND
  CEILING, UNLESS NOTED OTHERWISE.
- REMOVE EXISTING FIREPLACES & CHIMNEY & ALL WOOD STUD FURRING WALLS. EXISTING CONCRETE BLOCK WALL TO REMAIN INCLUDING BLOCKS ABOVE DOORWAY AND RECESS CHAMBER. PROVIDE TEMPORARY STRUCTURAL SUPPORT IF REQUIRED PRIOR TO REMOVAL.
- EXISTING WOOD FLOORING AND OSB SUBFLOOR TO REMAIN.
- 4 EXISTING COLUMNS TO REMAIN.
- 5 EXISTING INTERIOR PARTITION WALL TO REMAIN. REMOVE EXISTING DRYWALL SHEATHING.
- 6 REMOVE EXISTING INTERIOR PARTITION WALLS, DOORS, AND HARDWARE.
- 7 EXISTING INTERIOR WALL TO REMAIN
- REMOVE EXISTING CABINET MILLWORK, SINK AND OVEN. REVISE ASSOCIATED EXISTING PLUMBING AND EXHAUSTS. FILL EXISTING EXTERIOR WALL OPENINGS AS REQUIRED.
- 9 REMOVE EXISTING STAIR.
- REMOVE EXISTING LANDING. SEE NEW PLAN FOR NEW FLOOR ELEVATION.
- REMOVE EXISTING CONCRETE BLOCK WALL. PRIOR TO THE REMOVAL, CONFIRM EXISTENCE OF EXISTING COLUMN TO REMAIN
- REMOVE EXISTING ROOFING, FASCIA CROWN MOULD,
  AND SOFFIT. TEMPERORARIELY REMOVE EXISTING
  SLOPED ROOF JOISTS AS REQUIRED, REINSTALL AND
  LEVEL THE JOISTS. REPLACE EXISTING OSB/PLYWD
  ROOF UNDERLAY W/ 5/8" T&G PLYWD. PROVIDE
  ADDITIONAL PLYWD SHEATHING AS REQ'D TO MAKE
  NEW FLOOR FINISH FLUSH W/ EXISTING ADJACENT
  SPACE
- (13) REMOVE EXISTING WINDOW, FRAME AND TRIMS
- SAWCUT & REMOVE EXISTING EXTERIOR WALL TO ACCOMMODATE NEW DOOR. PROVIDE STRUCTURAL REINFORCEMENT AT JAMB & HEAD PRIOR TO SAWCUT.
- SAWCUT & REMOVE EXISTING WINDOW SILL TO ACCOMMODATE NEW DOOR.
- REMOVE EXISTING STUCCO EXTERIOR FINISH WHERE TO BECOME INTERIOR OF ADDITION AND UNDER NEW BOOF
- REMOVE EXISTING BATHROOM INCLUDING BUT NOT LIMITED TO ALL PLUMBING FIXTURES, ACCESSORIES AND FINISHES
- REMOVE EXISTING LOAD-BEARING WALL. PRIOR TO REMOVAL, PROVIDE STRUCTURAL SUPPORT.
- (19) REMOVE EXISTING DOOR, FRAME AND TRIM
- REMOVE EXISTING STEEL FIRE ESCAPE, DECK AND STEPS. EXISTING BALCONY TO REMAIN
- (21) REMOVE EXISTING PONY WALL
- CUT EXISTING ROOF SHEATHING BETWEEN TWO
  ADJACENT RAFTERS/TOP CHORDS TO ACCOMMODATE
  NEW SKYLIGHT. REUSE COVERED OPENINGS OF
  DISCOMMISSIONED OF SKYLIGHTS.
- REMOVE EXISTING WINDOW AND DOOR, BUT KEEP ON SITE AS REFERENCE FOR NEW DOOR AND DOOR TO MATCH. ELEVATE OPENING TO RECEIVE NEW WINDOW & DOOR. REPLACE EXISTING WOOD POSTS & LINTEL W/ NEW.
- REMOVE EXISTING STUCCO EXTERIOR FINISH, REINSTATE TO MATCH EXISTING.
- 25 REPLACE EXISTING WINDOW POSTS AS REQUIRED
  - > SALVAGE EXISTING CORNER STONE FOR REUSE.

## **CONSTRUCTION GENERAL NOTES:**

- 1. ALL WORK SHALL BE COMPLETE IN ACCORDANCE WITH THE LATEST EDITION OF ONTARIO BUILDING CODE 2012, PART 9 AND PART 11, AND ALL APPLICABLE SUPPLEMENTS AND ANY MUNICIPAL BYLAWS.
- 2. ALL INTERIOR FINISHES AND FIXTURES SHALL BE SELECTED BY THE OWNER, PROVIDED AND INSTALLED BY CONTRACTOR, INCLUDING BUT NOT LIMITED TO PAINTS, FLOORING, WALL BASES, CEILING, LIGHTS, CABINETRY, WINDOW, DOORS, ETC.

## **DRAWING NOTES:**

- NEW 2x4 WOOD STUD @ 24" O.C EACH WAY ON EXISTING OSB SUBFLOOR, C/W NEW 5/8" PLYWD SUBFLOOR ON TOP. ADD NEW 3/8" PLYWD AS REQUIRED. NEW FLOOR FINISH IN READING ROOM TO BE FLUSH WITH LIVING ROOM.
- 2 NEW ELECTRIC FIREPLACE, LOCATION TO COORDINATE ON SITE. REUSE EXISTING BLOCK WALL FIREPACE RECESS IF PRACTICAL.
- (3) NEW PRIVACY SCREEN. REFER TO INTERIOR DESIGN
- 4 NEW INTERIOR WOOD STAIR CONSTRUCTION
   CONFORM TO OBC 2012, 9.8.7. HANDRAILS & 9.8.8.
  GUARDS AND MMAH SUPPLEMENTARY STANDARD
  - GUARDS 42" HIGH AFF, HANDRAIL 3' HIGH AFF

  - WOOD MEMBERS MINIMUM SIZE: POST 4"X4", TOP & BOTTOM RAILS 2"X4", PICKETS 1  $\%_2$ "X1  $\%_2$ " @ MAX. 4" O.C., RISERS & TREADS 1  $\%_2$ " THICK X WIDTH TO CUT TO SUIT
  - STRINGERS TO BE 2X10
  - RISE TO BE MAX. 8" HIGH, AND RUN TO BE MIN. 10" DEEP
- 5 NEW SKYLIGHT
- 6 INFILL PANEL TO FILL EXISTING WINDOW OPENING.
  OVERLAP AND SEAL NEW VAPOUR BARRIER TO EXISITNG.
  R VALUE TO BE 24. NEW EXTERIOR STUCCO TO MATCH,
  FLUSH AND BLEND WITH EXISTING.
- 7 LAMINATE NEW 1" THICK RIGID INSULATION BOARD ON INTERFACE OF EXISTING EXTERIOR WALL, INSTALL 6mil POLY SHEET VAPOR BARRIER, AND 1/2" (13mm) NEW DRYWALL SHEATHING. TIE POLY V.B. WITH NEW SPRAYED FOAM INSULATION.
- 8 INSTALL NEW 6mil POLY SHEET VAPOR BARRIER AND 1/2"(13mm) GYPSUM BOARD INTERIOR SHEATHING ON INTERIOR FACE OF EXISTING EXTERIOR WALL @ READIND ROOM 109, BREAKFAST 104 AND STAIR A2
- 9 REINSTATE EXTERIOR STUCCO FINISH, COLOUR AND TEXTURE TO MATCH EXISTING.
- 10 NEW WOOD WINDOW, TRIM/CASING, COLOUR, AND CONFIGURATION MATCH EXISTING. WINDOW HEIGHT AND SILL HEIGHT TO MATCH EXISTING WINDOW.
- NEW WOOD WINDOW, TRIM/CASING, COLOUR, AND CONFIGURATION MATCH EXISTING.
- NEW WOOD WINDOW TO FILL DOOR OPENING, COLOUR TO MATCH EXISTING.
- (13) NEW 3-2X6 POST. REPAIR INSULATION & V.B.
- REFER TO STRUCTURAL FOR NEW STEEL REINFORCEMENT AT NEW OPENING THROUGH EXISTING BLOCK WALL.
- COLUMN ON WINDOW LINTEL TO SUPPORT RIDGE BEAM ABOVE
- FINISHED STUCCO AT ADDITION TO BE FLUSH WITH EXISTING
- REPAIR & REINSTATE EXISTING STUCCO & RIGID INSUL.
  AFFECTED BY CONSTRUCTION. REPLACE EXISTING
  CORNER STONES WHERE TO BE REMOVED WITH RIGID
  INSULATION



11-11-2022


# BING PROFESSIONAL ENGINEERING INC.











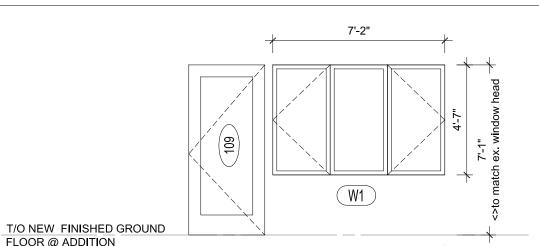

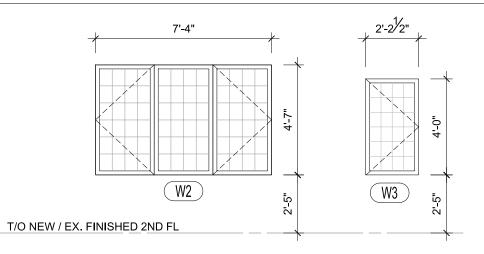

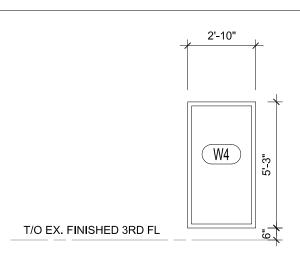

A0.3/

FLOOR @ ADDITION

## WINDOW ELEVATION

SCALE: 1/4" = 1'-0"

### **GENERAL NOTES:**

- SITE VERIFY ALL R.O. SIZES PRIOR TO P.O. AND INSTALLATION
- NEW WINDOWS @ ADDITION TO BE WOOD FRAME, INSULATED UNIT, COLOUR TO MATCH EXISTING.
- 3. WINDOW "W2" & "W3" TO BE FURNISHED W/ MUNTIN BARS, CONFIGURATION TO MATCH EXISTING

DOOI	R SCHEDULE NOTES:	CONTRACTOR TO VERIFY ALL E     ALL DOORS SHALL BE PROVIDE     ALL DOORS EQUAL TO OR ABO	D A LEVER AND DOOR STO	OP, UNLESS OTHERWISE	NOTED.		
NO.	LOCATION	DOOR TYPE	DOOR SIZE	FRAME TYPE	THROAT WIDTH	HARDWARE	REMARKS
101A	CLOSET	HOLLOW CORE WOOD	2-2'-4" X 6'-8"	WD		PASSAGE SET, LEVER	
106	POWDER	HOLLOW CORE WOOD	2'-4" X 6'-8"	WD		TOP TRACK, PULL, STOP	POCKET DOOR
107	STORAGE	HOLLOW CORE WOOD	2'-4" X 6'-8"	WD		STORAGE SET, LEVER	
109	READING ROOM	INSULATED PVC	3'-2" X 7'-1"	WD ENTRANCE SET, LEVER, THRESHOLD, WEATHERSTRIP,		VISION GLASS	
201	BEDROOM 201	HOLLOW CORE WOOD	2'-6" X 6'-8"	WD		PRIVACY SET, LEVER, STOP	
201A	CLOSET 201A	HOLLOW CORE WOOD	2-2'-4" X 6'-8"	WD		PASSAGE SET, LEVER	
202	BEDROOM 202	HOLLOW CORE WOOD	2'-6" X 6'-8"	WD		PRIVACY SET, LEVER, STOP	
202A	CLOSET 202A	HOLLOW CORE WOOD	2-2'-4" X 6'-8"	WD		PASSAGE SET, LEVER	
202B	BATHROOM 204B	HOLLOW CORE WOOD	2'-6" X 6'-8"	WD		PRIVACY SET, LEVER, STOP	
203	LINEN 203	HOLLOW CORE WOOD	2'-0" X 6'-8"	WD		PASSAGE SET, LEVER	
205	BATHROOM 205	HOLLOW CORE WOOD	2'-6" X 6'-8"	WD		PRIVACY SET, LEVER	
206	LAUNDRY 206	HOLLOW CORE WOOD	2'-8" X 6'-8"	WD	PASSAGE SET, LEVER, STOP		
207	BEDROOM 207	HOLLOW CORE WOOD	2'-6" X 6'-8"	WD		PRIVACY SET, LEVER, STOP	
207A	WALK-IN CLOSET	HOLLOW CORE WOOD	2'-6" X 6'-8"	WD		TOP TRACK, PULL, STOP	POCKET DOOR
207B	ENSUITE BATHRM	HOLLOW CORE WOOD	V CORE WOOD 2'-6" X 6'-8" WD TOP TRACK, PULL, STOP POCKET DO		POCKET DOOR		
		I	I				
302	BATHROOM 302	HOLLOW CORE WOOD	2'-4" X 6'-8"	WD		PRIVACY SET, LEVER, STOP	
303	FLEX	HOLLOW CORE WOOD	2'-6" X 6'-8"	WD		PRIVACY SET, LEVER	




11-11-2022

## **BING PROFESSIONAL ENGINEERING INC.**

150 Katimavik Rd, Unit 204, Ottawa, ON K2L 2N2 Phone: (613) 435 - 6665 E-mail: welcome@bingpro.ca

ОВ	EXISTING 3-STOREY DETACHED SINGLE HOUSE ALTERATION	DATE: 2022-09-08	DRAWN: CHS
	7.2.2.011011	REV	REV.
	241 Hillcrest Road, Kanata, ON K1M 0J4	DATE:	No:
RAW	ING	SCALE:	PART
WINDOW ELEVATIONS AND DOOR SCHEDULE		AS NOTED	OF:
		REFER:	PROJ. No: <b>O-22-GEN-37</b>

DRAWING No. A0.3 FILE.DWG

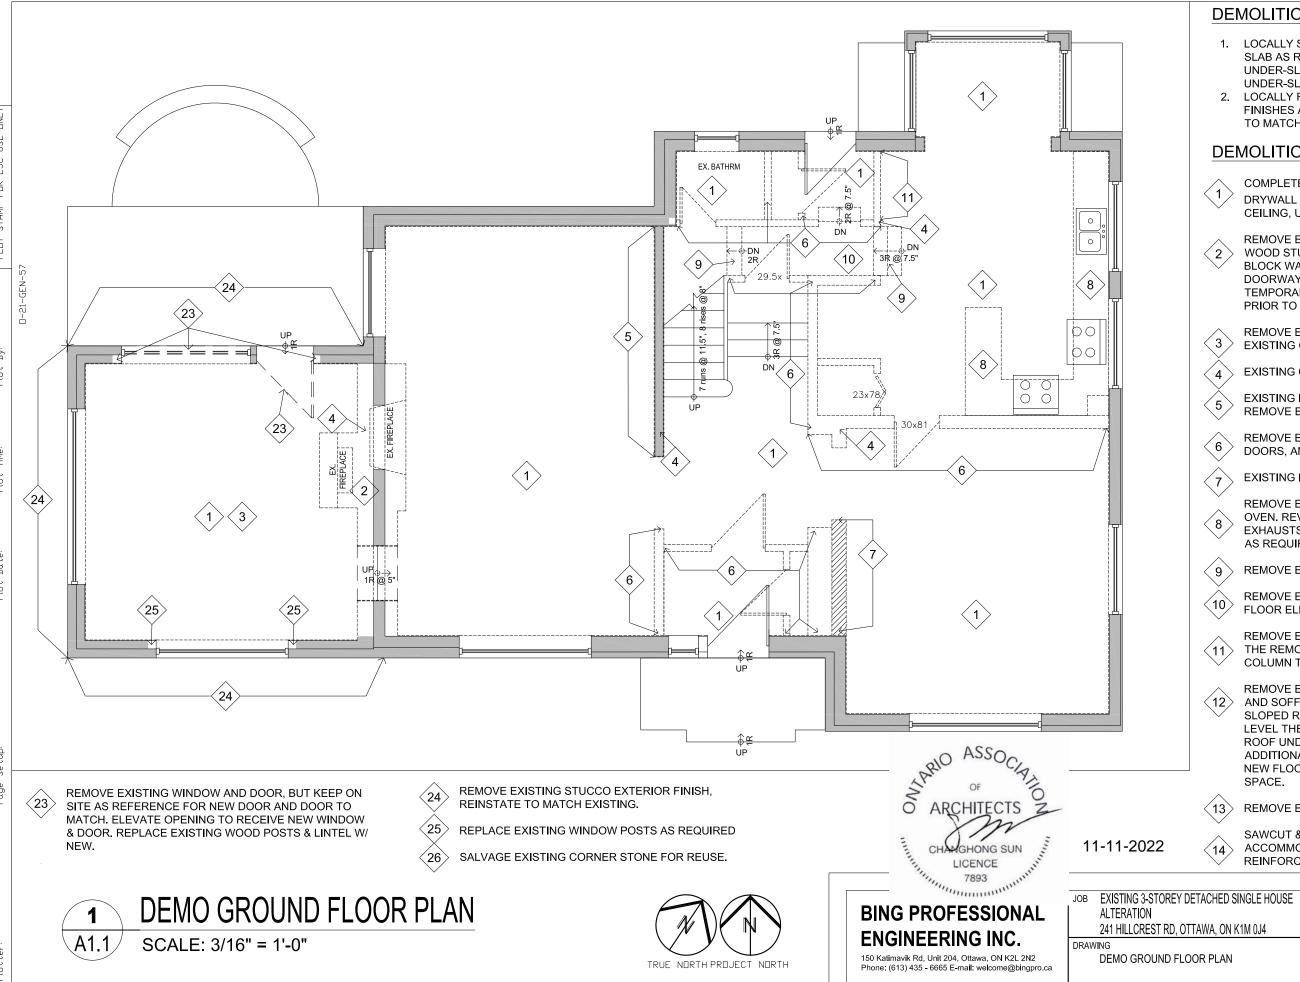


## **DEMOLITION GENERAL NOTES:**


- 1. LOCALLY SAWCUT AND REMOVE EXISTING CONCRETE SLAB AS REQUIRED FOR INSTALLATION OF NEW UNDER-SLAB PLUMBING. REINSTATE CONCRETE SLAB & UNDER-SLAB VAPOR BARRIER.
- 2. LOCALLY REMOVE EXISTING CONSTRUCTION AND FINISHES AS REQUIRED FOR NEW WORK. REINSTATE TO MATCH EXISTING.

## **DEMOLITION DRAWING NOTES:**

- COMPLETELY REMOVE ALL EXISTING INTERIOR DRYWALL SHEATHING IN ROOMS INCLUDING WALL AND CEILING, UNLESS NOTED OTHERWISE.
- REMOVE EXISTING FIREPLACES & CHIMNEY & ALL WOOD STUD FURRING WALLS. EXISTING CONCRETE BLOCK WALL TO REMAIN INCLUDING BLOCKS ABOVE DOORWAY AND RECESS CHAMBER. PROVIDE TEMPORARY STRUCTURAL SUPPORT IF REQUIRED PRIOR TO REMOVAL.
- REMOVE EXISTING WOOD FLOORING AND UNDERLAY. EXISTING OSB/PLYWD SUBFLOOR TO REMAIN.
- EXISTING COLUMNS TO REMAIN.
- EXISTING INTERIOR PARTITION WALL TO REMAIN. REMOVE EXISTING DRYWALL SHEATHING.
- REMOVE EXISTING INTERIOR PARTITION WALLS. DOORS, AND HARDWARE.
- **EXISTING INTERIOR WALL TO REMAIN**
- REMOVE EXISTING CABINET MILLWORK, SINK AND OVEN. REVISE ASSOCIATED EXISTING PLUMBING AND EXHAUSTS. FILL EXISTING EXTERIOR WALL OPENINGS AS REQUIRED.
- REMOVE EXISTING STAIR.
- REMOVE EXISTING LANDING. SEE NEW PLAN FOR NEW FLOOR ELEVATION.
- REMOVE EXISTING CONCRETE BLOCK WALL. PRIOR TO THE REMOVAL, CONFIRM EXISTENCE OF EXISTING **COLUMN TO REMAIN**
- REMOVE EXISTING ROOFING, FASCIA CROWN MOULD, AND SOFFIT, TEMPERORARIELY REMOVE EXISTING SLOPED ROOF JOISTS AS REQUIRED, REINSTALL AND LEVEL THE JOISTS. REPLACE EXISTING OSB/PLYWD ROOF UNDERLAY W/ 5/8" T&G PLYWD. PROVIDE ADDITIONAL PLYWD SHEATHING AS REQ'D TO MAKE NEW FLOOR FINISH FLUSH W/ EXISTING ADJACENT
- REMOVE EXISTING WINDOW, FRAME AND TRIMS
  - SAWCUT & REMOVE EXISTING EXTERIOR WALL TO ACCOMMODATE NEW DOOR, PROVIDE STRUCTURAL REINFORCEMENT AT JAMB & HEAD PRIOR TO SAWCUT.


DRAWN: DRAWING No. 2022-10-14 SCALE AS NOTED OF FILE.DWG PROJ.

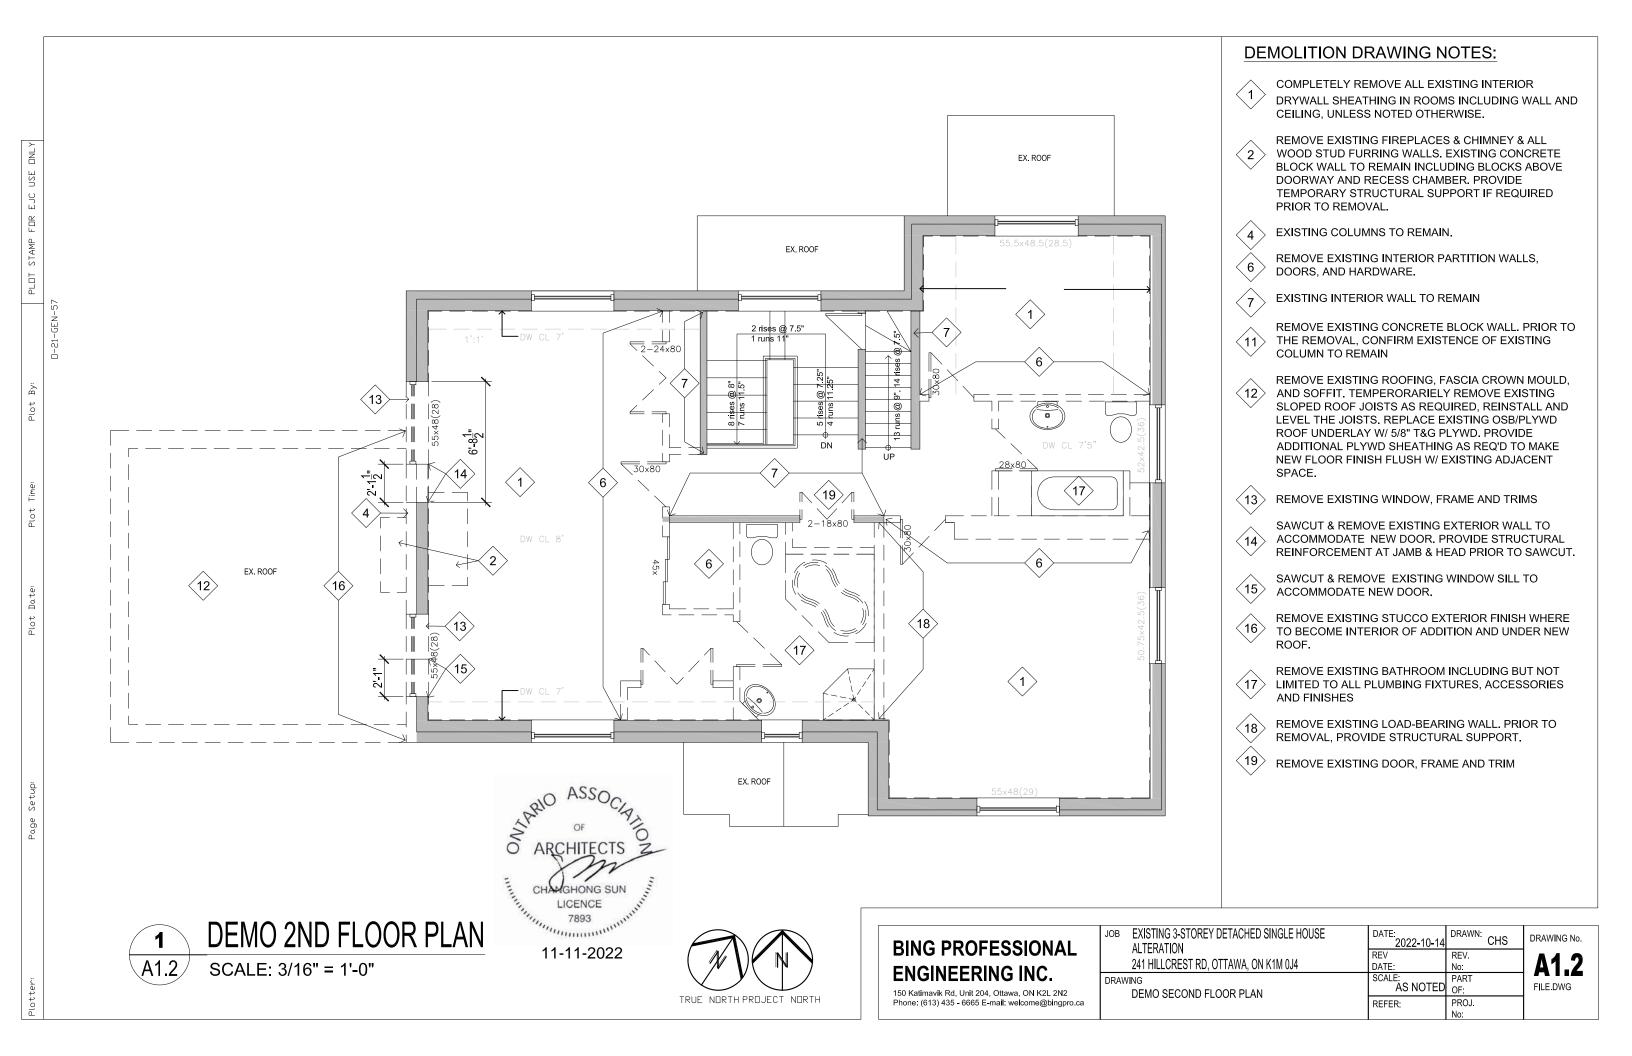

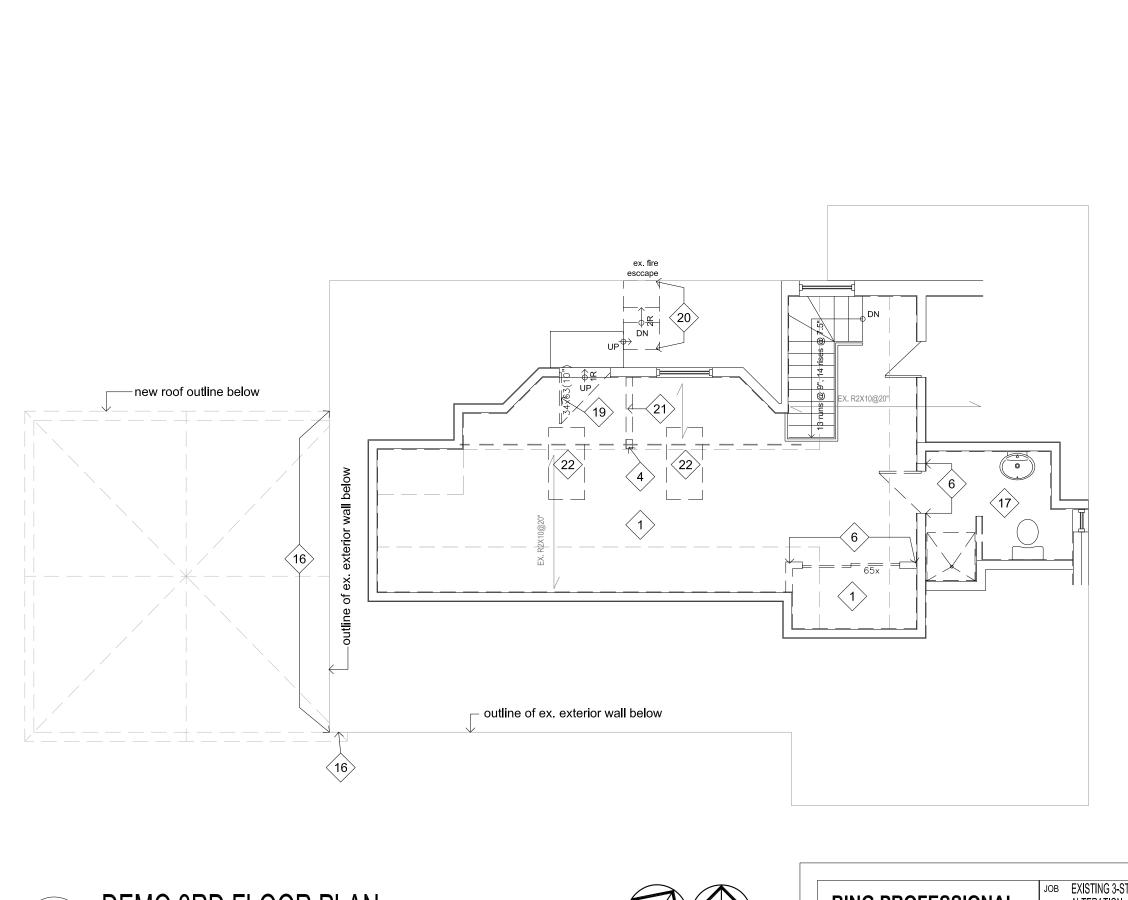

## DEMOLITION DRAWING NOTES:

COMPLETELY REMOVE ALL EXISTING INTERIOR
DRYWALL SHEATHING IN ROOMS INCLUDING WALL AND
CEILING, UNLESS NOTED OTHERWISE.

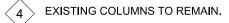

REMOVE EXISTING INTERIOR PARTITION WALLS, DOORS, AND HARDWARE.

REMOVE EXISTING STUCCO EXTERIOR FINISH WHERE TO BECOME INTERIOR OF ADDITION AND UNDER NEW ROOF.

REMOVE EXISTING BATHROOM INCLUDING BUT NOT LIMITED TO ALL PLUMBING FIXTURES, ACCESSORIES AND FINISHES

18 REMOVE EXISTING LOAD-BEARING WALL. PRIOR TO REMOVAL, PROVIDE STRUCTURAL SUPPORT.

19 REMOVE EXISTING DOOR, FRAME AND TRIM

20 REMOVE EXISTING STEEL FIRE ESCAPE, DECK AND STEPS. EXISTING BALCONY TO REMAIN

21 REMOVE EXISTING PONY WALL

22 CUT EXISTING ROOF SHEATHING BETWEEN TWO ADJACENT RAFTERS/TOP CHORDS TO ACCOMMODATE NEW SKYLIGHT. REUSE COVERED OPENINGS OF DISCOMMISSIONED OF SKYLIGHTS.



11-11-2022

1

DEMO 3RD FLOOR PLAN

SCALE: 3/16" = 1'-0"




# BING PROFESSIONAL ENGINEERING INC.


150 Katimavik Rd, Unit 204, Ottawa, ON K2L 2N2 Phone: (613) 435 - 6665 E-mail: welcome@bingpro.ca

JOB	EXISTING 3-STOREY DETACHED SINGLE HOUSE
	ALTERATION
	241 HILLCREST RD, OTTAWA, ON K1M 0J4
DRAW	/ING

DEMO THIRD FLOOR PLAN

 A1.3
FILE.DWG

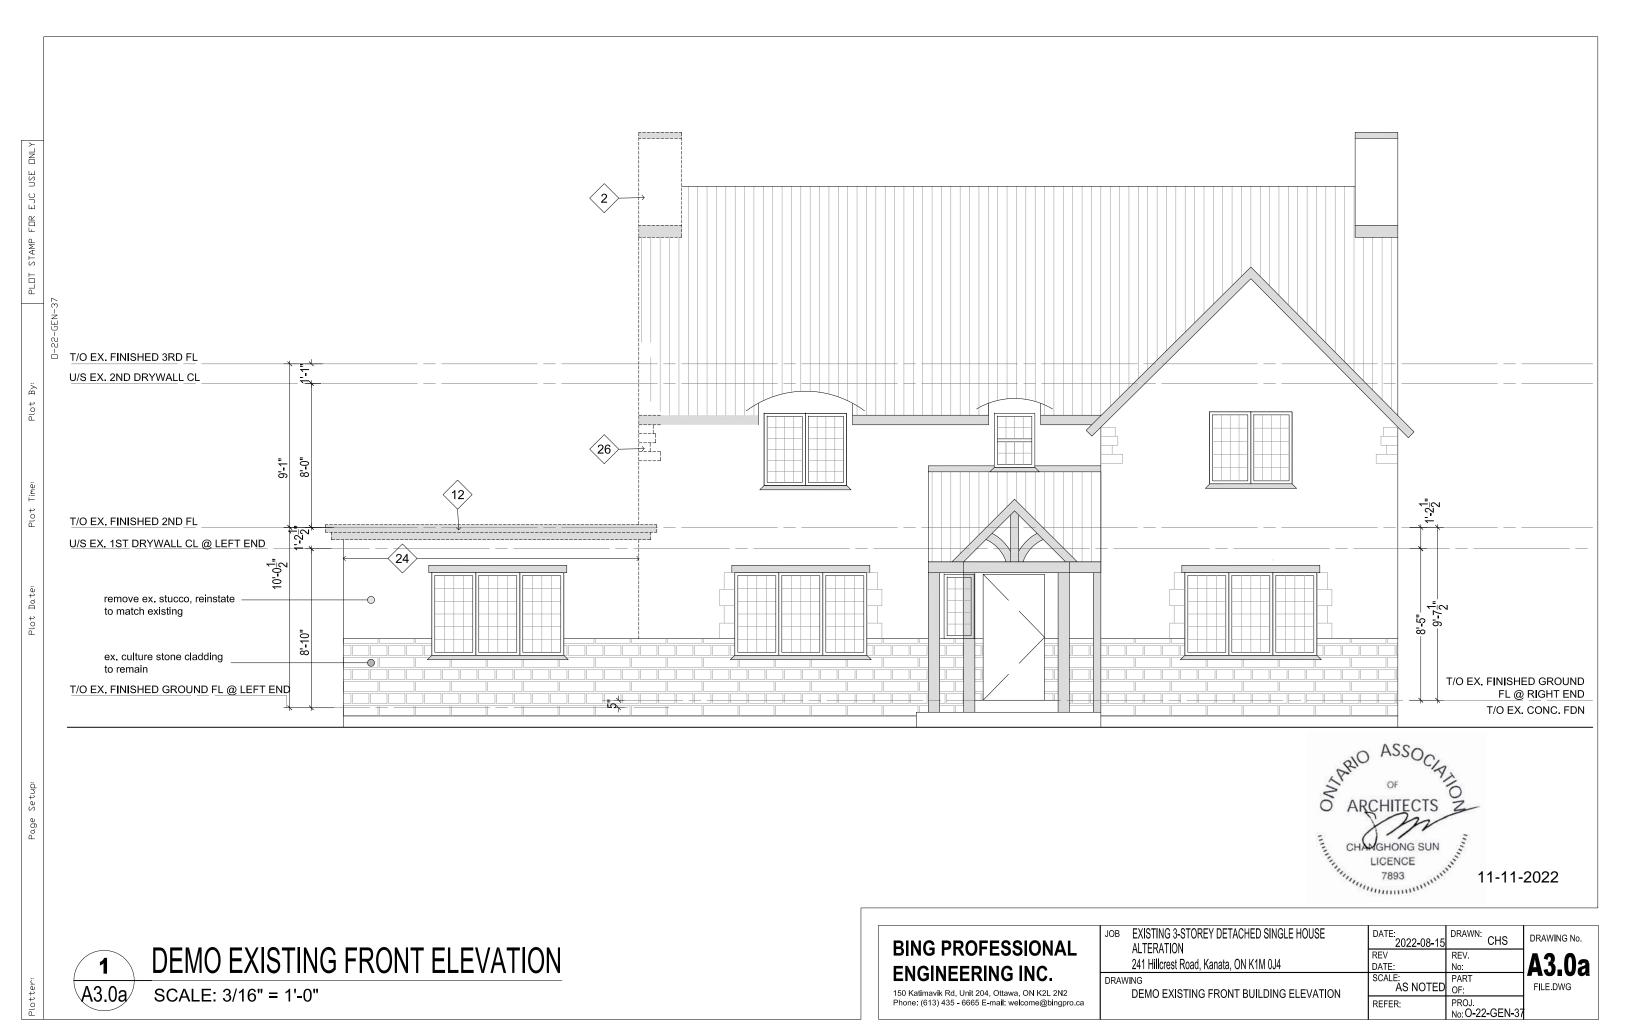

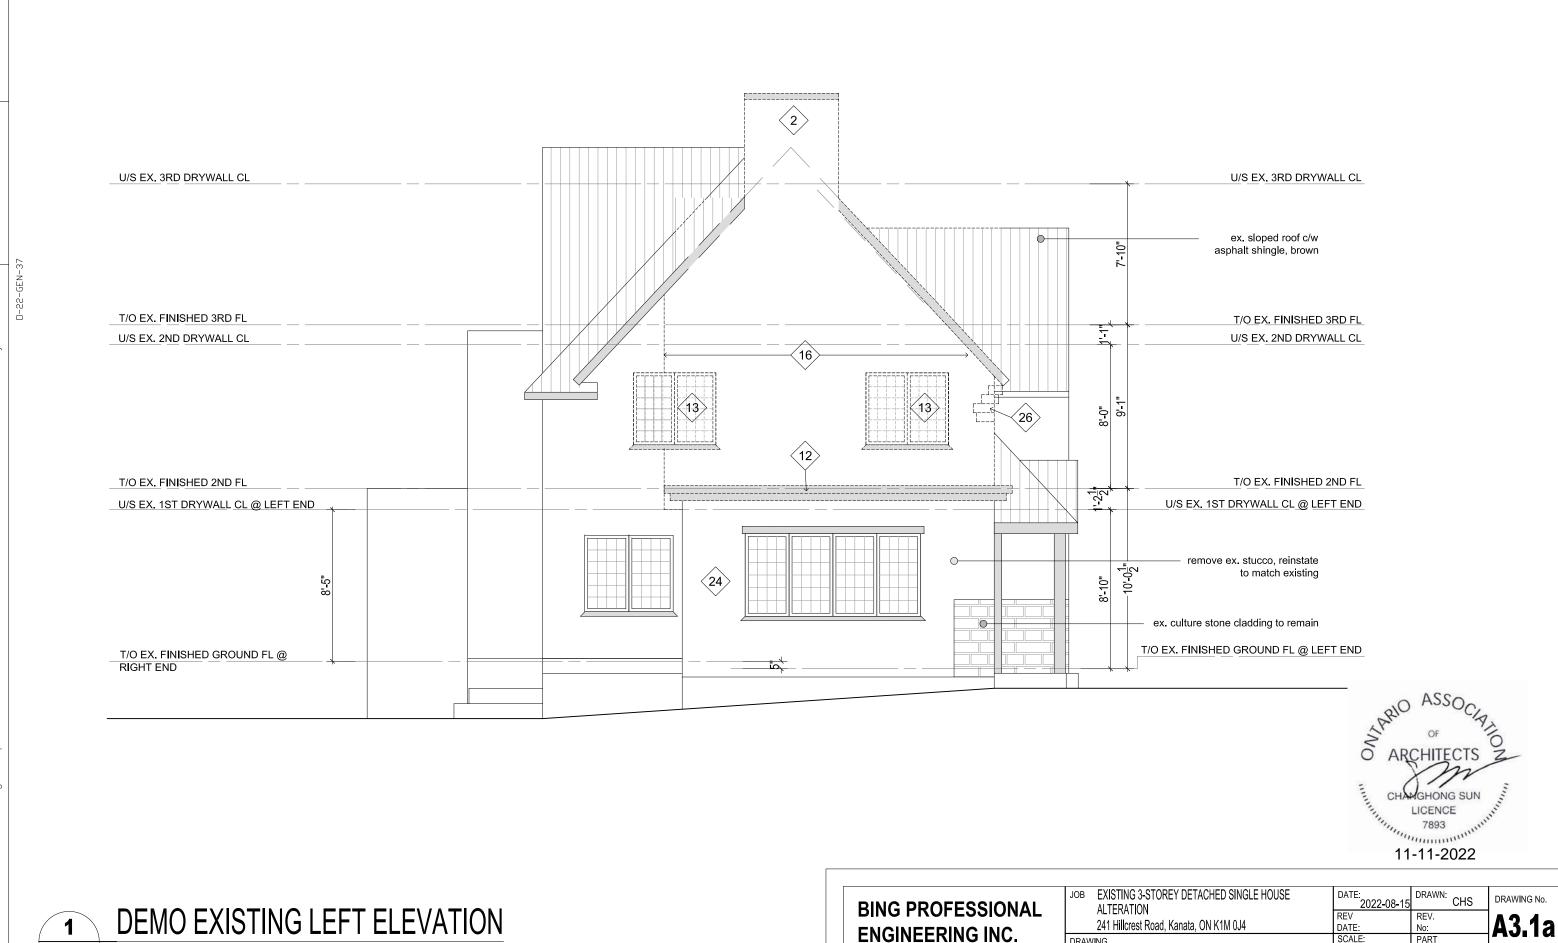

SCALE: PART OF

PROJ. No: O-22-GEN-3

FILE.DWG


DRAWING


DEMO EXISTING LEFT BUILDING ELEVATION


150 Katimavik Rd, Unit 204, Ottawa, ON K2L 2N2

Phone: (613) 435 - 6665 E-mail: welcome@bingpro.ca

SCALE: 3/16" = 1'-0"

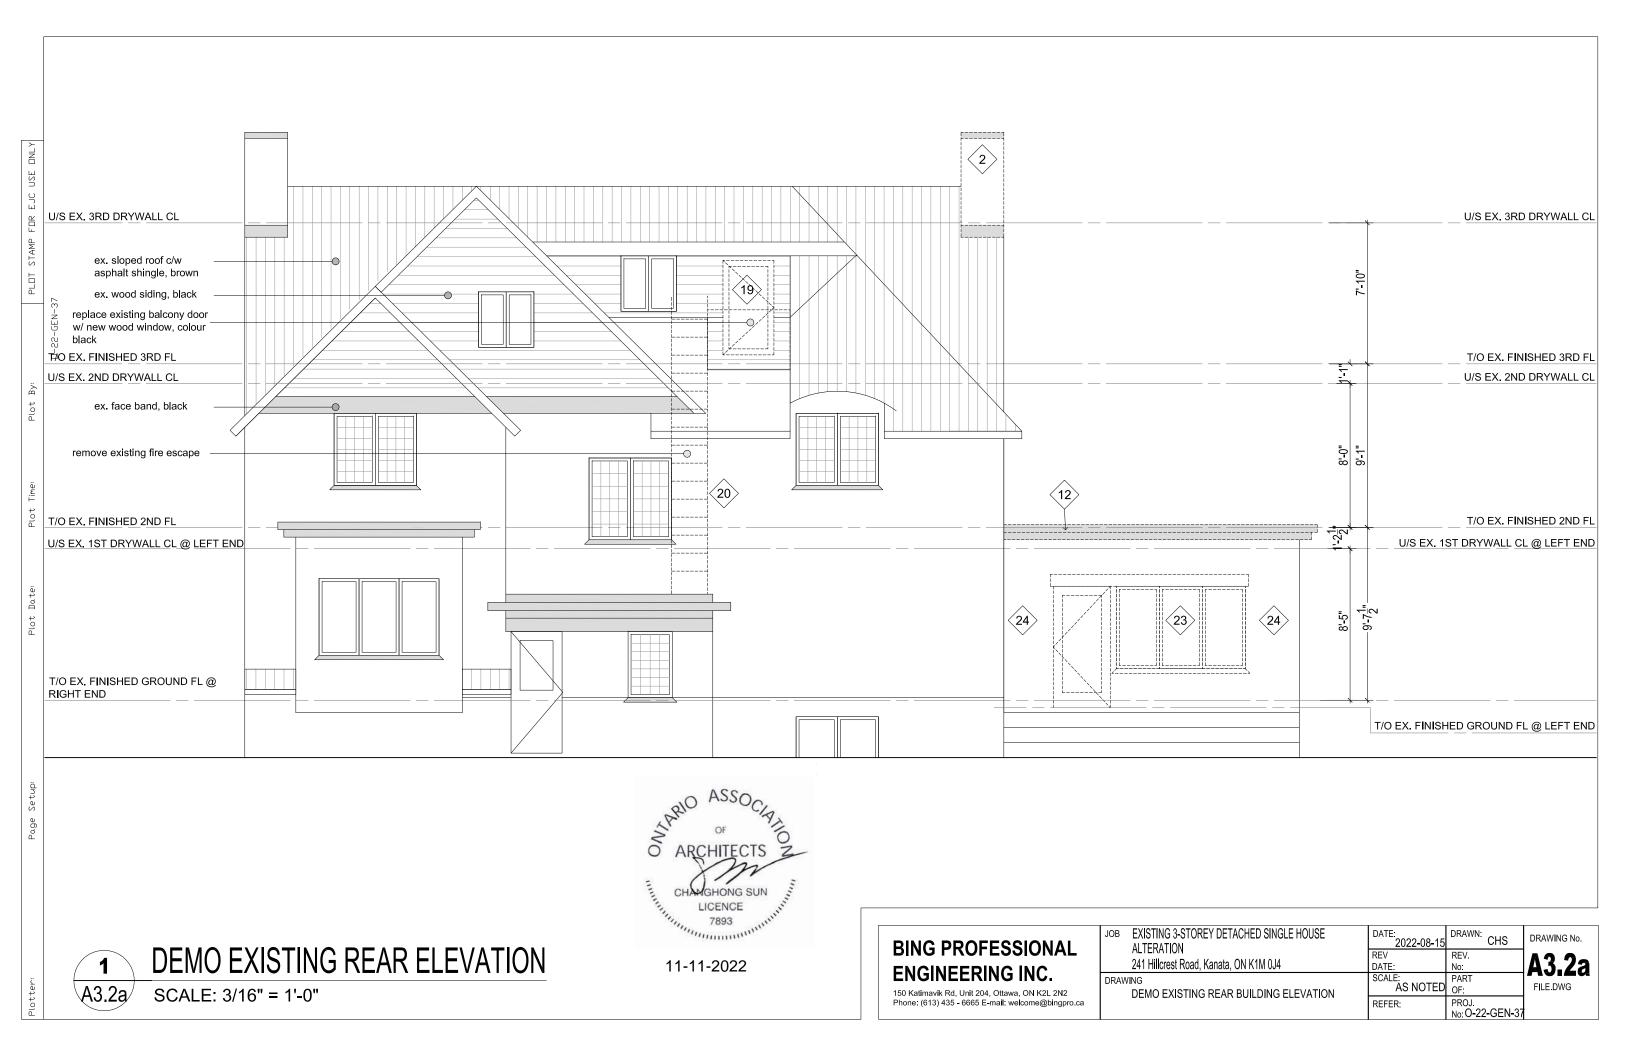

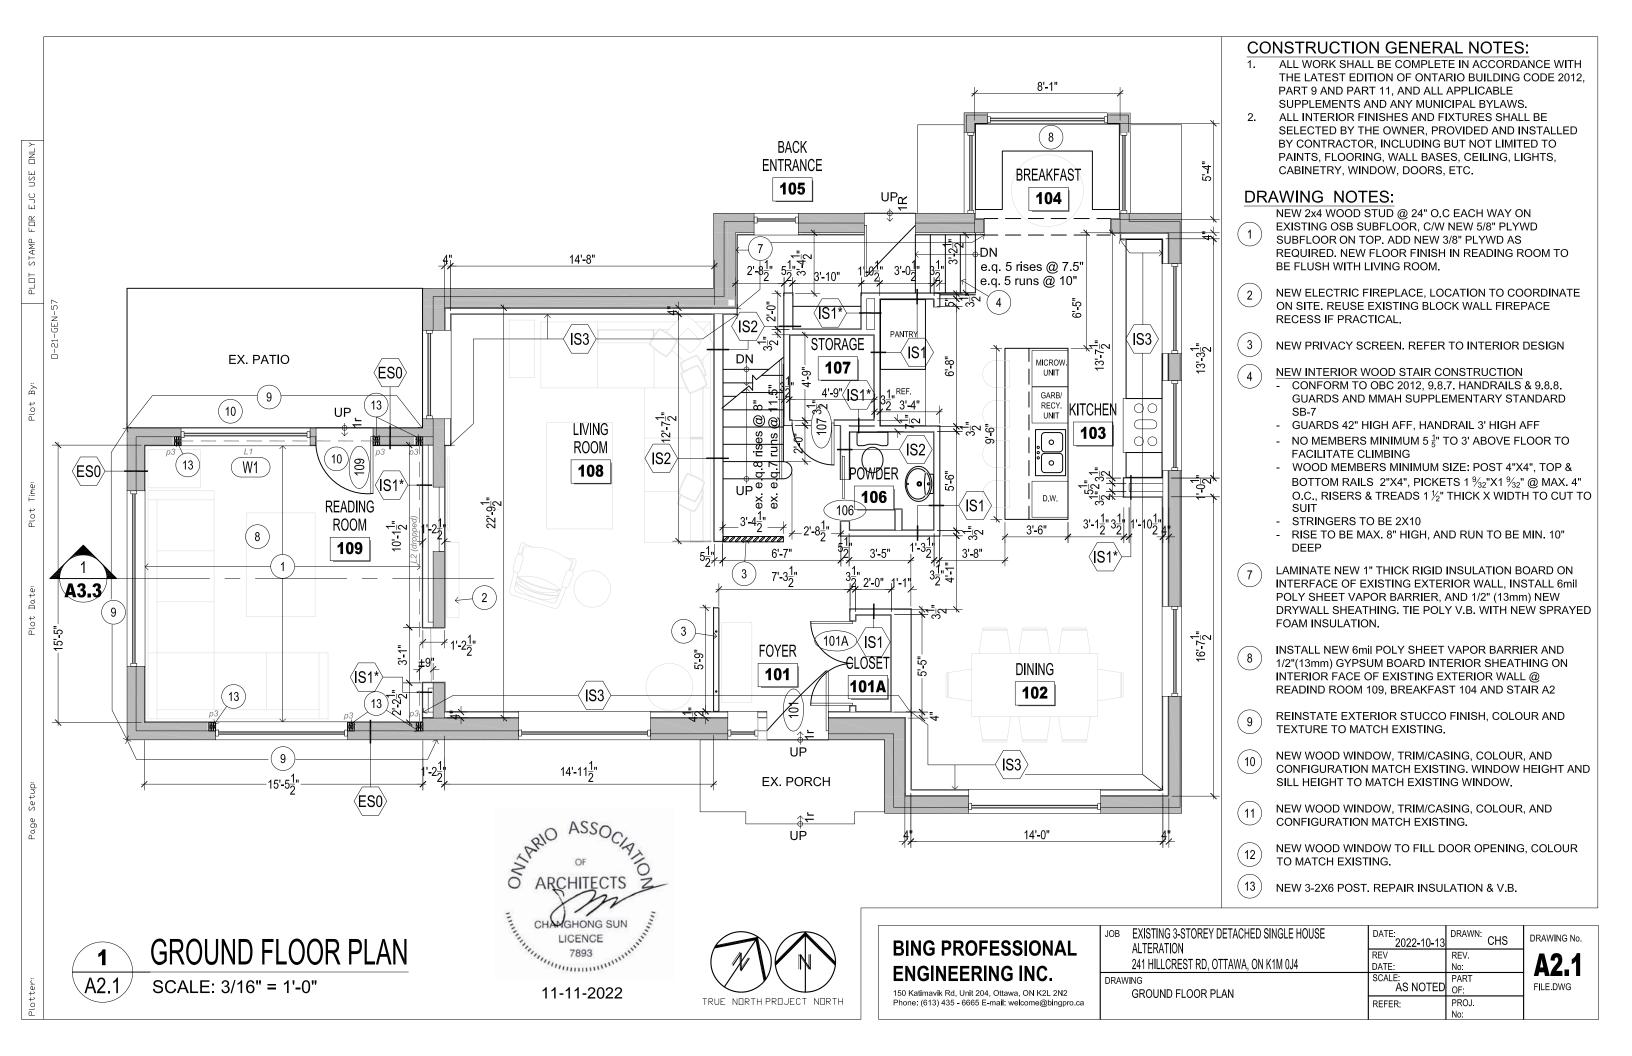

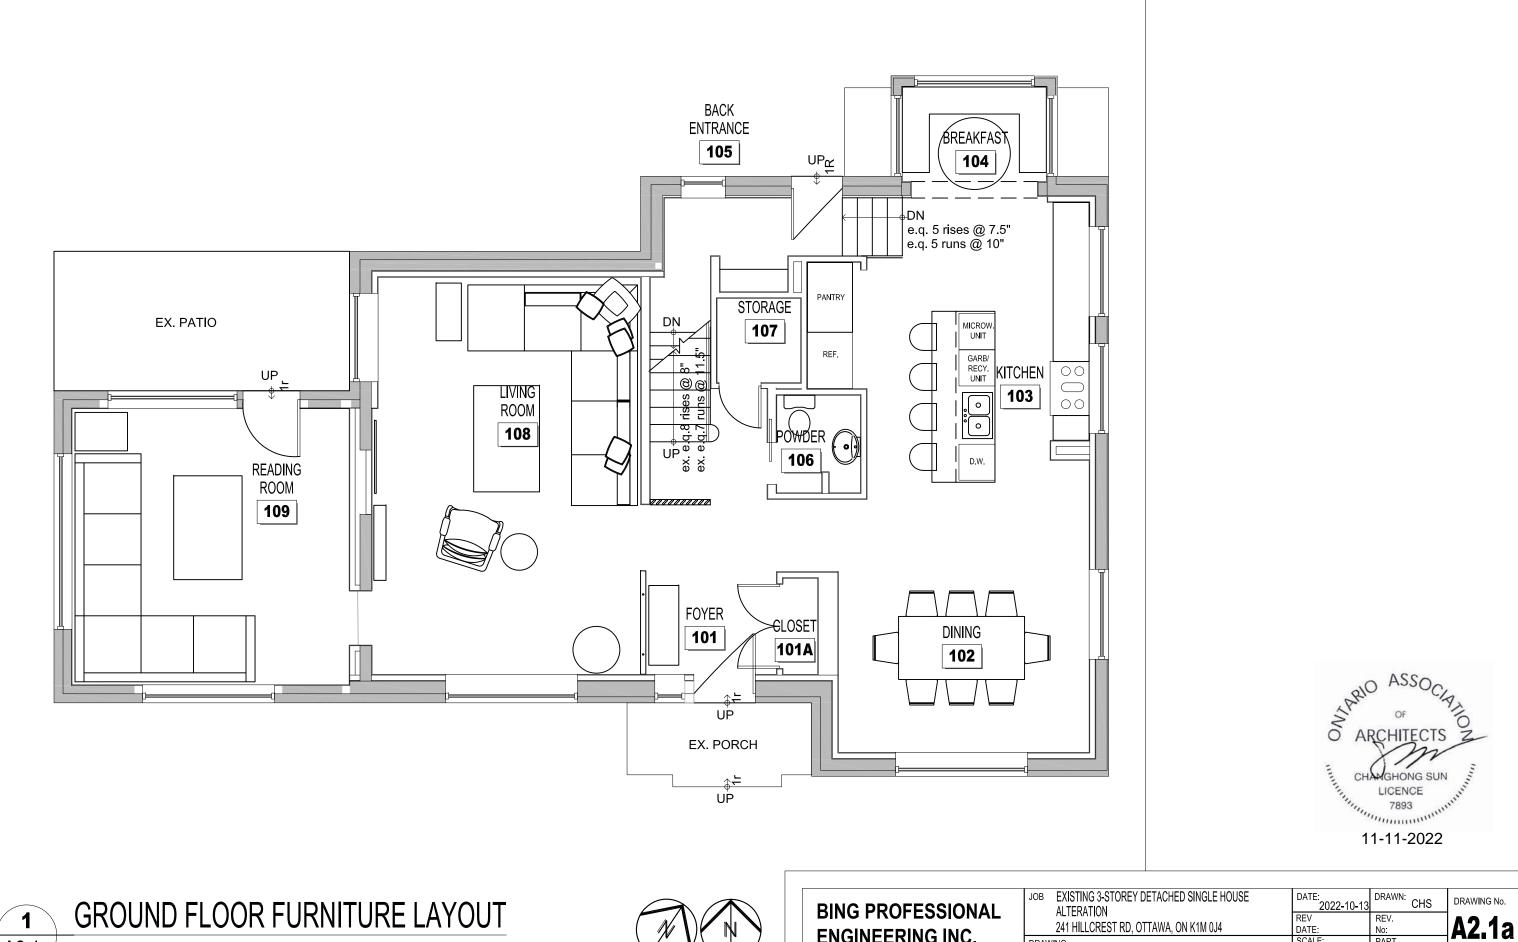

## GROUND FLOOR FURNITURE LAYOUT


SCALE: 3/16" = 1'-0"



## **ENGINEERING INC.**

150 Katimavik Rd, Unit 204, Ottawa, ON K2L 2N2 Phone: (613) 435 - 6665 E-mail: welcome@bingpro.ca

	JOB EXISTING 3-STOREY DETACHED SINGLE HOUSE ALTERATION	DATE: 2022-10-13	DRAWN: CHS	DR
	241 HILLCREST RD, OTTAWA, ON K1M 0J4	REV DATE:	REV. No:	Δ
DRAWING GROUND FLOOR FURNITURE LAYOUT		SCALE: AS NOTED	PART OF:	FII
	Chooling resolve or with one Extraor	REFER:	PROJ. No:	

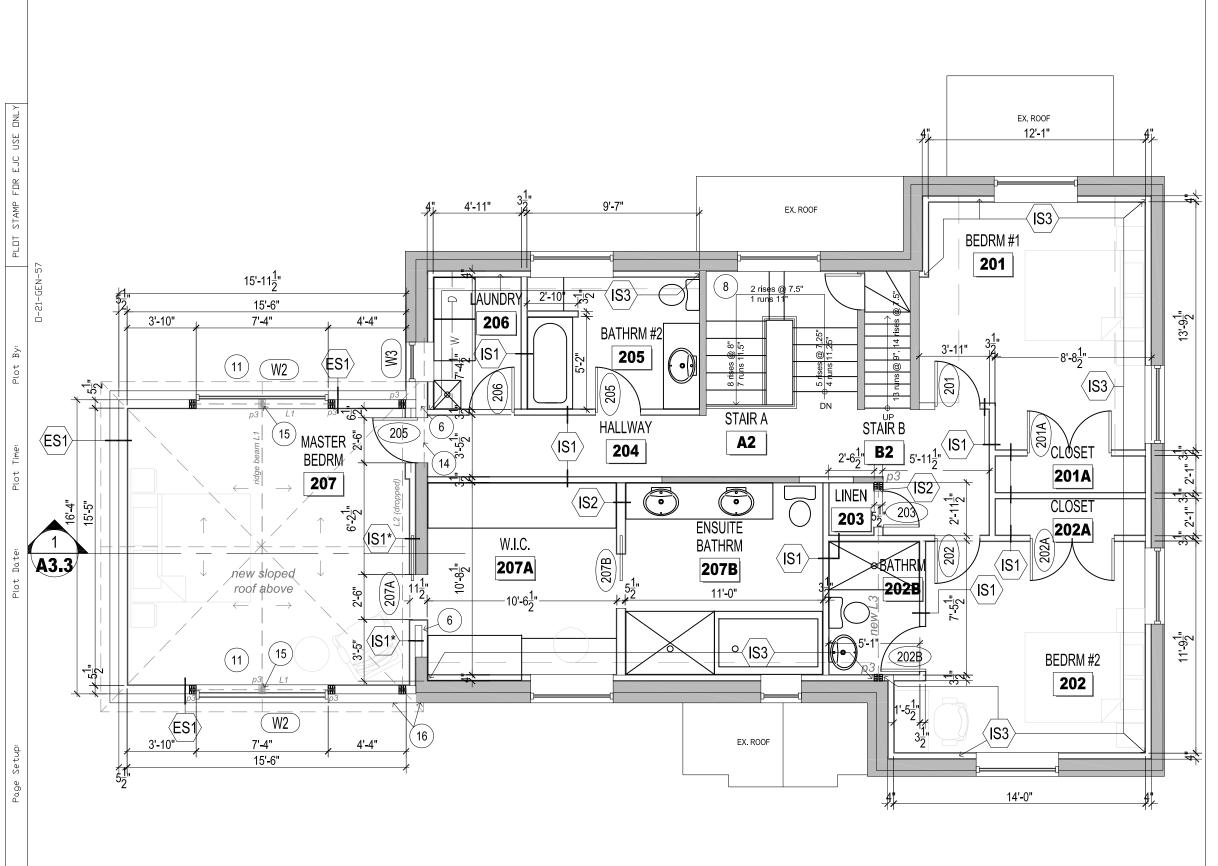

### CONSTRUCTION GENERAL NOTES:

- 1. ALL WORK SHALL BE COMPLETE IN ACCORDANCE WITH THE LATEST EDITION OF ONTARIO BUILDING CODE 2012, PART 9 AND PART 11, AND ALL APPLICABLE SUPPLEMENTS AND ANY MUNICIPAL BYLAWS.
- 2. ALL INTERIOR FINISHES AND FIXTURES SHALL BE SELECTED BY THE OWNER, PROVIDED AND INSTALLED BY CONTRACTOR, INCLUDING BUT NOT LIMITED TO PAINTS, FLOORING, WALL BASES, CEILING, LIGHTS, CABINETRY, WINDOW, DOORS, ETC.

## **DRAWING NOTES:**

- INFILL PANEL TO FILL EXISTING WINDOW OPENING.
  OVERLAP AND SEAL NEW VAPOUR BARRIER TO EXISITNG.
  R VALUE TO BE 24. NEW EXTERIOR STUCCO TO MATCH,
  FLUSH AND BLEND WITH EXISTING.
- 8 INSTALL NEW 6mil POLY SHEET VAPOR BARRIER AND 1/2"(13mm) GYPSUM BOARD INTERIOR SHEATHING ON INTERIOR FACE OF EXISTING EXTERIOR WALL @ READIND ROOM 109, BREAKFAST 104 AND STAIR A2
- 11 NEW WOOD WINDOW, TRIM/CASING, COLOUR, AND CONFIGURATION MATCH EXISTING.
- REFER TO STRUCTURAL FOR NEW STEEL REINFORCEMENT AT NEW OPENING THROUGH EXISTING BLOCK WALL.
- COLUMN ON WINDOW LINTEL TO SUPPORT RIDGE BEAM ABOVE



11-11-2022



SECOND FLOOR PLAN

SCALE: 3/16" = 1'-0"



# BING PROFESSIONAL ENGINEERING INC.

150 Katimavik Rd, Unit 204, Ottawa, ON K2L 2N2 Phone: (613) 435 - 6665 E-mail: welcome@bingpro.ca

JOB	EXISTING 3-STOREY DETACHED SINGLE HOUSE
	ALTERATION
	241 HILLCREST RD, OTTAWA, ON K1M 0J4
DRAV	VING

2ND FLOOR PLAN

DATE: DRAWN: CHS

REV REV.
DATE: No:
SCALE: PART
AS NOTED OF:
REFER: PROJ.

A2.2
FILE.DWG





## 2ND FLOOR FURNITURE LAYOUT


SCALE: 3/16" = 1'-0"



## **ENGINEERING INC.**

150 Katimavik Rd, Unit 204, Ottawa, ON K2L 2N2 Phone: (613) 435 - 6665 E-mail: welcome@bingpro.ca

JOB	EXISTING 3-STOREY DETACHED SINGLE HOUSE ALTERATION	DATE: 2022-10-13	DRAWN: CHS	DRAWING N
	241 HILLCREST RD, OTTAWA, ON K1M 0J4	REV DATE:	REV. No:	Δ2.2
DRAWING 2ND FLOOR FURNITURE LAYOUT		SCALE: AS NOTED	PART OF:	FILE.DWG
	ZHO I ZOOM OMMONE ZHOOT	REFER:	PROJ. No:	

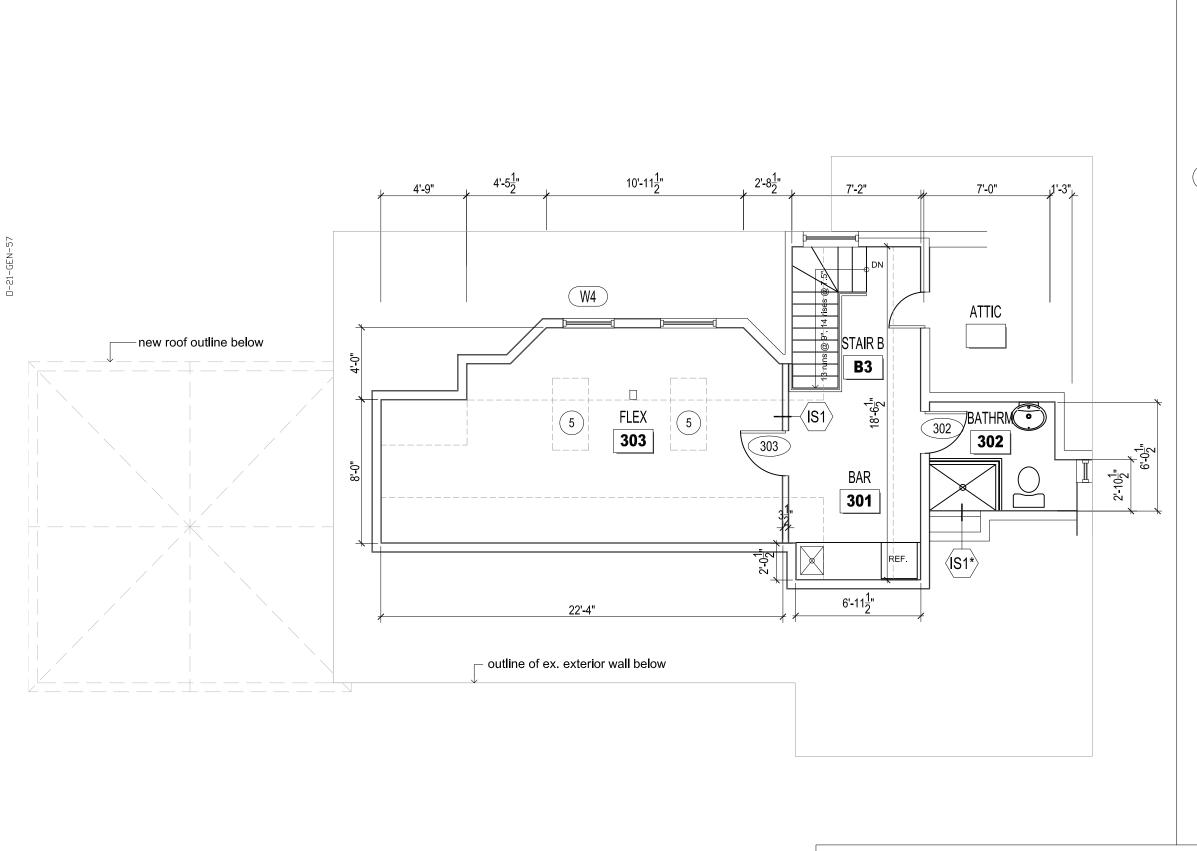

## CONSTRUCTION GENERAL NOTES:

- 1. ALL WORK SHALL BE COMPLETE IN ACCORDANCE WITH THE LATEST EDITION OF ONTARIO BUILDING CODE 2012, PART 9 AND PART 11, AND ALL APPLICABLE SUPPLEMENTS AND ANY MUNICIPAL BYLAWS.
- 2. ALL INTERIOR FINISHES AND FIXTURES SHALL BE SELECTED BY THE OWNER, PROVIDED AND INSTALLED BY CONTRACTOR, INCLUDING BUT NOT LIMITED TO PAINTS, FLOORING, WALL BASES, CEILING, LIGHTS, CABINETRY, WINDOW, DOORS, ETC.

## DRAWING NOTES:

NEW SKYLIGHT



11-11-2022



THIRD FLOOR PLAN
SCALE: 3/16" = 1'-0"



# BING PROFESSIONAL ENGINEERING INC.

150 Katimavik Rd, Unit 204, Ottawa, ON K2L 2N2 Phone: (613) 435 - 6665 E-mail: welcome@bingpro.ca

_		
	JOB	EXISTING 3-STOREY DETACHED SINGLE HOUSE
		ALTERATION
		241 HILLCREST RD, OTTAWA, ON K1M 0J4
	DRAW	/ING


3RD FLOOR PLAN

DATE:
2022-10-13

REV
DATE:
No:
SCALE:
AS NOTED
REFER:
PART
PROJ.

A2.3
FILE.DWG



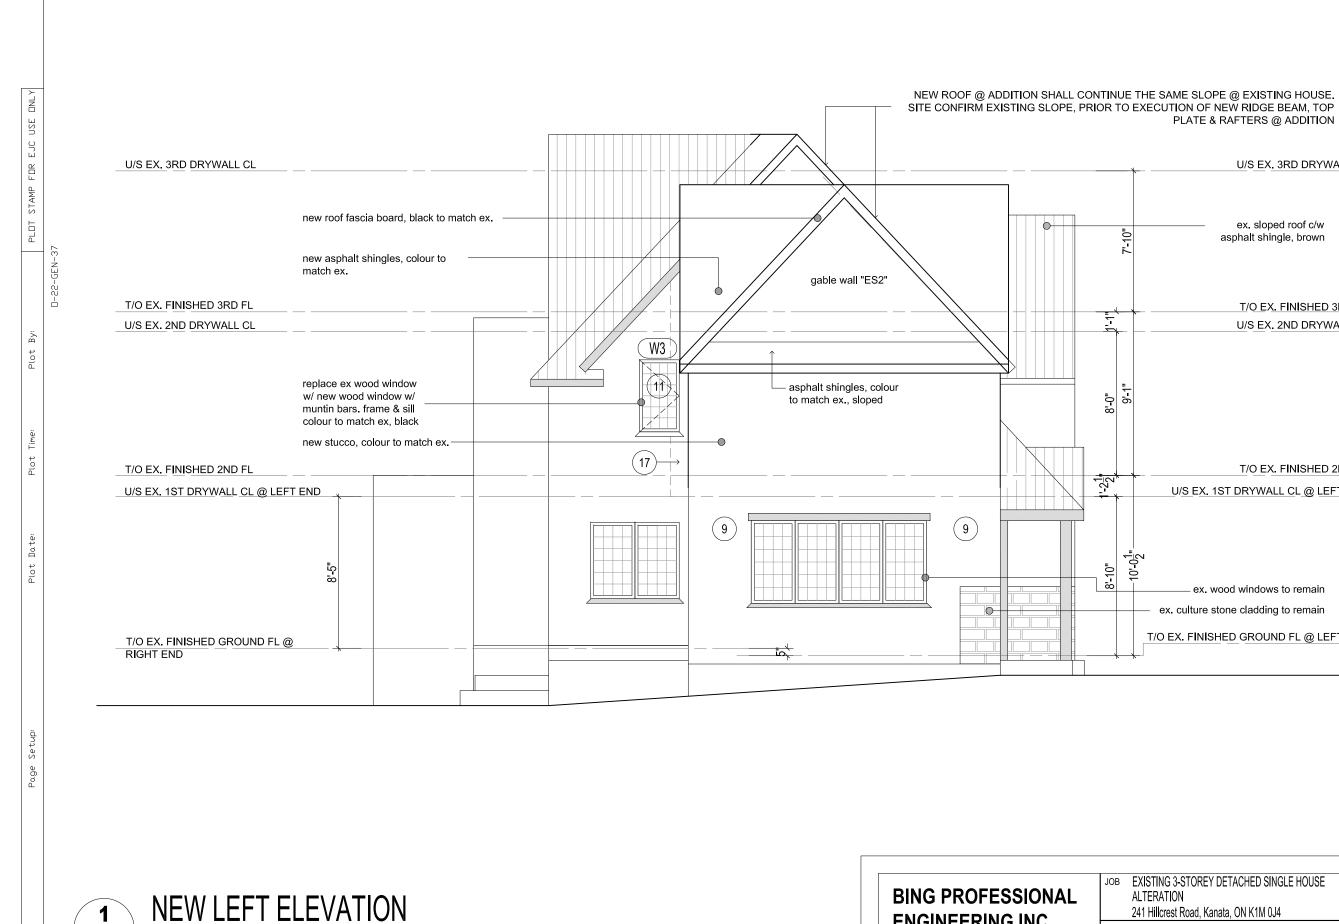

ex. culture stone cladding to remain T/O EX. FINISHED GROUND FL @ LEFT END 11-11-2022

PLATE & RAFTERS @ ADDITION

8' 0" 9' 1'

1-21

U/S EX. 3RD DRYWALL CL

T/O EX. FINISHED 3RD FL

U/S EX. 2ND DRYWALL CL

T/O EX. FINISHED 2ND FL

U/S EX. 1ST DRYWALL CL @ LEFT END

ex. wood windows to remain

ex. sloped roof c/w asphalt shingle, brown




BING PROFESSIONAL
<b>ENGINEERING INC.</b>

150 Katimavik Rd, Unit 204, Ottawa, ON K2L 2N2 Phone: (613) 435 - 6665 E-mail: welcome@bingpro.ca

	EXISTING 3-STOREY DETACHED SINGLE HOUSE	DATE: 2022-08-15	DRAWN: CHS
•		REV	REV.
2	41 Hillcrest Road, Kanata, ON K1M 0J4	DATE:	No:
RAWIN	G	SCALE:	PART
NEW LEFT BUILDING ELEVATION		AS NOTED	OF:
	TEN EEN DOLLDING ELEVATION	REFER:	PROJ. No: <b>O-22-GEN-</b> 37

DRAWING No. FILE.DWG

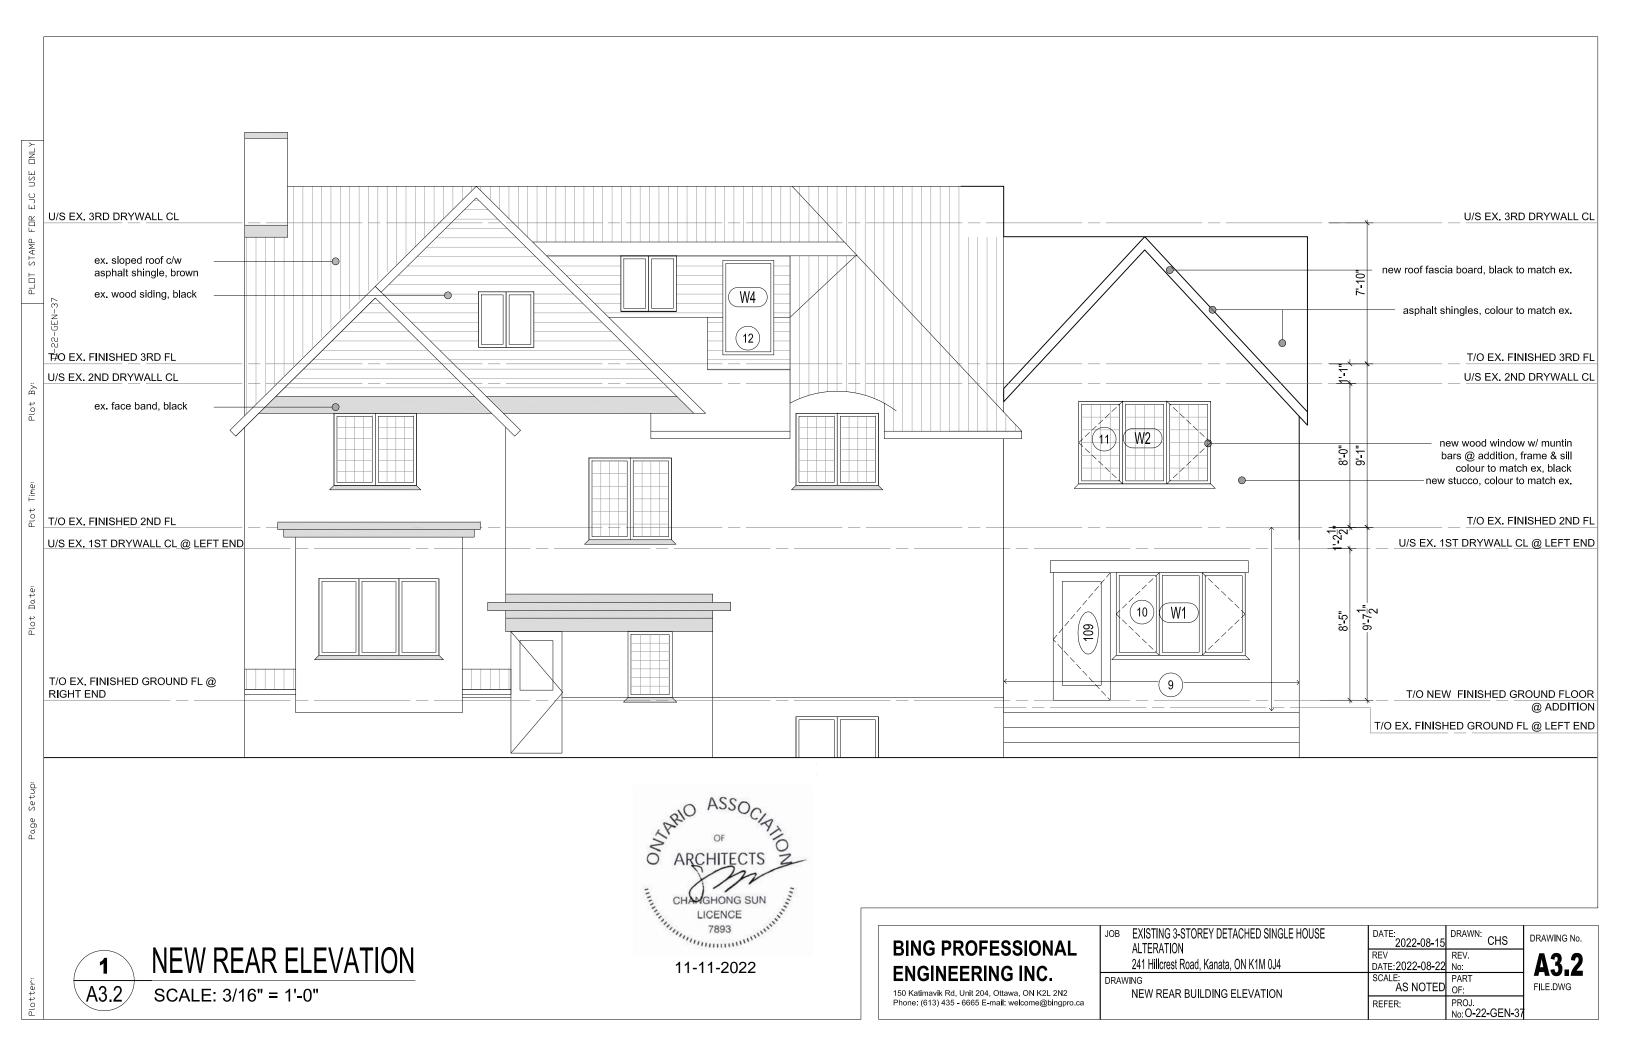

## **SURVEYOR'S REAL PROPERTY REPORT**

## (PART 2)

Re: 241 Hillcrest Road

**Lot 10** 

Registered Plan 4M-55

**City of Ottawa** 

## 1. Registered Rights-of-Way / Easements

There are no easements or rights-of-way registered against the subject lands per our Land Titles search.

## 2. Property Improvements

There is a 2 ½ storey stone & stucco sided dwelling, with a 1 storey addition, municipally known as 241 Hillcrest Road situate wholly within the subject lands.

There is a stucco sided garage to the north of the said dwelling

There is an asphalt driveway in front or east of the said garage.

There is an air conditioning unit to the east of the said dwelling.

There is a covered porch, interlock landings and steps and a 'U' shaped driveway in front or south of the said dwelling.

There are various trees, cedar hedges and fencing along the northerly and westerly property boundaries.

See Part 1 of this Report (Plan) for details.

## 3. Compliance with Municipal Zoning Bylaws

Compliance is not certified by this report.

## 4. Additional Remarks

Survey monuments were found at all four property corners.

The area of the site is 1134.8 sq. m.

This report is a supplement to the accompanying survey plan. Please refer to this plan (Part 1 of the Surveyor's Real Property Report) for disclosure of the location of improvements and boundary information.

OTTAWA, Ontario

Date: February 27, 2023

Our Reference: 23906-23

T. Hartwick

Ontario Land Surveyor

