
Committee of Adjustment Received | Reçu le


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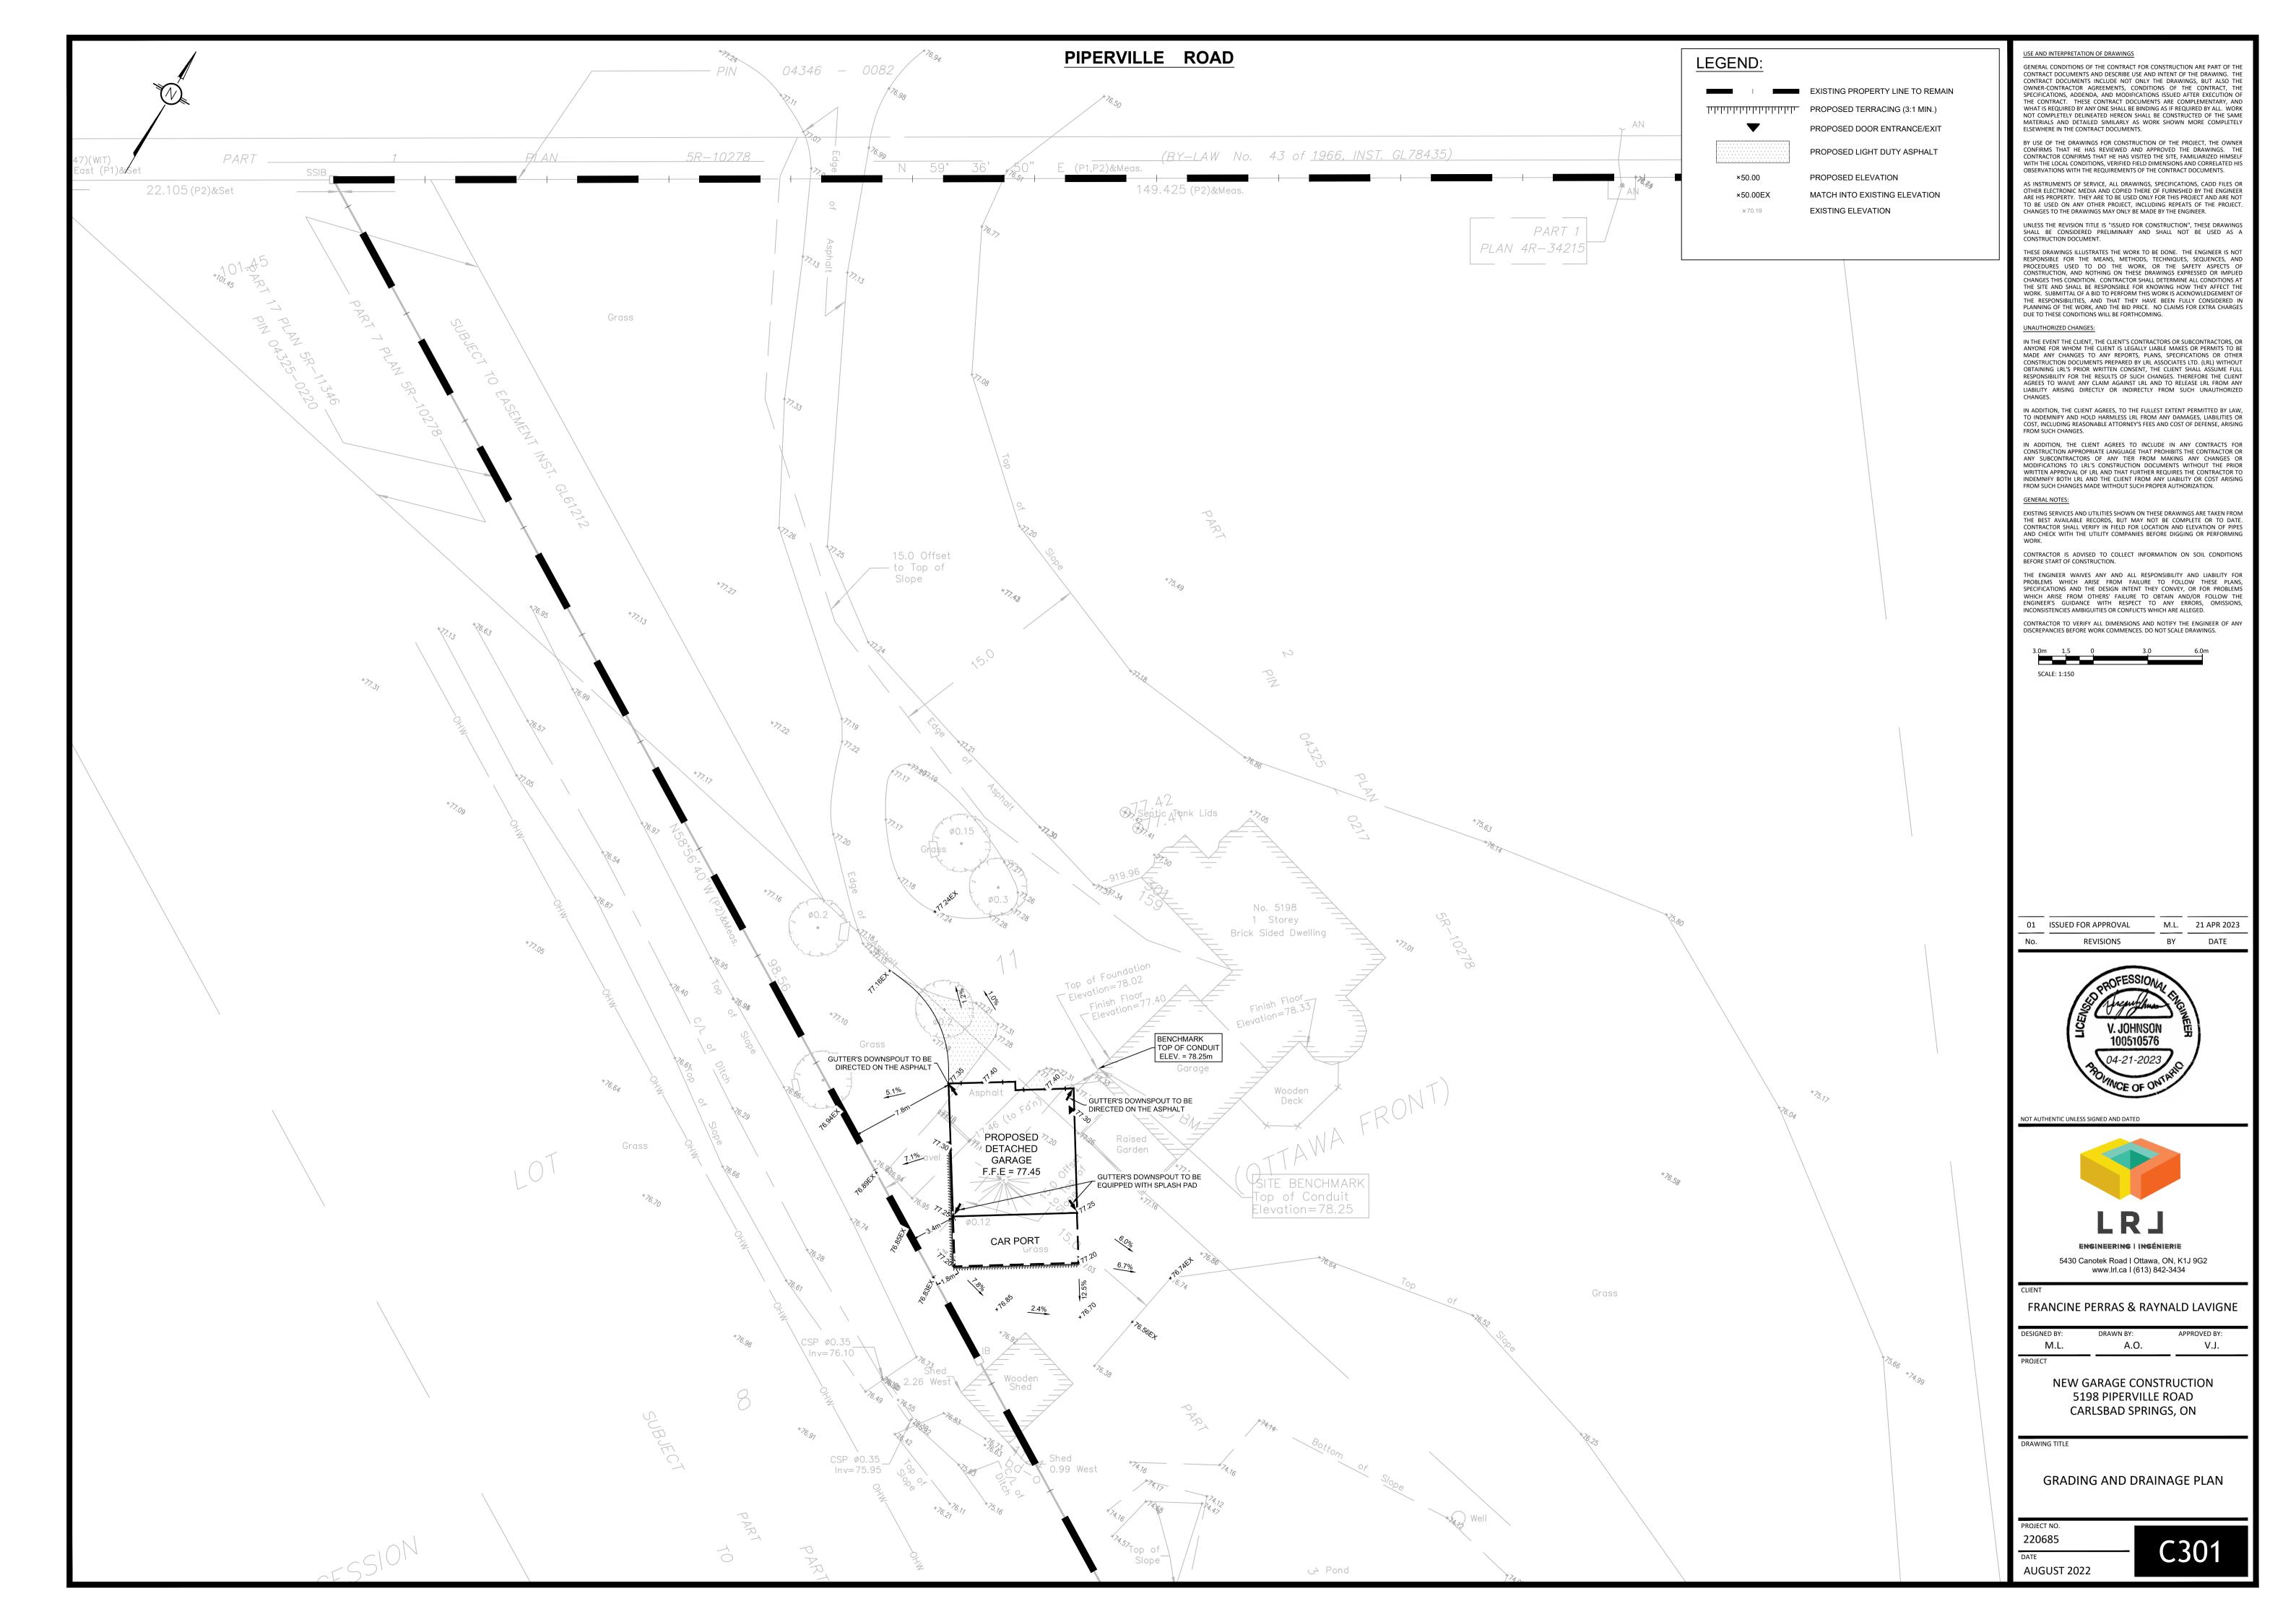
City of Ottawa | Ville d'Ottawa


Comité de dérogation




ROAD ALLOWANCE BETWEEN CONCESSIONS 7 AND 8 (OTTAWA FRONT) - KNOWN AS CHEMIN PIPERVILLE ROAD

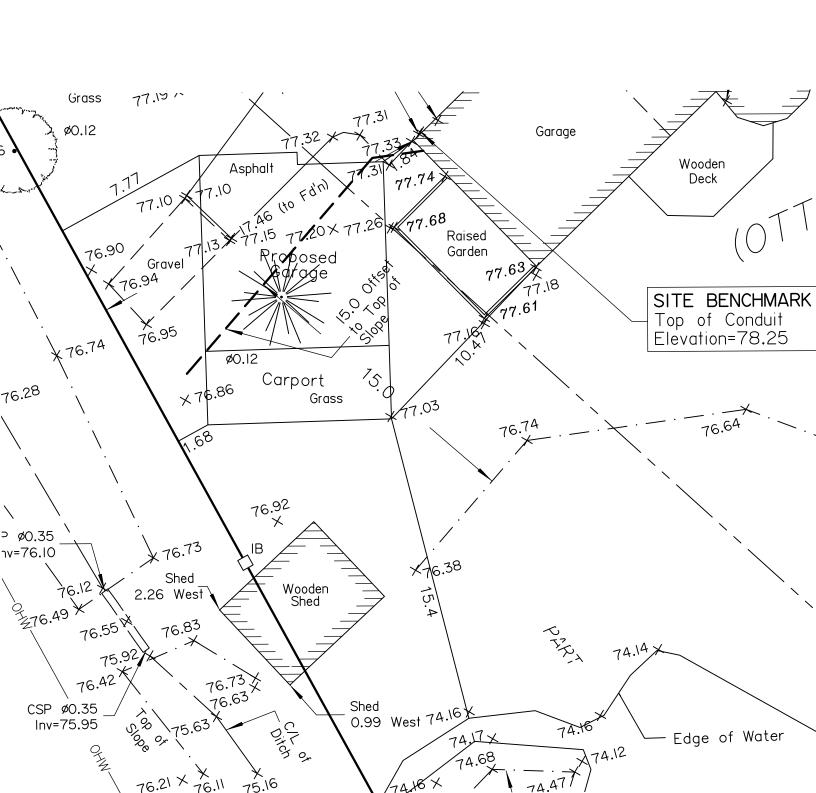

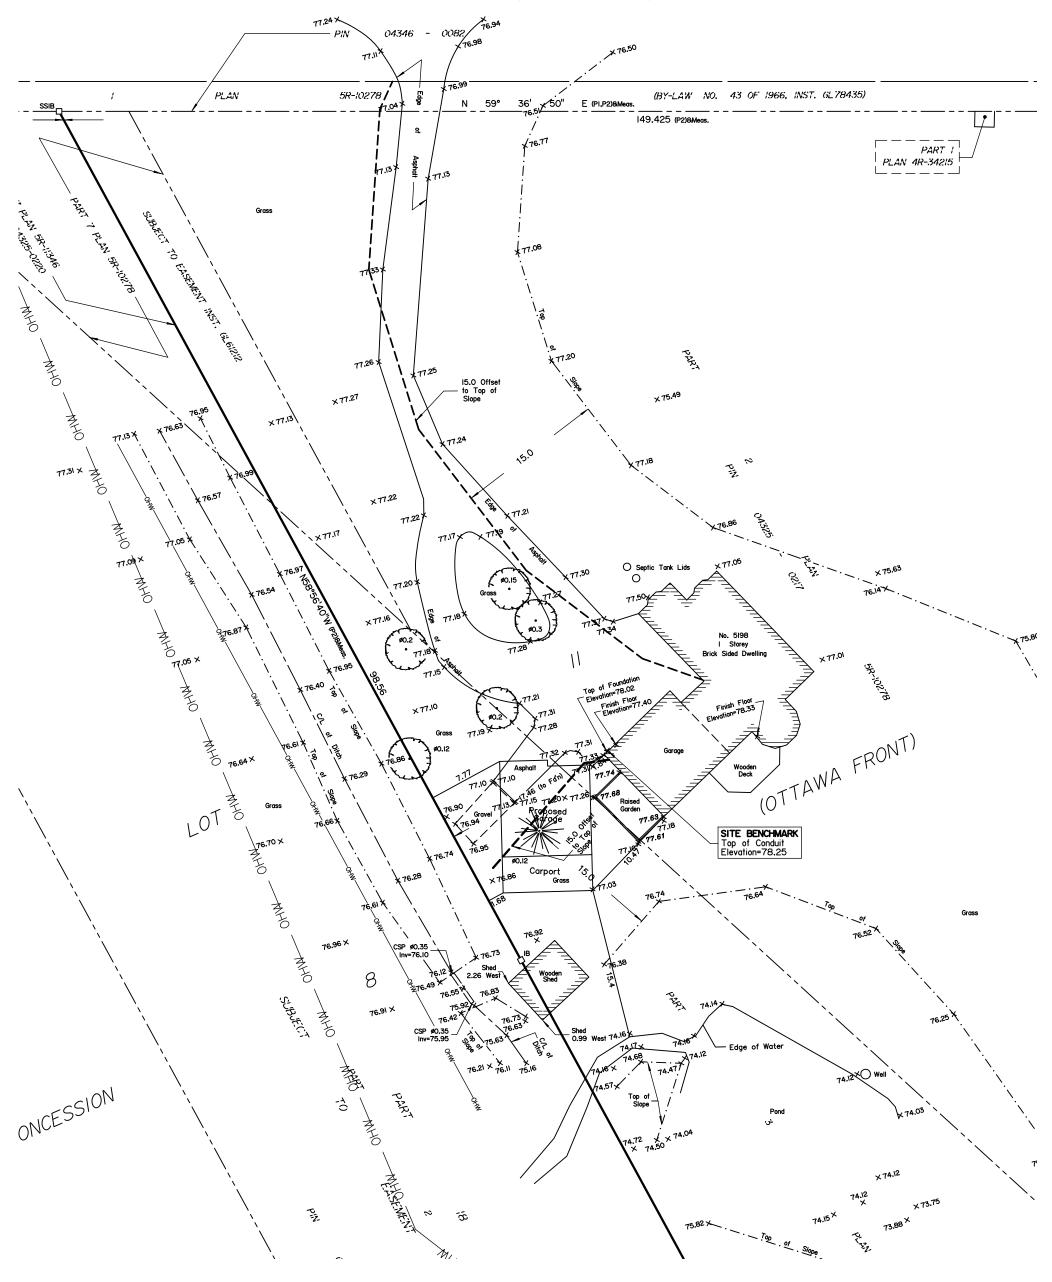

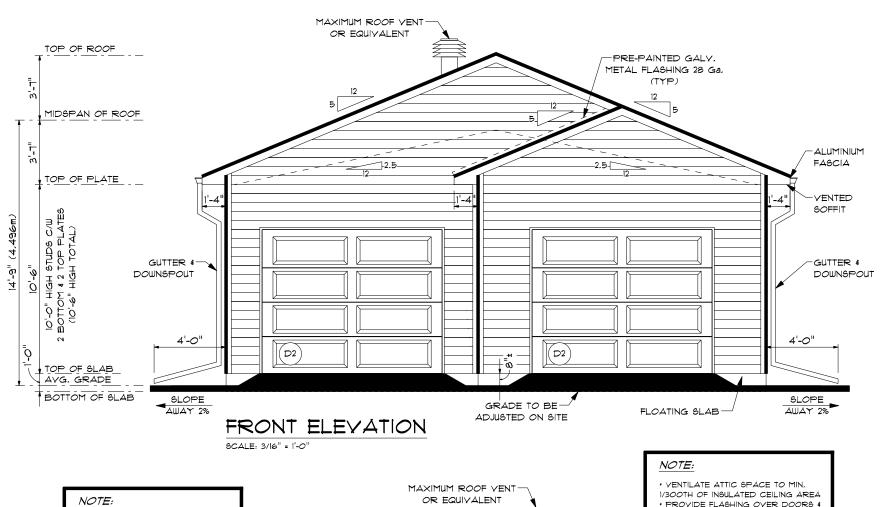

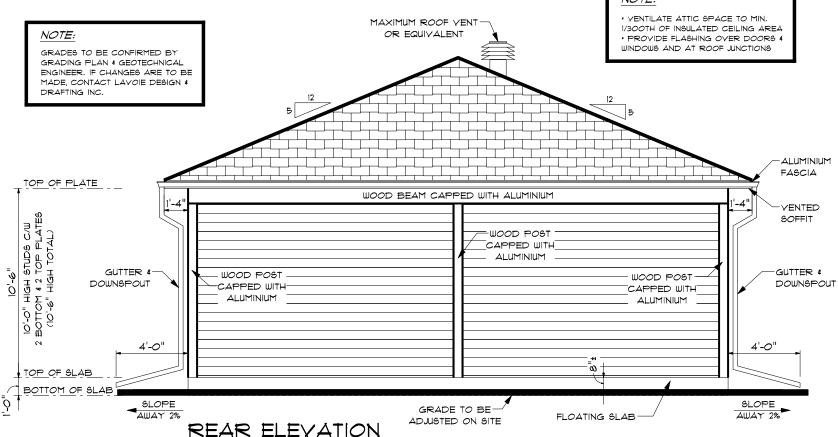

SCALE: 3/16" = 1'-0"

CODES & STANDARDS

* AT THE TIME OF PREPARATION, THIS PLAN WAS DRAWN IN ACCORDANCE WITH THE CURRENT EDITION OF THE ONTARIO BUILDING CODE, IT IS THE RESPONSIBILITY OF THE OWNER/BUILDER TO INSURE THAT CHANGES TO THE CODE ARE COMPLIED WITH AND ALL AMENDEMENTS ARE INCORPORATED IN THE CONSTRUCTION, ALL WORK SHALL CONFORM TO BYLAWS, ORDINANCES AND REGIL ATIONS

- * PRIOR TO PROCEEDING WITH CONSTRUCTION. THE BUILDER MUST VERIFY ALL INFORMATION. DIMENSIONS AND SPECIFICATIONS, WRITTEN DIMENSIONS ALWAYS TAKES PRECEDENCE OVER SCALED MEASUREMENTS.
- \star ALL WORKMANSHIP TO BE OF A STANDARD EQUAL IN ALL RESPECTS TO GOOD PRACTICE. · ANY VARIANCES FROM THE DRAWINGS AND SPECIFICATIONS OR FROM CONDITIONS ENCOUNTERED AT THE JOB SITE SHALL BE RESOLVED BY OWNER/BUILDER, SUCH RESOLUTIONS SHALL BE THEIR SOLE RESPONSABILITY AND MUST BE SUBMITTED TO THE MUNICIPALITY OR CITY FOR APPROVAL PRIOR TO CHANGES BEING MADE.
- · CONSTRUCTION LOADS ON THE STRUCTURE CAUSED BY INTERIM STORAGE OF MATERIALS SHALL NOT BE ALLOWED TO EXCEED THE INTENDED DESIGN LOADS.
- * THE BUILDER TO PROVIDE ALL NECESSARY TEMPORARY SUPPORTS FOR IIIALLS AND FLOORS PRIOR TO THE COMPLETION OF VERTICAL AND LATERAL LOAD SYSTEMS.
- * THE OWNER/BUILDER SHALL BE RESPONSIBLE FOR THE CORRECT PLACEMENT OF THE GARAGE ON THE PROPERTY
- · THE OWNER/BUILDER TO SUPPLY ALL MISSING DIMENSIONS ON SITE PLAN, LOT ELEVATIONS, LEGAL DESCRIPTION, NORTH DIRECTION AND MAIN STREETS.
- . THE OWNER/BUILDER IS RESPONSIBLE FOR CONDITIONS SUCH AS SOIL BEARING CAPACITY, DEPTH OF FROST PENETRATION, WATER TABLE, BURIED STRUCTURES, LOCATION OF SERVICES, ETC.

CARPENTRY

- · FRAMING LUMBER SHALL BE NUMBER TWO (2) OR BETTER UNLESS OTHERWISE SPECIFIED ON PLAN, LINTEL SIZES SHOWN ON THE DRAWINGS ARE BASED ON NUMBER TWO (2) SPRUCE AND ARE TO BE TWO 2X109 UNLESS OTHERWISE INDICATED.
- * OWNER/BUILDER TO OBTAIN SHOP DRAWINGS FROM MANUFACTURER OF ROOF TRUSSES. PLATES ARE TO BE ANCHORED TO CONCRETE WITH 1/2" DIA, ANCHOR BOLTS, MAX, 6'-0" O.C
- * FLUSH FRAMED WOOD MEMBERS SHALL BE ANCHORED WITH JOIST HANGERS UNLESS OTHERWISE SPECIFIED.

ROOFING

* ALL ROOFING SHALL BE APPLIED ACCORDING TO THE MANUFACTURER'S RECOMMENDATIONS AND CONFORM TO THE ONTARIO BUILDING CODE.

SHEET METAL

* ALL REQUIRED FLASHINGS TO BE 28 GAUGE GALVANIZED METAL UNLESS OTHERWISE SPECIFIED.

DOORS & WINDOWS

- * ALL WINDOW AND DOOR SIZES ARE SPECIFIED ON PLANS AND SCHEDULE(S).
- * DOORS AND WINDOWS TO CONFORM WITH 9.7 OF THE O.B.C.

INSULATION/YENTILATION

- · MINIMUM INSULATION REQUIREMENTS; REFER TO THE ENERGY EFFICIENCY DESIGN SUMMARY
- * CEILING INSULATION MAY BE LOOSE FILL OR BATT TYPE.
- * ALL ROOF SPACES SHALL BE VENTILATED WITH SOFFIT & ROOF VENTS, ROOF VENTS ARE TO BE EQUALLY DISTRIBUTED AT THE TOP OF THE ROOF AS SHOWN ON ELEVATION DRAWINGS.
- · ALL VENTILATION OF ROOF SPACES SHALL CONFORM TO THE ONTARIO BUILDING CODE, MIN. 1/300TH OF INSULATED CEILING AREA

MISCELLANEOUS


- · CAULK OVER AND AROUND ALL EXTERIOR OPENINGS USING NON-HARDENING
- CAULKING COMPOUND.
- * FLASH BETWEEN MATERIAL CHANGES ON EXTERIOR WALLS.
- * FLASH OVER ALL EXTERIOR OPENINGS,
- · ALL SIDING TO BE A MINIMUM OF 8" (200 MM) ABOVE FINISHED GRADE.
- · FLOOR FINISHES TO BE SPECIFIED BY OWNER/ BUILDER.

EXTERIOR FINISH LEGEND





COLOR AND MANUFACTURER TO BE CONFIRMED BY CLIENT BEFORE ORDERING

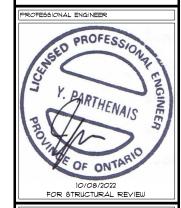

I, LUC LAVOIE, DECLARE THAT I REVIEWED AND TAKE RESPONSIBILITY FOR THE DESIGN WORK ON BEHALF OF A FIRM REGISTERED UNDER SUBSECTION 3,2,4 OF DIVISION C, OF THE BUILDING CODE, I AM RUALIFIED, AND THE FIRM IS REGISTERED, IN THE APPROPRIATE CLASSES / CATEGORIES

INDIVIDUAL B.C.I.N.: 23595 FIRM B.C.I.N.: 112054

10/08/2022

REGISTERED B.C.I.N ARCHITECTURAL DESIGNER

4	ISSUED FOR BLDG PERMIT	10/08/202
3	ISSUED FOR FINAL CHANGES	09/08/202
2	166UED FOR P.ENG REVIEW	02/08/202
1	ISSUED FOR PRELIMINARY	18/05/2022
NO.	REVISIONS	DATE





1041 NOTRE DAME STREET, P.O. BOX 928, EMBRUN, ON, KOA IWO WEBSITE: WWW.LAYOIEDESIGN.CA EMAIL: INFO@LAVOIEDESIGN.CA 613-443-3461

PROJECT NAME

PROPOSED DETACHED GARAGE FOR FRANCINE PERRAS & REYNALD LAVIGNE

PROJECT NO.	2022-003	DRAWINGS NO
DRAWN BY	S.CHEFF B.D-SOLOWY L.LAVOIE	1/
VERIFIED BY	L.LAYOIE	/5

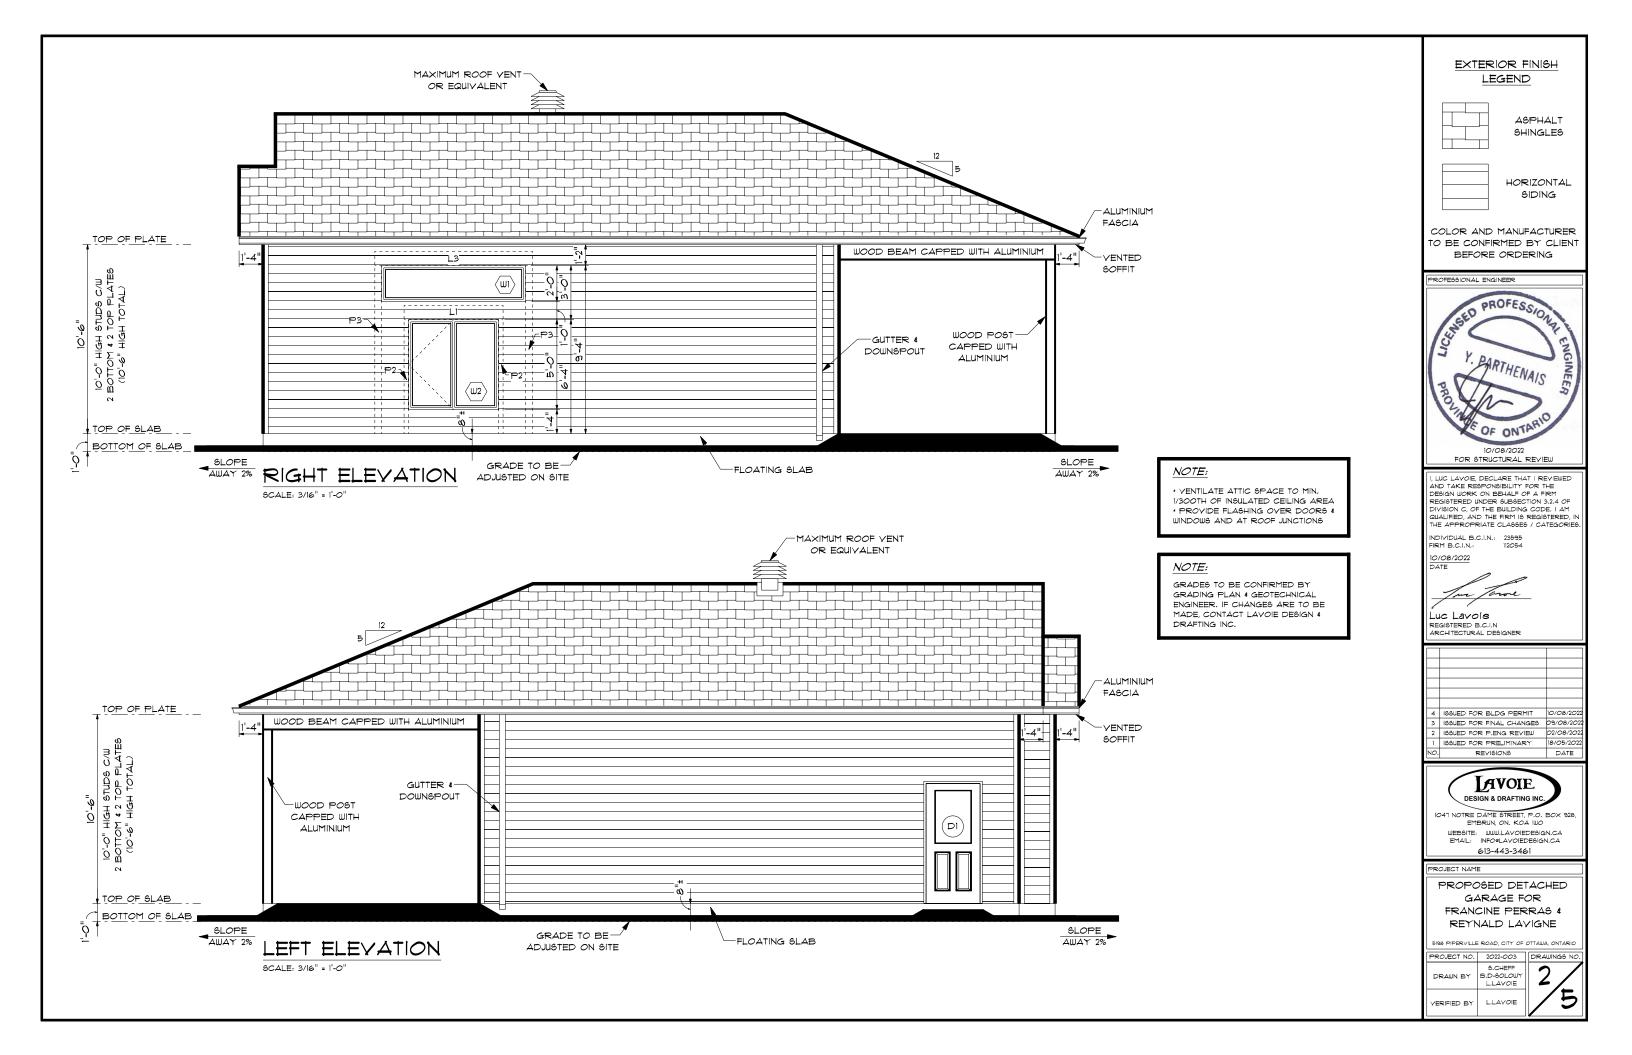

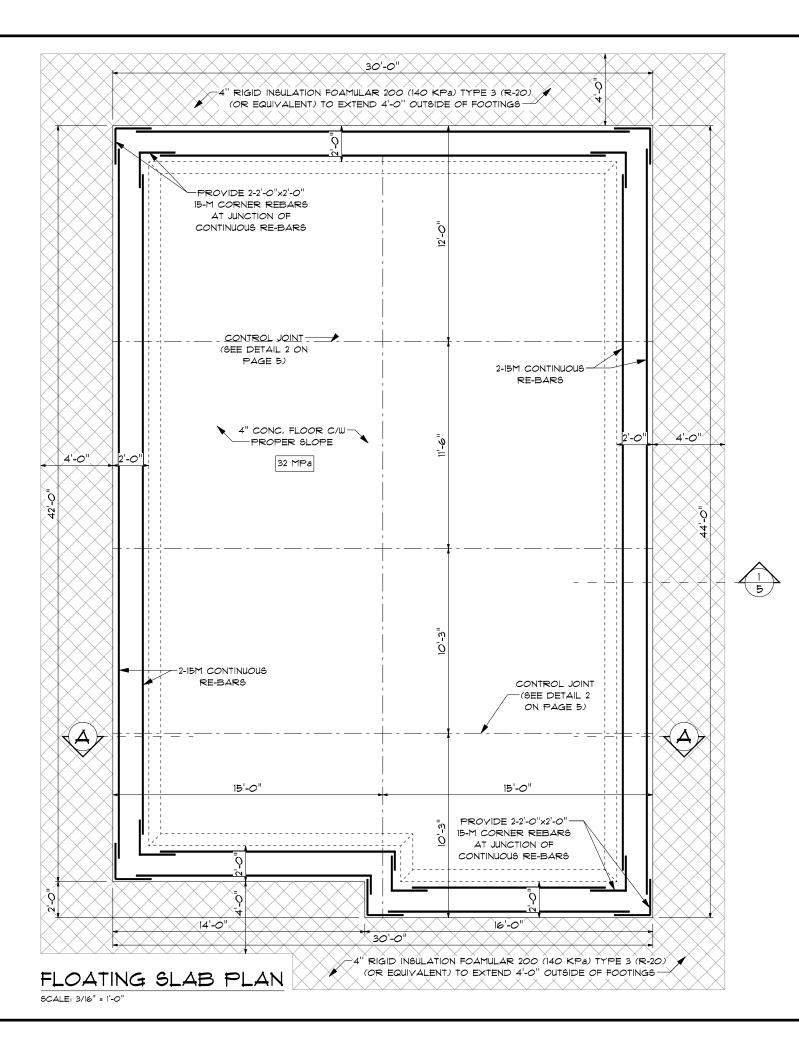

CONCRETE AND FOUNDATIONS

- DO ALL CONCRETE WORK IN STRICT ACCORDANCE WITH CSA A23,1-04 CONCRETE MATERIALS AND METHODS OF CONSTRUCTION
- * CONCRETE FOOTING TO BE 20MPA (2900 PSI) AFTER 28 DAYS, MAX. SLUMP 3". CLASS FI
- CONCRETE WALL TO BE 20MPA (2900 PGI) AFTER 28 DAYS, MAX. SLUMP 3". CLASS FI • SLABS ON GRADE TO BE 32MPA (4640 PSI) AFTER 28 DAYS, 6-8% AIR ENTRAINMENT
- MINIMUM, MAX. 3" SLUMP. CLASS CI • DO NOT ADD WATER TO THE CONCRETE MIX SUPPLIED BY THE READY MIX SUPPLIER
- * OWNER TO SPECIFY DESIRED FINISHES OF ALL EXPOSED CONCRETE SURFACES
- OWNER TO SPECIFY DESIRED FINISHES OF ALL EXPOSED CONCRETE SURFACES
 YIBRATE ALL CONCRETE TO ACHIEVE SATISFACTORY CONSOLIDATION
- REINFORCING STEEL BARS SHALL COMPLY WITH THE REQUIREMENTS OF CAN/CSA-G30.18 WITH FY = 400MPA (60 KSI)
- COLD BEND ALL REINFORCING, DO NOT FLAME CUT OR WELD ANY REINFORCING
- * CONCRETE FOOTINGS MUST BE PLACED ON UNDISTURBED OR COMPACTED SOIL TO AN ELEVATION BELOW FROST PENETRATION.
- FOUNDATION WALLS SHOULD NOT BE BACKFILLED UNTIL CONCRETE HAS REACHED ITS SPECIFIED 28 DAY STRENGHT AND STRUCTURAL FLOOR FRAMING (INCLUDING PLYWOOD SUBFLOOR) REQUIRED TO STABILIZE THE WALLS IS COMPLETE 4 FULLY NAILED AND ANCHORED.
- + FOOTING DIMENSIONS ARE BASED ON AN ASSUMED SOIL BEARING CAPACITY OF 15 KPA (PROVIDE SOIL TEST TO CONFIRM)
- * ALL REBARS TO BE 60KSI (400MPA), CLEAN OF ANY DIRT AND SPACED AS SHOWN ON DRAWINGS, ALL REBARS TO MEET CSA G30.16-M92
- * LAPPING OF REINFORCEMENT STEEL SHALL BE
- 15M AND SMALLER = 18" (500MM) MIN.
- 20M AND BIGGER = 24" (600MM) MIN.
- WIRE MESH LAPS SHALL BE 6" (ISOMM) MIN.
- + PROVIDE CORNER REBARS OF GIOMM \times GIOMM (24" \times 24") SPACED THE SAME AS WALL REINFORCEMENT

ELECTRICAL

- INSTALLATION OF ELECTRICAL ITEMS MUST COMPLY WITH LOCAL ELECTRICAL CODES AND REGULATIONS IN ALL RESPECTS.
- * ELECTRICIAN TO PROVIDE EXTERIOR LIGHTING IN PROXIMITY OF EXTERIOR DOORS,


NOTE:

GRADES TO BE CONFIRMED BY GRADING PLAN & GEOTECHNICAL ENGINEER. IF CHANGES ARE TO BE MADE, CONTACT LAVOIE DESIGN & DRAFTING INC.

MOISTURE BARRIER SHALL BE PROVIDED IN ALL AREAS WHERE WOOD IS IN CONTACT WITH CONCRETE OR UNIT MASONRY LOCATED BELOW GRADE,

CARRY ALL POINT LOADS DOWN TO FOOTINGS/ FOUNDATION

SOIL BEARING CAPACITY ASSUMED TO BE 15KPA FOR SERVICEABILITY LOADS

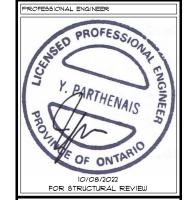

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INDIVIDUAL B.C.I.N.: 23595 FIRM B.C.I.N.: 112054

10/08/2022 DATE

REGISTERED B.C.I.N ARCHITECTURAL DESIGNER

Jun Towne Luc Lavoie

4 ISSUED FOR BLDG PERMIT IO/08/201
3 IGGUED FOR FINAL CHANGES 09/08/201
2 ISSUED FOR P.ENG REVIEW 22/08/201
1 IGGUED FOR PRELIMINARY 18/05/202
NO. REVISIONS DATE



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PROJECT NAME


PROPOSED DETACHED
GARAGE FOR
FRANCINE PERRAS &
REYNALD LAVIGNE

5198 PIPERVILLE ROAD, CITY OF OTTAWA, ONTARI

PROJECT NO. 2022-003 DRAWINGS NO.

9.CHEFF
DRAWN BY B.D-SOLOWY
L.LAVOIE

VERIFIED BY L.LAVOIE

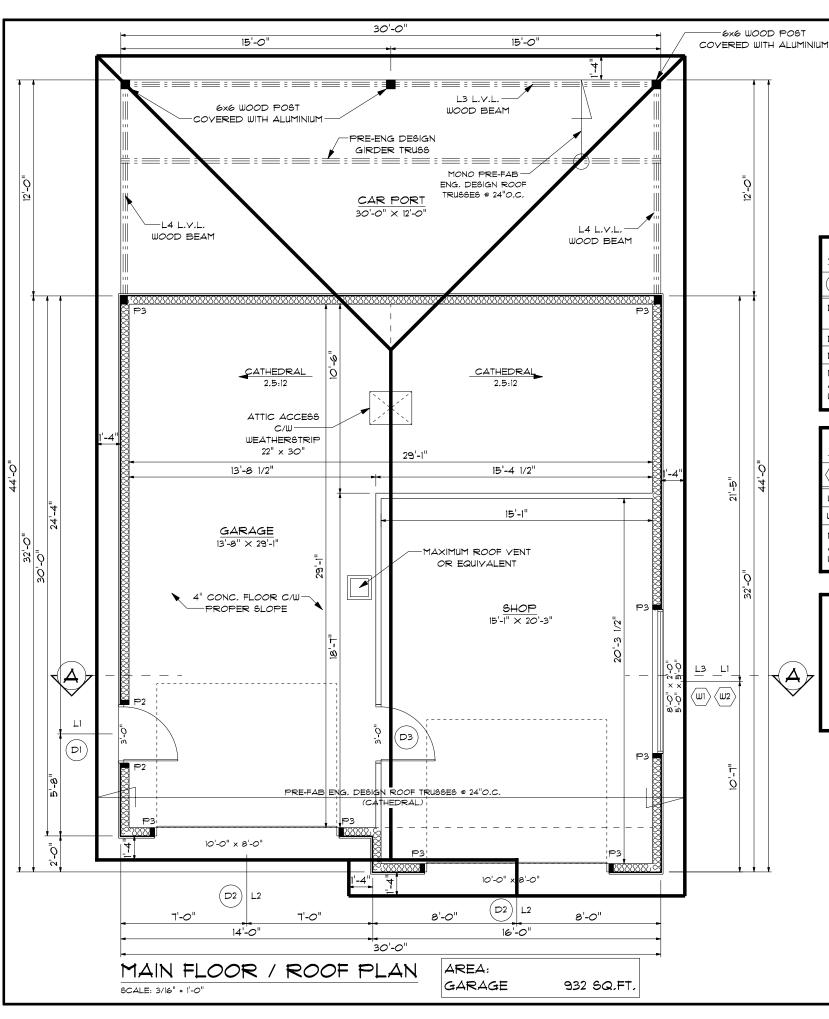

EXTERIOR & INTERIOR DOOR SCHEDULE

	QTY	DOOR DIMENSIONS	COMMENTS
DI	1	36" HALF GLASS METAL DOOR (MAIN DOOR C/W WEATHERSTRIP & DEADBOLT)	MANUFACTURER SPECS BY OTHERS
D2	2	10'-0" × 8'-0" GARAGE DOOR	MANUFACTURER SPECS BY OTHERS
D3	1	3'-0" x 6'-8" "STYLE BY CLIENT"	MANUFACTURER SPECS BY OTHERS

NOTE + IMPORTANT +

ALL WINDOWS & DOORS ARE NOMINAL SIZE, BEFORE FRAMING, CONTRACTOR SHALL VERIFY WITH SUPPLIER OR MANUFACTURER FOR EXACT ROUGH OPENING DIMENSIONS.

WINDOW SCHEDULE

\bigcirc	QTY	WINDOW DIMENSIONS	COMMENTS
W1	1	8'-0" × 2'-0"	CASEMENT SPECS BY OTHERS
W2	1	5'-O" × 5'-O"	CASEMENT SPECS BY OTHERS

NOTE * IMPORTANT *

ALL WINDOWS & DOORS ARE NOMINAL SIZE, BEFORE FRAMING, CONTRACTOR SHALL YERIFY WITH SUPPLIER OR MANUFACTURER FOR EXACT ROUGH OPENING DIMENSIONS.

ROOF LAYOUT NOTES:

ROOF LAYOUT IS A SCHEMATIC LAYOUT TO ASSIST THE TRUSS MANUFACTURER, PROVIDE THE TRUSS MANUFACTURER'S ROOF LAYOUT FOR BUILDING PERMIT APPLICATION AND ON SITE FOR FRAMING, THE DRAFTING SERVICE OFFICE NEEDS TO BE AWARE OF ANY ALTERNATIVES OR CHANGES REGARDING THE ROOF SCHEMATIC LAYOUT BEFORE CONSTRUCTION BEGINS, PROVIDE SUPPORT UNDER GIRDER TRUSSES & SOLID BLOCKING DOWN TO FOUNDATION

REFER TO ROOF LAYOUT Q-221860A FROM ST-LAWRENCE STRUCTURES DATED AUGUST 4 2022

CARRY ALL POINT LOADS DOWN TO FOOTINGS/ FOUNDATION

POST TABLE : P2 = 2-2x4 OR 2-2x6 P3 = 3-2x4 OR

LINTEL TABLE:

3-2×6

L1 = 2- 2XIO WITH P2 ON EACH SIDE (1 STUD + 1 JACK)

L2 = 3- 2×10 WITH P3 ON EACH SIDE (1 STUD + 2 JACK)

L3 = 2- 1 3/4" × 9 1/2" L.Y.L. WOOD BEAM WITH P3 ON EACH SIDE (1 STUD + 2 JACK) L4 = 3- 1 3/4" × 9 1/2" L.Y.L.



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INDIVIDUAL B.C.I.N.: 23595 FIRM B.C.I.N.: 112054 10/08/2022

Jun Jorose

Luc Lavoie REGISTERED B.C.I.N ARCHITECTURAL DESIGNER

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PROJECT NAME

PROPOSED DETACHED


GARAGE FOR

FRANCINE PERRAS &

REYNALD LAVIGNE

5198 PIPERVILLE ROAD, CITY OF OTTAWA, ONTARIO

PROJECT NO.	2022-003	DRAWINGS NO.
DRAWN BY	9.CHEFF B.D-90LOWY L.LAYOIE	4/
YERIFIED BY	L.LAYOIE	/5

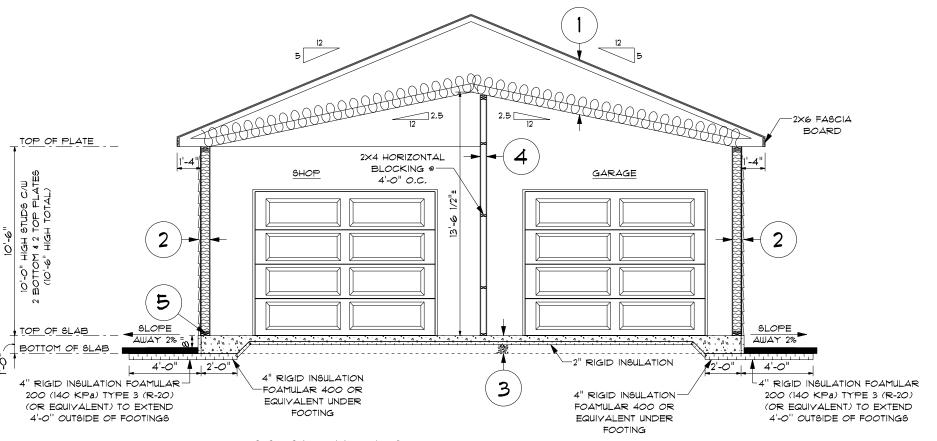

CROSS SECTION A 9CALE: 3/16" = 1'-0"

SPECIFICATIONS:

ROOF (CATHEDRAL)

-ASPHALT SHINGLES
-ICE & WATER SHIELD
(6'-O" AT BOTTOM / 3'-O" AT VALLEYS)
-I5/32" O.S.B. EXT. SHEATHING (ASPENITE) C/W "H" CLIPS
-PRE-FAB. ENG. DESIGN TRUSSES © 24" O.C.
(CATHEDRAL) (SCISSOR TRUSS)
(AS SHOWN ON SECTIONS AND PLANS)
-R 31 BATT OR BLOWN INSULATION (C/W STYROVENT)
-6 MIL VAPOUR BARRIER
-IX4 STRAPPING © 16" O.C.
-I/2" DRYWALL OR ASPENITE (O.S.B.)

12 ROOF (REAR PORCH)

-ASPHALT SHINGLES
-ICE 4 WATER SHIELD
(6'-O" AT BOTTOM / 3'-O" AT VALLEYS)
-I5/32" O.S.B. EXT, SHEATHING (ASPENITE) C/W "H" CLIPS
-PRE-FAB, ENG, DESIGN TRUSSES & 24" O.C.
(AS SHOWN ON SECTIONS AND PLANS)
-IX4 STRAPPING & 16" O.C.
-YENTED SOFFIT

2 EXTERIOR WALL

-SIDING (AS SHOWN)
(INSTALLATION SPECS AS PER MANUFACTURER)
-TYPAR OR TYVEK
-TI/B" EXTERIOR SHEATHING (ASPENITE)
-2x6 STUDS & I6" O.C. C/W TYPAR HEADER WRAP
-R 22 BATT INSULATION
-6 MIL VAPOUR BARRIER
-1/2" DRYWALL OR ASPENITE (O.S.B.)

3) FLOATING SLAB

-SEE DETAIL I ON PAGE 5

SILL PLATE

4

-2x6 SILL PLATE C/W SILL GASKET -1/2" DIA, ANCHORS BOLTS @72" O.C. (MAX)


NOTE:

• YENTILATE ATTIC SPACE TO MIN. 1/300TH OF INSULATED CEILING AREA • PROVIDE FLASHING OVER DOORS (WINDOWS AND AT ROOF JUNCTIONS


NOTE:

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-4" concrete floor complete with 6"x6"x 6/6 welded wire mesh 1/2" DIA. Anchor bolt concrete 4650 P.S.I. 5% to 8% @ 72" o.c.(max) air entrained (RADIANT) Paraina c/w " riaid insulation (R-10) -6 mil vapour barrier wire mesh -6 to 8" of Granular A compacted 95% modified proctor 2x6 P.T. sill plate c/w sill gasket downsbout ∠Finish arade 4" rigid insulation (R-20) FOAMULAR 400 or Equilyalent 4" rigid-CONCRETE SLAB DETAIL insulation (R-20) FOAMULAR 200 or Equilyalent

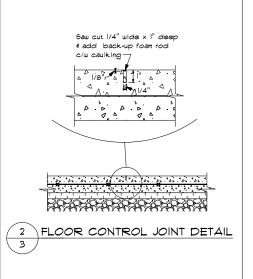

MOISTURE BARRIER SHALL BE PROVIDED IN ALL AREAS WHERE WOOD IS IN CONTACT WITH CONCRETE OR UNIT MASONRY LOCATED BELOW GRADE.

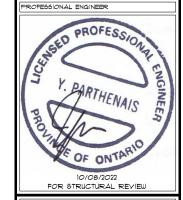

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INDIVIDUAL B.C.I.N.: 23595 FIRM B.C.I.N.: 112054 10/08/2022

Jun Jaroe

Luc Lavoie Registered B.C.I.N Architectural designer

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