

356844, 5024013

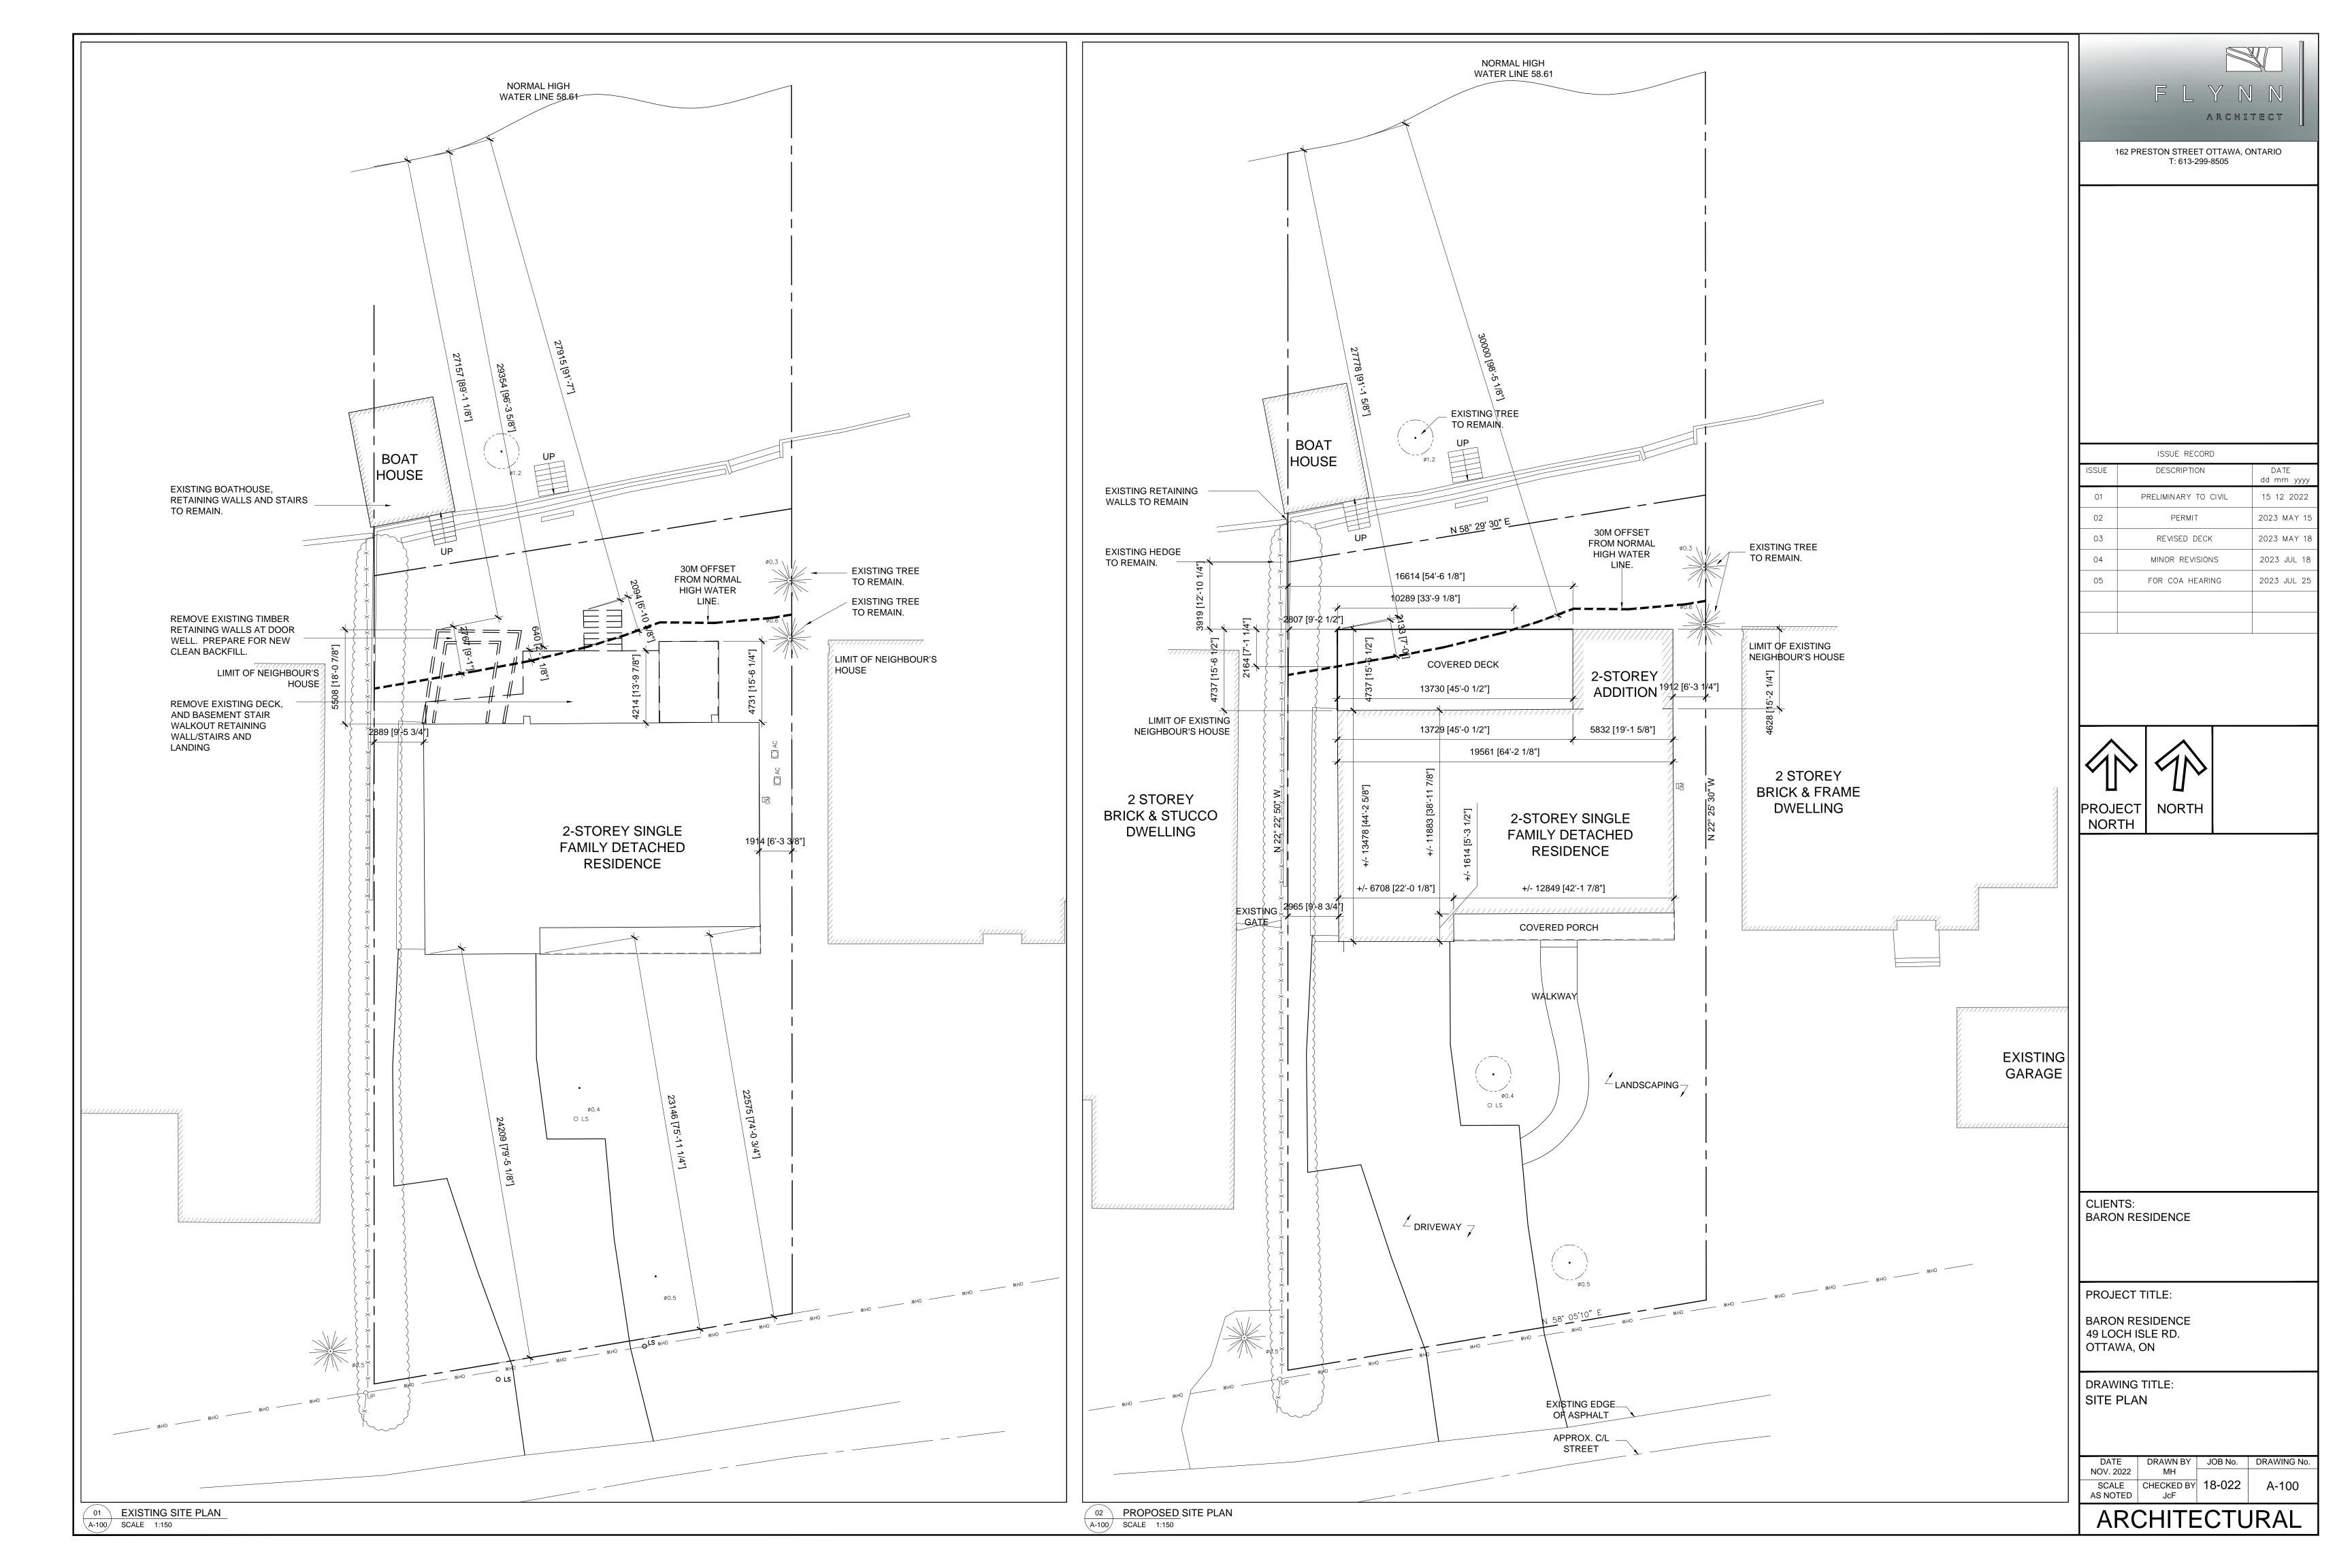

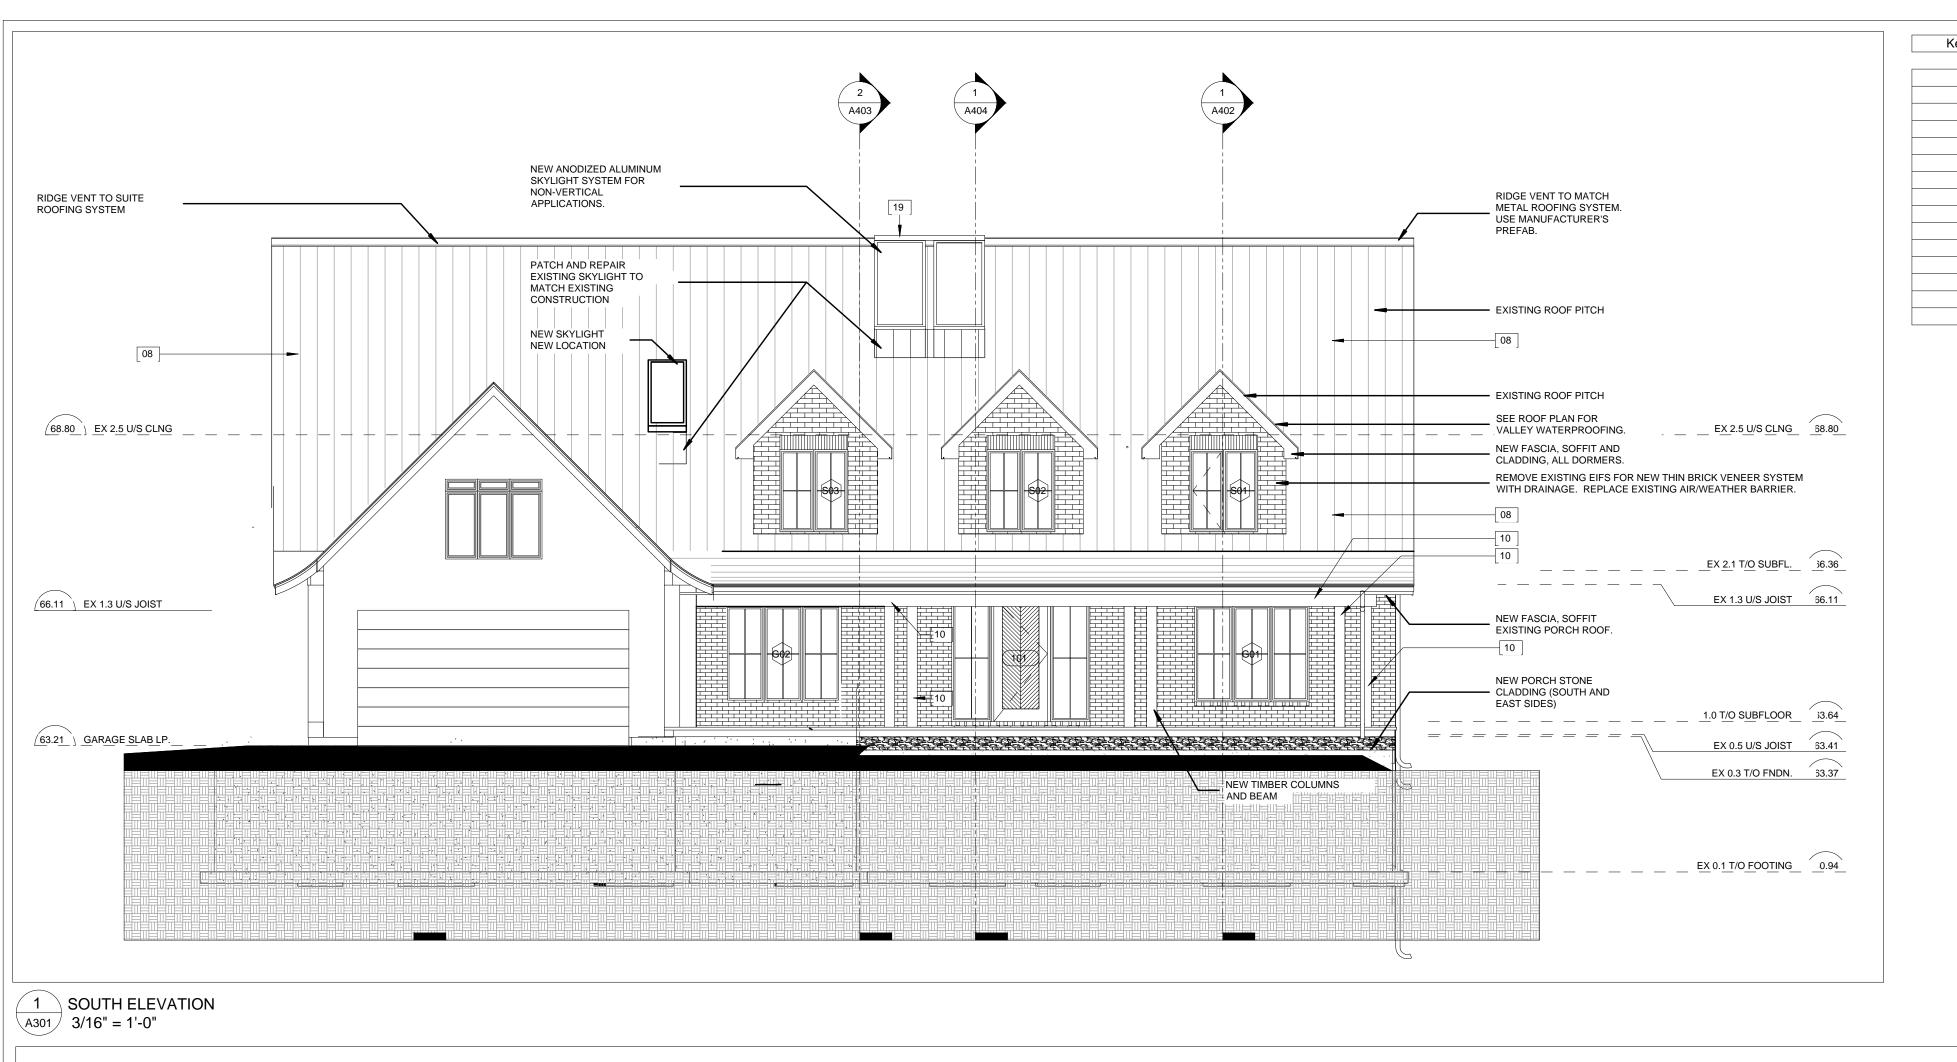

2 EAST ELEVATION

A301 3/16" = 1'-0"

Key Value	Material Description
01	POURED CONCRETE
06	COMPOSITE CLADDING
07	THIN BRICK CLADDING
08	STANDING SEAM METAL ROOFING
10	DOUGLAS FIR
14	T&G HORIZ. WD. CLADDING
15	PREFINISHED EXTRUDED ALUMINUM FASCIA
16	PREFINISHED METAL VENTED SOFFIT - TRUVENT
17	PREFINISHED STEEL GUTTER - LINDAB
18	STRUCTURAL STEEL PAINTED
19	ANNODIZED ALUMINUM - GREY
20	WOOD IPE
21	GLASS LAMINATED
25	COMPOSITE CEDAR SHAKES

162 PRESTON STREET OTTAWA, ONTARIO T: 613-299-8505

GENERAL NOTES:

1. DO NOT SCALE DRAWINGS. FIGURED DIMENSIONS ONLY TO BE USED.

2. IT IS THE RESPONSIBILITY OF THE CONTRACTOR TO CHECK AND VERIFY ALL DIMENSIONS ON SITE AND REPORT ANY DISCREPANCIES TO THE ARCHITECT.

3. ALL WORK DESCRIBED UNDER THIS CONTRACT TO COMPLY WITH ONTARIO BUILDING CODE, 2012 AND ALL OTHER CODES AND BY-LAWS IN EFFECT.

GENERAL NOTES:

PURPOSE MADE ANODIZED ALUMINUM SKYLIGHT SYSTEM FOR NON-VERTICAL APPLICATION. 2.6 U/S CLNG 70.01 68.80) EX 2.5 U/S CLNG _______ GUTTER AND DOWNSPOUT. C/W CLEAN-OUT ACCESSORY AT BOTTOM. TYPICAL 2.3 T/O SUBFL. 67.12 66.36 EX 2.1 T/O SUBFL. _ VERIFY UPPER STOREY WALL 66.11 <u>EX 1.3 U/S JOIST</u> FRAMING LOCATION RELATIVE TO 66.08 EX 1.2 U/S CLNG. DOWNSPOUT IF NOT — FLASHING LEDGE AT GROUND FLOOR AT TIME OF DEMOLITION. FLUSH FINISH WITH ADDITION IS 10 REQURIED. 63.37 EX 0.3 T/O FNDN. 63.21 GARAGE SLAB LP EX 0.5 U/S JOIST 33.41 CLADDING TO SUIT EXISTING GRADE 61.01 EX 0.2 T/O SLAB EX 0.2 T/O SLAB 61.01 EX 0.1 T/O FOOTING 0.94

3 PERMIT APPLICATION 2023 APR 14 2 PRELIM TO STRUCTURAL 2023 FEB 21 TO CONSULTANTS 2022 DEC 13 Revision Description Revision Date

Revision Schedule

NO ASSOC O ARCHITECTS JASON C. FLYNN LICENCE 6131

PROJECT NORTH CLIENT: BARON RESIDENCE

CONSULTANTS: IAN MALCOLM STRUCTURAL ENGINEER

HVAC DESIGN EXPERTS MECHANICAL AND VENTILATION

T.L. MAK ENGINEERING CONSULTANTS CIVIL ENGINEER

PROJECT TITLE: BARON RESIDENCE

LOCHE ISLE RD.

DRAWING TITLE: ELEVATIONS

NOV. 2022 SCALE: CHECKED BY: 21-008 A301 3/16" = 1'-0" JCF

ARCHITECTURAL

