



Area and Lot Width Certificate

Part of Lot 58, Lot 59 and Part of Lot 60
Registered Plan 334
PIN 04242-0165(LT)
674/676 rue de L'Eglise Street, City of Ottawa
Being
Parts 1, 2, 3, and 4
as Shown on Draft Reference Plan dated September 14, 2023

I <u>Shawn Leroux</u>, Ontario Land Surveyor, hereby certify the following Areas and Lot Widths:

674 rue de L'Eglise Street

Part	Plan	Area (sq. m.)	Lot Width (m) At 4.5 m setback
Parts 1 and 2	Draft	292.9	9.61

676 rue de L'Eglise Street

Part	Plan	Area (sq. m.)	Lot Width (m) At 4.5 m setback
Parts 3 and 4	Draft	293.7	9.61


<u>September 14, 2023</u>

Date

Shawn Leroux

Ontario Land Surveyor

RE: 22-10-043-00

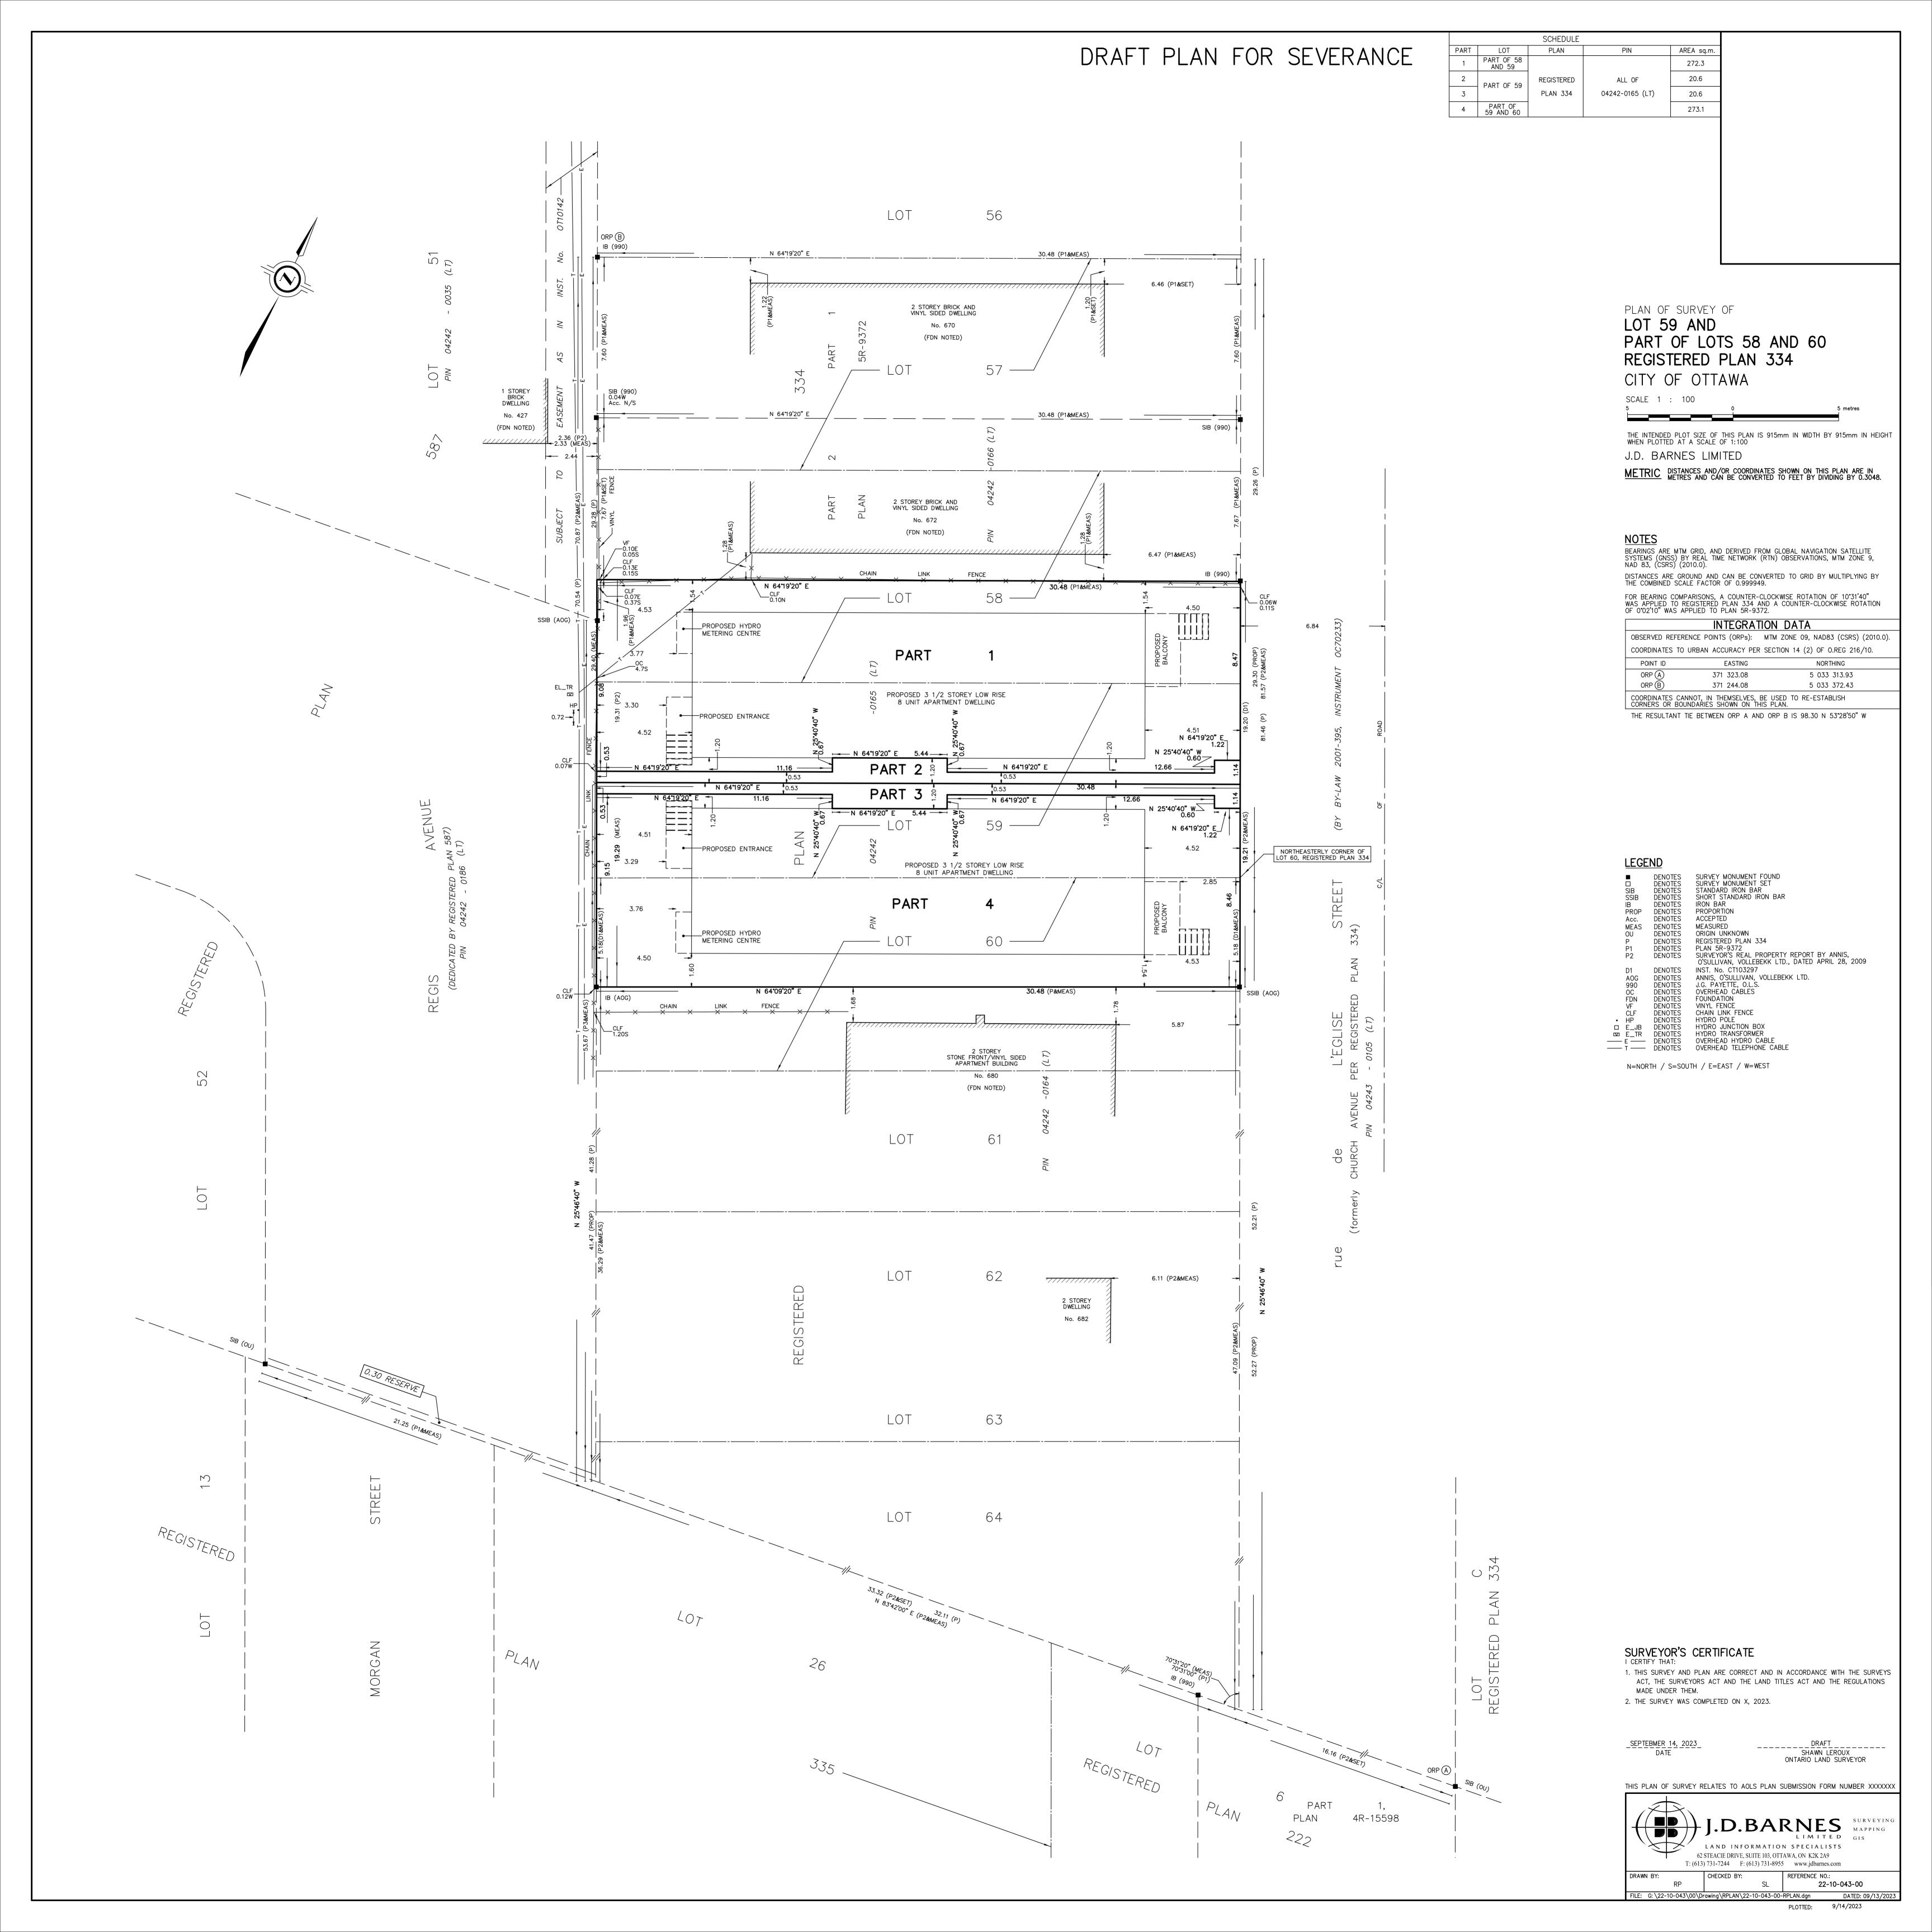

ON, K1K 3K2

VARIA: DRAFTING & DESIGN

GENERAL NOTES:

DO NOT SCALE THESE DRAWINGS.

DRAWINGS NOT TO BE USED FOR CONSTRUCTION UNTIL APPROVED BY IN WRITING FROM THE APPOINTED DESIGNER.

CONTRACTOR(S) TO VERIFY ALL DIMENSIONS AND SITE CONDITIONS PRIOR TO THE COMMENCEMENT OF ANY TO BE FORWARDED IN WRITING WITHIN TWO (2) BUSINESS CONTINGENT UPON MUTUAL AGREEMENT BETWEEN APPOINTED DESIGNER AND CONTRACTOR.

CONTRACTOR(S) RESPONSIBLE FOR THE CORRECT APPLICATION OF SPECIFIED MATERIALS AND SYSTEMS (ONLY TO BE SUPERCEDED BY THESE DRAWINGS, IF APPLICABLE).

THE APPOINTED DESIGNER DOES NOT ASSUME ANY RESPONSIBILITY AND / OR LIABILITY IF THE ABOVE CONDITIONS ARE NOT MET.

NO.	DESCRIPTION	DATE
1	2ND LAYOUTS FOR CLIENT	JUN/28/2023
2	ELEVATIONS FOR CoA SUBMITTAL	SEP/08/2023

NORTH ARROW:

PROJECT TITLE: (2) x 8-UNIT APARTMENT DWELLINGS, 674 & 676 rue de l'ÉGLISE, OTTAWA,

AXO VIEWS - ENTRY DETAILS

DRAWN BY: CORY DUBEAU

REVIEWED BY:

Ax001



L'EGLISE APPROACH: NOTE THE ARTICULATED BALCONIES, BRICKWORK AND ADDRESS SIGNAGE








L'EGLISE: ENTRY DETAIL SHOWCASING THE ARTICULATION OF THE INTERIOR SIDEYARD ALONG THE SHARED PEDESTRIAN RAMP.


REGIS AVENUE APPROACH: NOTE THE ELEVATED HYDRO ENCLOSURE & JULIETTE BALCONIES

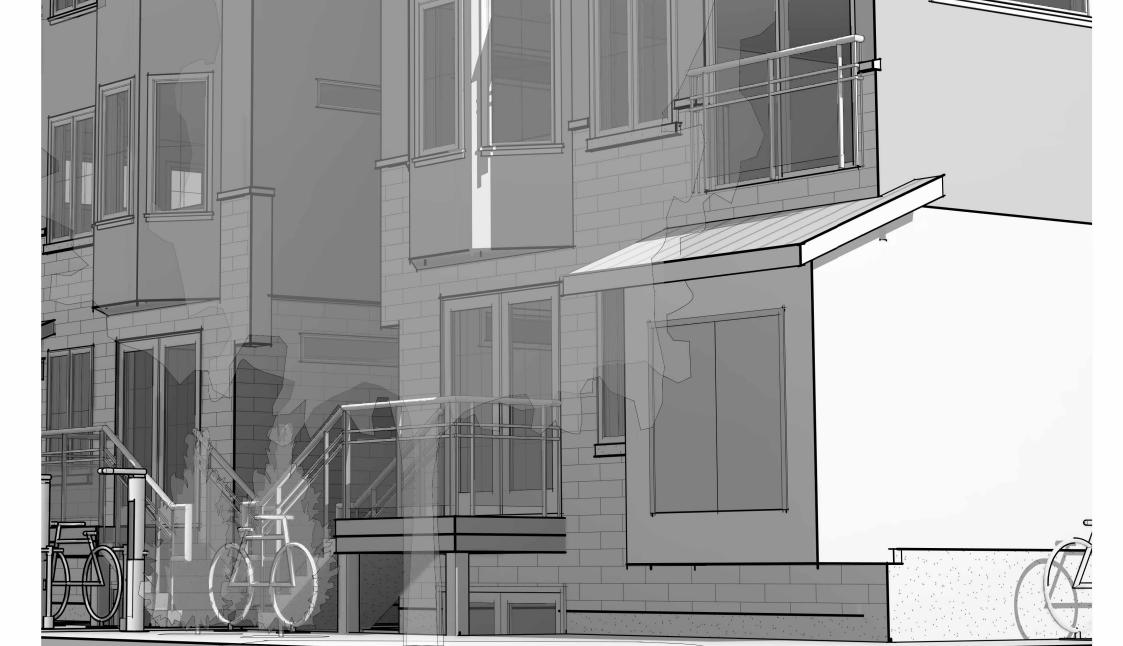

REGIS, AS SEEN FROM A WORM'S EYE VIEW SHOWCASING SOME BICYCLE PARKING & A MIOBILE REPAIR STATION FOR OCCUPANT CONVENIENCE.





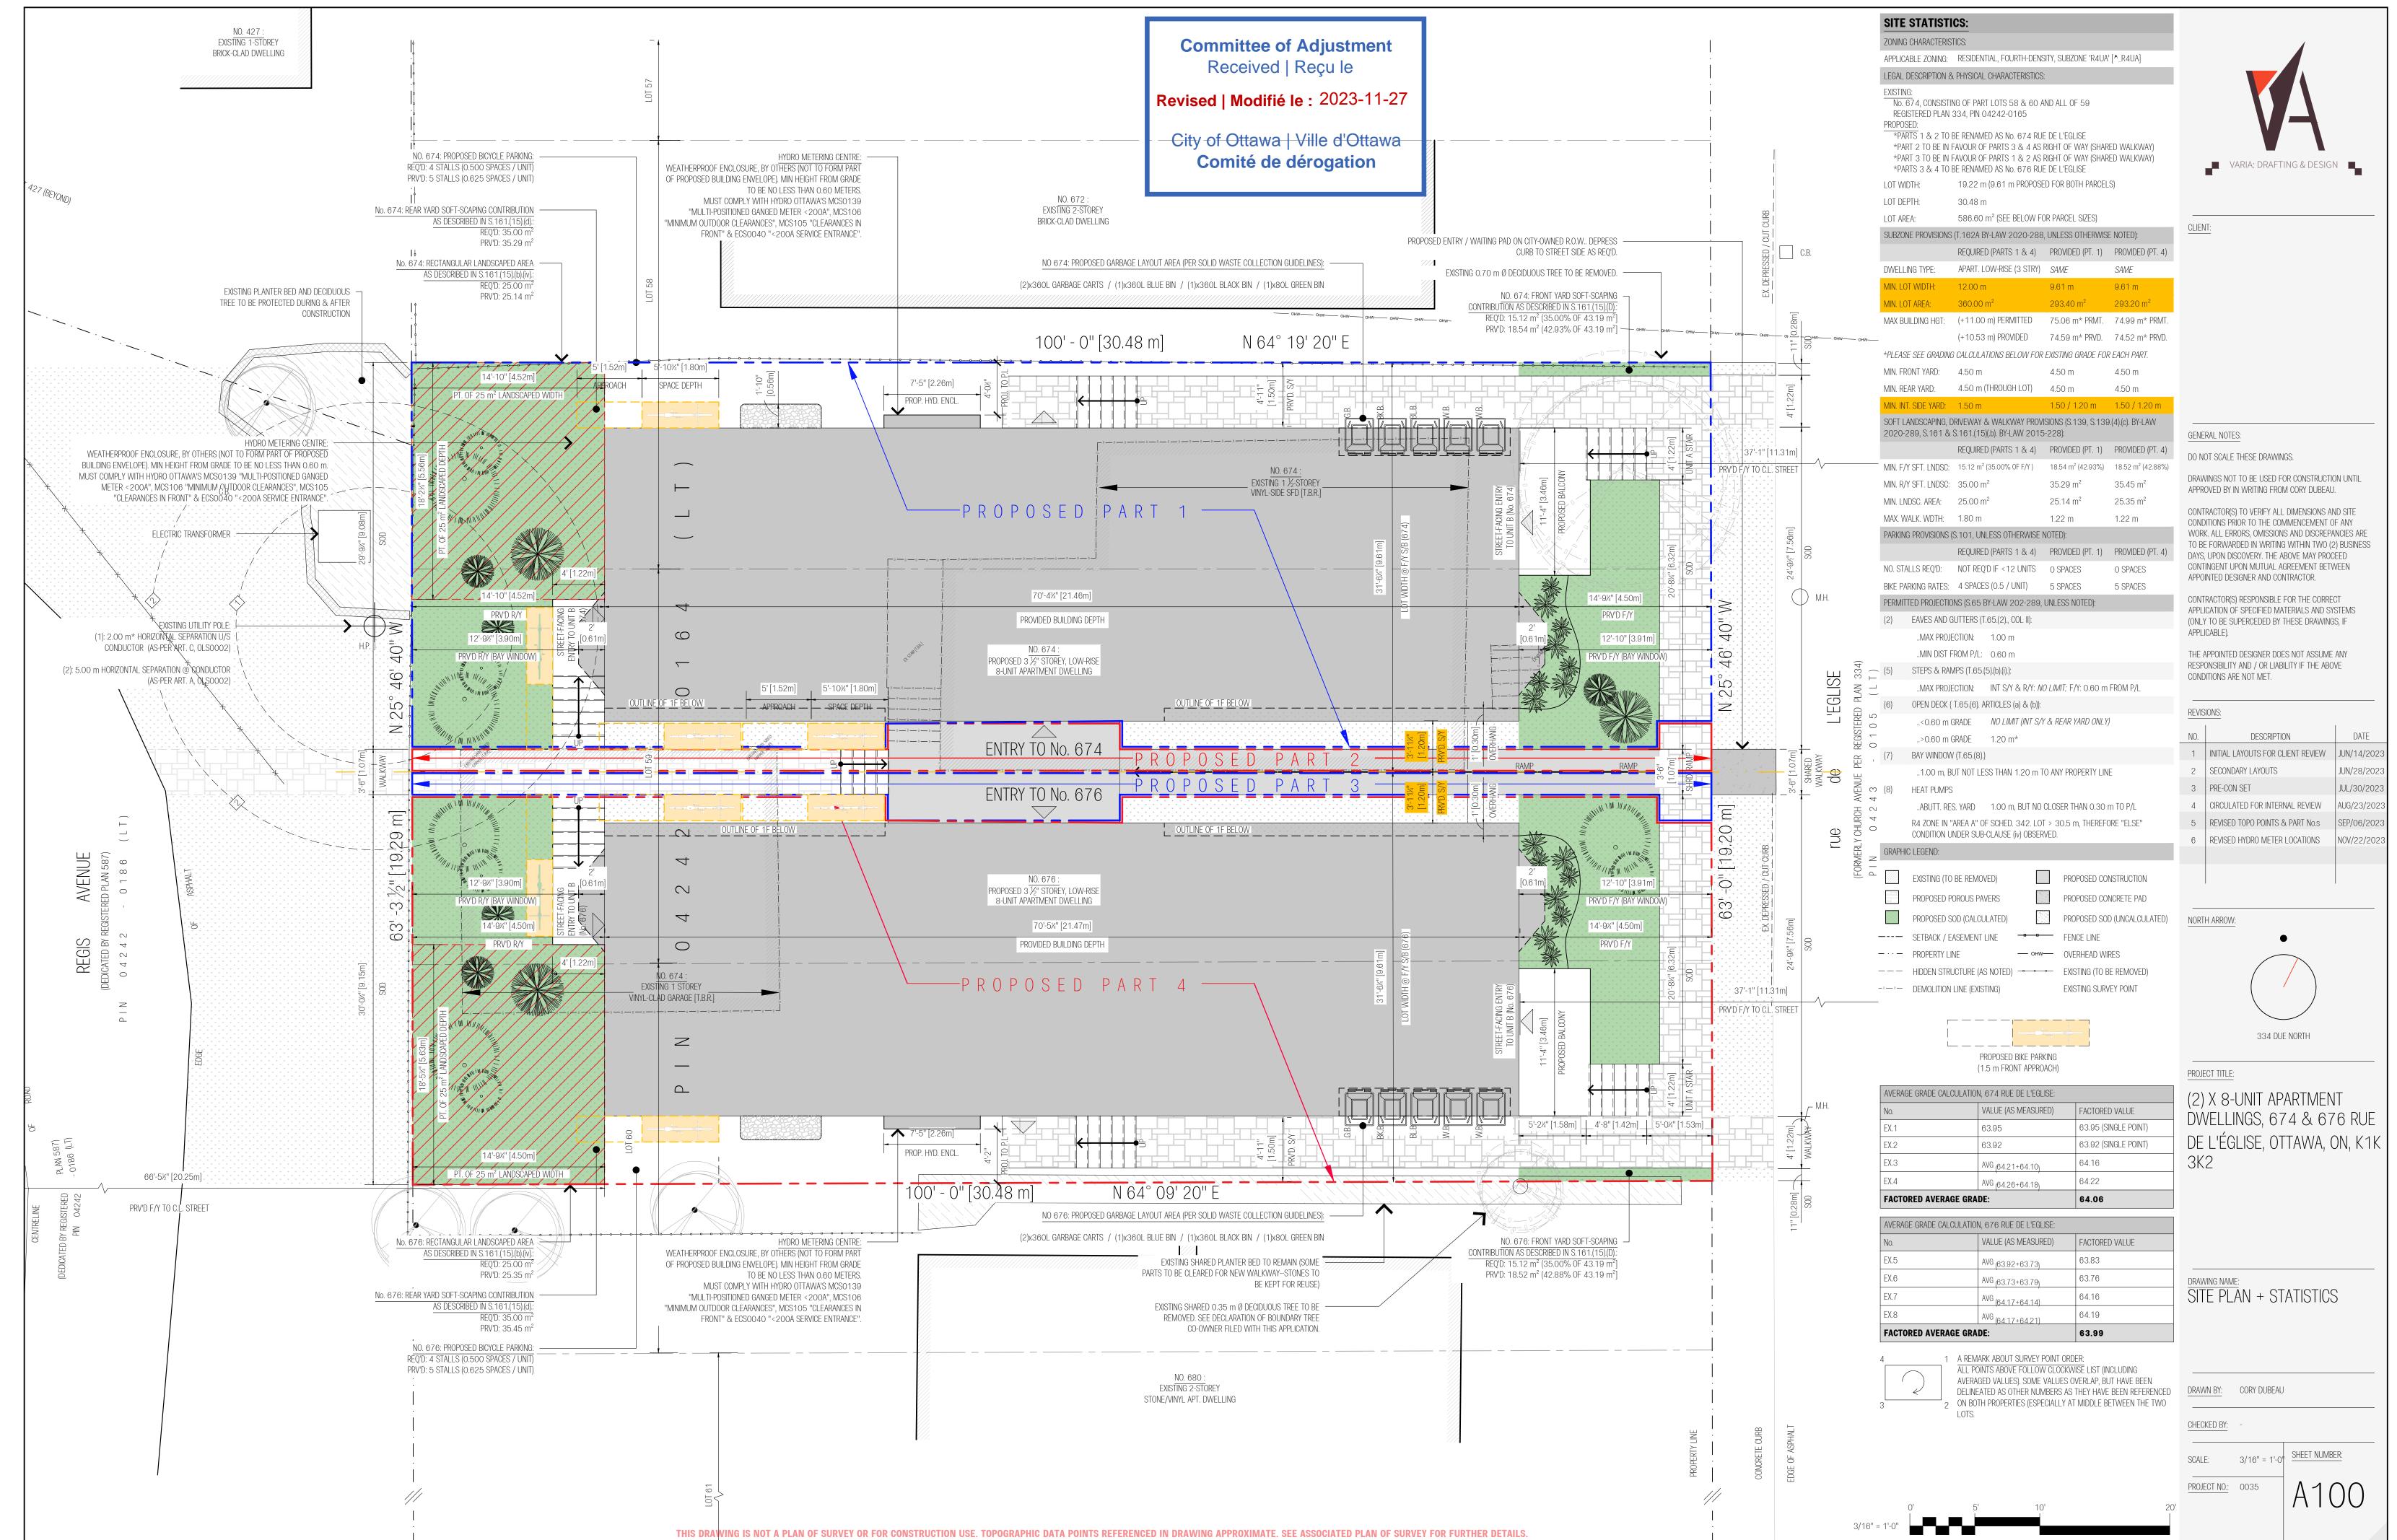


Committee of Adjustment Received | Reçu le

Revised | Modifié le : 2023-11-27

City of Ottawa | Ville d'Ottawa

Comité de dérogation

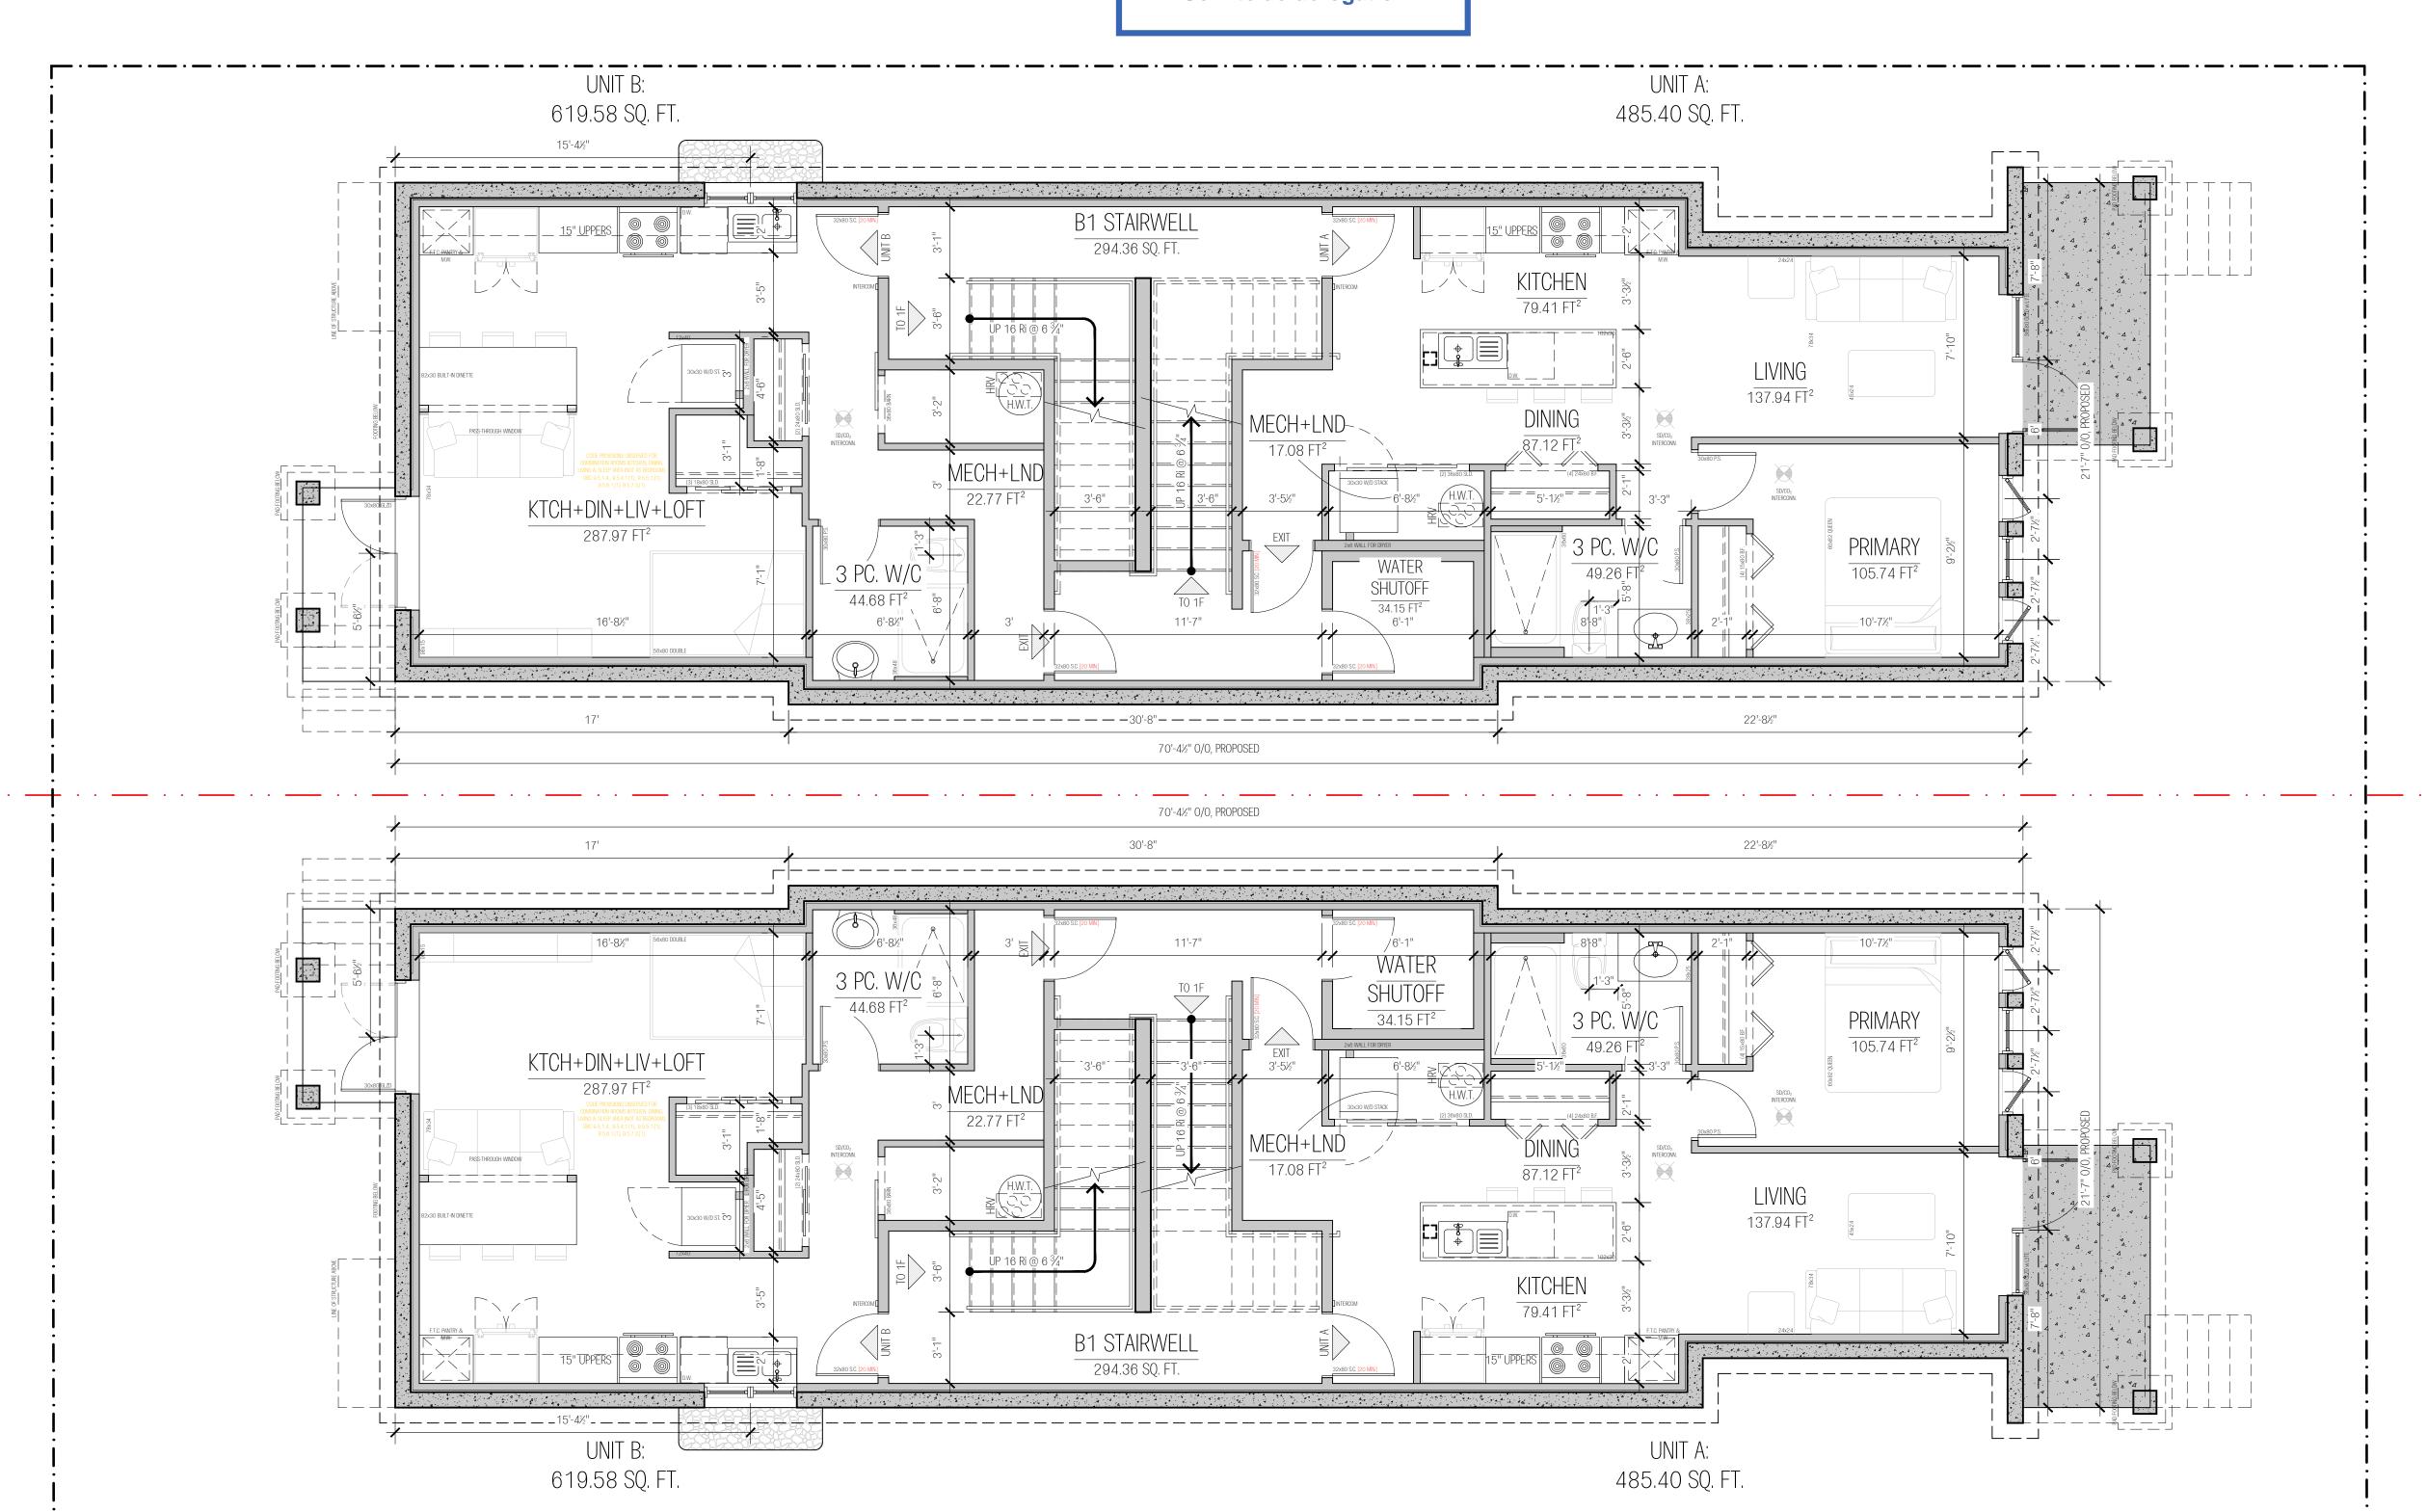



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REVISIONS:

NO.	DESCRIPTION	DATE
1	INITIAL LAYOUTS FOR CLIENT REVIEW	JUN/14/20
2	2ND LAYOUTS	JUN/28/20
3	PRE-CoA SET	AUG/23/20

NORTH ARROW:



PROJECT TITLE:

(2) X 8-UNIT APARTMENT DWELLINGS, 674 & 676 RUE DE L'ÉGLISE, OTTAWA, ON, K1K 3K2


FOUNDATION PLAN:
(674 & 676 RUE DE L'EGLISE)

DRAWN BY: CORY DUBEAU

CHECKED E

SCALE: 1/4" = 1'-PROJECT NO.: 0035

A10

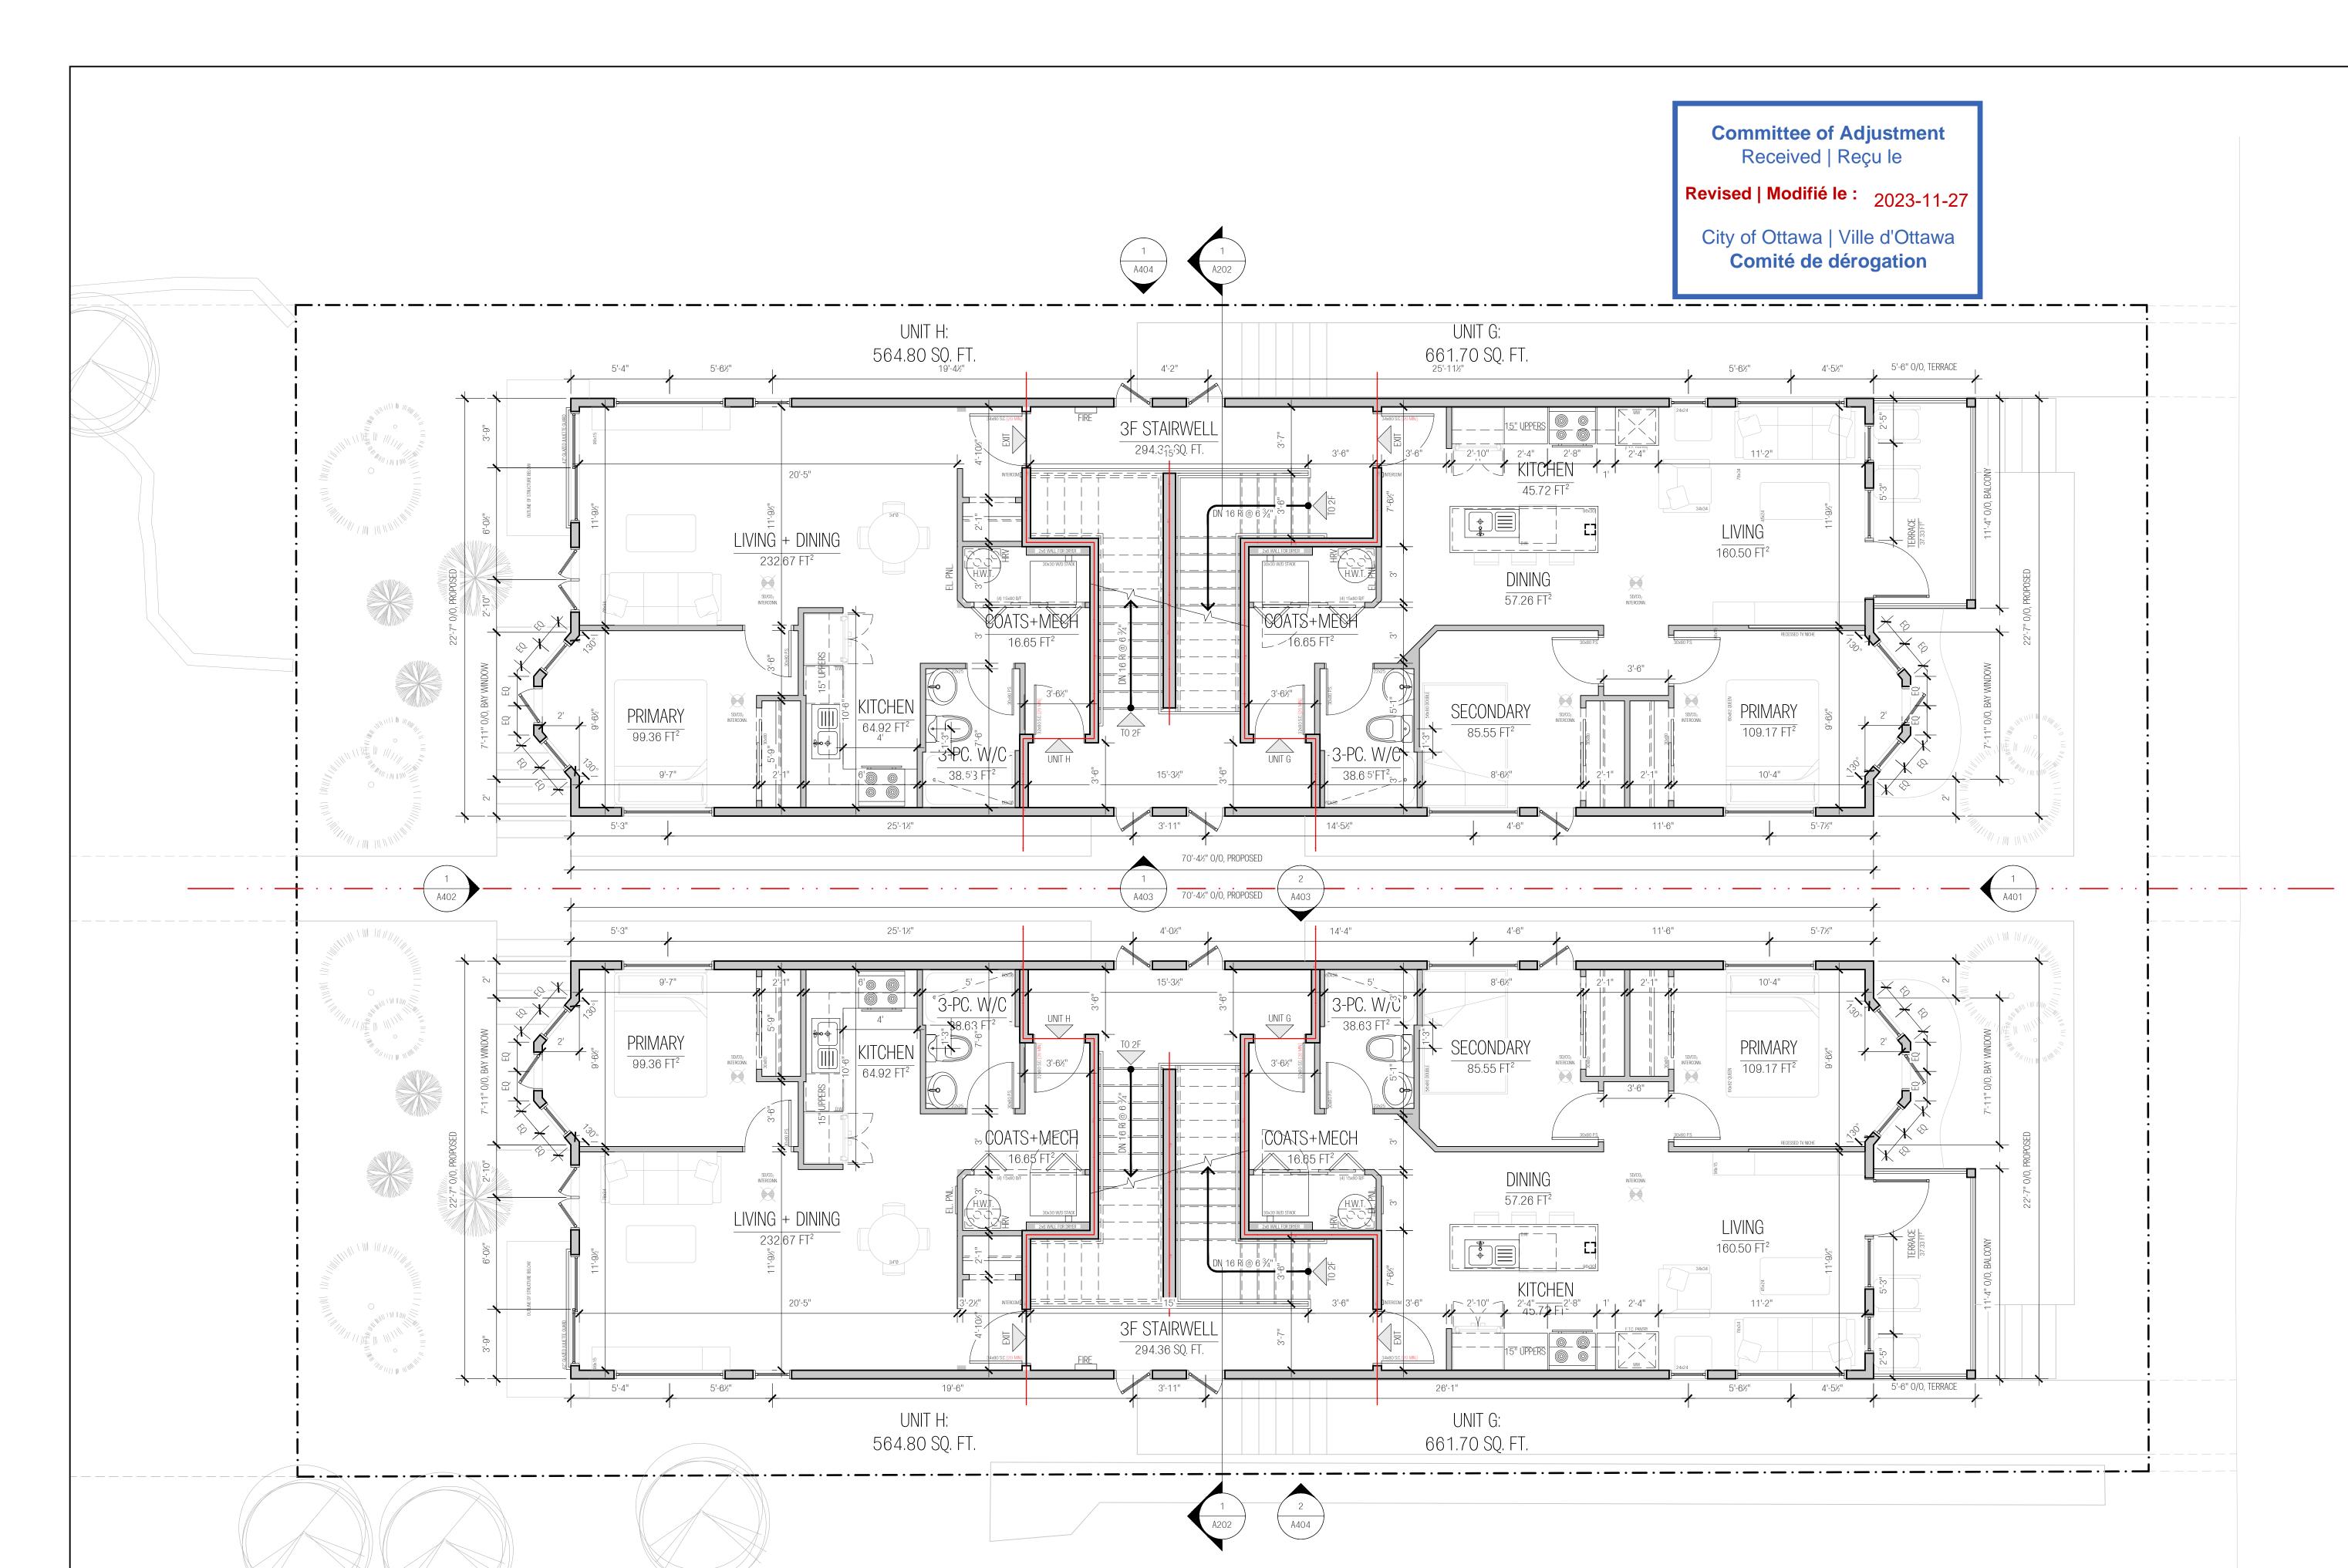




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NO.	DESCRIPTION	DATE
1	INITIAL LAYOUTS FOR CLIENT REVIEW	JUN/14/2023
2	PRECON SET	JUL/30/2023
3	PRE-CoA SET	AUG/23/2023

DRAWING NAME:
THIRD FLOOR PLAN: (674 & 676 RUE DE L'EGLISE)

DRAWN BY: CORY DUBEAU

SCALE: 1/4" = 1'-0" PROJECT NO.: 0035 A104



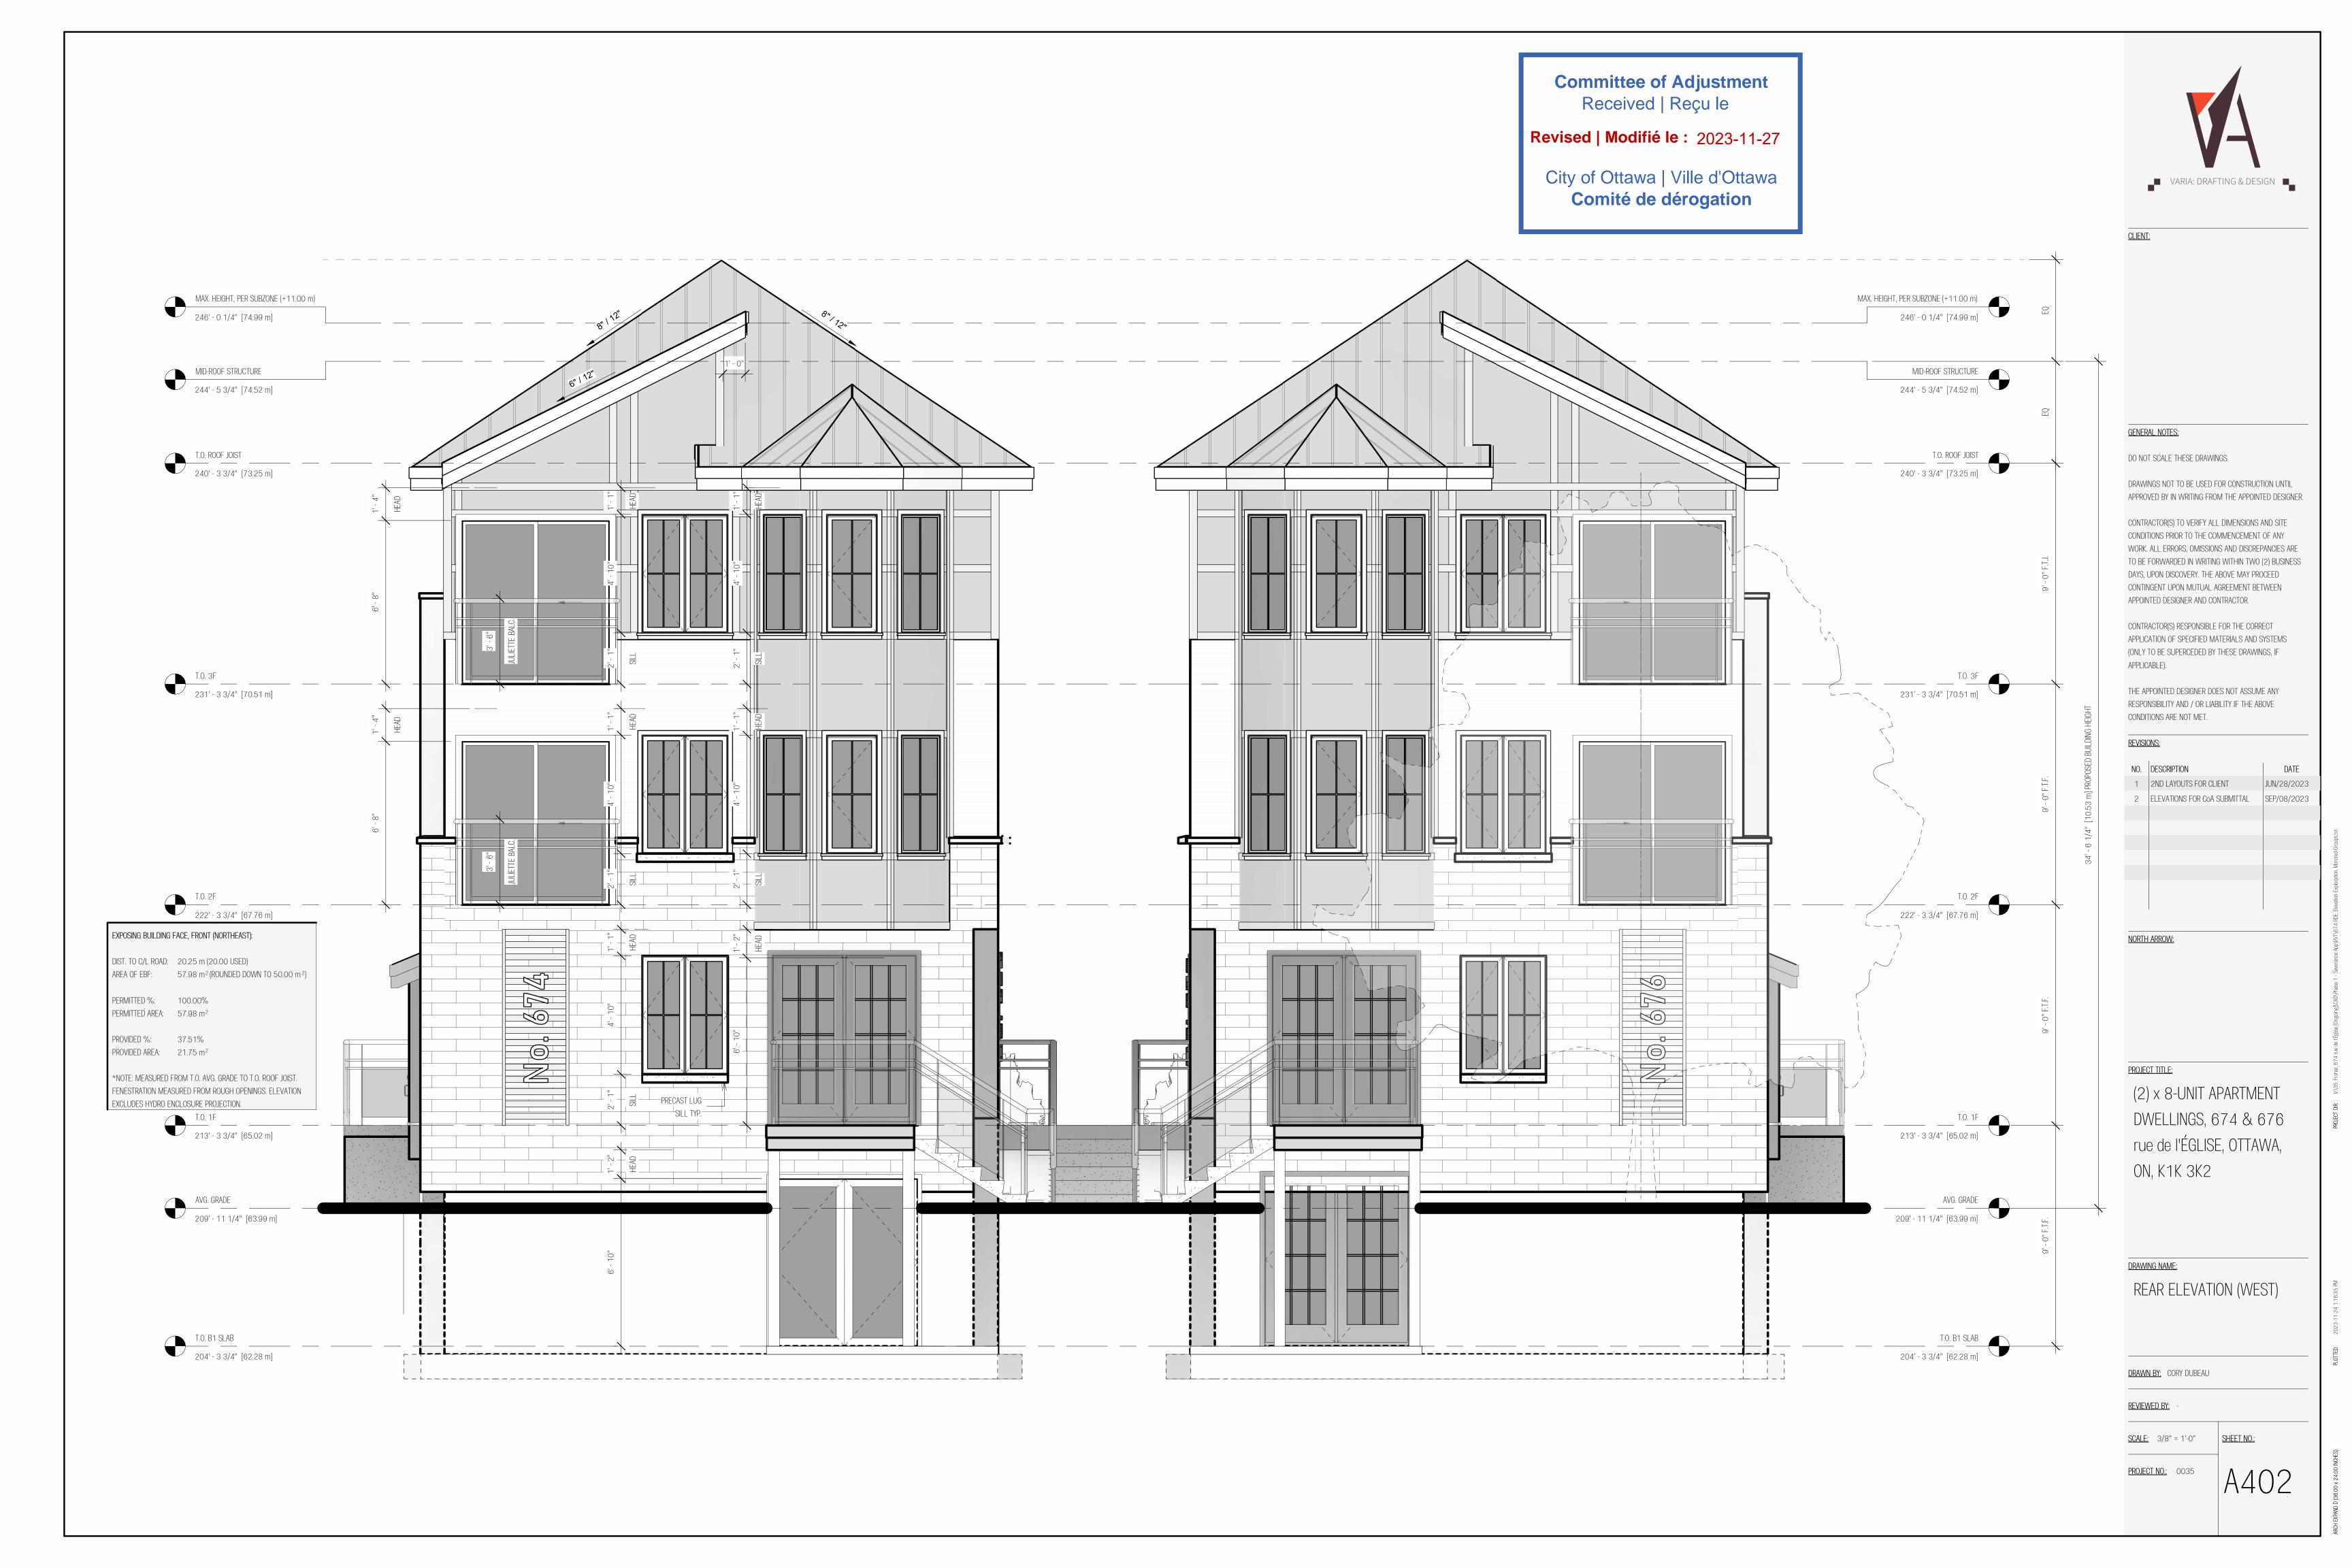





Revised | Modifié le : 2023-11-27

City of Ottawa | Ville d'Ottawa Comité de dérogation




REGIS AVENUE APPROACH: NOTE: MATERIAL CHANGES & JULIETTE BALCONIES



L'EGLISE APPROACH: NOTE THE ARTICULATED BALCONIES, BRICKWORK AND ADDRESS SIGNAGE



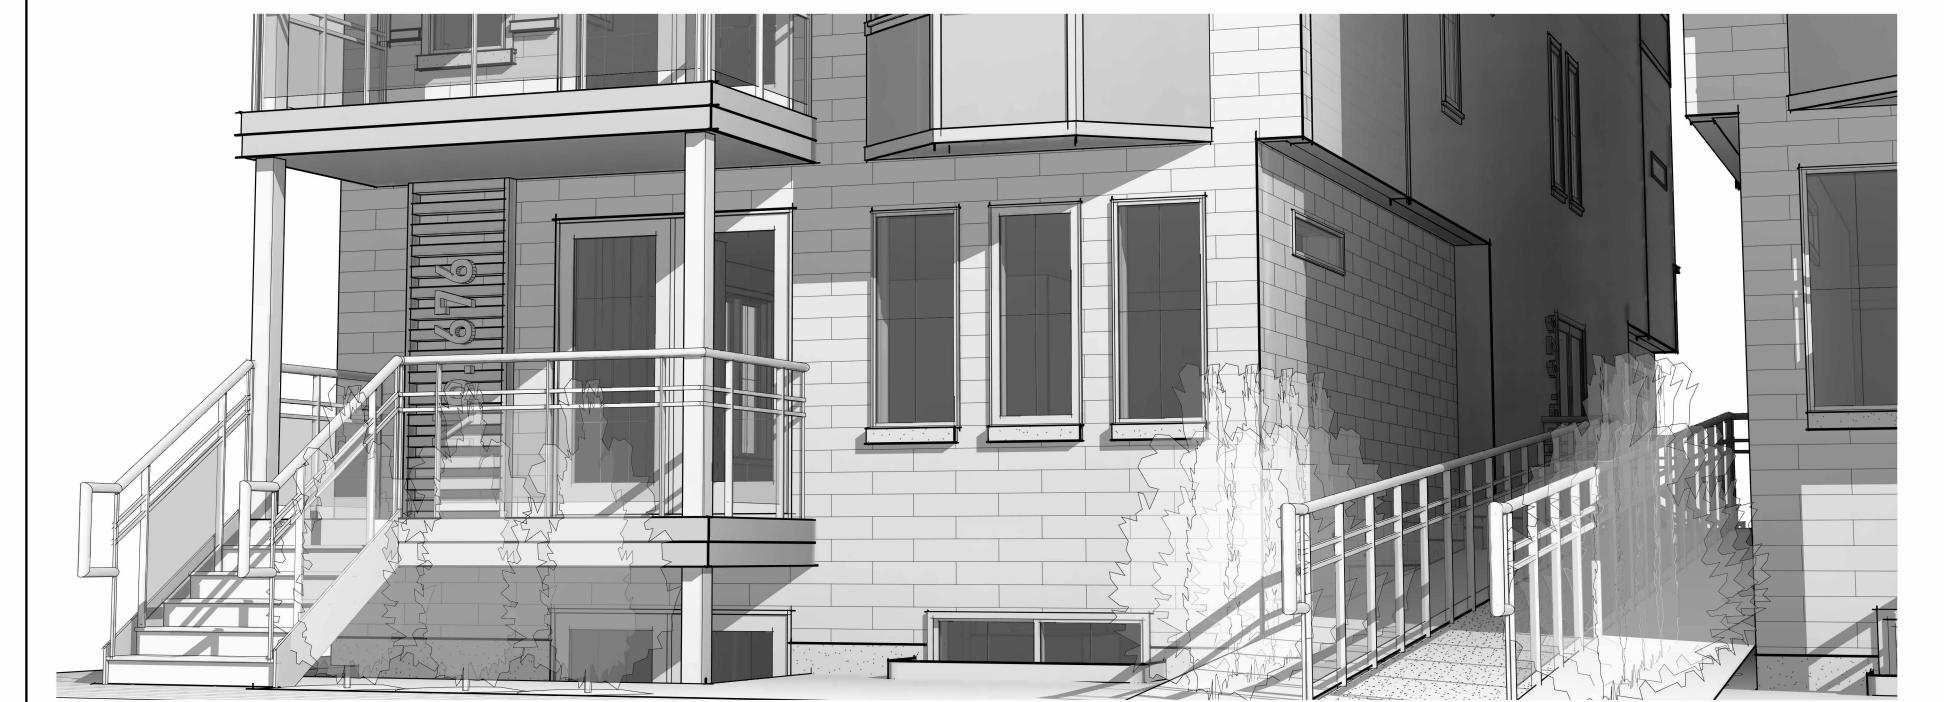

L'EGLISE: ENTRY DETAIL SHOWCASING THE ARTICULATION OF THE INTERIOR SIDEYARD ALONG THE SHARED PEDESTRIAN RAMP.



REGIS (REAR) VIEW SHOWCASING PROPOSED BICYCLE PARKING INTEGRATED WITH A MOBILE REPAIR STATION FURTHER ENCOURAGING CYCLING USE.



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REVISIONS:

NO.	DESCRIPTION	DATE
1	2ND LAYOUTS FOR CLIENT	JUN/28/2023
2	ELEVATIONS FOR COA SUBMITTAL	SEP/08/2023
4	REVISED HYDRO METER LOCATIONS	NOV/22/2023

NORTH ARROW:

OJECT TITLE:

(2) x 8-UNIT APARTMENT DWELLINGS, 674 & 676 rue de l'ÉGLISE, OTTAWA, ON, K1K 3K2

DRAWING NAME:

AXO VIEWS - ENTRY DETAILS

DRAWN BY: CORY DUBEAU


REVIEWED BY:

SCALE:

SHEET

PROJECT NO.: 0035

Ax001

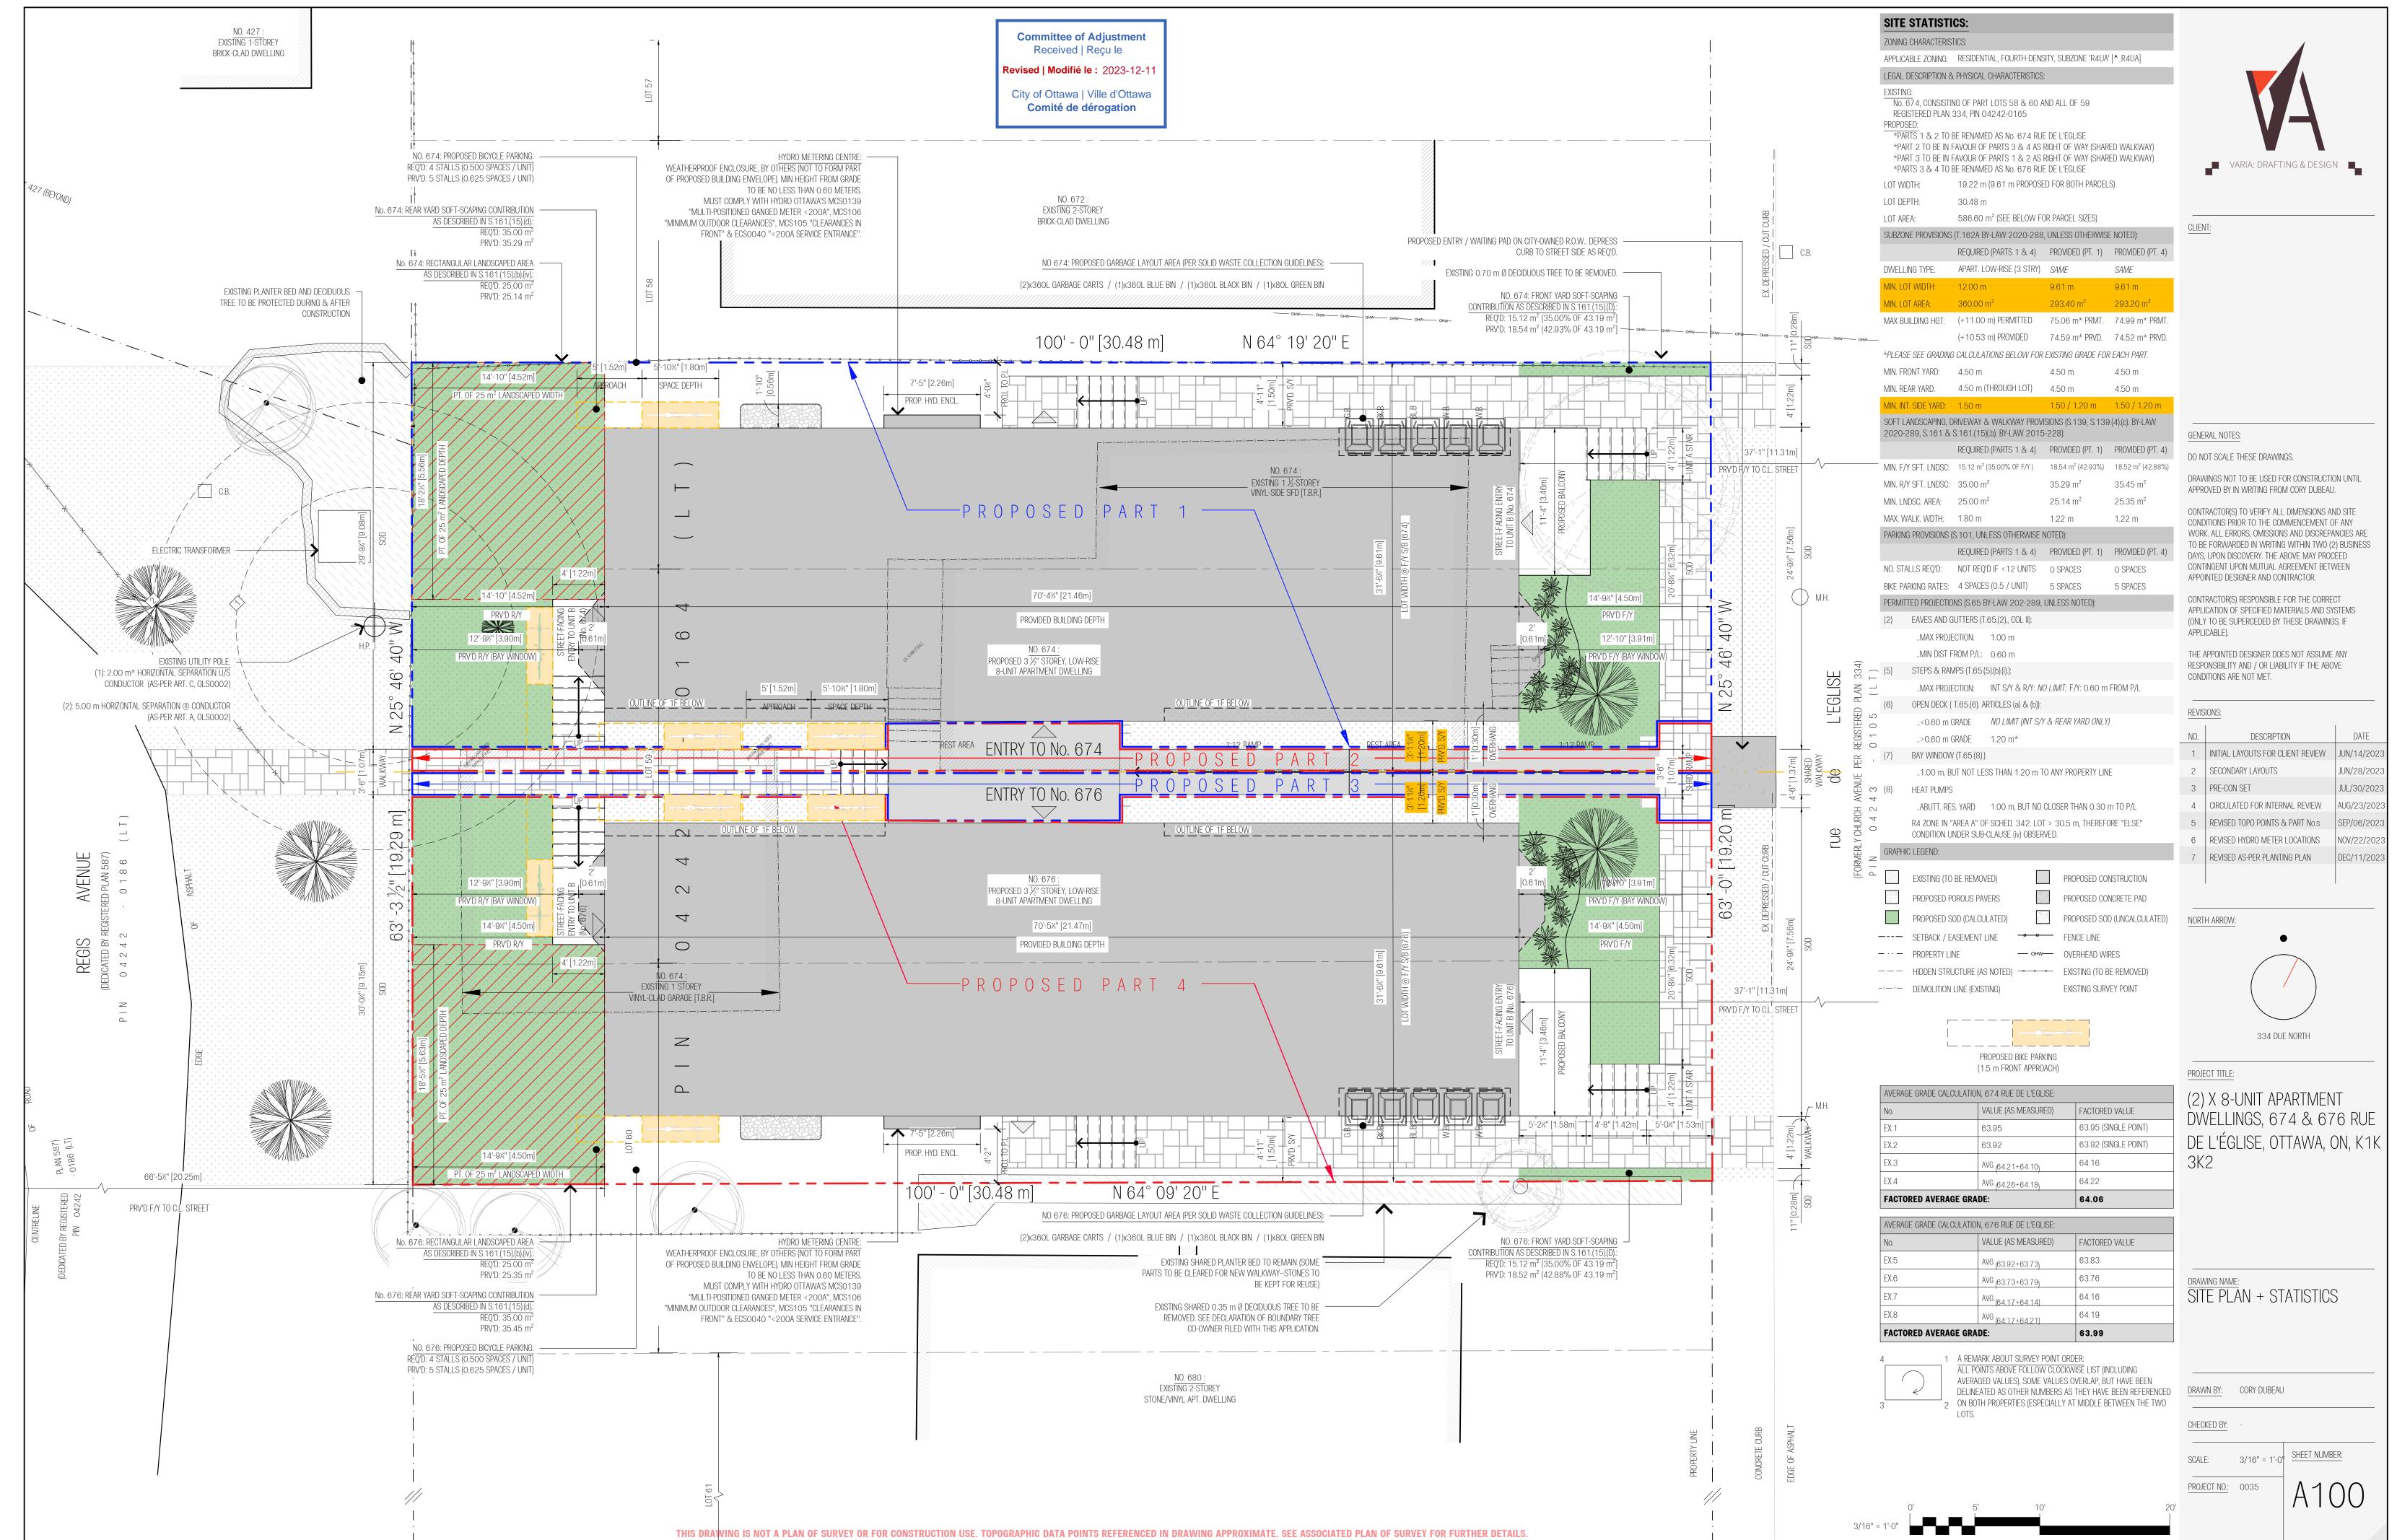

PROJECT DIR: V:\35_Frohar_674 Rue De L'Église [Ongoing]\CAD\Phase 1 - Severance App\CAD\674 Rue De L'Église_(2)-8-Unit_Low-R

LOTTED: December 9, 2023 3:23:54 PM

EXPAND D (36.00 X 24.00 INCHES)

Replacement Tree Specifications

Note: Proposed tree locations are suggestions only and should be finalized only once construction is complete and should adhere to City of Ottawa Tree Planting Guidelines found at the right of this page.

Trees 1-5 should be small trees at maturity due to overhead wires and small amounts of available rooting space. Site conditions are expected to be full to partial light exposure and moderate moisture availability. Species suggestions include:

Choke cherry - Prunus virginiana*
Eastern redbud - Cercis canadensis*
Yellowwood - Cladtrastis lutea
Flowering dogwood - Cornus florida
Magnolia - Magnolia spp.
Eastern redcedar - Juniperis virginiana*
Crabapple - Malus spp.
Servicebrry - Amelanchier spp.*
Pagoda dogwood - Cornus alternifolia*

Witch hazel - Hamamelis virginiana*
Oakleaf mountain ash - Sorbus thuringiaca 'Fastigiata'

*Native to Ottawa region: Planting species native to a region can help maintain and enhance biodiversity.


Trees 1 and 2 could be medium trees at maturity if breakout zones are created underneath the front walkway. Breakout zones are areas that allow roots to cross under hard surfaces through uncompacted rooting media to more available rooting space on the other side. These can be created using a variety of methods include:

Paper birch - Betula papyrifera*
Honey locust - Gleditsia triacanthos*
Sour cherry - Prunus cerasus
Pin cherry - Prunus pensylvanica*
River birch - Betula nigra
Shagbark hickory - Carya ovata*
Ironwood - Ostrya virginiana*
Bitternut hickory - Carya cordiformis*
Turkish hazel - Corylus colurna*

Note: Norway maple (*Acer platanoides*) is *not* recommended as it is highly invasive and not a suitable tree for urban planting.

The species recommended herein are the most suitable species based on the existing plans. For best success, tree species should be matched to site conditions.

All deciduous trees must be a minimum of 50 mm in diameter measured no less than 15 cm above ground level. Coniferous trees must be no less than 200 cm in height.

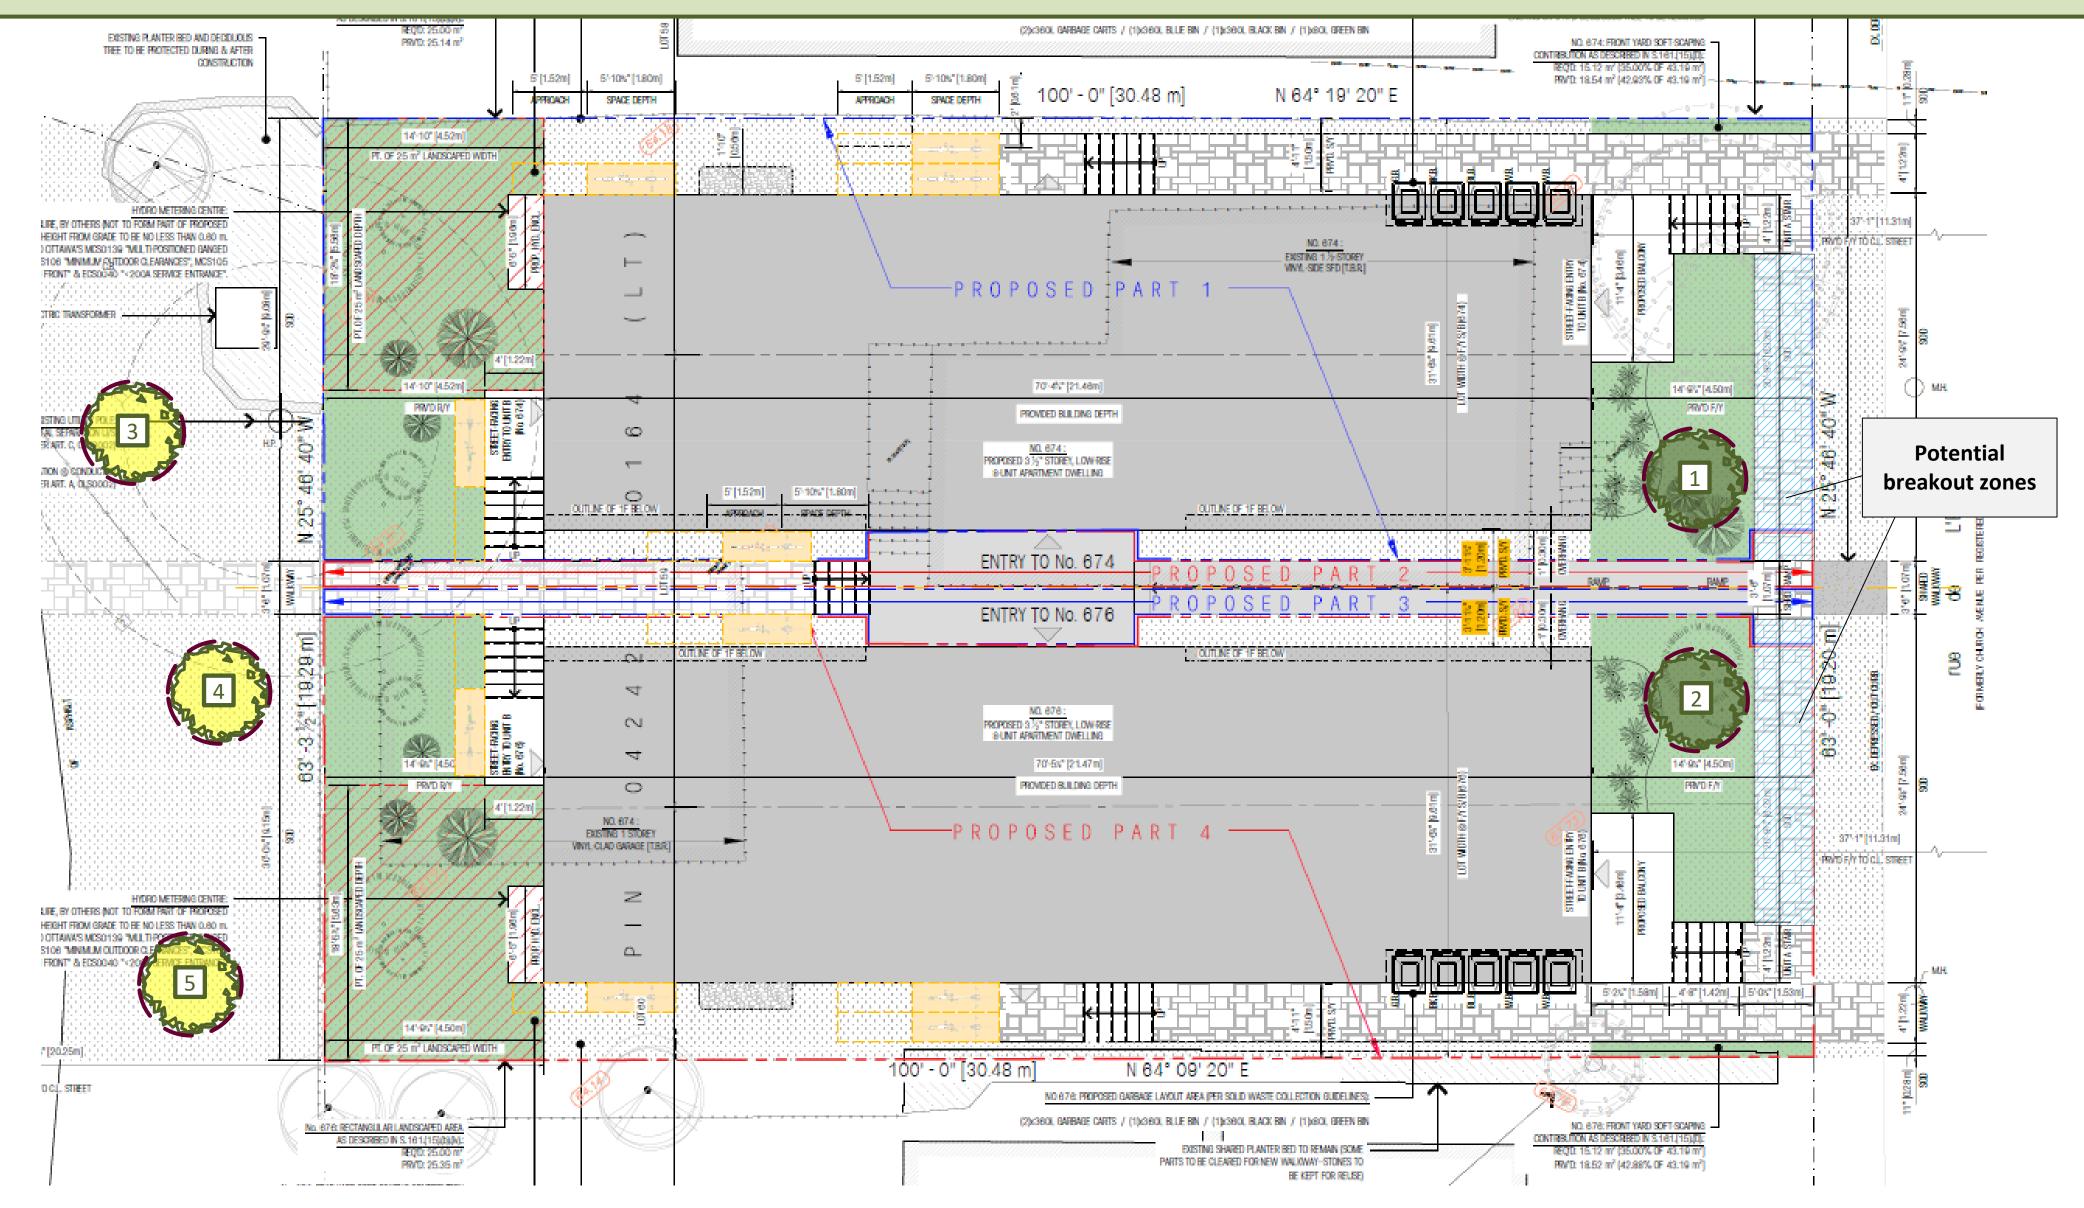



Tree Planting Plan – 674 rue de l'Eglise

Tree layer prepared by


Dendron Forestry Services

Version 3.0, December 8, 2023

For more information, please contact:

info@dendronforestry.ca

Note: the tree layer has been added to the original site plan supplied by the client in pdf format. This layer refers to the trees only, and the original site plan has not been altered in the process. Refer to the original plan for details as quality is lost when importing the plan into the mapping software used to create the tree layer.

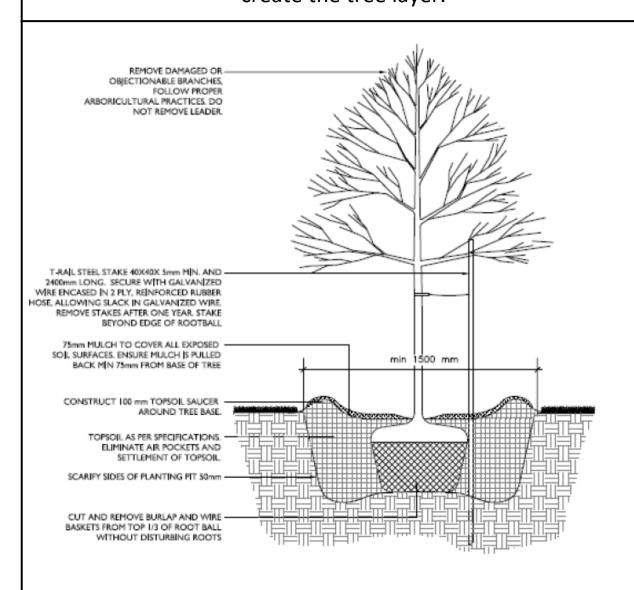

PROTECT TRUNK DURING TRANSPORT AND INSTALLATION, ALL WRAPPING
TO BE REMOVED BEFORE FINAL INSPECTION;
 ALL PROTECTIVE WRAPPING SHALL BE REMOVED AFTER INSTALLATION;
 STAKING OF TREES SHALL BE PERFORMED ONLY IF DEEMED NECESSARY;
 ALL DIMENSION IN MILLIMETERS UNLESS OTHERWISE NOTED.

KEY SPACING GUIDELINES

For Deciduous Trees:

- Minimum 50mm caliper stock
- 1.5m from sidewalks, driveways, walkways, fences, sound walls, and old stumps.
- 2.5m from curbs, hydro transformers, or behind fire hydrants
- 4-7m from any part of an existing tree, depending on canopy width
- 10m from bus shelters and community mailboxes

For Coniferous Trees:

- Follow same setbacks as deciduous, but due to the widest branching being at the base of the tree, conifers need greater setbacks for ground-level obstacles.
- Minimum 200cm height stock
 A Fire anthony live from aid availage.
- 4.5m setbacks from sidewalks, walkways, driveways, and curbs.
 Do not plant on corners where sight lines will be compromised.
- Do not plant on corners where sight lines will be compromised.

TREES MUST BE WATERED REGULARLY FOLLOWING PLANTING TO ENSURE PROPER ESTABLISHMENT.


On average, a young tree needs 6 gallons (24 liters) of water twice per week. (Do not water using a sprinkler as water on the foliage can lead to fungal infection)
Placing a ring of mulch around the planting hole will help reduce water loss.

Ensure no mulch is touching the base of the tree.


Legend



New Private Tree

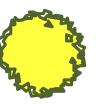

New Tree either fully or partly on city property

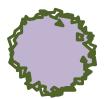

Existing Tree to be retained