

**Committee of Adjustment** Received | Reçu le

Comité de dérogation

THE GORHAM

**SURVEY WITH SETBACKS** 

EMILY + SEBASTIAN 74 STRACHAN STREET RICHMOND, ON

LEGEND:

APPROVED BY: DATE: March 25, 2024

PERMIT NO: RV5-0624

RIDEAU VALLEY CONSERVATION AUTHORITY

Jenna Gorham BCIN 126550 613.608.7634 jenna@thegorhamgroup.ca

> The Gorham Group BCIN 127561

MARCH 15, 2024

# 3.21 m Original Dwelling Existing Existing 1-Storey Accessory Building Existing **Existing Deck** Accessory Building - 2.26 m -

# **LOT COVERAGE**

Existing (per 2016 survey): 18% Proposed: 19.5% includes all accessory buildings and decks

### **GROSS FLOOR AREA**


Existing (per 2016 survey): 1380sqft Proposed:1928sqft

**Committee of Adjustment** Received | Reçu le

2024-03-27

**SCALE: 1:200** 

City of Ottawa | Ville d'Ottawa Comité de dérogation

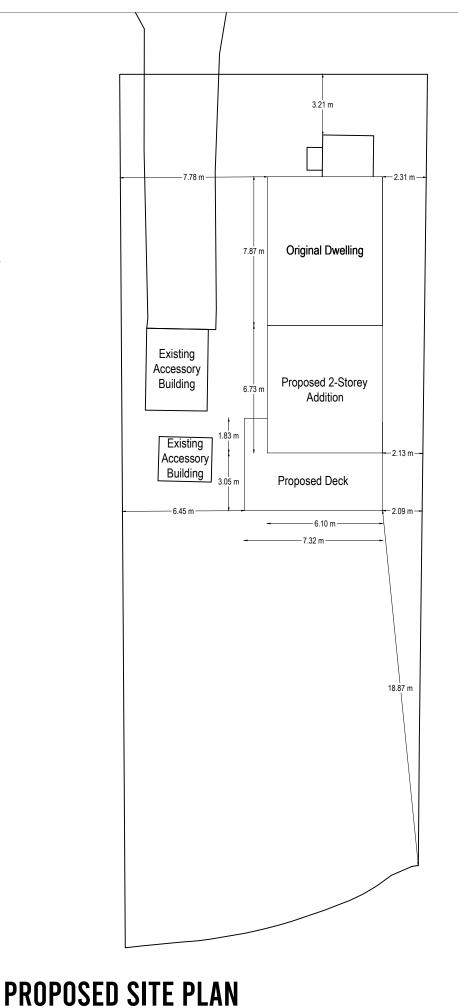

# THE GORHAM

## **SITE PLANS**

**EMILY + SEBASTIAN** 74 STRACHAN STREET RICHMOND, ON

LEGEND:



Jenna Gorham BCIN 126550 613.608.7634 jenna@thegorhamgroup.ca

> The Gorham Group BCIN 127561

MARCH 18, 2024

# **EXISTING SITE PLAN**

**SCALE: 1:200** 





Please note that renderings are for Illustration purposes only and may reflect exact choices & inclusions in project.

The undersigned has reviewed and takes responsibility for this design, and has the qualifications and meets the requirements set out in the Ontario Building Code.

Qualification Information:

Precision Home Design

113690 BCIN

CUSTOMER:

BOEMAC RENO / ADDITION

74 STRACHAN ST. RICHMOND, ON

DRAWING NAME:

SCALE :

Sheet#

DATE: JUNE 19, 2023

#### **OWNER & BUILDER'S NOTE**

THESE PLANS SHALL NOT BE USED FOR CONSTRUCTION UNTIL STAMPED AND SIGNED BY A QUALIFIED DESIGNER & THE LOCAL BUILDING DEPARTMENT. THE BUILDER IS EXPECTED TO FOLLOW THESE PLANS, APPLICABLE BUILDING CODES AND LOCAL ORDINANCES. HE SHALL VERIFY THAT SIT CONDITIONS ARE CONSISTENT WITH THESE PLANS BEFORE STARTING CONSTRUCTION, WHILE THESE PLANS ARE DRAWN TO SHOW THE PROPOSED WORK AS ACCURATELY AS POSSIBLE, SCHEMATIC DETAILS MAY BE USED IN SOME CASES FOR CLARITY. WORK NOT SPECIFICALLY DETAILED SHALL BE CONSTRUCTED TO THE SAME QUALITY AS SIMILAR WORK THAT IS

WRITTEN DIMENSIONS AND SPECIFIC NOTES SHALL TAKE PRECEDENCE OVER SCALED DIMENSIONS AND GENERAL NOTES. THE DESIGNER SHALL BE CONSULTED FOR CLARIFICATION IF SITE CONDITIONS ARE ENCOUNTERED THAT ARE DIFFERENT THAN SHOWN, IF DISCREPANCIES ARE FOUND IN THE PLANS OR NOTES, OR IF A QUESTION ARISES OVER THE INTENT OF THE PLANS OR NOTES.

THE DESIGNER ASSUMES NO RESPONSIBILITY FOR SCHEDULING, FABRICATION, CONSTRUCTION TECHNIQUES OR MATERIALS, OR QUANTITIES USED IN THE WORK. THE DESIGNER ASSUMES NO RESPONSIBILITY FOR FIELD CHANGES. SITE VARIANCES OR DISCREPANCIES NOT BROUGHT TO HIS HER ATTENTION FOR CLARIFICATION.

#### GENERAL NOTES

ALL WORK SHALL BE DONE IN ACCORDANCE WITH 2012 ONTARIO BUILDING CODE AND

FOUNDATION AND TRUSS DESIGN SHALL BE VERIFIED BY A QUALIFIED ENGINEER FOR COMPLIANCE WITH SITE REQUIREMENTS.

DIMENSIONS AND NOTES SHALL TAKE PRECEDENCE OVER THE SCALING OF DRAWINGS.

MALL DIMENSIONS ARE TO THE EXTERIOR OF FRAMING UNLESS NOTED OTHERWISE.

LUMBER COMING IN CONTACT WITH CONCRETE OR MASONRY SHALL BE TREATED OR PROTECTED WITH AN APPROVED VAPOR BARRIER.

CONTINUOUS CONTACT WITH THE GROUND SHALL BE TREATED TO A MINIMUM OF .60

ALL FRAMING LUMBER TO BE #2 OR BETTER DF OR EQUIVALENT, UNLESS NOTED OTHERWISE.

EXTERIOR AND INTERIOR MATERIALS AND FINISHES TO BE DETERMINED BY OWNER.

ALL REQUIRED SMOKE ALARMS NEED A VISUAL COMPONENT.

BLOCKING FOR NON-LOAD BEARING INTERIOR WALLS PARALLEL TO FLOOR JOISTS SHALL BE MIN 2x4 @ 4'-0" O.C.

CHIMNEY HEIGHT SHALL BE DETERMINED USING A 10' RADIUS PLANE AND SHALL BE 2' HIGHER THAN ANY ROOF SURFACE 10' FROM THE CHIMNEY.

DOWNSPOUTS TO BE COLLECTED AND ROOF RUN OFF TO BE DIRECTED AWAY FROM

FINISH GRADE SHALL SLOPE AWAY FROM STRUCTURE MIN. 1/2" PER FOOT OF RUN FOR

SOIL PARAMETERS: BASED ON SOILS INDIGENOUS TO THE AREA BEARING PRESSURE - 1600 PSF. (75 kPa) LATERAL ACTIVE PRESSURE 35 PSF FLUID

SOIL-CONCRETE COEFFICIENT 0.35 SOIL PROFILE SD

#### **BUILDING PERFORMANCE**

HEAT LOSS CALCULATIONS SHALL COMPLY WITH THE REQUIREMENTS OF REGIONAL AND LOCAL CODES. SEE CALCULATIONS

PORCHES AND GARAGE AREAS NOT INCLUDED IN LIVING AREA.

ALL EXHAUST FANS TO BE VENTED DIRECTLY TO THE EXTERIOR

ALL PENETRATIONS OF THE BUILDING ENVELOPE SHALL BE SEALED WITH POLYURETHANE FOAM

ALL COMBUSTION APPLIANCES WILL BE VENTED DIRECTLY TO THE EXTERIOR

FURNACE FIREBOX SHALL HAVE OUTSIDE COMBUSTION AIR SUPPLY PURSUANT TO REGIONAL AND LOCAL CODES.

A SOIL GAS BARRIER IS REQUIRED TO BE INSTALLED BENEATH A CONCRETE SLAB (AT OR BELOW GRADE) FOR ALL CONSTRUCTION REGULATED UNDER PART 9 OF THE ONTARIO BUILDING CODE.
A SOIL GAS BARRIER MUST INCLUDE THE FOLLOWING REQUIREMENTS:

- POLYETHYLENE SHEET COMPLYING TO CANICGSB-51.34-M
   JOINTS IN THE SOIL GAS BARRIER SHALL BE LAPPED NOT LESS THAN 300MM (12")
   PERIMETER OF SLAB SHALL BE SEALED TO THE INNER SURFACE OF ADJACENT
- SLAB PENETRATIONS SHALL BE SEALED AGAINST SOIL GAS LEAKAGE

#### **YENTILATION:**

WHERE INSULATION IS INSTALLED BETWEEN A CEILING AND THE UNDERSIDE OF THE ROOF SHEATHING, A SPACE SHALL BE PROVIDED BETWEEN THE INSULATION AND THE SHEATHING, AND VENTS SHALL BE INSTALLED TO PERMIT THE MOVEMENT OF AIR FROM THE SPACE TO THE EXTERIOR.

ATTIC SHALL HAVE VENTILATION EQUAL TO 1 SQ. FOOT PER 150 SQ. FEET OF ATTIC SPACE. VENTILATION SHALL BE PROTECTED FROM SNOW AND RAIN. OPENINGS SHALL BE LOCATED TO PROVIDE CROSS VENTILATION.

UNDER FLOOR SPACES SHALL HAVE VENTILATION EQUAL TO ONE SQ. FOOT PER 150 SQ. FEET OF FLOOR SPACE. VENTS SHALL BE CAST INTO THE CONCRETE STEM MALLS AND COVERED WITH GALVANIZED WIRE SCREEN. VENTS SHALL BE LOCATED TO PROVIDE CROSS VENTILATION

#### RAILING NOTES:

STAIRWAYS SHALL HAVE A MIN. WIDTH OF 35" MEASURED BETWEEN WALL FACES OR GUARDS

TREADS SHALL HAVE A MIN. DEPTH OF 10". STAIR TREADS MUST BE UNIFORM AND CAN NOT VARY FROM THE LARGEST TO THE SMALLEST BY MORE THAN 1/4".

STAIRWAYS SHALL HAVE MIN. 6'-5" OF HEADROOM AT THE NOSE OF THE STAIR.

STAIRWAYS SHALL HAVE AT LEAST ONE HANDRAIL LOCATED 34" TO 38" ABOVE THE NOSING OF TREADS AND LANDINGS. THE HAND GRIP PORTION OF HANDRAILS SHALL NOT BE LESS THAN 1-1/2" OR GREATER THAN 2" IN CROSS-

HANDRAILS SHALL BE CONTINUOUS THE FULL LENGTH OF THE STAIRS. THE ENDS OF HANDRAILS SHALL RETURN TO WALL OR TERMINATE INTO A NEWEL POST OR SAFETY TERMINAL

STAIRWAYS HAVING LESS THAN 2 RISERS DO NOT REQUIRE A HAND RAIL.

36" MIN. HEIGHT GUARDRAILS SHALL BE PROVIDED FOR AT PORCHES, DECKS, BALCONIES, STAIRWAYS AND LANDINGS WHERE THE ADJACENT SURFACE IS LESS THAN 24" BELOW.

RAILING AND GUARDRAIL BALUSTER SPACING SHALL BE NO GREATER THAN 4".

THE TRIANGULAR OPENINGS FORMED BY THE RISER, TREAD, AND BOTTOM OF GUARDRAIL SHALL NOT ALLOW A 4" DIAMETER SPHERE TO PASS THROUGH.

#### **WINDOWS AND DOORS**

WINDOWS SHALL BE DOUBLE PANE WITH VINYL FRAMES AND CONFORM TO CAN/CSA-A440 MANUFACTURER AND COLOR TO BE DETERMINED BY OWNER.

EVERY BEDROOM SHALL BE PROVIDED WITH AN EGRESS WINDOW WITH FINISH SILL HEIGHT NOT GREATER THAN 39" ABOVE THE FINISH FLOOR HEIGHT (EXCLUDING BASEMENTS) AND SHALL HAVE A MINIMUM OPENABLE AREA OF 3.8 SQ. FT. EGRESS WINDOWS SHALL NOT HAVE AN OPENABLE AREA LESS THAN 15" WIDE OR 24" HIGH

SAFETY GLAZING SHALL BE PROVIDED IN DOORS AND ENCLOSURES FOR HOT TUBS, WHIRLPOOLS, SAUNAS, STEAM ROOMS, BATHTUBS, AND SHOWERS.

ALL EXTERIOR DOORS AND WINDOWS SHALL BE FINISHED WITH WEATHER RESISTANT COATINGS AND WEATHER STRIPPED.

DOORS BETWEEN GARAGE AND LIVING AREA SHALL BE 1-3/4" TIGHT FITTING SOLID CORE DOORS WITH A RATING OF 20 MINUTES. DOOR SHALL BE SELF CLOSING

MAIN ENTRANCE DOORS TO DWELLING UNITS SHALL BE PROVIDED WITH, A DOOR VIEWER OR TRANSPARENT GLAZING IN THE DOOR, OR A SIDELIGHT

#### ATTIC ACCESS:

A MINIMUM OF 22" × 36". THERE SHALL BE 30" MIN. CLEARANCE AT OR ABOVE THE

LOCATED IN A CORRIDOR, HALLWAY OR OTHER READILY ACCESSIBLE LOCATION. ATTICS WITH A MAXIMUM VERTICAL HEIGHT OF LESS THAN 30" WILL NOT REQUIRE ACCESS OPENINGS.

HATCHWAYS TO ATTIC OR ROOF SPACES SHALL BE FITTED WITH DOORS OR COVERS.

| REVISIONS | DATE |
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| DOOR SCHEDULE |     |       |          |        |                 |                                |                      |          |
|---------------|-----|-------|----------|--------|-----------------|--------------------------------|----------------------|----------|
| NUMBER        | QTY | FL00R | MIDTH    | HEIGHT | R/0             | DESCRIPTION                    | AREA, ACTUAL (SQ FT) | COMMENTS |
| D01           | 1   | 1     | 36 "     | 80 "   | 39"X83 3/4"     | EXT. HINGED-GLASS PANEL        | 20.0                 |          |
| D02           | 1   | 1     | 58 1/2 " | 80 "   | 59 1/2"X81"     | MULLED UNIT-HL                 | 32.5                 |          |
| D03           | 1   | 1     | 72 "     | 80 "   | 75"×83 3/4"     | EXT. DOUBLE HINGED-GLASS PANEL | 40.0                 |          |
| D04           | 1   | 2     | 18 "     | 80 "   | 20 1/2"X83 1/2" | HINGED-3 PANEL                 | 10.0                 |          |
| D05           | 1   | 2     | 24 "     | 80 "   | 26 1/2"X83 1/2" | HINGED-3 PANEL                 | 13.33                |          |
| D06           | 1   | 2     | 26 "     | 80 "   | 53 1/4"X84 1/2" | POCKET-3 PANEL                 | 14.44                |          |
| DOT           | 6   | 2     | 30 "     | 80 "   | 32 1/2"X83 1/2" | HINGED-3 PANEL                 | 16.67                |          |
| D08           | 1   | 2     | 32 "     | 80 "   | 34 1/2"X83 1/2" | HINGED-3 PANEL                 | 17.78                |          |
| D09           | 2   | 2     | 48 "     | 80 "   | 50 1/2"X83 1/2" | DOUBLE HINGED-3 PANEL          | 26.67                |          |
| D10           | 1   | 2     | 96 "     | 80 "   | 98 1/2"X84 1/2" | SLIDER-DOOR P05                | 53.33                |          |
| TOTALS:       |     |       |          |        |                 |                                | 354.74               |          |

|         |     |       |             |        | MI          | NDOW SCHEDULE           |                      |          |
|---------|-----|-------|-------------|--------|-------------|-------------------------|----------------------|----------|
| NUMBER  | QTY | FLOOR | MIDTH       | HEIGHT | R/0         | DESCRIPTION             | AREA, ACTUAL (SQ FT) | COMMENTS |
| M01     | 1   | 1     | 22 "        | 60 "   | 23"X61"     | SINGLE CASEMENT-HL      | 9.17                 |          |
| M02     | 1   | 1     | 30 "        | 42 "   | 31"X43"     | SINGLE CASEMENT-HL      | 8.75                 |          |
| M03     | 1   | 1     | 30 "        | 66 "   | 31"X67"     | SINGLE CASEMENT-HL      | 13.75                |          |
| M04     | 1   | 1     | 42 "        | 72 "   | 43"X73"     | DOUBLE CASEMENT-LHL     | 21.0                 |          |
| M05     | 1   | 1     | 42 "        | 72 "   | 43"X73"     | DOUBLE CASEMENT-RHR     | 21.0                 |          |
| M06     | 1   | 1     | 46 1/4 "    | 55 "   | 47 1/4"X56" | DOUBLE HUNG             | 17.66                |          |
| MOT     | 1   | 1     | 48 "        | 42 "   | 49"X43"     | DOUBLE CASEMENT-LHL     | 14.0                 |          |
| MOB     | 1   | 1     | 84 "        | 44 "   | 85"×45"     | TRIPLE CASEMENT-LHL/RHR | 25.67                |          |
| M09     | 1   | 1     | <b>92</b> " | 72 "   | 43"X73"     | TRIPLE CASEMENT-LHL/RHR | 46.0                 |          |
| W10     | 1   | 2     | 24 "        | 60 "   | 25"X61"     | SINGLE CASEMENT-HL      | 10.0                 |          |
| W11     | 2   | 2     | 30 "        | 60 "   | 31"X61"     | DOUBLE HUNG             | 12.5                 |          |
| W12     | 1   | 2     | 44 "        | 60 "   | 45"X61"     | DOUBLE CASEMENT-LHL     | 18.33                |          |
| W13     | 2   | 2     | 72 "        | 48 "   | 73"×49"     | TRIPLE CASEMENT-LHL/RHR | 24.0                 |          |
| TOTALS: |     |       |             |        |             |                         | 278.33               |          |

#### NOTES:

- 1. DOUBLE PANE WINDOWS / DOORS
- 2. GRIDS AS PER ELEVATIONS

|  |   |                       | PRECISION - HOME DESIGN - www.precisionhd.ca   |
|--|---|-----------------------|--|
|  |   |                       | Please note that renderings are for illustration purposes only and may no reflect exact choices & inclusions in project. |
| TABLE 3.1.1.11. REQUIREMENTS FOR ADDITIONS T |   |                       |  |
| COMPONENT                                    | THERMAL<br>VALUES                       | ZONE 1<br>< 5000 D.D. | Qualification Information:   |
|  | .,,,,,,,,,,,,,,,,,,,,,,,,,,,,,,,,,,,,,, | - 3000 D.D.           |  |

| COMPONENT  | THERMAL                | ZONE 1      |  |  |  |
|--|------------------------|-------------|--|--|--|
| COMPONENT  | VALUES                 | < 5000 D.D. |  |  |  |
| CEILING W/ ATTIC SPACE                           |                        | 60          |  |  |  |
| CEILING W/O ATTIC SPACE                          |                        | N/A         |  |  |  |
| EXPOSED FLOOR                                    |                        | 18 + 22     |  |  |  |
| WALLS ABOVE GRADE                                | MIN.                   | 22 + 5 C.I. |  |  |  |
| BASEMENT WALLS                                   | BASEMENT WALLS NOMINAL |             |  |  |  |
| HEATED SLAB OR SLAB<br>< 600mm BELOW GRADE       | 'R'                    | N/A         |  |  |  |
| EDGE OF BELOW GRADE SLAB<br>< 600 mm BELOW GRADE |                        | N/A         |  |  |  |
| MINDOMS AND SLIDING<br>GLASS DOORS               | ENERGY<br>RATING       | 25          |  |  |  |
| SPACE HEATING EQUIPMENT                          | MIN. AFUE              | EXISTING    |  |  |  |
| HRV  | MIN. SRE               | EXISTING    |  |  |  |
|  |                        |             |  |  |  |

MIN. EF

EXISTING


DATE:

JUNE 19, 2023

DOMESTIC WATER HEATER

| Jeremy McMullen                 | M/cm 2202 |  |  |  |  |  |
|---------------------------------|-----------|--|--|--|--|--|
| NAME SIGNATURE                  | BCI       |  |  |  |  |  |
| Precision Home Design           | 11369     |  |  |  |  |  |
| FIRM                            | BCII      |  |  |  |  |  |
| CUSTOMER:                       |           |  |  |  |  |  |
| BOEMAC RENO / ADDITION          |           |  |  |  |  |  |
| 74 STRACHAN ST.<br>RICHMOND, ON |           |  |  |  |  |  |
| DRAWING NAME:                   |           |  |  |  |  |  |
| GENERAL NO                      | OTES      |  |  |  |  |  |
| SCALE:                          | Sheet#    |  |  |  |  |  |

#### ALL EXTERIOR DIMENSIONS ARE FROM CONCRETE

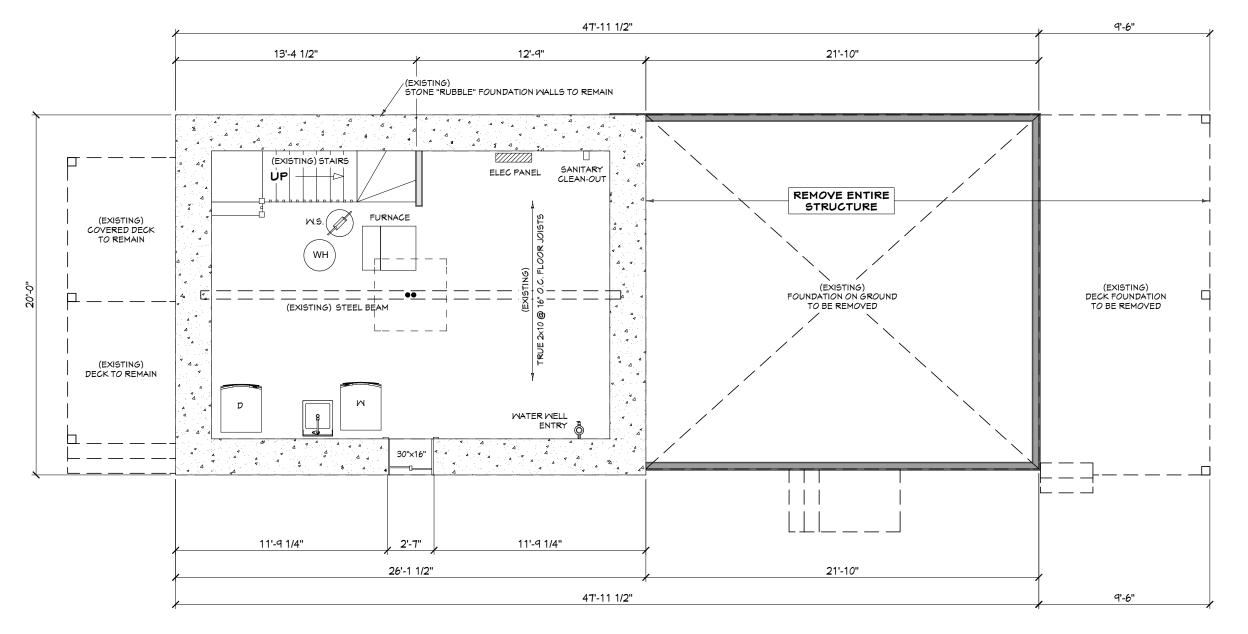

EXISTING FOUNDATION PLAN





out in the Ontario Building Code. Qualification Information

Precision Home Design

113690 BCIN

CUSTOMER:

**BOEMAC RENO / ADDITION** 

74 STRACHAN ST. RICHMOND, ON

DRAWING NAME: EXISTING FOUNDATION PLAN

SCALE:


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DATE:

**A3** JUNE 19, 2023


NOTES:

1. ALL DIMENSIONS ARE TO BE CONFIRMED ON-SITE PRIOR TO CONSTRUCTION.

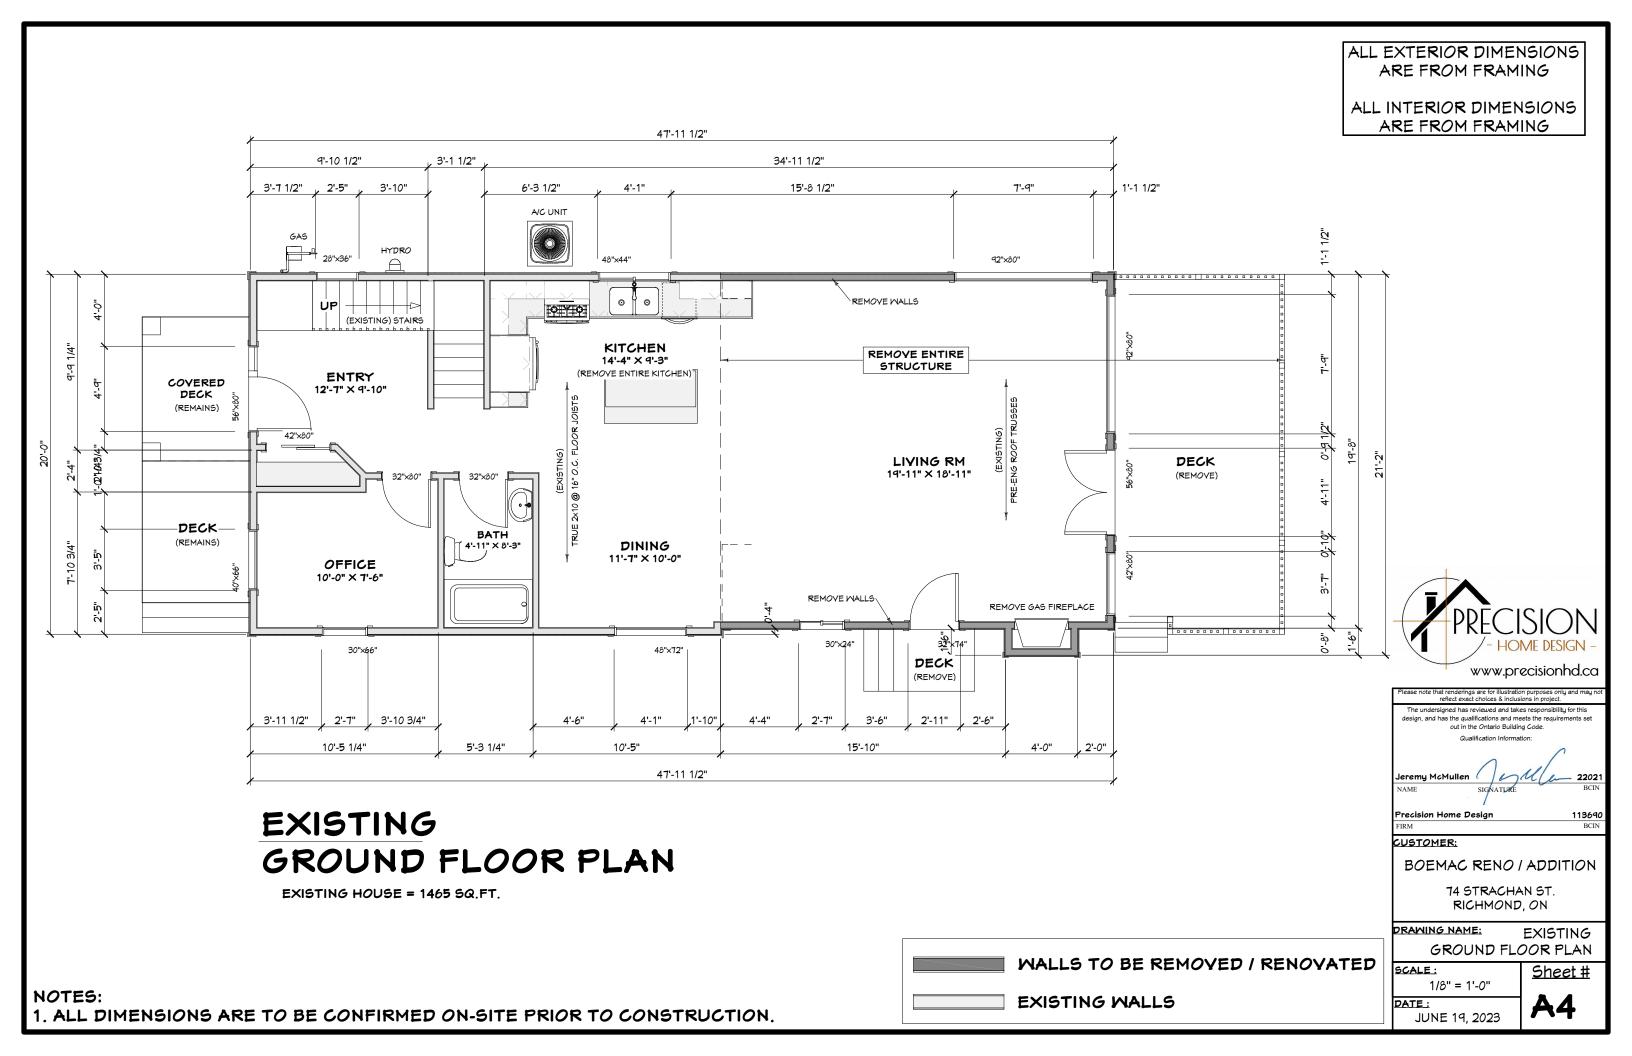

ALL EXTERIOR DIMENSIONS ARE FROM FRAMING

ALL INTERIOR DIMENSIONS ARE FROM FRAMING

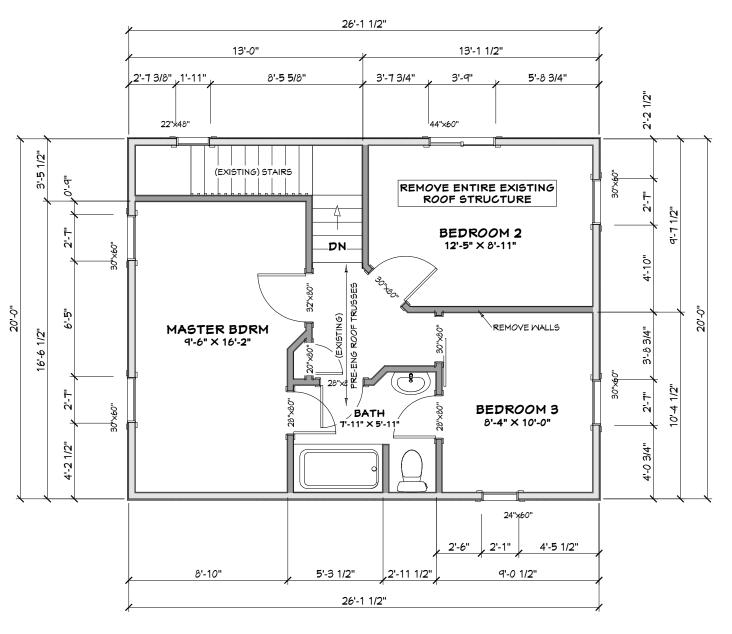

# EXISTING SECOND FLOOR PLAN

EXISTING HOUSE = 1465 SQ.FT.



**BOEMAC RENO / ADDITION** 

The undersigned has reviewed and takes responsibility for this

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74 STRACHAN ST. RICHMOND, ON

DRAWING NAME: EXISTING SECOND FLOOR PLAN


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**A5** DATE: JUNE 19, 2023

WALLS TO BE REMOVED / RENOVATED EXISTING WALLS

1. ALL DIMENSIONS ARE TO BE CONFIRMED ON-SITE PRIOR TO CONSTRUCTION.



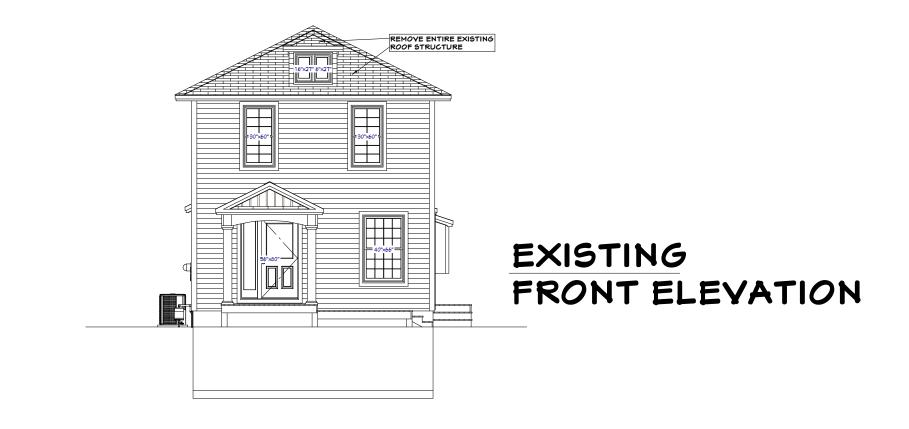

# EXISTING RIGHT ELEVATION



1. ALL DIMENSIONS ARE TO BE CONFIRMED ON-SITE PRIOR TO CONSTRUCTION.



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The undersigned has reviewed and takes responsibility for t design, and has the qualifications and meets the requirement out in the Ontario Building Code.

Qualification Information:

my McMullen ( ) M ( ) 2 E SIGNATURE

Precision Home Design

CUSTOMER:

BOEMAC RENO / ADDITION

74 STRACHAN ST. RICHMOND, ON

DRAWING NAME:

EXISTING ELEVATIONS

SCALE:

1/8" = 1'-0

Sheet #

DATE :

JUNE 19, 2023



113690 BCIN





EXISTING LEFT ELEVATION

NOTES:

1. ALL DIMENSIONS ARE TO BE CONFIRMED ON-SITE PRIOR TO CONSTRUCTION.



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remy McMullen Ml 220

Precision Home Design

CUSTOMER:

BOEMAC RENO / ADDITION

74 STRACHAN ST. RICHMOND, ON

DRAWING NAME:

EXISTING ELEVATIONS

SCALE:

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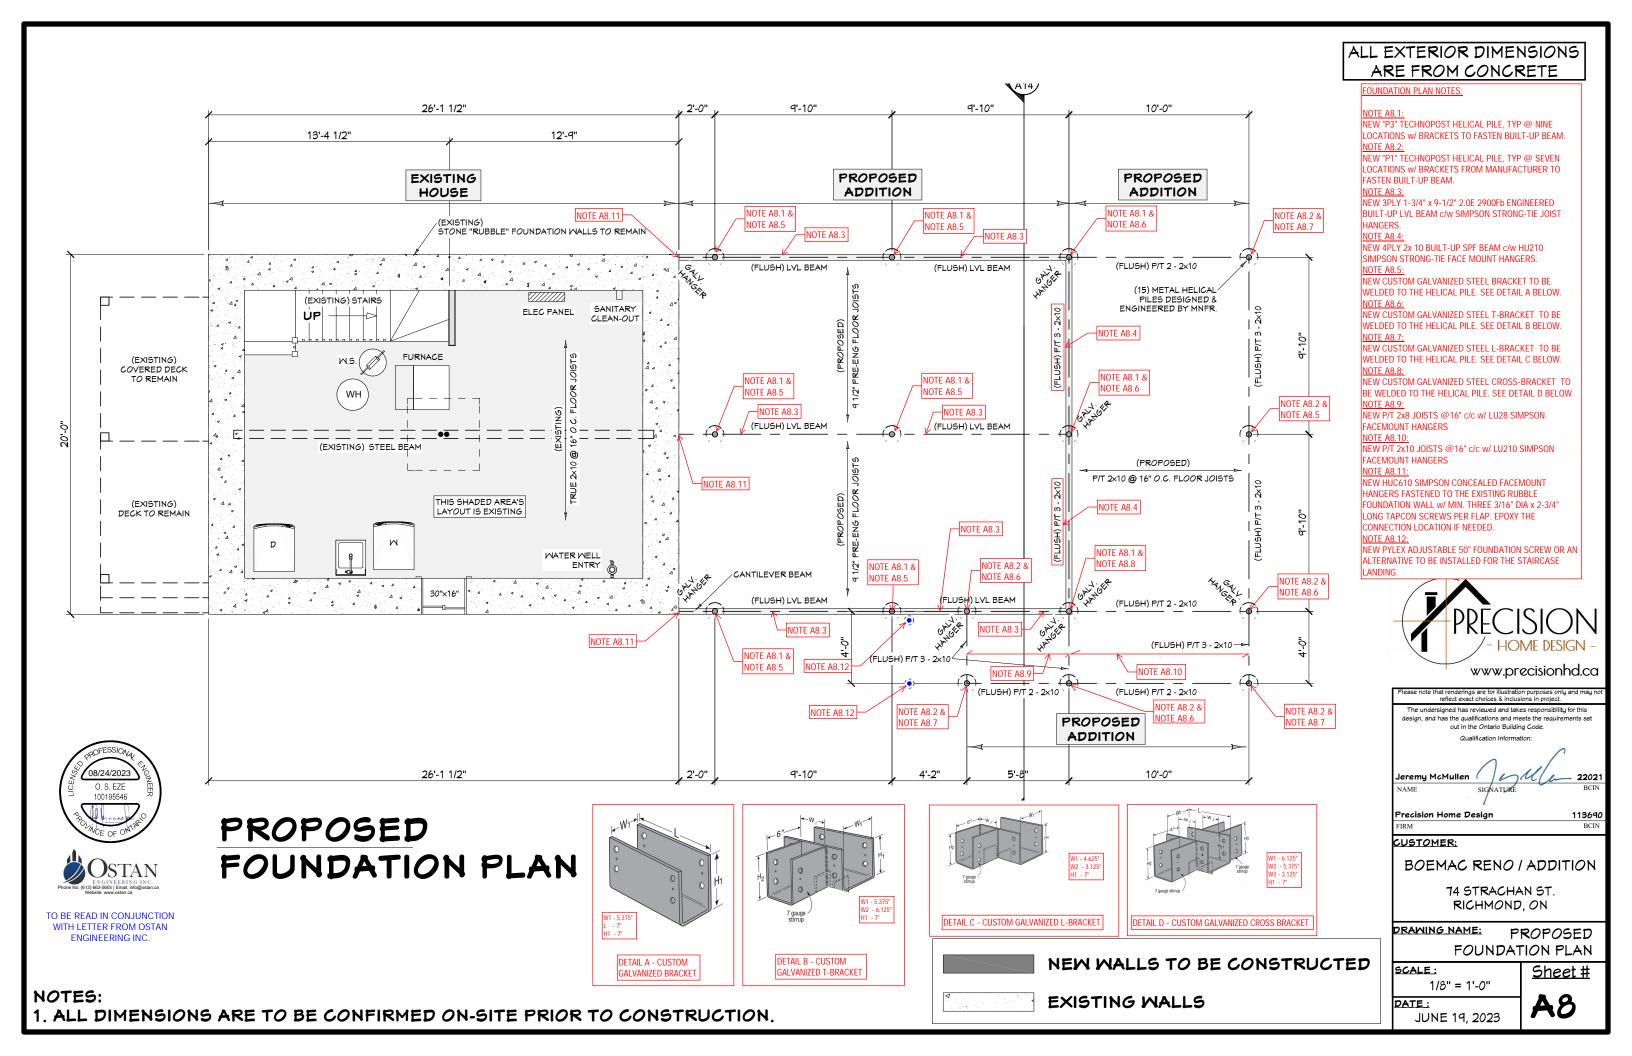
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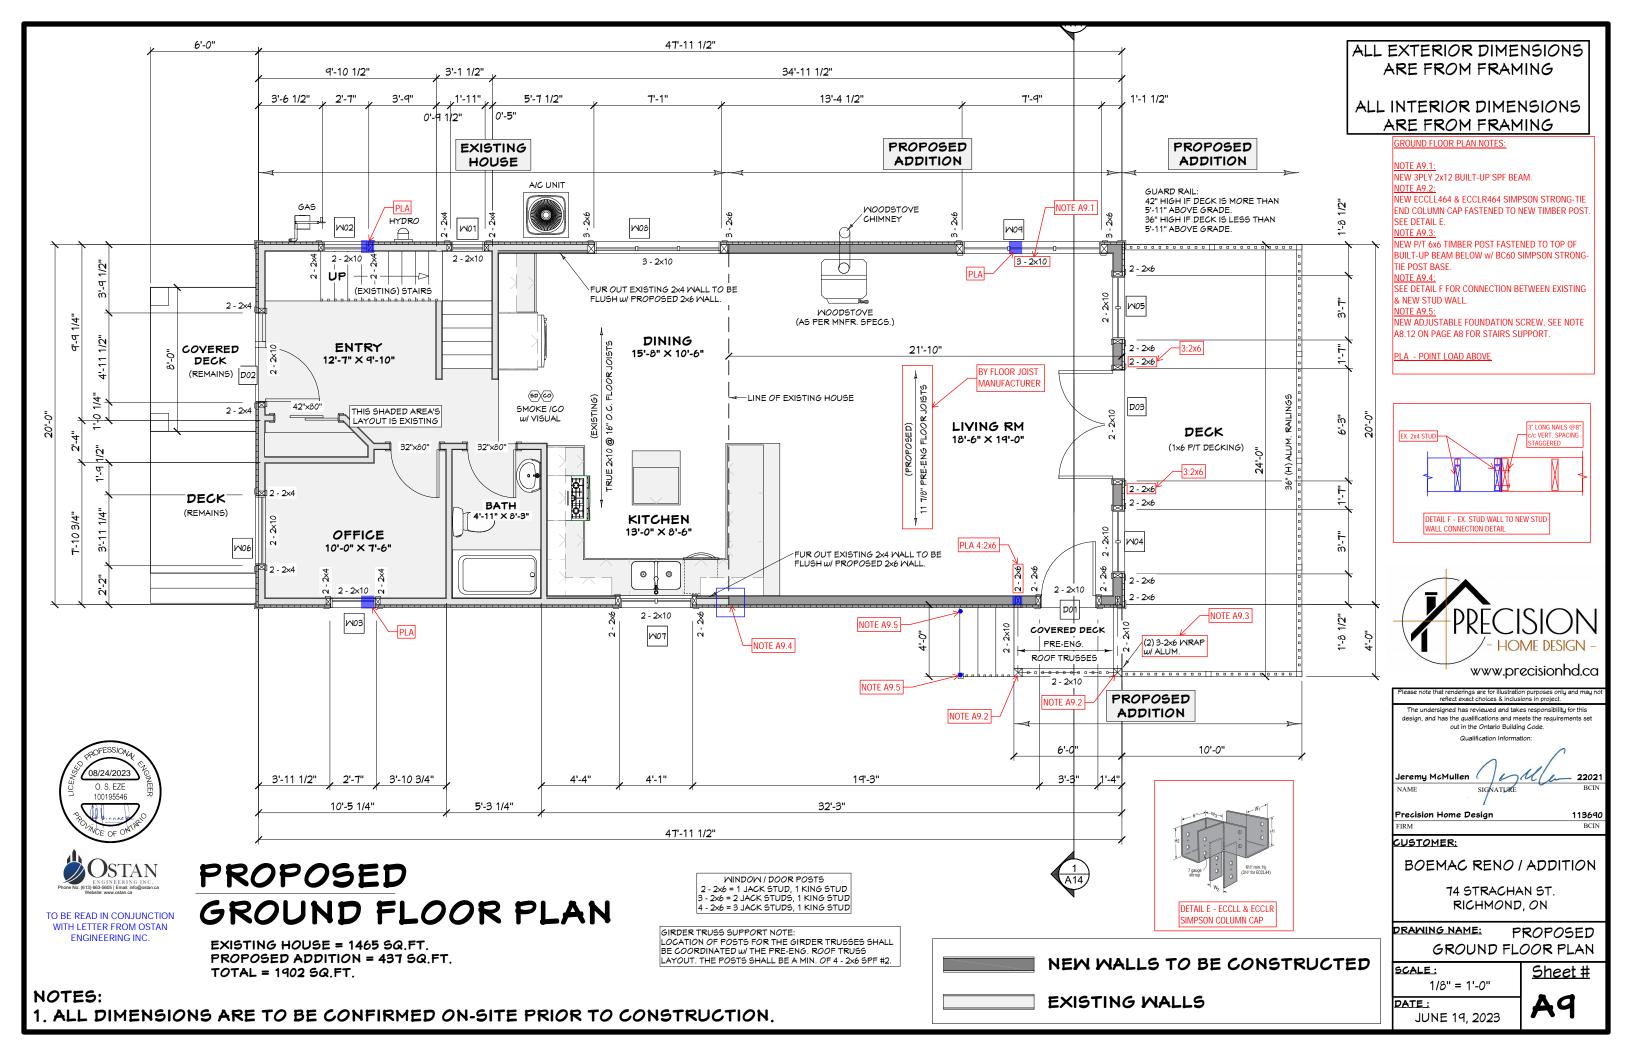
**DATE :**JUNE 19, 2023


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Sheet#

113690 BCIN







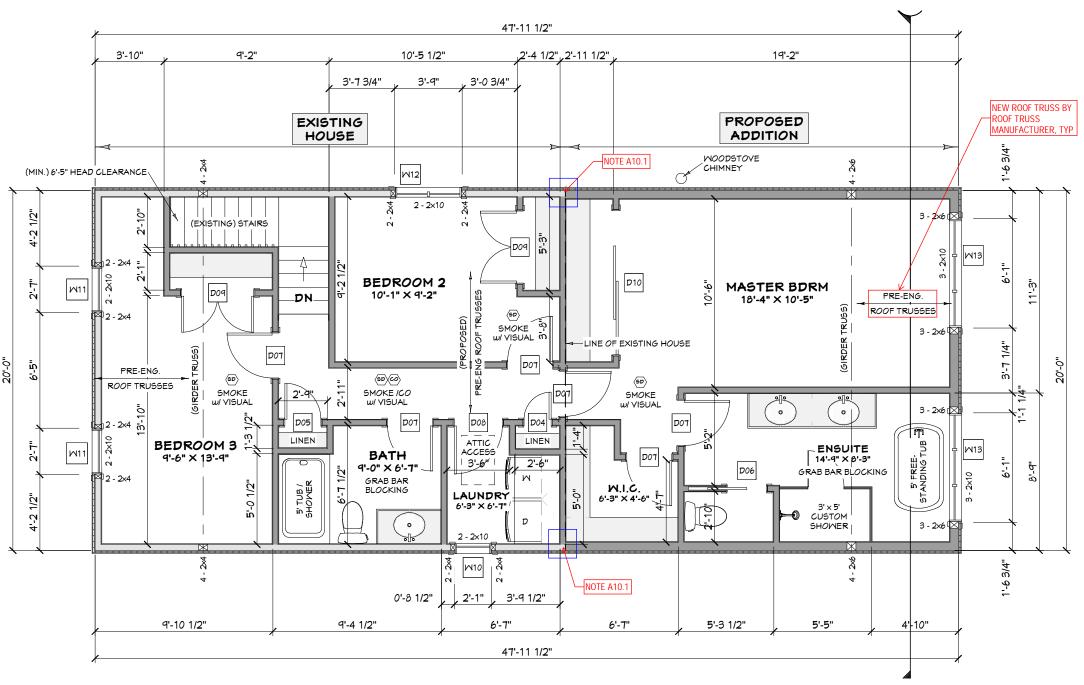



TO BE READ IN CONJUNCTION WITH LETTER FROM OSTAN ENGINEERING INC.

# PROPOSED SECOND FLOOR PLAN

EXISTING HOUSE = 1465 SQ.FT. PROPOSED ADDITION = 437 SQ.FT. TOTAL = 1902 SQ.FT.

WINDOW / DOOR POSTS 2 - 2x6 = 1 JACK STUD, 1 KING STUD - 2×6 = 2 JACK STUDS, 1 KING STUD 4 - 2x6 = 3 JACK STUDS, 1 KING STUD


GIRDER TRUSS SUPPORT NOTE: LOCATION OF POSTS FOR THE GIRDER TRUSSES SHALL BE COORDINATED W/ THE PRE-ENG. ROOF TRUSS LAYOUT. THE POSTS SHALL BE A MIN. OF 4 - 2×6 SPF #2.

> NEW WALLS TO BE CONSTRUCTED EXISTING WALLS

#### ALL EXTERIOR DIMENSIONS ARE FROM FRAMING

ALL INTERIOR DIMENSIONS ARE FROM FRAMING

SEE DETAIL G FOR CONNECTION BETWEEN EXISTING AND NEW STUD WALLS.

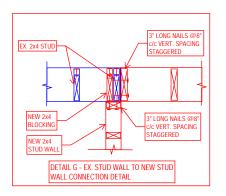





CUSTOMER:

**BOEMAC RENO / ADDITION** 

74 STRACHAN ST. RICHMOND, ON

DRAWING NAME: PROPOSED SECOND FLOOR PLAN

SCALE:


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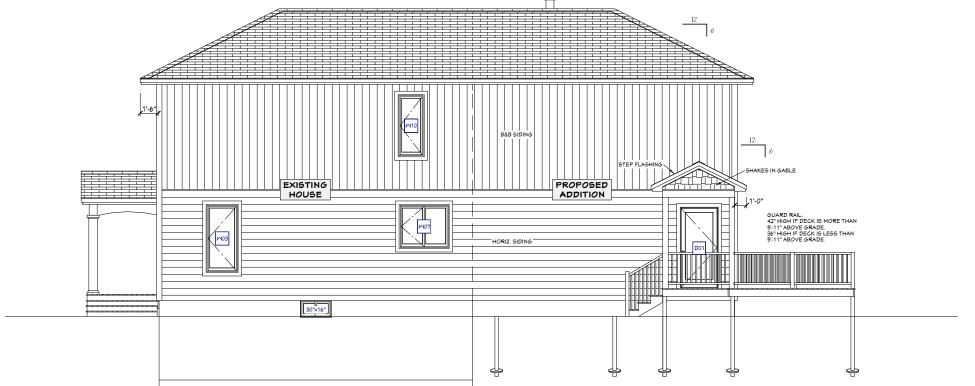
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NOTES:

ALL DIMENSIONS ARE TO BE CONFIRMED ON-SITE PRIOR TO CONSTRUCTION.

JUNE 19, 2023



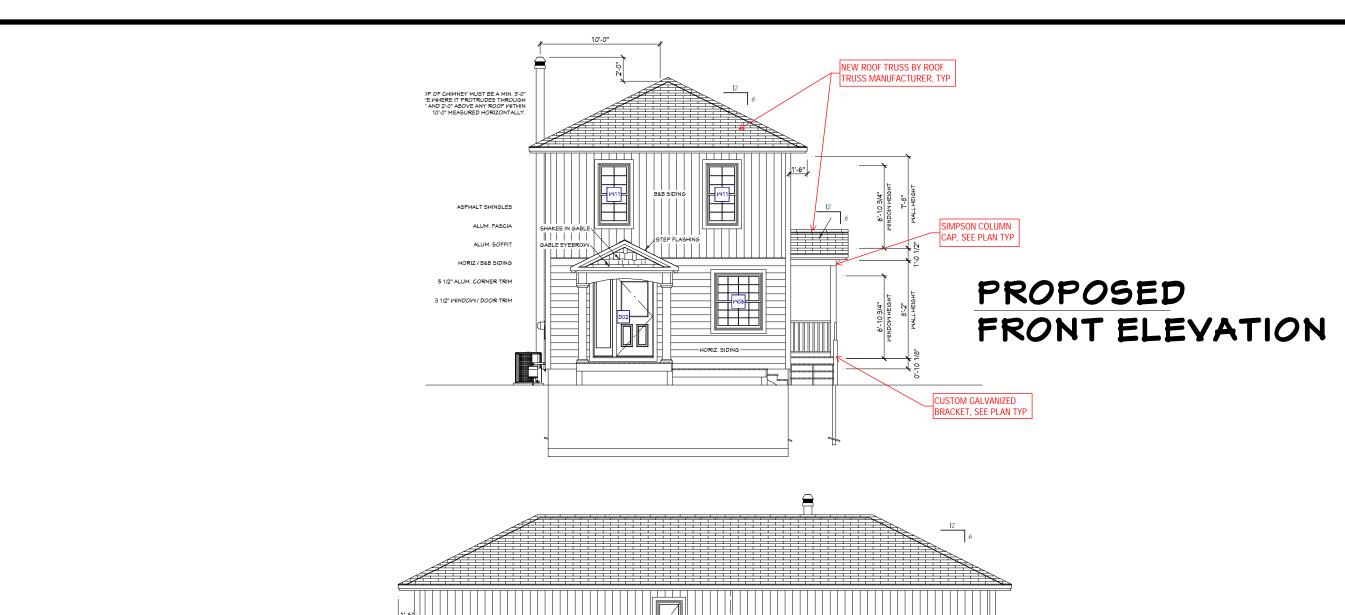

# PROPOSED RIGHT ELEVATION

NOTES:

1. ALL DIMENSIONS ARE TO BE CONFIRMED ON-SITE PRIOR TO CONSTRUCTION.



out in the Ontario Building Code.

113690 BCIN

Sheet #

Precision Home Design

CUSTOMER:


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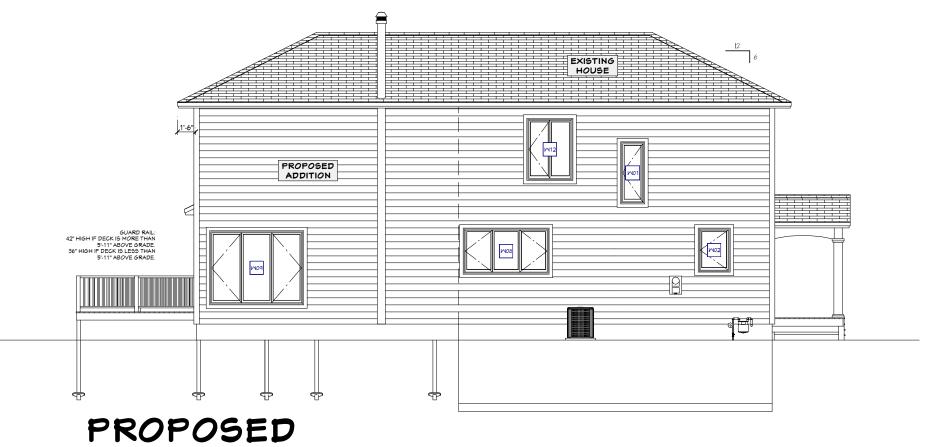
74 STRACHAN ST. RICHMOND, ON

DRAWING NAME:

PROPOSED ELEVATIONS

DATE: JUNE 19, 2023



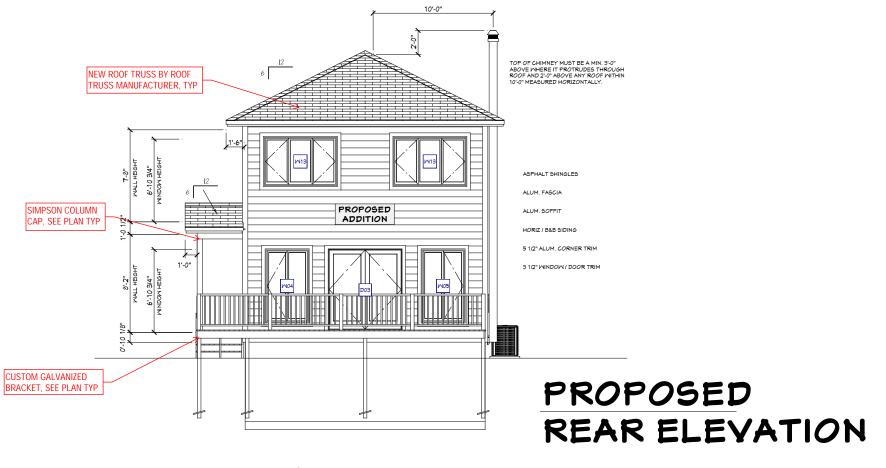



1. ALL DIMENSIONS ARE TO BE CONFIRMED ON-SITE PRIOR TO CONSTRUCTION.

LEFT ELEVATION



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The undersigned has reviewed and takes responsibility for this design, and has the qualifications and meets the requirements sout in the Ontario Building Code.

remy McMullen SIGNATURE BC

Precision Home Design

CUSTOMER:

**BOEMAC RENO / ADDITION** 

74 STRACHAN ST. RICHMOND, ON

DRAWING NAME:

PROPOSED ELEVATIONS

SCALE:

1/8" = 1'-0'


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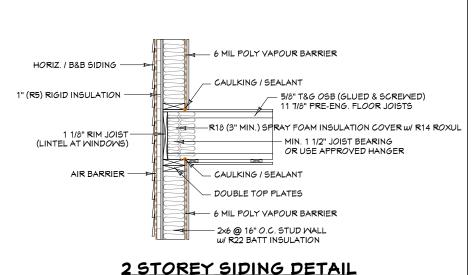
JUNE 19, 2023


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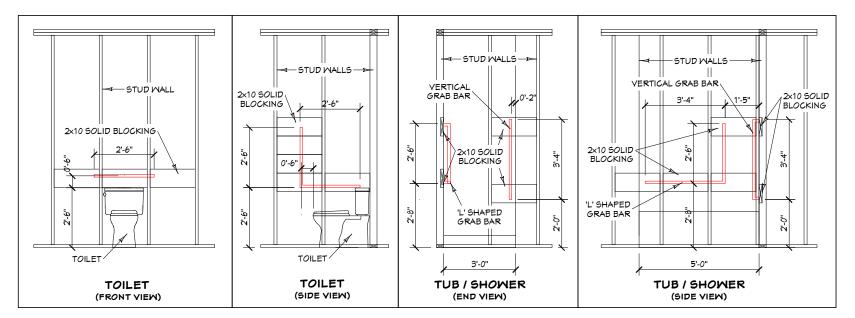
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113690 BCIN







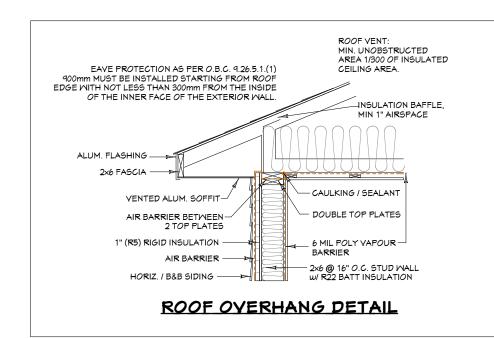

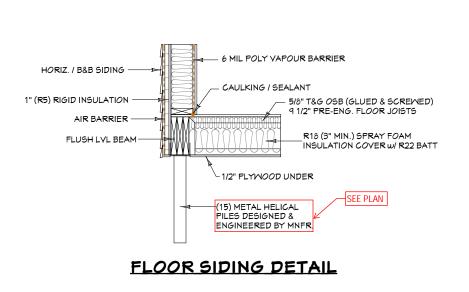TYPICAL GRAB BAR BLOCKING

(MIN DIA. OF GRAB BARS = 1 1/8")

#### NOTES:

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reflect exact choices & inclusions in project.

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Qualification Information:

NAME SIGNATURE

Precision Home Design 113640
FIRM BCIN

CUSTOMER:

BOEMAC RENO / ADDITION

74 STRACHAN ST. RICHMOND, ON

DRAWING NAME:

DETAILS

SCALE:

Sheet #

\_\_ 22021

DATE:

JUNE 19, 2023

