

PROPOSED COACH HOUSE FACADE

PROUD RESIDENCE

1342 CORKERY ROAD

PROPOSED COACH HOUSE FIT UP IN **EXISTING DET. GARAGE**

PERMIT SET

Committee of Adjustment Received | Reçu le

2024-04-22

City of Ottawa | Ville d'Ottawa Comité de dérogation



PROPOSED INTERIOR

SCOPE OF WORK

NEW INTERIOR FINISHES

NEW WOOD FRAMING NEW ENGINEERED FROST PROTECTION **NEW MILLWORK NEW WINDOWS & DOORS** PLUMBING & ELECTRICAL TO SUIT

DRAWING LEGEND

LABEL	TITLE
A1	SCOPE & LEGEND
A2	SITE PLAN
A3	DOOR SCHEDULE
A4	DOOR SCHEDULE (CONT'D)
A5	WINDOW SCHEDULE
A6	EXISTING FOUNDATION PLAN
A7	EXISTING GROUND FLOOR
A8	PROPOSED FOUNDATION PLAN
A9	PROPOSED GROUND FLOOR
A10	FRONT & REAR ELEVATIONS
A11	SIDE ELEVATIONS
A12	CROSS SECTION & DETAILS
A13	CONSTRUCTION ASSEMBLIES
A14	GENERAL NOTES



PROJECT TITLE: PROUD RESIDENCE 1342 CORKERY ROAD CARP, ONTARIO I BASSAM ELSARAJ REVIEW AND TAKE RESPOSIBILITIES FOR THE DESIGN WORK ON BEHALF OF A FIRM REGISTERED UNDER DIVISION C, PART 3, SUBSECTION 3.2.4 OF THE 2012 O.B.C. I AM QUALIFIED AND THE FIRM IS REGISTERED IN THE APPROPRIATE CLASSES/CATAGORIES.

DESIGNER BCIN: 37385 FIRM BCIN: 40889

SIGNATURE OF MEMBER:



SQURE FTG:	EXISTING	NEW
BSMNT/FDN:	ft²	ft²
GRND FLR:	1,233 ft ²	ft²
2ND FLOOR:	ft²	ft²
2ND FLOOR:	ft²	ft²

GENERAL NOTES:

- DO NOT SCALE DIMENISONS. READ DIMENSIONS
- GENERAL CONTRACTORS SHALL CONSTRUCT ALL WORK IN ACCORDANCE WITH THE 2012 ONTARIO BUILDING CODE, MUNICIPAL BYLAWS, AND ALL OTHER APPLICABLE BUILDING CODES.
- THE OWNER/BUILDER MAY NEED TO PROVIDE AN ENGINEER'S REPORT AT HIS/HER EXPENSE. CONSULT YOUR LOCAL BUILDING AUTHORITIES.
- PLEASE NOTIFY DESIGNER FOR ANY ERRORS AND/OR OMISSIONS PRIOR TO START OF WORK.
- TO THE BEST OF MY KNOWLEDGE THESE PLANS ARE DRAWN TO COMPLY WITH THE CLIENT'S SPECIFICATIONS AND ANY CHANGES MADE ON THEM AFTER SUBMISSION ARE MADE AT THE OWNER'S AND/ OR CONTRACTOR'S EXPENSE AND RESPONSIBILITY.

SCALE: AS SHOWN

DRAWING TITLE: **SCOPE & LEGEND**

DESCRIPTION

DATE: APRIL 6, 2024

ISSUED FOR PERMIT

NO.

REVISION TABLE

DATE

2024-02-28

PROJECT NUMBER: 2348

B.E.

DRAWN BY:





613-255-3425 | SERVICES@CLEARDRAFTING.COM

PROJECT TITLE:

PROUD RESIDENCE 1342 CORKERY ROAD CARP, ONTARIO I BASSAM ELSARAJ REVIEW AND TAKE RESPOSIBILITIES FOR THE DESIGN WORK ON BEHALF OF A FIRM REGISTERED UNDER DIVISION C, PART 3, SUBSECTION 3.2.4 OF THE 2012 O.B.C. I AM QUALIFIED AND THE FIRM IS REGISTERED IN THE APPROPRIATE CLASSES/CATAGORIES.

DESIGNER BCIN: 37385 FIRM BCIN: 40889

SIGNATURE OF MEMBER:



SQURE FTG:	EXISTING	NEW
BSMNT/FDN:	ft²	ft²
GRND FLR:	1,233 ft ²	ft²
2ND FLOOR:	ft²	ft²
2ND FLOOR:	ft²	ft²

- GENERAL CONTRACTORS SHALL CONSTRUCT ALL WORK IN ACCORDANCE WITH THE 2012 ONTARIO BUILDING CODE, MUNICIPAL BYLAWS, AND ALL OTHER APPLICABLE BUILDING CODES.
- THE OWNER/BUILDER MAY NEED TO PROVIDE AN ENGINEER'S REPORT AT HIS/HER EXPENSE. CONSULT YOUR LOCAL BUILDING AUTHORITIES.
- PLEASE NOTIFY DESIGNER FOR ANY ERRORS AND/OR OMISSIONS PRIOR TO START OF WORK.
- TO THE BEST OF MY KNOWLEDGE THESE PLANS ARE DRAWN TO COMPLY WITH THE CLIENT'S SPECIFICATIONS AND ANY CHANGES MADE ON THEM AFTER SUBMISSION ARE MADE AT THE OWNER'S AND/ OR CONTRACTOR'S EXPENSE

SCALE: AS SHOWN

REVISION TABLE

DATE

2024-02-28

2024-04-06

DESCRIPTION

ISSUED FOR PERMIT

SITE PLAN REVISIONS

NO.

1

2

2348

DRAWN BY: B.E.

SHEET:

AND RESPONSIBILITY. DATE: APRIL 6, 2024

NUMBER	QTY	FLOOR	WIDTH	HEIGHT	R/O	DESCRIPTION	ROOM NAME	3D EXTERIOR ELEVATION
D01	1	1	28"	80"	30"X82 1/2"	HINGED-DOOR P04	CLOSET/PRIMARY BEDROOM	
D02	1	1	28"	80"	30"X82 1/2"	HINGED-DOOR P04	HALL/BATH	
D03	1	1	28"	80"	57 1/4"X82 1/2"	POCKET-DOOR P04	ENSUITE/PRIMARY BEDROOM	
D04	1	1	32"	80"	34"X82 1/2"	HINGED-DOOR P04	HALL/LAUNDRY/UTILITY	
D05	1	1	72"	80"	74"X82 1/2"	DOUBLE BARN-DOOR P04	HALL/BEDROOM 2	
D06	1	1	72"	84"	74"X87"	EXT. SLIDER-GLASS PANEL	PRIMARY BEDROOM	
D07	1	1	30"	80"	32"X82 1/2"	HINGED-DOOR P04	HALL/PRIMARY BEDROOM	



211-1390 PRINCE OF WALES DRIVE OTTAWA, ONTARIO K2C 3N6 613-255-3425 | SERVICES@CLEARDRAFTING.COM

PROJECT TITLE:

PROUD RESIDENCE 1342 CORKERY ROAD CARP, ONTARIO I BASSAM ELSARAJ REVIEW AND TAKE RESPOSIBILITIES FOR THE DESIGN WORK ON BEHALF OF A FIRM REGISTERED UNDER DIVISION C, PART 3, SUBSECTION 3.2.4 OF THE 2012 O.B.C. I AM QUALIFIED AND THE FIRM IS REGISTERED IN THE APPROPRIATE CLASSES/CATAGORIES.

DESIGNER BCIN: 37385 FIRM BCIN: 40889

SIGNATURE OF MEMBER:



SQURE FTG:	EXISTING	NEW
BSMNT/FDN:	ft²	ft²
GRND FLR:	1,233 ft ²	ft²
2ND FLOOR:	ft²	ft²
2ND FLOOR:	ft²	ft²

GENERAL NOTES:

31"X82 1/2"

• DO NOT SCALE DIMENISONS. READ DIMENSIONS

HINGED-DOOR P04

- GENERAL CONTRACTORS SHALL CONSTRUCT ALL WORK IN ACCORDANCE WITH THE 2012 ONTARIO BUILDING CODE, MUNICIPAL BYLAWS,
- AND ALL OTHER APPLICABLE BUILDING CODES.

 THE OWNER/BUILDER MAY NEED TO PROVIDE AN ENGINEER'S REPORT AT HIS/HER EXPENSE. CONSULT YOUR LOCAL BUILDING AUTHORITIES.
- PLEASE NOTIFY DESIGNER FOR ANY ERRORS
- AND/OR OMISSIONS PRIOR TO START OF WORK. • TO THE BEST OF MY KNOWLEDGE THESE PLANS ARE DRAWN TO COMPLY WITH THE CLIENT'S SPECIFICATIONS AND ANY CHANGES MADE ON THEM AFTER SUBMISSION ARE MADE AT THE OWNER'S AND/ OR CONTRACTOR'S EXPENSE AND RESPONSIBILITY.

SCALE: AS SHOWN

DRAWING TITLE:

DESCRIPTION

DATE: APRIL 6, 2024

ISSUED FOR PERMIT

NO.

PANTRY/ENTRY

DOOR SCHEDULE

REVISION TABLE

PROJECT NUMBER: 2348

DRAWN BY: B.E.

SHEET:

DATE

2024-02-28

DOOR SCHEDULE (CONT'D) NUMBER QTY FLOOR WIDTH HEIGHT R/O DESCRIPTION ROOM NAME 3D EXTERIOR ELEVATION DO9 1 1 1 49" 80" 51"X82 1/2" SLIDER-DOOR P04 CLOSET/ENTRY



211-1390 PRINCE OF WALES DRIVE OTTAWA, ONTARIO K2C 3N6

613-255-3425 | SERVICES@CLEARDRAFTING.COM

PROJECT TITLE:

PROUD RESIDENCE

1342 CORKERY ROAD CARP, ONTARIO

I BASSAM ELSARAJ REVIEW AND TAKE RESPOSIBILITIES FOR THE DESIGN WORK ON BEHALF OF A FIRM REGISTERED UNDER DIVISION C, PART 3, SUBSECTION 3,24 OF THE 2012 O.B.C. I AM QUALIFIED AND THE FIRM IS REGISTERED IN THE APPROPRIATE CLASSES/CATAGORIES.

DESIGNER BCIN: 37385 FIRM BCIN: 40889

SIGNATURE OF MEMBER:



SQURE FTG:	EXISTING	NEW
BSMNT/FDN:	ft²	ft²
GRND FLR:	1,233 ft ²	ft²
2ND FLOOR:	ft²	ft²
2ND FLOOR:	ft²	ft²

GENERAL NOTES:

- DO NOT SCALE DIMENISONS. READ DIMENSIONS
- GENERAL CONTRACTORS SHALL CONSTRUCT ALL WORK IN ACCORDANCE WITH THE 2012 ONTARIO BUILDING CODE, MUNICIPAL BYLAWS,

 AND ALL OF HER ADMISSIAN ENVIRONMENT OF THE CODE.

 AND ALL OF HER ADMISSIAN ENVIRONMENT OF THE CODE.

 AND ALL OF HER ADMISSIANCE OF THE CODE.

 AND ALL OF THE CODE
- AND ALL OTHER APPLICABLE BUILDING CODES.

 THE OWNER/BUILDER MAY NEED TO PROVIDE AN ENGINEER'S REPORT AT HIS/HER EXPENSE.
- CONSULT YOUR LOCAL BUILDING AUTHORITIES.

 PLEASE NOTIFY DESIGNER FOR ANY ERRORS
- AND/OR OMISSIONS PRIOR TO START OF WORK.

 TO THE BEST OF MY KNOWLEDGE THESE PLANS
 ARE DRAWN TO COMPLY WITH THE CLIENT'S
 SPECIFICATIONS AND ANY CHANGES MADE ON
 THEM AFTER SUBMISSION ARE MADE AT THE
 OWNER'S AND/ OR CONTRACTOR'S EXPENSE
 AND RESPONSIBILITY.

SCALE: AS SHOWN

DRAWING TITLE:

DATE: APRIL 6, 2024

DOOR SCHEDULE (CONT'D)

REVISION TABLE

NO. DESCRIPTION DATE

1 ISSUED FOR PERMIT 2024-02-28

PROJECT NUMBER: 2348

DRAWN BY: B.E.

SHEET:

Δ4

WINDOW SCHEDULE

	NUMBER	QTY	FLOOR	WIDTH	HEIGHT	R/O	ARCH	DESCRIPTION	ROOM NAME	3D EXTERIOR ELEVATION
	W01	1	1	18"	48"	19"X49"		SINGLE CASEMENT-HL	ENSUITE	
	W02	1	1	42"	40"	43"X41"		DOUBLE CASEMENT-RHL	KITCHEN/DECK	
	W03	1	1	72"	18"	73"X19"		SINGLE AWNING	PRIMARY BEDROOM	
	W04	1	1	72"	60"	73"X61"		TRIPLE CASEMENT-CHL/RHL	BEDROOM 2	
	W05	1	1	72"	60"	73"X61"		TRIPLE CASEMENT-CHL/RHL	LIVING/DINING	
	W06	1	1	96"	60"	97"X61"		TRIPLE CASEMENT-CHL/RHL	LIVING/DINING	



211-1390 PRINCE OF WALES DRIVE OTTAWA, ONTARIO K2C 3N6

613-255-3425 | SERVICES@CLEARDRAFTING.COM

PROJECT TITLE:

PROUD RESIDENCE 1342 CORKERY ROAD CARP, ONTARIO I BASSAM ELSARAJ REVIEW AND TAKE RESPOSIBILITIES FOR THE DESIGN WORK ON BEHALF OF A FIRM REGISTERED UNDER DIVISION C, PART 3, SUBSECTION 3.2.4 OF THE 2012 O.B.C. I AM QUALIFIED AND THE FIRM IS REGISTERED IN THE APPROPRIATE CLASSES/CATAGORIES.

DESIGNER BCIN: 37385 FIRM BCIN: 40889

SIGNATURE OF MEMBER:



SQURE FTG:	EXISTING	NEW
BSMNT/FDN:	ft²	ft²
GRND FLR:	1,233 ft ²	ft²
2ND FLOOR:	ft²	ft²
2ND FLOOR:	ft²	ft²

GENERAL NOTES:

- DO NOT SCALE DIMENISONS. READ DIMENSIONS
- GENERAL CONTRACTORS SHALL CONSTRUCT ALL WORK IN ACCORDANCE WITH THE 2012 ONTARIO BUILDING CODE, MUNICIPAL BYLAWS, AND ALL OTHER APPLICABLE BUILDING CODES. • THE OWNER/BUILDER MAY NEED TO PROVIDE
- AN ENGINEER'S REPORT AT HIS/HER EXPENSE. CONSULT YOUR LOCAL BUILDING AUTHORITIES.
- PLEASE NOTIFY DESIGNER FOR ANY ERRORS

DRAWING TITLE:

DESCRIPTION

ISSUED FOR PERMIT

WINDOW SCHEDULE

REVISION TABLE

DATE

2024-02-28

PROJECT NUMBER: 2348

DRAWN BY:


B.E.

SHEET:

TO THE BEST OF MY KNOWLEDGE THESE PLANS ARE DRAWN TO COMPLY WITH THE CLIENT'S SPECIFICATIONS AND ANY CHANGES MADE ON THEM AFTER SUBMISSION ARE MADE AT THE OWNER'S AND/ OR CONTRACTOR'S EXPENSE AND RESPONSIBILITY.	
SCALE: AS SHOWN	DATE: APRIL 6, 2024

NO.

1

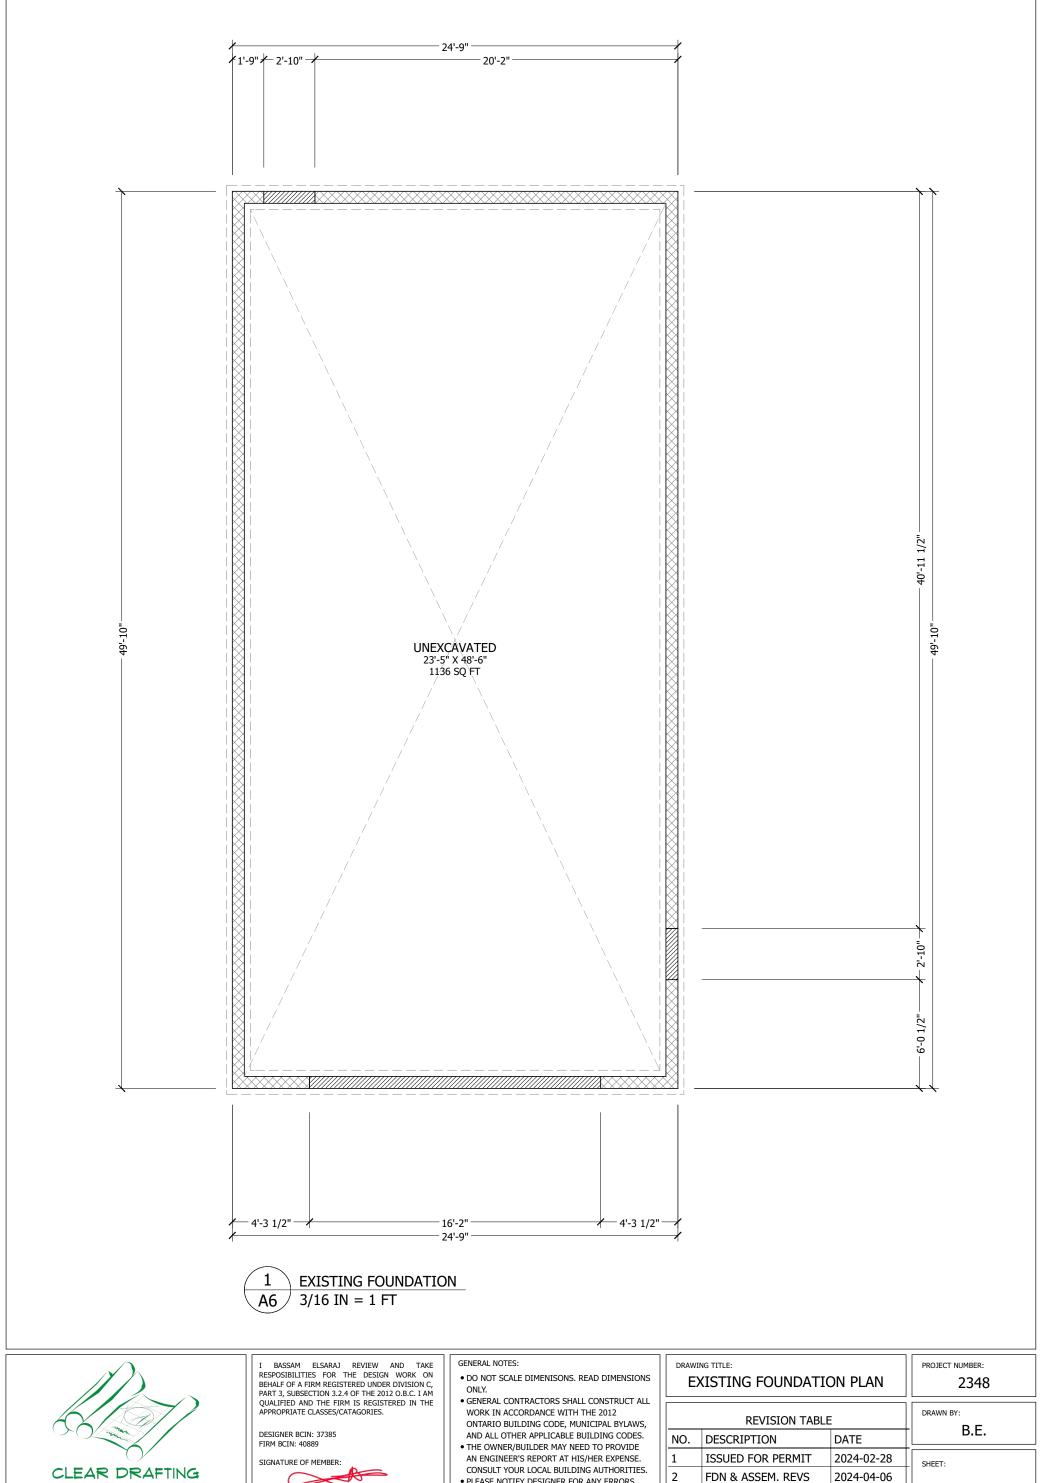



PROUD RESIDENCE 1342 CORKERY ROAD CARP, ONTARIO

PROJECT TITLE:




SQURE FTG:	EXISTING	NEW
BSMNT/FDN:	ft ²	ft²
GRND FLR:	1,233 ft ²	ft²
2ND FLOOR:	ft ²	ft²
2ND FLOOR:	ft²	ft²

- PLEASE NOTIFY DESIGNER FOR ANY ERRORS
- AND/OR OMISSIONS PRIOR TO START OF WORK. • TO THE BEST OF MY KNOWLEDGE THESE PLANS ARE DRAWN TO COMPLY WITH THE CLIENT'S SPECIFICATIONS AND ANY CHANGES MADE ON THEM AFTER SUBMISSION ARE MADE AT THE OWNER'S AND/ OR CONTRACTOR'S EXPENSE AND RESPONSIBILITY.

SCALE: AS SHOWN

DATE: APRIL 6, 2024

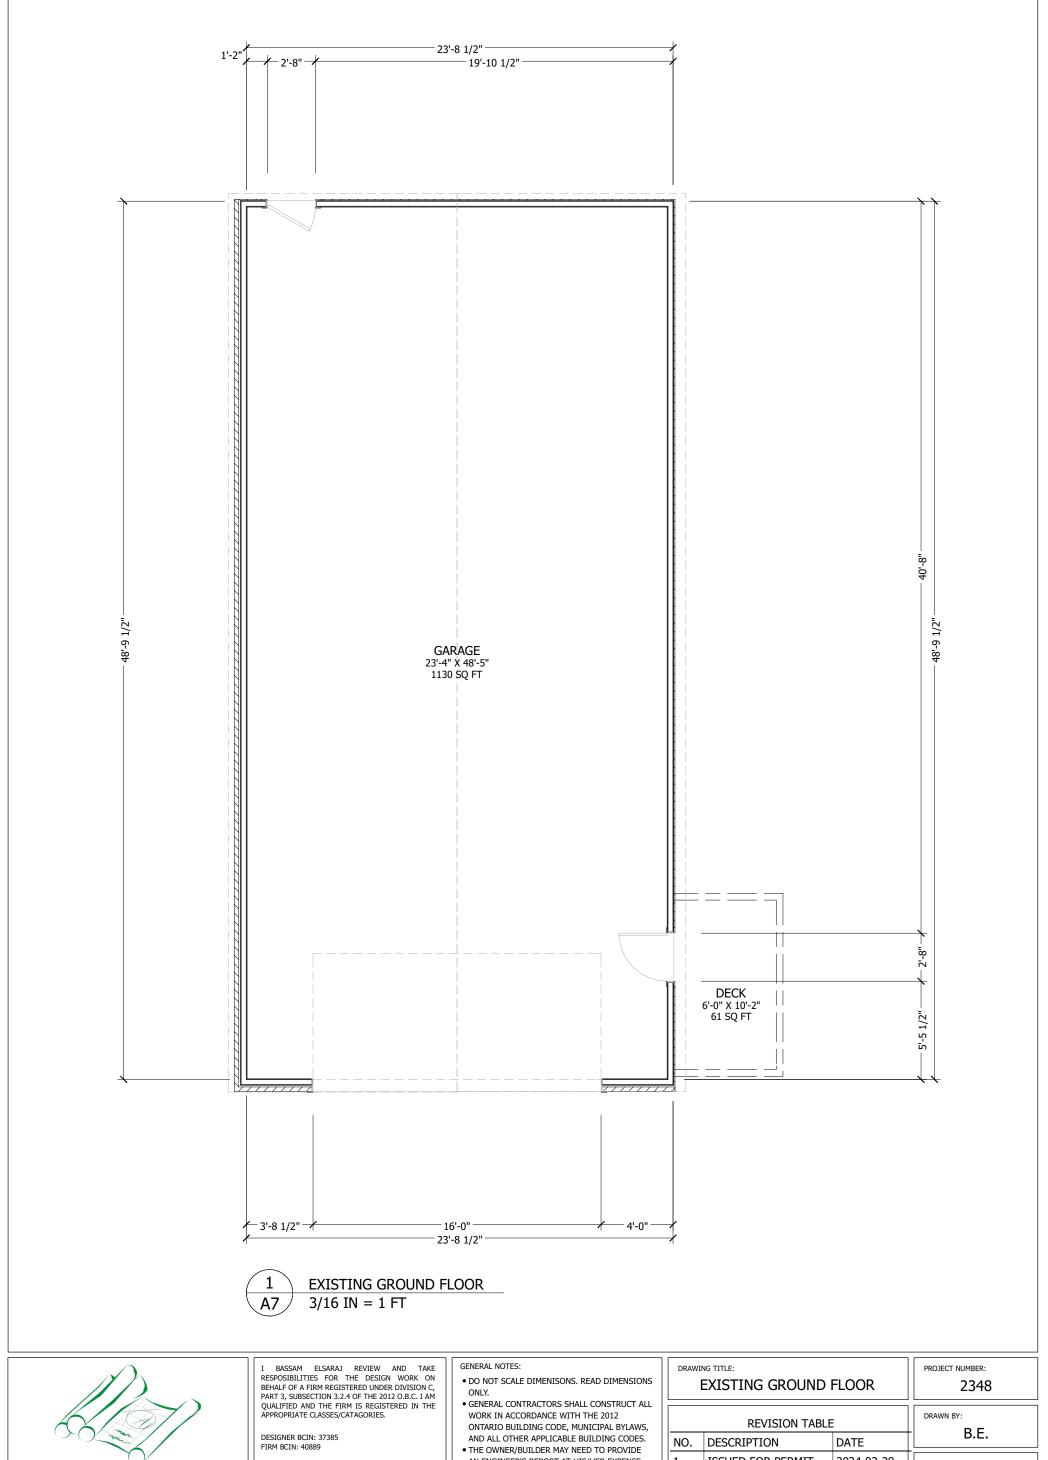




PROJECT TITLE:

PROUD RESIDENCE

SIGNATURE OF MEMBER:

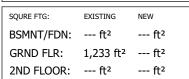

- AN ENGINEER'S REPORT AT HIS/HER EXPENSE. CONSULT YOUR LOCAL BUILDING AUTHORITIES.
- PLEASE NOTIFY DESIGNER FOR ANY ERRORS AND/OR OMISSIONS PRIOR TO START OF WORK.
- \bullet TO THE BEST OF MY KNOWLEDGE THESE PLANS ARE DRAWN TO COMPLY WITH THE CLIENT'S SPECIFICATIONS AND ANY CHANGES MADE ON THEM AFTER SUBMISSION ARE MADE AT THE OWNER'S AND/ OR CONTRACTOR'S EXPENSE AND RESPONSIBILITY.


SCALE: AS SHOWN

ISSUED FOR PERMIT 1 2024-02-28 2 2024-04-06 FDN & ASSEM. REVS

DATE: APRIL 6, 2024

SHEET:

2ND FLOOR: --- ft² --- ft² 1342 CORKERY ROAD CARP, ONTARIO

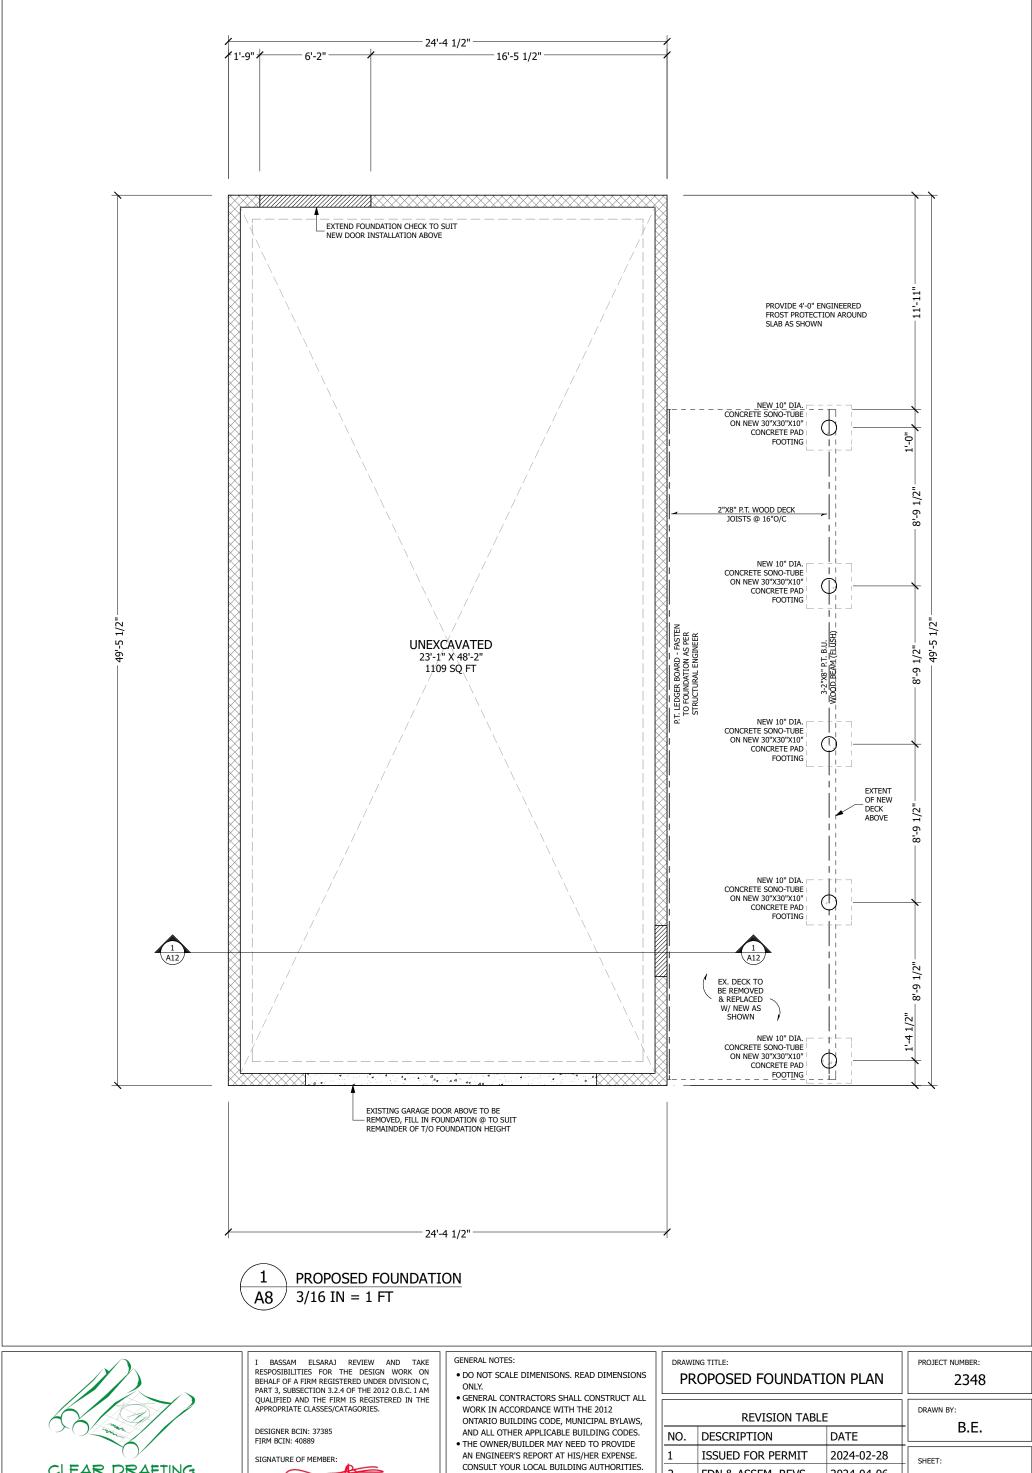




613-255-3425 | SERVICES@CLEARDRAFTING.COM

PROJECT TITLE:

PROUD RESIDENCE 1342 CORKERY ROAD CARP, ONTARIO

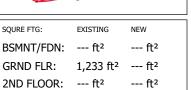

--- ft²


2ND FLOOR: --- ft²

- PLEASE NOTIFY DESIGNER FOR ANY ERRORS AND/OR OMISSIONS PRIOR TO START OF WORK.
- TO THE BEST OF MY KNOWLEDGE THESE PLANS ARE DRAWN TO COMPLY WITH THE CLIENT'S SPECIFICATIONS AND ANY CHANGES MADE ON THEM AFTER SUBMISSION ARE MADE AT THE OWNER'S AND/ OR CONTRACTOR'S EXPENSE AND RESPONSIBILITY.

SCALE: AS SHOWN

NO.	DESCRIPTION	DATE
1	ISSUED FOR PERMIT	2024-02-28
2	FDN & ASSEM. REVS	2024-04-06

DATE: APRIL 6, 2024

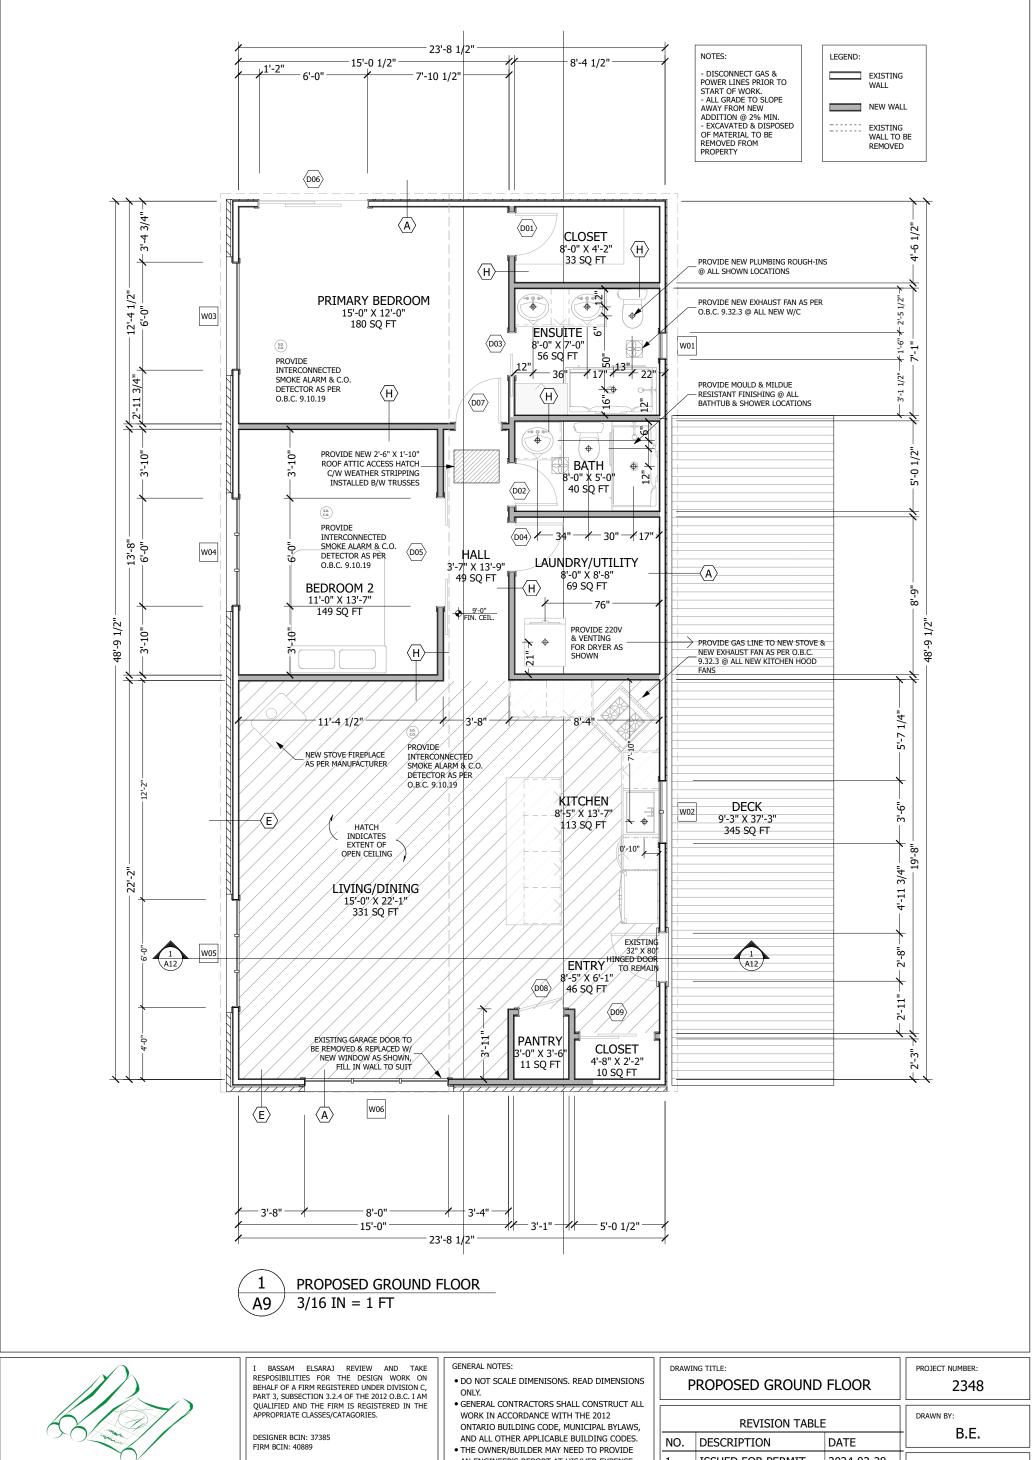



PROJECT TITLE: PROUD RESIDENCE 1342 CORKERY ROAD CARP, ONTARIO SIGNATURE OF MEMBER:

2ND FLOOR: --- ft2

BSMNT/FDN: --- ft² --- ft² GRND FLR: 1,233 ft² --- ft² 2ND FLOOR: --- ft² --- ft²

--- ft²


- AN ENGINEER'S REPORT AT HIS/HER EXPENSE.
- CONSULT YOUR LOCAL BUILDING AUTHORITIES. • PLEASE NOTIFY DESIGNER FOR ANY ERRORS
- AND/OR OMISSIONS PRIOR TO START OF WORK. • TO THE BEST OF MY KNOWLEDGE THESE PLANS ARE DRAWN TO COMPLY WITH THE CLIENT'S SPECIFICATIONS AND ANY CHANGES MADE ON THEM AFTER SUBMISSION ARE MADE AT THE OWNER'S AND/ OR CONTRACTOR'S EXPENSE AND RESPONSIBILITY.


SCALE: AS SHOWN

ISSUED FOR PERMIT 1 2024-02-28 2024-04-06 2 FDN & ASSEM. REVS

DATE: APRIL 6, 2024

SHEET:

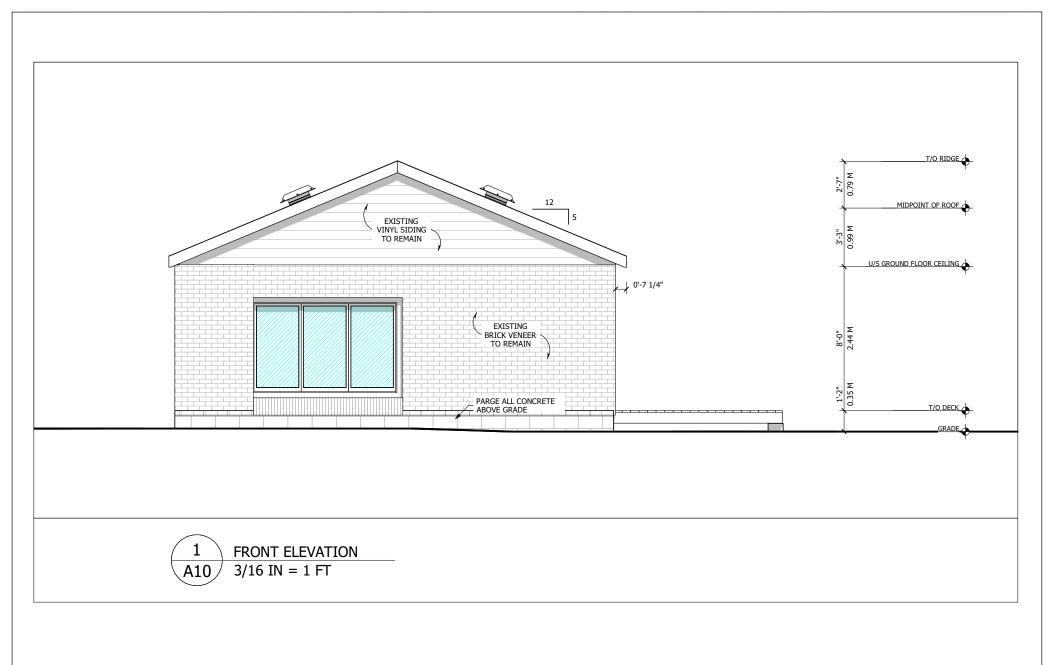

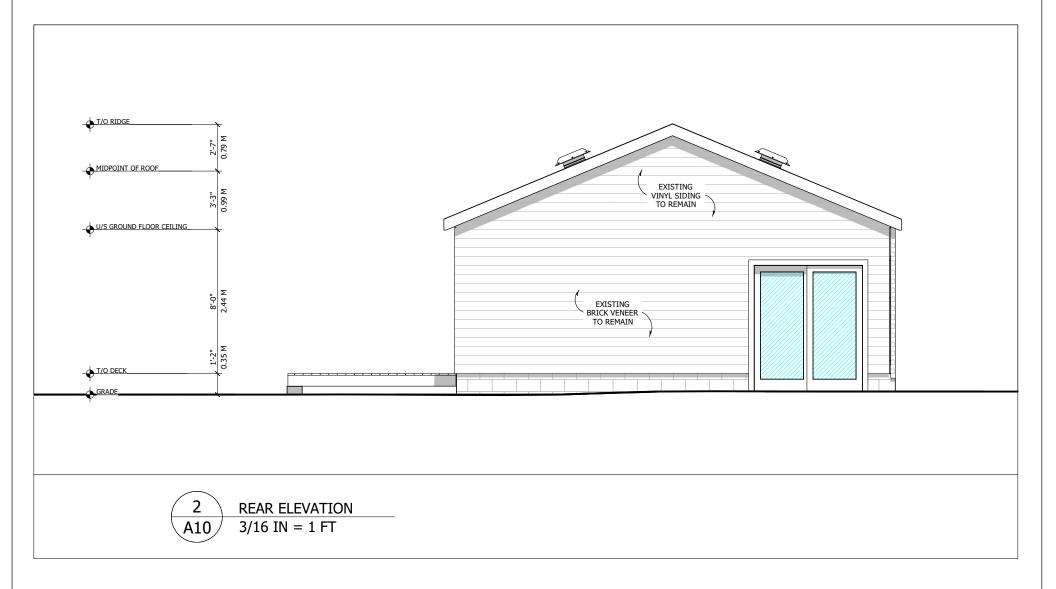



PROJECT TITLE:

PROUD RESIDENCE 1342 CORKERY ROAD CARP, ONTARIO I BASSAM ELSARAJ REVIEW AND TAKE RESPOSIBILITIES FOR THE DESIGN WORK ON BEHALF OF A FIRM REGISTERED UNDER DIVISION C, PART 3, SUBSECTION 3.2 4 OF THE 2012 O.B.C. I AM QUALIFIED AND THE FIRM IS REGISTERED IN THE APPROPRIATE CLASSES/CATAGORIES.

DESIGNER BCIN: 37385 FIRM BCIN: 40889

SIGNATURE OF MEMBER:



SQURE FTG:	EXISTING	NEW
BSMNT/FDN:	ft²	ft²
GRND FLR:	1,233 ft ²	ft²
2ND FLOOR:	ft²	ft²
2ND FLOOR:	ft²	ft²

GENERAL NOTES:

- DO NOT SCALE DIMENISONS. READ DIMENSIONS ONLY.
- GENERAL CONTRACTORS SHALL CONSTRUCT ALL WORK IN ACCORDANCE WITH THE 2012 ONTARIO BUILDING CODE, MUNICIPAL BYLAWS,
- AND ALL OTHER APPLICABLE BUILDING CODES. • THE OWNER/BUILDER MAY NEED TO PROVIDE AN ENGINEER'S REPORT AT HIS/HER EXPENSE.
- CONSULT YOUR LOCAL BUILDING AUTHORITIES. • PLEASE NOTIFY DESIGNER FOR ANY ERRORS
- AND/OR OMISSIONS PRIOR TO START OF WORK. • TO THE BEST OF MY KNOWLEDGE THESE PLANS ARE DRAWN TO COMPLY WITH THE CLIENT'S SPECIFICATIONS AND ANY CHANGES MADE ON THEM AFTER SUBMISSION ARE MADE AT THE OWNER'S AND/ OR CONTRACTOR'S EXPENSE

SCALE: AS SHOWN

DRAWING TITLE:

DESCRIPTION

ISSUED FOR PERMIT

FDN & ASSEM. REVS

NO.

1

FRONT & REAR ELEVATIONS

REVISION TABLE

DATE

2024-02-28


2024-04-06


PROJECT NUMBER: 2348

DRAWN BY: B.E.

SHEET:

AND RESPONSIBILITY. DATE: APRIL 6, 2024

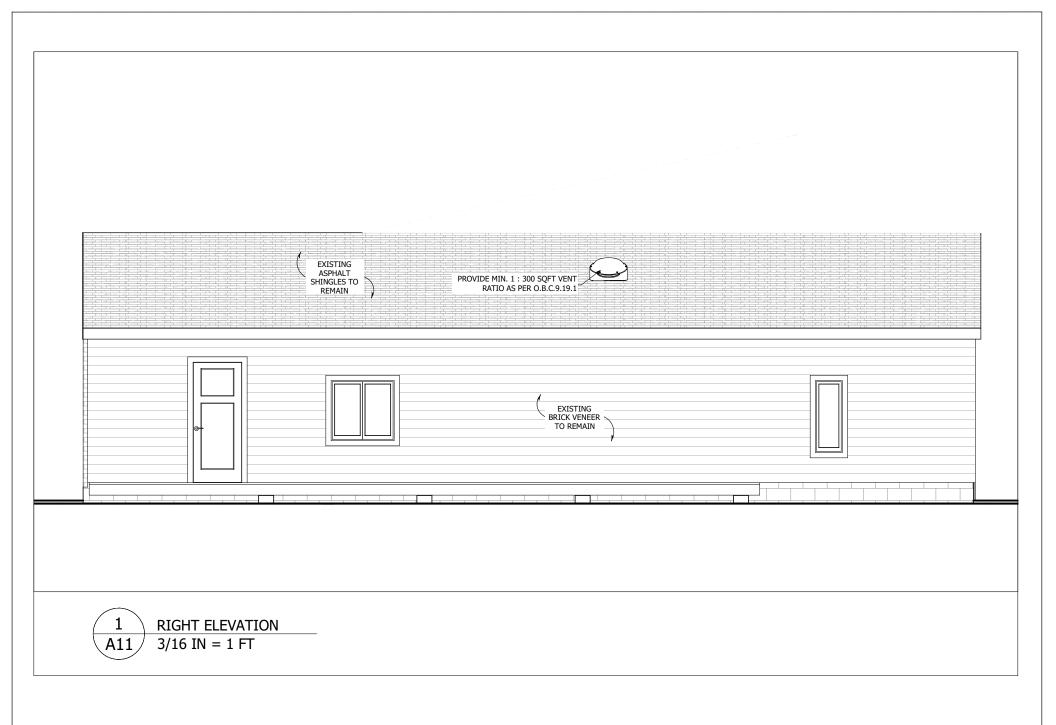

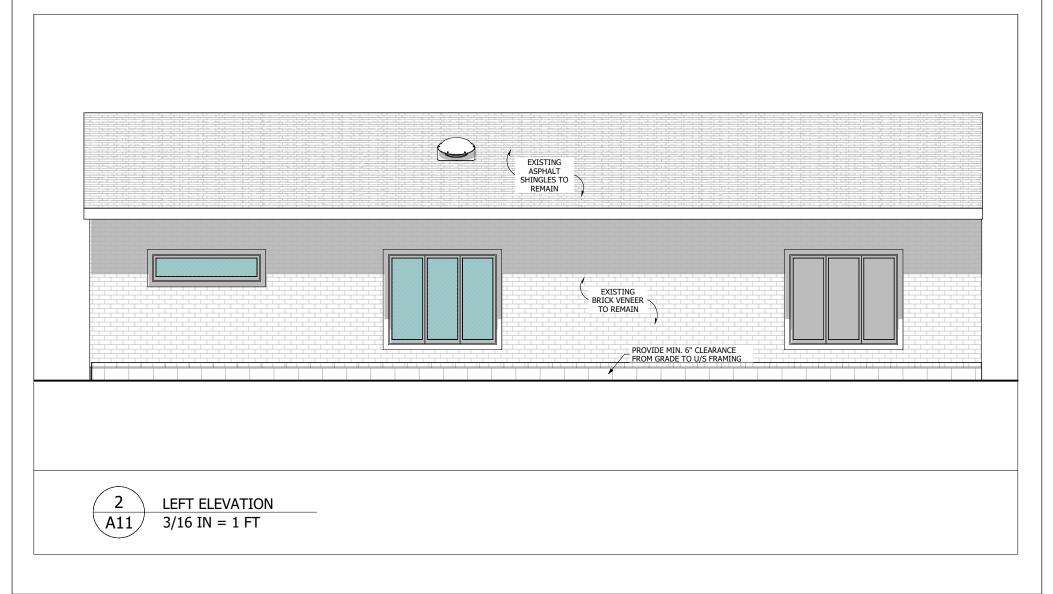



PROJECT TITLE:

PROUD RESIDENCE

1342 CORKERY ROAD CARP, ONTARIO I BASSAM ELSARAJ REVIEW AND TAKE RESPOSIBILITIES FOR THE DESIGN WORK ON BEHALF OF A FIRM REGISTERED UNDER DIVISION C, PART 3, SUBSECTION 3.2.4 OF THE 2012 O.B.C. I AM QUALIFIED AND THE FIRM IS REGISTERED IN THE APPROPRIATE CLASSES/CATAGORIES.

DESIGNER BCIN: 37385 FIRM BCIN: 40889

SIGNATURE OF MEMBER:



SQURE FTG:	EXISTING	NEW
BSMNT/FDN:	ft²	ft²
GRND FLR:	1,233 ft ²	ft²
2ND FLOOR:	ft²	ft²
2ND FLOOR:	ft²	ft²

GENERAL NOTES:

- DO NOT SCALE DIMENISONS. READ DIMENSIONS
- ONLY. • GENERAL CONTRACTORS SHALL CONSTRUCT ALL WORK IN ACCORDANCE WITH THE 2012 ONTARIO BUILDING CODE, MUNICIPAL BYLAWS,
- AND ALL OTHER APPLICABLE BUILDING CODES. • THE OWNER/BUILDER MAY NEED TO PROVIDE AN ENGINEER'S REPORT AT HIS/HER EXPENSE.
- CONSULT YOUR LOCAL BUILDING AUTHORITIES. • PLEASE NOTIFY DESIGNER FOR ANY ERRORS
- AND/OR OMISSIONS PRIOR TO START OF WORK. \bullet TO THE BEST OF MY KNOWLEDGE THESE PLANS

ARE DRAWN TO COMPLY WITH THE CLIENT'S SPECIFICATIONS AND ANY CHANGES MADE ON THEM AFTER SUBMISSION ARE MADE AT THE OWNER'S AND/ OR CONTRACTOR'S EXPENSE AND RESPONSIBILITY.

SCALE: AS SHOWN

DRAWING TITLE:

SIDE ELEVATIONS


REVISION TABLE DESCRIPTION DATE NO. ISSUED FOR PERMIT 2024-02-28 1 2024-04-06 FDN & ASSEM. REVS

PROJECT NUMBER: 2348

DRAWN BY: B.E.

SHEET:

DATE: APRIL 6, 2024

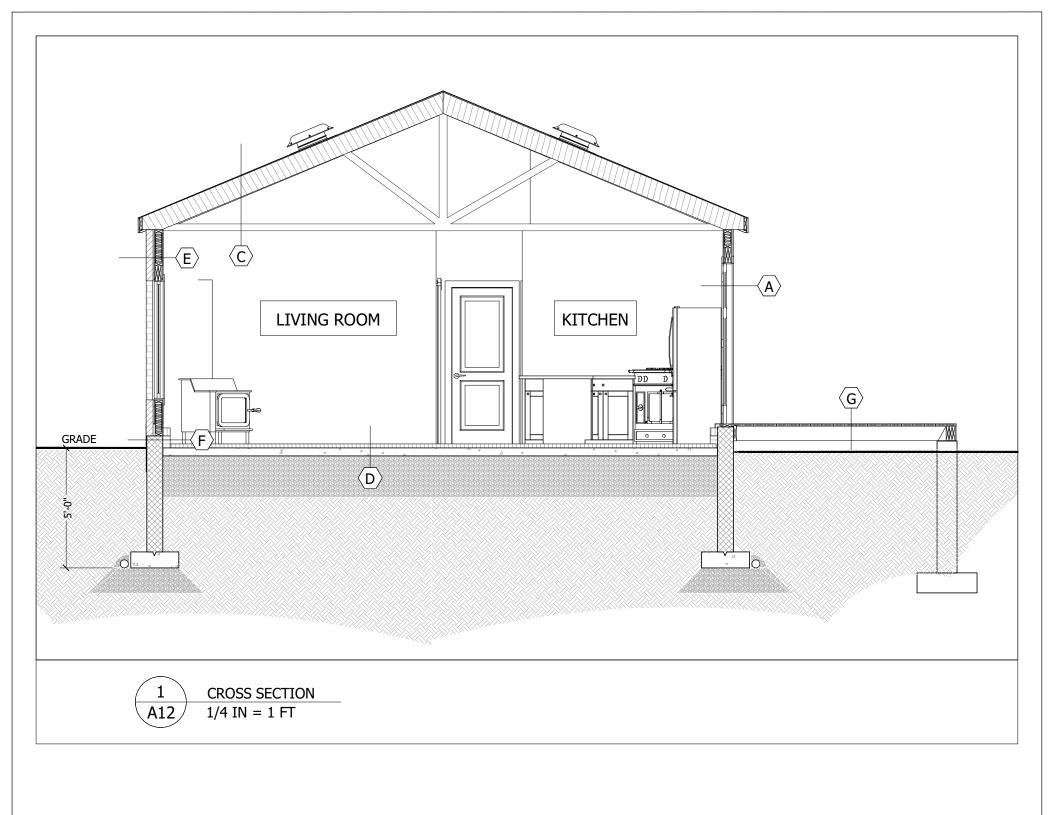



211-1390 PRINCE OF WALES DRIVE OTTAWA, ONTARIO K2C 3N6

613-255-3425 | SERVICES@CLEARDRAFTING.COM

PROJECT TITLE:

PROUD RESIDENCE 1342 CORKERY ROAD CARP, ONTARIO I BASSAM ELSARAJ REVIEW AND TAKE RESPOSIBILITIES FOR THE DESIGN WORK ON BEHALF OF A FIRM REGISTERED UNDER DIVISION C, PART 3, SUBSECTION 3, 2, 4 OF THE 2012 O.B.C. I AM QUALIFIED AND THE FIRM IS REGISTERED IN THE APPROPRIATE CLASSES/CATAGORIES.

DESIGNER BCIN: 37385 FIRM BCIN: 40889

SIGNATURE OF MEMBER:



SQURE FTG:	EXISTING	NEW	
BSMNT/FDN:	ft²	ft²	
GRND FLR:	1,233 ft ²	ft²	
2ND FLOOR:	ft²	ft²	
2ND FLOOR:	ft²	ft2	

GENERAL NOTES:

- DO NOT SCALE DIMENISONS. READ DIMENSIONS ONLY.
- GENERAL CONTRACTORS SHALL CONSTRUCT ALL WORK IN ACCORDANCE WITH THE 2012
- ONTARIO BUILDING CODE, MUNICIPAL BYLAWS, AND ALL OTHER APPLICABLE BUILDING CODES. THE OWNER/BUILDER MAY NEED TO PROVIDE AN ENGINEER'S REPORT AT HIS/HER EXPENSE.
- CONSULT YOUR L • PLEASE NOTIFY I
- AND/OR OMISSIO • TO THE BEST OF ARE DRAWN TO C SPECIFICATIONS THEM AFTER SUB OWNER'S AND/ C AND RESPONSIBI

SCALE: AS SH

DRAWING TITLE:

DESCRIPTION

NO.

CROSS SECTION & DETAILS

REVISION TABLE

DATE

PROJECT NUMBER: 2348

DRAWN BY:

B.E.

REPORT AT HIS/HER EXPENSE.	1	ISSUED FOR PERMIT	2024-02-28	
LOCAL BUILDING AUTHORITIES. DESIGNER FOR ANY ERRORS	2	FDN & ASSEM. REVS	2024-04-06] `
IONS PRIOR TO START OF WORK. F MY KNOWLEDGE THESE PLANS				
COMPLY WITH THE CLIENT'S				
S AND ANY CHANGES MADE ON JBMISSION ARE MADE AT THE				
OR CONTRACTOR'S EXPENSE				
SILITY.				
HOWN	DATE	E: APRIL 6, 2024		

CONSTRUCTION ASSEMBLIES

$\langle \mathsf{A} \rangle$

EXISTING EXTERIOR WALL ASSEMBLY @ VINYL SIDING

- EXISTING VINYL SIDING AS PER MANUFACTURER
- SBPOF WEATHER BARRIER, ALL JOINTS SEALED W/ TAPE
- EXISTING 7/16" O.S.B. SHEATHING
- EXISTING 2X4 STUD WALL @ 16" O/C C/W 4" FIBER GLASS INSULATION (R12)
- 6 MIL POLYETHYLENE VAPOUR BARRIER
- 2" RIGID INSULATION (R10 CI) - 1/2" GYPSUM BOARD- TAPED & SANDED
- PAINT FINISH

$\langle \mathsf{B} \rangle$

EXISTING ROOF CONSTRUCTION ASSEMBLY @ 9'-0" FLAT INTERIOR CEILING

- 25 OR 30 YR. SELF SEALING ARCHITECTURAL ASPHALT SHINGLES
- 15 LBS ASPHALT ROOF FELT
- ICE & WATER SHIELD 60" UP FROM FASCIA BOARD
- 7/16" OSB SHEATHING W/ 'H' CLIPS
- EXISTING PRE-ENGINEERED- ROOF TRUSSES @ 24" O/C
- NEW FIBERGLASS BATT INSULATION CELLULOSE R60 MIN.
- INSULATION DEPRESSORS TO PROVIDE 2 1/2" OF CLEAR AIR FLOW ON ROOF SLOPES
- 6 MIL POLYETHYLENE VAPOUR BARRIER
- 1X3 STRAPPING @ 16" O/C 1/2" GYPSUM BOARD TAPED & SANDED
- PAINT FINISH

$\langle \mathsf{c} \rangle$

EXISTING ROOF CONSTRUCTION ASSEMBLY @ OPEN INTERIOR CEILING

- 25 OR 30 YR. SELF SEALING ARCHITECTURAL ASPHALT SHINGLES
- 15 LBS ASPHALT ROOF FELT
- ICE & WATER SHIELD 60" UP FROM FASCIA BOARD
- 7/16" OSB SHEATHING W/ 'H' CLIPS
- EXISTING PRE-ENGINEERED ROOF TRUSSES @ 24" O/C
- 6" RIGID INSULATION (R31 MIN.), FASTEND TO U/S ROOF SHEATING W/ 6" $\,$
- CLIMATECK R4 SCREWS @ 16" O/C, MECHANICAL INSTALLATION
- 1X3 STRAPPING @ 16" O/C
- 1/2" GYPSUM BOARD TAPED & SANDED
- PAINT FINISH

NEW BASEMENT SLAB CONSTRUCTION

- FLOOR FINISH, NOT SHOWN
- NEW 1/2" PLYWOOD SHEATHING
- NEW 2" R10 RIGID INSULATION PANELS (R10 CI)
- EXISTING 4" POURED CONCRETE SLAB, SEALED
- 8" CRUSHED STONE COMPACTED TO 95 MPD
- THERMOFOIL
- UNDISTURBED SOIL

$\langle \mathsf{E} \rangle$

EXISTING BRICK VENEER WALL ASSEMBLY

- 3 1/2" BRICK VENEER
- 1" AIR SPACE
- SBPOF WEATHER BARRIER, ALL JOINTS SEALED W/ TAPE
- EXISTING SHEATHING
- 2X4 STUD WALL @ 16" O/C C/W 8" INSULATION
- 6 MIL POLYETHYLENE VAPOUR BARRIER
- 1/2" GYPSUM BOARD - PAINT FINISH



NEW 8" FOUNDATION WALL ASSEMBLY @ FOUNDATION CURB

- AIR GAP MEMBRANE DRAINAGE LAYER
- CEMENT PARGING ABOVE GRADE TO MIN. 3" BELOW GRADE
- MIN. 1 COAT, BELOW GRADE BITUMINOUS DAMPROOFING
- 8" POURED CONCRETE WALL, 20 MPA (2900 PSI) MIN. STRENGTH AFTER 28 DAYS
- 2-15M CONTINUOUS REBARS (W/ 16" LAPS) TOP & BOTTOM 2-15M L-BARS (24"X24") TOP & BOTTOM OF ALL WALL CORNERS/JUNCTIONS 2-15M REBARS BELOW WINDOW OPENINGS (EXTEND 12" PAST EITHER SIDE OF
- OPENING)
- 15 LBS BUILDING PAPER FROM SLAB TO GRADE (WRAP AROUND 2X4 STUD WALL AT
- 4" RIGID INSULATION (R20 CI)



DECK FLOOR CONSTRUCTION ASSEMBLY @ REAR LANDINGS

- 2"X4" P.T. WOOD SLEEPER PLANKS
- 2"X8" P.T. FLOOR JOISTS @ 16" O/C



NEW OR EXISTING 4" INTERIOR NON-LOAD BEARING WALL ASSEMBLY

- PAINT FINISH
- 1/2" GYPSUM BOARD
- 2X4 STUD WALL @ 16" O/C
- PAINT FINISH

NATURAL LIGHT CALCULATION

LIVING/DINING ROOM

PROPOSED GLAZING REQUIRED GLAZING (10%)

331 SQFT 31.37 SQFT 9.47%

PRIMARY BEDROOM

PROPOSED GLAZING: REQUIRED GLAZING (5%)

180 SQFT 33.85 SQFT

BEDROOM 2

ROOM AREA: PROPOSED GLAZING REQUIRED GLAZING (5%) 149 SQFT 22.73 SQFT 15.25%



211-1390 PRINCE OF WALES DRIVE OTTAWA, ONTARIO K2C 3N6 613-255-3425 | SERVICES@CLEARDRAFTING.COM

PROJECT TITLE:

PROUD RESIDENCE 1342 CORKERY ROAD CARP, ONTARIO

I BASSAM ELSARAJ REVIEW AND TAKE RESPOSIBILITIES FOR THE DESIGN WORK ON BEHALF OF A FIRM REGISTERED UNDER DIVISION C, PART 3, SUBSECTION 3.2.4 OF THE 2012 O.B.C. I AM QUALIFIED AND THE FIRM IS REGISTERED IN THE APPROPRIATE CLASSES/CATAGORIES.

DESIGNER BCIN: 37385 FIRM BCIN: 40889

SIGNATURE OF MEMBER:



SQUKE FIG:	EXISTING	INEVV
BSMNT/FDN:	ft²	ft²
GRND FLR:	1,233 ft ²	ft²
2ND FLOOR:	ft²	ft²
2ND FLOOR:	ft ²	ft²

GENERAL NOTES:

- DO NOT SCALE DIMENISONS. READ DIMENSIONS
- GENERAL CONTRACTORS SHALL CONSTRUCT ALL WORK IN ACCORDANCE WITH THE 2012 ONTARIO BUILDING CODE, MUNICIPAL BYLAWS, AND ALL OTHER APPLICABLE BUILDING CODES.
- THE OWNER/BUILDER MAY NEED TO PROVIDE AN ENGINEER'S REPORT AT HIS/HER EXPENSE. CONSULT YOUR LOCAL BUILDING AUTHORITIES. • PLEASE NOTIFY DESIGNER FOR ANY ERRORS
- TO THE BEST OF MY KNOWLEDGE THESE PLANS ARE DRAWN TO COMPLY WITH THE CLIENT'S SPECIFICATIONS AND ANY CHANGES MADE ON THEM AFTER SUBMISSION ARE MADE AT THE OWNER'S AND/ OR CONTRACTOR'S EXPENSE AND RESPONSIBILITY.

AND/OR OMISSIONS PRIOR TO START OF WORK.

SCALE: AS SHOWN

DRAWING TITLE:

DATE: APRIL 6, 2024

CONSTRUCTION ASSEMBLIES

REVISION TABLE

PROJECT NUMBER: 2348

B.E.

DESCRIPTION NO. DATE ISSUED FOR PERMIT 2024-02-28

DRAWN BY:

SHEET:

GENERAL NOTES

NATURAL VENTILATION

INSULATION SHALL BE INSTALLED & OTHER CONSTRUCTION WORK UNDERTAKEN IN A MANNER WHICH WILL NOT REDUCE THE FLOW OF AIR THROUGH VENTS OR THROUGH ANY PORTION OF THE ROOF SPACE OR ATTIC WHERE NECESSARY TO ENSURE EFFECTIVE AIR CIRCULATION, SPECIAL VENTING DEVICES SUCH AS DUCTS OR BAFFLES SHALL BE INSTALLED.

PROVIDE HEAT RECOVERY VENTILATOR.

INSTALL SMOKE ALARMS AS PER O.B.C. 9.10.18.

FLASHING

FLASHING IS REQUIRED UNDER ALL JOINTED SILLS AND OVERHEAD OF WINDOWS & DOORS IN EXTERIOR WALLS IF DISTANCE BELOW EAVES IS MORE THAN 1/4 OF ROOF OVERHANG

FLASHING IS REQUIRED @ INTERSECTIONS OF ROOFS & WALLS, VALLEY, & OVER PARAPET WALLS.

FLASHING IS REQUIRED BETWEEN ROOF AND SHINGLES AND WALL SIDING 0.8MM (20 Ga) GALVANIZED METAL 75MM (3") UP BEHIND SHEATHING & EXTENDS 75MM (3") HORIZONTALLLY.

FLASHING IS REQUIRED @ BRICK VENEER & SHALL BE INSTALLED UP TO 200M (8") BEHIND THE BUILDING FELT & BELOW THE BOTTOM COURSE WITH VERTICAL JOINTS RAKED CLEAN WEEPHOLES @ 600MM (24")

WOOD FRAMING

ALL FRAMING LUMBER MUST CONFORM TO O.B.C. STRANDARDS OF SIZES FOR JOISTS, LINTELS, BEAMS, ETC... AS INDICATED ON PLANS UNLESS OTHERWISE NOTED.

ALL WINDOW LINTELS TO BE 2-2X10 UNLESS OTHERWISE NOTED.

ALL LUMBER TO BE SPF #2 OR BETTER, LUMBER EXPOSED TO THE EXTERIOR TO BE SPF #2 OR BETTER.

BEAMS TO HAVE A COLLECTIVE BEARING SIZE OF 89MM (3 1/2") BEARING SIZE. MINIMUM BEARING SIZE FOR LVLS (NORDIC LAM OR EQUIVELANT) TO BE 1 3/4".

LATERAL SUPPORT (WALLS SUPPORTING JOISTS): ANCHOR SILL PLATE @ 2400MM (8'-0") O.C. WITH 13MM (1/2") DIAMETER ANCHOR BOLTS EMBEDDED 100MM (4") INTO CONCRETE OR ANCHORED EVERY 4TH JOIST NOT RESTING ON A PLATE WITH A 4.8MM X 38MM (3/16 X 1 1/2") STEEL JOIST ANCHORS N.B.

LATERAL SUPPORT (WALLS PARALLEL TO JOISTS): BEND 4.8MM X 3.8MM (3/16 X 1 1/2") STEEL TRAP 75MM (3") INTO CONCRETE AND FIX TO 3 PARALLEL JOISTS OR FIX TO SILL PLATE (ANCHORED) TO 3 RIGIDLY CONNECTED FLOOR JOISTS @ A MAXIMUM 2030MM (6'-8") O.C.

ALL TRADITIONAL LUMBER & WOOD-I JOISTS TO HAVE BLOCKING OVER INTERIOR L-B WALLS & BEAMS.

OPEN-WEB JOIST 12'-0" & OVER TO HAVE CONTINOUS STRONGBACK THROUGH CHASE (IF POSSIBLE).

PROVIDE BLOCKING BETWEEN WOOD-I JOISTS OR CROSS-BRIDGING BETWEEN TRADITIONAL LUMBER FLOOR JOISTS WHEN NECESSARY (AS PER FLOOR JOIST MANUFACTURER LAYOUTS)

ALL BEAMS TO BE FLUSH OR DROPPED AS NOTED

HEADER LUMBER JOISTS OVER OPENINGS TO BE DOUBLED IF OPENING IS OVER 1200MM (4'-0").

ALL LVLS OVER WINDOWS, DOORS, AND ALL OTHER OPENINGS INDICATED ARE TO BE PROPERLY SIZED BY FLOOR MANUFACTURER ACCORDING TO LOAD APPLIED.

TRIMMER JOISTS TO BE DOUBLED IF OVER 800MM (2'-8").

DOUBLE ALL JOISTS UNDER PARALLEL PARTITIONS.

PROVIDE HANGERS FOR ALL JOISTS TO SUPPORT JOIST FRAMING INTO SIDES OF BEAMS, TRIMMERS.

WOOD STUD PARTITION TO BE MADE OF 38MM X 89MM (2" X 4") SPR $\,$ 400 $\,$ $\,$ 400MM (16") O.C. 38MM X 89MM (2" X 4") TOP AND BOTTOM PLATES. DOUBLE TOP STUDS AROUND OPENINGS & TRIPLE STUDS IN CORNERS IN BEARING STUD PARTITIONS

CERAMIC TILES APPLIED WITH ADHESIVE SHALL BE SET ON NO LESS THAN 5/8" PLYWOOD/WAFERBOARD WITH OFFSETTING JOISTS AND A 5/32" GAP BETWEEN THE SHEETS.

PROVIDE SOLID BLOCKING BEHIND TOWEL BARS, RODS, ETC.,

PROVIDE DOUBLE STUDS ON EACH END OF WALL OPENINGS

THERMAL INSULATION & VAPOUR BARRIERS

PROVIDE RIGID PERIMETER INSULATION FOR CONCRETE ON GRADE FOR HABITABLE AREAS.

THE UPPER PART OF FOUNDATION WALLS ENCLOSING HEATED SPACE SHALL BE INSULATED FROM THE UNDERSIDE OF THE SUBFLOOR TO NOT LESS THAN 610MM (24") BELOW THE ADJACENT FINISHED GROUND LEVEL, COVER THE INSULATION WITH C.G.S.B. APPROVED VAPOUR BARRIER ON WARM SIDE OF INSULATION. PROVIDE A MOISTURE BARRIER BETWEEN FOUNDATION WALL & WOOD STUD FRAMING

ACCESS TO HATCHES INTO ATTICS SHALL BE WEATHERSTRIPPED AROUND THE PERIMETER OF THE HATCH &

DUCTWORK IN THE ATTIC OR ROOF SPACES SHALL HAVE ALL JOINTS TAPED OR BE OTHERWISE SEALED TO ENSURE THE DUCTS ARE AIR-TIGHT THROUGHOUT THEIR LENGTH.

CLEARANCES BETWEEN CHIMNEYS OR GAS VENTS & THE SURROUNDING CONSTRUCTION THAT BUILDS

INSULATION INSTALLED IN CEILING AND EXTERIOR WALLS SHALL BE PROTECTED BY TYPE "1" VAPOUR BARRIERS TO C.A.N./C.G.S.B.-51.34M INSTALLED SO THAT ALL JOINTS OCCUR @ FRAMING MEMBERS FURRING OR BLOCKING & LAPPED @ LEAST 100MM (4") AT ALL JOINTS (CAULKED).

HOLES FOR VAPOLIR BARRIERS INSTALLED IN CEILINGS FOR THE INSTALLATION OF ELECTRICAL WIRING ELECTRICAL BOXES, PIPING, OR DUCTWORK SHALL BE EFFECTIVELY SEALED WITH CAULKING TAPE OR OTHER APPROVED MATERIAL TO MAINTAIN THE INTEGRITY OF THE VAPOUR BARRIER OVER THE ENTIRE

FOOTING & SLABS

CONCRETE FOOTINGS TO REST ON UNDISTURBED SOIL CAPABLE OF SUSTAINING A LOAD OF 75 KPA

FOOTINGS TO CONFORM TO O.B.C. SECTION 9.15 OR AS PER STRUCTURAL ENGINEER

PLUMBING SPECIFICATIONS

PLUMBING & FIXTURES AS INDICATED ON PLANS ACCORDING TO LOCAL PLUMBING CODES.

PROVIDE CONNECTIONS FOR DISHWASHER, CLOTHES WASHER, AND DRYER.

MECHANICAL SPECIFICATIONS

MECHANICAL VENTILATIONS IS REQUIRED TO PROVIDE 0.3 AIR CHANGES PER HOUR AVERAGED OVER 24 HOURS, SEE MECHANICAL DRAWINGS

MECHANICAL EXHAUST FANS, VENTED TO EXTERIOR TO PROVIDE AT LEAST ONE AIR CHANGE PER HOUR.

MECHANICAL VENTILATION SHALL CONFORM TO O.B.C. 9.32.

ELECTRICAL SPECIFICATIONS

ELECTRICAL INSTALLATIONS INCLUDE THE NUMBER OF DISTRIBUTION PANELS, ELECTRICAL FIXTURES AND OUTLETS SHALL MEET THE REQUIREMENTS OF THE APPROPRIATE PROVINCIAL CODE AND ONTARIO HYDRO. ALL WIRING SHALL BE COPPER.

PROVIDE ELECTRICAL CONNECTIONS FOR DISHWASHER, CLOTHES WASHER, & DRYER,

ROOF CONSTRUCTION

START STRIP NO. 85; 4.2KG/SQ.M. ROLL ROOFING OR ROOFING SHINGLES OF SAME WEIGHT AND QUALITY AS USED ON ROOF, LAID WITH TABS FACING UP.

HIP & VALLEY RAFTERS TO BE 50MM (2") DEEPER THAN COMMON RAFTERS.

ROOF EDGE SUPPORTS TO BE 38MM X 38MM (2" X 2") BLOCKING MINIMUM.

PROVIDE TRUSS BRIDGING 19MM X 89MM (3/4" X 4") CONTINOUS @ EACH 2135MM (7'-0")O.C.

PROVIDE 38MM X 89MM (2" X 4") WALL TIES ACROSS JOINTS OR BOTTOM TRUSS CHORD, MINIMUM 1220MM (4'-0") O.C. FOR ROOF SLOPES 4/12 OR GREATER.

PROVIDE ICE & SNOW GUARD IN ALL VALLEY & ROOF INTERSECTION.

HEATING

HEATING DUCTS & RETURN AIR HAVE BEEN LOCATED AS A SUGGESTED GUIDE ONLY. INSTALLATION IS TO SUIT BUILDING CONDITIONS & LOCAL BY-LAWS, SUBMIT HEATING LAYOUTS BEFORE COMMENCEMENT OF

AIR DUCTS IN EXTERIOR WALLS TO HAVE A MINIMUM R.S.I. 7 (R4) THERMAL INSULATION R.S.I. 1.23 (R7) IN UNHEATED SPACE. SPACE DUCTS & STUDS, ETC... TO BE SEALED WITH NON-COMBUSTIBLE MATERIAL @ EACH END. PIPE INSULATION TO BE NON-COMBUSTIBLE MAXIMUM FLAME SPREAD RATING FOR PIPES & DUCTS 75 IN SERVICE SPACE 150 OTHERWISE.

CONCRETE FOUNDATION WALLS

FOR BASEMENT WINDOWS OVER 1220MM (4'-0") WIDE, REINFORCE WITH 10M REINFORCEMENT RODS

SEAL EXTERIOR JOINTS BETWEEN FOUNDATION WALLS AND FOOTINGS, CONCRETE FLOOR SLAB, AND FOUNDATION WITH SEALING COMPOUND

APPLY BITUMINOUS DAMP PROOFING ON EXTERIOR FACE OF CONCRETE FOUNDATION WALL WITH 100MM (4") FREE DRAINING BACKFILL (GRANULAR 'B') OR EQUIVALENT

CONCRETE WALLS TO BE 200MM (8") THICK UNLESS OTHERWISE NOTED.

TOP OF ALL FOUNDATION WALLS TO BE MINIMUM 150MM (6") ABOVE FINAL GRADE.

DAMPROOFING COURSE TO BE PLACED BETWEEN CONTACT OF WOOD & CONCRETE.

MINIMUM STRENGTH FOR WALLS TO BE MINIMUM 20MPA (2900 PSI) AT 28 DAYS CURING.

FOUNDATION WALLS SHOULD NOT BE BACKFILLED UNTIL CONCRETE HAS REACHED ITS SPECIFIED 28 DAYS STRAIGHT & STRUCTURAL FLOOR FRAMING (INCLUDING PLYWOOD SUBFLOOR) REQUIRED TO STABILIZE THE WALLS IS COMPLETE AND FULLY NAILED & ANCHORED.

STEEL, TIMBER, & BUILT-UP TIMBER COLUMNS FROM ALL LEVELS SHALL BE CARRIED DOWN TO THE FOUNDATION OR TO SUPPORTING BEAMS. PROVIDE BLOCKING WHERE REQUIRED, STEEL COLUMN PLATES TO BE ANCHORED TO FOOTINGS AND BEAM FLANGES.

WINDOWS & DOORS

10% FLOOR AREA OF HABITABLE ROOMS TO EQUAL TRANSPARENT OPENINGS IN WINDOWS

5% FLOOR AREA OF BEDROOMS TO EQUAL TRANSPARENT OPENINGS IN WINDOWS, (ACCEPTABLE TO C.M.H.C. PROJECTS PROVIDING LOCAL AUTHORITIES APPROVE).

EXTERIOR DOORS TO HAVE THERMAL RESISTANCE OF R.S.I. 1.23 (R7).



211-1390 PRINCE OF WALES DRIVE OTTAWA, ONTARIO K2C 3N6

613-255-3425 | SERVICES@CLEARDRAFTING.COM

PROUD RESIDENCE 1342 CORKERY ROAD CARP, ONTARIO

PROJECT TITLE

I BASSAM ELSARAJ REVIEW AND TAKE RESPOSIBILITIES FOR THE DESIGN WORK ON BEHALF OF A FIRM REGISTERED UNDER DIVISION C, PART 3, SUBSECTION 3.2.4 OF THE 2012 O.B.C. I AM QUALIFIED AND THE FIRM IS REGISTERED IN THE APPROPRIATE CLASSES/CATAGORIES.

DESIGNER BCIN: 37385 FIRM BCIN: 40889

SIGNATURE OF MEMBER:



SQURE FTG:	EXISTING	NEW
BSMNT/FDN:	ft²	ft²
GRND FLR:	1,233 ft ²	ft²
2ND FLOOR:	ft²	ft²
2ND FLOOR:	ft ²	ft²

GENERAL NOTES:

- DO NOT SCALE DIMENISONS. READ DIMENSIONS
- GENERAL CONTRACTORS SHALL CONSTRUCT ALL WORK IN ACCORDANCE WITH THE 2012 ONTARIO BUILDING CODE, MUNICIPAL BYLAWS, AND ALL OTHER APPLICABLE BUILDING CODES.
- THE OWNER/BUILDER MAY NEED TO PROVIDE AN ENGINEER'S REPORT AT HIS/HER EXPENSE. CONSULT YOUR LOCAL BUILDING AUTHORITIES.
- PLEASE NOTIFY DESIGNER FOR ANY ERRORS AND/OR OMISSIONS PRIOR TO START OF WORK.
- TO THE BEST OF MY KNOWLEDGE THESE PLANS ARE DRAWN TO COMPLY WITH THE CLIENT'S SPECIFICATIONS AND ANY CHANGES MADE ON THEM AFTER SUBMISSION ARE MADE AT THE OWNER'S AND/ OR CONTRACTOR'S EXPENSE AND RESPONSIBILITY.

DRAWING TITLE

DESCRIPTION

DATE: APRIL 6, 2024

ISSUED FOR PERMIT

NO.

GENERAL NOTES

REVISION TABLE

DATE

2024-02-28

PROJECT NUMBER: 2348

DRAWN BY: B.E.

SCALE: AS SHOWN