

ARCHITECTURAL SHEET LIST Sheet Issue Date Sheet Number 09/08/23 09/08/23 09/08/23 09/08/23 LANDSCAPE AREA PLAN LOT AREA AND LOT COVERAGE SITE PLAN,OAA MATRIX,STATISTICS AND GENERAL NOTES FLOOR AREA PLAN PROPOSED R PLAN CONSTRUCTION NOTES DEMOLITION PLAN PROP. BASEMENT PROP. GROUND FLOOR 09/08/23 09/08/23 PROP. SECOND FLOOR PROP. ROOF PLAN PROP. FRONT ELEVATION 09/08/23 09/08/23 09/08/23 PROP. REAR ELEVATION PROP. LEFT ELEVATION PROP. RIGHT ELEVATION SECTION 09/08/23 SECTION 09/08/23 WINDOW AND DOOR SCHEDULE DETAILS, WALL, FLOOR AND ROOF ASSEMBLIES 09/08/23





Committee of Adjustment Received | Reçu le

2024-02-01

City of Ottawa | Ville d'Ottawa Comité de dérogation

295 DOVERCOURT AVE OTTAWA, ON K1Z 7H4

CLIENT

Owner



REVISIONS

No.	Description	Date
10	ISSUED FOR C OF A	2023-11-10
7	ISSUED FOR CONSULTANT	2023-09-26
6	ISSUED FOR BUILDING PERMIT	2023-09-08
4	ISSUED FOR C OF A	2023-07-21
3	ISSUED FOR CLIENT	2023-07-17
2	ISSUED FOR CLIENT	2023-07-13
1	ISSUED FOR CLIENT	2023-06-30

Discrepancies must be reported immediately to the Architect before proceeding. Only figured dimensons are to be used. Contractors must check all dimensions on site. This drawing is protected by copyright.

ALL DIMENSIONS ARE SHOWN IN IMPERIAL & METRIC

CONSULTAI





TORONTO - CANADA 416.546.2040 info@qbsarchitects.co

DRAWING TITLE

COVER

DRAWN	CHECKED
CD	SA
SCALE @ ARCH D	DATE
	09/08/23



PROJECT NO.

230118

COFA A0-00

LOCATION REVISION OTTAWA

DRIVEWAY-295

DRIVEWAY-297

HARD LS-295

HARD LS-297

SOFT LS-295

SOFT LS-297

Calculating...

DRIVEWAY-297 18.04 m² DRIVEWAY-295 18.00 m² SOFT LS-295 22.08 m²

FRONT YARD LANDSCAPE

1" = 10'-0"

OVERCOURT	AVE
Area	AREA SI
24.79 m²	24.79 m ²
11.38 m²	11.38 m ²
18.04 m²	18.04 m²
54.21 m²	54.21 m ²
	Area 24.79 m² 11.38 m² 18.04 m²

01 - FRONT YARD AREA CALCULA	TION-295 DOVERCOURT	AVE
Name	Area	AREA SI
SOFT LS-295	25.88 m²	25.88 m²
HARD LS-295	11.48 m²	11.48 m²
DRIVEWAY-295	18.00 m ²	18.00 m ²
6	55.37 m²	55.37 m²

Schema 1 Legend

HARD LS-295

HARD LS-297

SOFT LS-295

SOFT LS-297

Calculating...



REAR LANDSCAPE

1" = 10'-0"

OVERCOURT AVE	
Area	AREA S
2.46 m ²	2.46 m ²
82.14 m ²	82.14 m ²
84.60 m²	84.60 m ²
	2.46 m² 82.14 m²

01 - REAR YARD AREA-29	5 DOVERCOURT AVE	Ē
Name	Area	AREA SI
HARD LS-295	2.46 m²	2.46 m²
SOFT LS-295	82.14 m²	82.14 m²
TOTAL REAR YARD AREA	84.60 m²	84.60 m ²

295 DOVERCOURT AVE OTTAWA, ON K1Z 7H4

Owner



REVISIONS

Ю.	Description	Date
1	ISSUED FOR C OF A	2023-11-10
	ISSUED FOR CONSULTANT	2023-09-26
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LANDSCAPE AREA PLAN


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CD	SA
SCALE @ ARCH D	DATE
1" = 10'-0"	09/08/23



PROJECT NO. 230118

COFA A0-01

OTTAWA

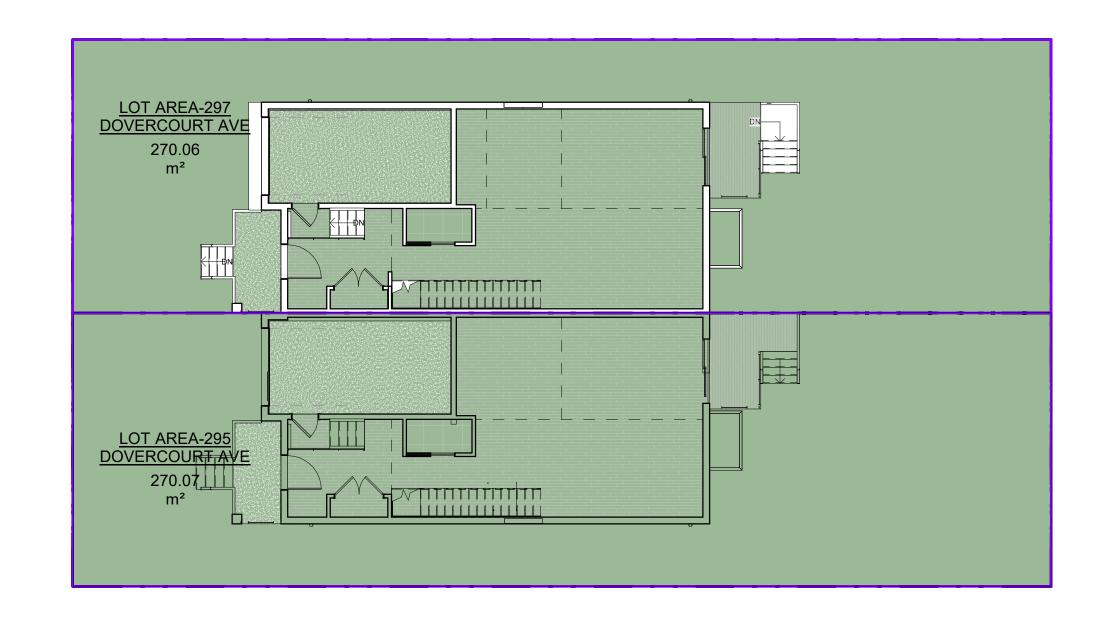



PROP. COVERAGE-295 DOVERCOURT AVE

PROP. COVERAGE-297 DOVERCOURT AVE Calculating...





295 DOVERCOURT AVE OTTAWA, ON K1Z 7H4

Owner



REVISIONS

No.	Description	Date
10	ISSUED FOR C OF A	2023-11-10
7	ISSUED FOR CONSULTANT	2023-09-26
6	ISSUED FOR BUILDING PERMIT	2023-09-08
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ALL DIMENSIONS ARE SHOWN IN IMPERIAL & METRIC.





TORONTO - CANADA 416.546.2040 info@qbsarchitects.co

LOT AREA AND LOT COVERAGE

DRAWN	CHECKED
CD	SA
SCALE @ ARCH D	DATE
1" = 10'-0"	09/08/23
	0.5



PROJECT NO. 230118

COFA A0-02

OTTAWA

	FIRM NAME:											TARIO ASSO	20
	QBS ARCHITECTS INC 1670 BAYVIEW AVENU											NARIE OF	CAIL
	TORONTO, ON	, CONE 001										O ARCHITEC	
	M4G 3C2 CERTIFICATE OF PRA	CTICE NUMBE	R: 523	5								SABA AL MATI	1000 0000
												5983	Hararia .
	PROPOSED 2 STOREY LOCATION:	DWELLING										The architect noted a	
	297 DOVERCOURT AV	E, OTTAWA										responsible contro design activities. The	
\vdash												number is the ar	
No.	ONTARIO'S BUILDING	CODE DATA M	IATRIX	(PART 9 RESIDI	ENTIA	L						OBC REFERENCE References are to D	
												noted [A] for Divisio	
1	PROJECT DESCRIPTION	ON:					\times	NEW		PA	RT 11	PART 3	X PART 9
								ADDITION		11.1 7	O 11.4	2.1.1.[A]	2.1.1.[A]
				c	HANG	E OF USE		ALTERATION	١				9.10.1.3
2	MAJOR OCCUPANCY(S):	GRO	UP C RESIDENT	ΓIAL O	CCUPANCY						3.1.2.1.(1)	9.10.2
3	BUILDING AREA (m²):		EXIS	TING: 100.00	N	IEW: 93.36						1.4.1.2.[A]	1.4.1.2.[A]
4	GROSS AREA (m²):		EXIS	TING: +/- 184.48	S N	IEW: 167.23						1.4.1.2.[A]	1.4.1.2.[A]
5	NUMBER OF STOREYS	3	ABO	VE GRADE: 2	В	BELOW GRAD	E: 1					1.4.1.2.[A] & 3.2.1.1.	1.4.1.2.[A] & 9.10.
6	NUMBER OF STREET/	FIRE FIGHTER	ACCE	SS: 1								3.2.2.10 & 3.2.5	9.10.20
7	BUILDING CLASSIFICA	ATION:										3.2.2.2083	9.10.2
8	SPRINKLER SYSTEM F	PROPOSED:				EI	NTIRE BUILDIN	IG				3.2.2.2083	9.10.8.2
						□ sı	ELECTED COM	IPARTMENTS	3			3.2.1.5	
							ELECTED FLO					3.2.2.17	
						⊟в	ASEMENT ONL	Υ			OF ROOF	INDEX	INDEX
						=	OT REQUIRED		ш	RATING			
9	STANDPIPE REQUIRE	D:				YI	ES		\times	NO		3.2.9	N/A
10	FIRE ALARM REQUIRE	D:				YI	ES		X	NO		3.2.4	9.10.18
11	WATER SERVICE/SUP	PLY IS ADEQU	ATE:			X YI	ES (MUNICIPAL	_)		NO		3.2.5.7	N/A
12	HIGH BUILDING:					YI	ES		\times	NO		3.2.6	N/A
13	CONSTRUCTION RES	TRICTIONS:		N-COMBUSTIBL RMITTED	.E	× c	OMBUSTIBLE F	REQUIRED		вотн		3.2.2.2083	9.10.6
	ACTUAL CONSTRUCT	ION:		N-COMBUSTIBL	.E		OMBUSTIBLE			вотн			
14	MEZZANINE(S) AREA	(m²):	N/A									3.2.1.1.(3)-(8)	9.10.4.1
15	OCCUPANT LOAD BAS	SES ON:	m²/	PERSON		X D	ESIGN OF BUIL	DING				3.1.17	9.9.1.3
	BASEMENT:	_	occ	UPANCY C		L(OAD _2 PER	SONS					
	1st FLOOR:		occ	UPANCY C		L	OAD PER	SONS					
	2nd FLOOR:		occ	UPANCY_C		L	DAD 6 PERSO	ONS					
	3rd FLOOR:		OCC	UPANCY		L	OAD PERS	ONS					
	ROOF:		OCC	UPANCY _		L	OAD PERS	ONS					
16	BARRIER-FREE DESIG	SN .		YES 2	× N	O (EXPLAI	N) BUILDING IS	S A HOUSE (E	XEM	IPT)		3.8	9.5.2
17	HAZARDOUS SUBSTA	NCES		YES 2	X N	10						3.3.1.2. & 3.3.1.19	9.10.1.3(4)
18	REQUIRED FIRE	HORIZO	ONTAL	ASSEMBLIES F	RR (H	IOURS)	LISTED DE	ESIGN No. OF	R DES	SCRIPTION	l (SG-2)	3.2.2.2083	9.10.8
	RESISTANCE RATING	FLOORS			0 1	HOURS						3.2.1.4	9.10.9
	(FRR)	ROOF			0 1	HOURS							
		MEZZANINE			N/	A HOURS						1	
			OF SU	PPORTING MEN	/BERS	3	LISTED DE	ESIGN No. OF	R DES	SCRIPTION	l (SG-2)		
		FLOORS				HOURS							
		ROOF				HOURS						†	
		MEZZANINE				A HOURS						†	
19	SPATIAL SEPERATION		ION O	F EXTERIOR W			l						<u> </u>
' "	WALL	AREA OF	.5.40	L.D.	L/H	PERMITTED	PROPOSED	FRR	1	ISTED	COMB.	СОМВ.	NON-COMB.
	**/ \LL	E.B.F.		L.D.	OR	MAX % OF	l % OF	(HOURS)	DE:	SIGN OR	CONST	CONST. NONC.	CONSTR.
		(sq.ft) (sq.n	n)	(ft) (m)	H/L	OPENINGS	OPENINGS (sq.m) %		DES	CRIPTION		CLADDING	
	FRONT (SOUTH)	492.45 45.7	5	19.69 6.00		100	19.56 % (8.95)			\times		
	REAR (NORTH)	492.45 45.7	75	35.60 10.85		100	28.92%(13.23)			X		
	SIDE-RIGHT (EAST)	1001.15 93.0)1	0.00 0.00		0	0.00% (0.00)				X		
1					 		· ·		 		_=	1	1

1046.47 97.22 6.53 1.99 7 6.90% (6.71)

NEW BY-LAW

			(sq.m)	(sq.ft)
ZONING: R3R[2687] H(8.5)				
MINIMUM LOT AREA(SEMI-DETACHED): ALLOWABLE COVERAGE: N/A ALLOWABLE FSI: N/A			180.0 N/A N/A	1937.5 N/A N/A
PROPOSED BASEMENT FLOOR PROPOSED GROUND FLOOR PROPOSED SECOND FLOOR PROPOSED TOTAL GFA				
PROPOSED FSI 0.62				
PROPOSED COVERAGE: 34.57%				
SETBACKS	ALLO	PROPOSED		
	(m)	(ft)	(m)	(ft)

	FIRM NAME:												22A C	0
	PIRM NAME: QBS ARCHITECTS INC 1670 BAYVIEW AVENU TORONTO, ON M4G 3C2												ARCHITE	CTS 2
	CERTIFICATE OF PRA	CTICE NUMBER:	5235										SABA AL MAT	THNO E
	PROPOSED 2 STOREY	Y DWELLING											THE THE PERSON NAMED IN	STREET, STREET
	LOCATION: 295 DOVERCOURT AV	Æ, OTTAWA											The architect noted responsible control design activities. The architecture is the architecture	ol with respect to he architect's seal
lo.	ONTARIO'S BUILDING	CODE DATA MAT	RIX PART 9 F	ESIDE	NTIAL	_							OBC REFERENCE	
													References are to noted [A] for Division C.	
1	PROJECT DESCRIPTION	ON:						X N	NEW		PA	ART 11	PART 3	X PART 9
			Г	l c⊦	IANGE	E OF USE]	=	ADDITION ALTERATION	ı	11.1	ΓΟ 11.4	2.1.1.[A]	2.1.1.[A] 9.10.1.3
2	MAJOR OCCUPANCY(S): G	ROUP C RES						ILTERVITION				3.1.2.1.(1)	9.10.2
;	BUILDING AREA (m²):	E	XISTING: 100	00	N	EW: 93.36							1.4.1.2.[A]	1.4.1.2.[A]
ļ	GROSS AREA (m²):	E	XISTING: +/- 1	84.48	N	EW: 167.23							1.4.1.2.[A]	1.4.1.2.[A]
5	NUMBER OF STOREYS	S A	BOVE GRADE	: 2	В	ELOW GRA	DE: 1						1.4.1.2.[A] & 3.2.1.1	1.4.1.2.[A] & 9.10
3	NUMBER OF STREET/	FIRE FIGHTER AC	CCESS: 1										3.2.2.10 & 3.2.5	9.10.20
7	BUILDING CLASSIFICA	ATION:											3.2.2.2083	9.10.2
3	SPRINKLER SYSTEM F	PROPOSED:					ENTIRE BU	ILDING	3				3.2.2.2083	9.10.8.2
									PARTMENTS	;			3.2.1.5	
						_ ∐ ;	SELECTED	FLOOF	R AREAS		IN LUTE	0F B00F	3.2.2.17 INDEX	INDEX
						=	BASEMENT NOT REQUI		,		RATING	OF ROOF	INDEX	INDEX
9	STANDPIPE REQUIRE	D:					YES			X	NO		3.2.9	N/A
10	FIRE ALARM REQUIRE	ED:					YES			X	NO		3.2.4	9.10.18
11	WATER SERVICE/SUP	PLY IS ADEQUAT	E:			\times ,	YES (MUNIC	CIPAL))		NO		3.2.5.7	N/A
12	HIGH BUILDING:						YES			X	NO		3.2.6	N/A
13	CONSTRUCTION REST		NON-COMBU PERMITTED	STIBLI	=		COMBUSTII		EQUIRED	Ц	BOTH		3.2.2.2083	9.10.6
	ACTUAL CONSTRUCT		NON-COMBU	STIBLI	Ε	×	COMBUSTII	BLE			вотн			
14	MEZZANINE(S) AREA		/A			<u> </u>							3.2.1.1.(3)-(8)	9.10.4.1
15	OCCUPANT LOAD BAS		m²/PERSON	_			DESIGN OF						3.1.17	9.9.1.3
	BASEMENT: 1st FLOOR:		CCUPANCY_	_			LOAD _2 LOAD	PERS						
	2nd FLOOR:		CCUPANCY_ CCUPANCY	_			LOAD 6 P							
	3rd FLOOR:		CCUPANCY	_			LOAD F							
	ROOF:	0	CCUPANCY	_			LOAD F	PERSO	ONS					
16	BARRIER-FREE DESIG	SN .	YE:	3 >	< N	O (EXPLA	AIN) BUILDII	NG IS	A HOUSE (E	XEMI	PT)		3.8	9.5.2
17	HAZARDOUS SUBSTA	NCES	YE:	s >	< N	0							3.3.1.2. & 3.3.1.19	9.10.1.3(4)
18	REQUIRED FIRE	HORIZON	TAL ASSEMB	IES F	RR (H	OURS)	LISTE	D DES	SIGN No. OF	RDES	CRIPTION	N (SG-2)	3.2.2.2083	9.10.8
	RESISTANCE RATING (FRR)	FLOORS				HOURS							3.2.1.4	9.10.9
	, ,	ROOF				HOURS								
		MEZZANINE N/A HOURS FRR OF SUPPORTING MEMBERS												
					LISTED DESIGN No. OR DESCRIPTION (SG-2)				N (SG-2)					
		FLOORS				HOURS								
		ROOF				HOURS								
9	SPATIAL SEPERATION	- CONSTRUCTION	N OF EVTER!	JB 1/1/		A HOURS								
פּי	WALL	AREA OF	L.D.	JI VV P	L/H	PERMITTE	D PROPO	SED	FRR	1.1	STED	COMB.	сомв.	NON-COMB.
	**ALL	E.B.F. (sq.ft) (sq.m)		n)	OR H/L	MAX % OF OPENINGS	: % C	F	(HOURS)	DES	SIED SIGN OR CRIPTION	CONST.	CONST. NONC. CLADDING	CONSTR.
	FRONT (SOUTH)	492.45 45.75		5.00		100	19.56 %							
		TUL.TU 40.10	10.00	-										-
	REAR (NORTH)	492.45 45.75	35.60	0.85	I	100	28.92%(1	13.23)	1			1 1/2 1		
	REAR (NORTH) SIDE-RIGHT (EAST)	492.45 45.75 1001.15 93.01		1.99		7	6.21% (5					\times		

NEW BY-LAW

	OURT AVE	BY-LAW	2008-250	
ZONING: R3R[2687] H(8.5)			(sq.m)	(sq.ft)
MINIMUM LOT AREA(SEMI-DETACHED): ALLOWABLE COVERAGE: N/A ALLOWABLE FSI: N/A			180.0 N/A N/A	1937.5 N/A N/A
PROPOSED BASEMENT FLOOR PROPOSED GROUND FLOOR PROPOSED SECOND FLOOR PROPOSED TOTAL GFA				
PROPOSED FSI 0.62				
PROPOSED COVERAGE: 34.57%				
SETBACKS	ALLOW	/ABLE	PROPOS	ED
	(m)	(ft)	(m)	(ft)
FRONT: REAR: SIDE-WEST (LEFT): SIDE-EAST (RIGHT): BUILDING HEIGHT: BUILDING LENGTH:	6.0 7.5 0 1.2 8.0 17.59 6.0	19.69 24.60 0.00 3.94 26.25 57.71 19.69	6.0 10.85 0 1.99 7.74 14.24 8.69 PROVIDED	19.69 35.60 0.00 6.53 25.39 46.72 28.51

GENERAL NOTES

- ALL CONSTRUCTION TO COMPLY WITH CURRENT EDITION OF THE ONTARIO BUILDING CODE 2012 OBC, AS AMENDED. ALL WORKMANSHIP IS TO BE OF A STANDARD EQUAL IN ALL RESPECTS TO GOOD BUILDING PRACTICE.
- DRAWINGS AND SPECIFICATIONS ARE PROPERTY OF THE ARCHITECT AND MUST BE RETURNED ON COMPLETION OF THE PROJECT.
- REPORT IN WRITING ALL DISCOVERED ERRORS OR OMISSIONS TO THE ARCHITECT AT ONCE.
- DO NOT SCALE DRAWINGS. USE LATEST SCALE DRAWINGS ONLY.
- CONTRACTOR TO VERIFY ALL VERTICAL AND HORIZONTAL SITE DIMENSIONS PRIOR TO COMMENCING WORK INCLUDING EXTERIOR LANDSCAPING DIMENSIONS. CONTRACTOR TO PROVIDE PLYWOOD HOARDING AROUND THE PERIMETER OF THE JOB SITE BETWEEN THE PROPOSED NEW STRUCTURE TO THE PROPERTY LINE. IF ADDITIONAL STAGING/STORAGE AREA IS REQUIRED, CONTRACTOR TO APPLY FOR PERMIT TO BUILD HOARDING ON CITY PROPERTY. IN LIEU OF PLYWOOD HOARDING, A 7'-0" HIGH CHAIN LINK FENCE BY "FAST FENCE" OR EQUAL IS TO BE

- SITE MUST BE SAFE AND SECURE AT ALL TIMES. CONTRACTOR RESPONSIBLE FOR LOCKING THE CONSTRUCTION GATE NIGHTLY. CONTRACTOR MUST POST "NO TRESPASSING" AND "DANGER-CONSTRUCTION AREA" SIGNS AS WELL AS ANY OTHER SIGNS REQUIRED BY ANY GOVERNING BODY .G. HEALTH AND SAFETY, ETC.
- EXISTING GRADE DIMENSIONS DISTURBED DURING CONSTRUCTION TO BE MAINTAINED UNLESS OTHERWISE NOTED ON LOT DRAINAGE PLAN. ALL BACKFILL MUST BE EVELED. ADD 4" TOPSOIL AND SOD IN ALL AREAS DISTURBED DURING CONSTRUCTION. REPAIRS TO EXISTING LANDSCAPING - USE TRIPLE MIX SOIL AT ALL PLANTING BEDS.
- REFER TO ARBORIST REPORT (WHERE APPLICABLE) FOR SPECIAL INSTRUCTION REGARDING EXCAVATION / CONSTRUCTION IN PROXIMITY TO MATURE TREES.
- EVERY EXCAVATION SHALL BE UNDERTAKEN IN SUCH A MANNER AS TO PREVENT MOVEMENT WHICH WOULD CAUSE DAMAGE TO ADJACENT PROPERTY, EXISTING STRUCTURES, UTILITIES, ROADS AND SIDEWALKS AT ALL STAGES OF CONSTRUCTION.
- ENSURE ADEQUATE BRACING OF FOUNDATION WALLS PRIOR TO BACKFILLING. ALL STRUCTURAL WOOD TO BE #2 SPRUCE OR BETTER UNLESS NOTED OTHERWISE
- PROVIDE POSTS UNDER ALL BEAMS / GIRDER TRUSSES, ETC. POSTS TO RUN CONTINUOUS TO FOUNDATION OR EQUIVALENT SUPPORT.
- ALL STUMPS, ROOTS AND OTHER DEBRIS SHALL BE REMOVED FROM HE SOIL TO A MIN. DEPTH OF 12" IN UNEXCAVATED AREAS UNDER A BUILDING. WOOD DEBRIS REMOVAL SHALL EXTEND 2'- 0" MIN. BEYOND THE PERIMETER OF THE BUILDING.
- ALL WOOD SCRAPS AND FORMS SHALL BE REMOVED FROM AROUND THE FOUNDATIONS BEFORE BACKFILLING AND FROM UNDER EXTERIOR STEPS OR PORCHES BEFORE CONSTRUCTION IS COMPLETED.
- ALL EXISTING SURFACES ADJACENT TO NEW CONSTRUCTION AND THROUGH WHICH CONSTRUCTION MATERIALS AND CONTRACTOR'S FORCES MOVE ARE TO BE PROTECTED.
- PROVIDE TEMPORARY DUST BARRIERS AS REQUIRED TO MAINTAIN DUST FREE ENVIRONMENT FOR ALL BUILDING AREAS OCCUPIED BY OWNER / TENANTS. CONTRACTOR SHALL MAINTAIN THE JOB SITE AND WORK IN A TIDY CONDITION. DAILY CLEAN UP OF JOB SITE IS REQUIRED.
- REMOVE ALL CONSTRUCTION DEBRIS FROM SITE UNLESS OTHERWISE NOTED. ALL WOOD FRAMING MEMBERS SUPPORTED ON CONCRETE WHICH IS IN DIRECT CONTACT WITH SOIL IS TO BE SEPARATED FROM CONCRETE WITH DAMP PROOFING MATERIAL (9.23.2.3 OBC)
- GARAGE ACCESS DOOR TO BUILDING TO BE C/W SELF CLOSURE MECHANISM AND GAS TIGHT. ALL WINDOWS LOCATED WITHIN 6'7" FROM GRADE, SHALL CONFORM TO CLAUSE 10.13 OF CSA STANDARD A440-M90 AND 9.7.6.1 OBC (RESISTANCE TO FORCED ENTRY). SUPPLY AND INSTALL 6" SMOOTH CUT LIMESTONE THRESHOLD / SILL AT ALL EXTERIOR DOORS / WINDOWS (INCLUDING BASEMENT).
- ALL GUARD RAILS ARE TO SUSTAIN MINIMUM LOADING AS PER OBC 4.1.10.1 AND 9.8.8 FOR HEIGHT AND SPACING OF PICKETS. HANDRAILS AND TO CONFIRM WITH 9.8.8 OBC.

WATER METER

ESTABLISHED GRADE CALC: 82.44 + 82.51 / 2 = 82.48

- ALL INTERIOR TRIM TO BE POPLAR (PAINT) UNLESS OTHERWISE NOTED. EXTERIOR TRIM TO BE #1 CLEAR PINE (PAINT). NOTE: USE KIL ON ALL KNOTS PRIOR TO PRIMER COAT. ALL WOOD TO BE KEPT DRY
- ALL TRIM TO BE PRE-PAINTED (PRIMER + ONE COAT) PRIOR TO INSTALLATION.
- CONTRACTOR MUST RECEIVE PERMISSION FROM OWNER PRIOR TO INSTALLATION OF JOB SIGN. SEE INSTRUCTIONS TO CONTRACTOR FOR ADDITIONAL SPECIFICATIONS AND CASH ALLOWANCES.
- CONTRACTOR TO USE FLEXIBLE CORNER BEAD AT ALL RADIUSES DRYWALL EDGES.
- THESE WORKING DRAWINGS ARE BASED ON "MEASURED DRAWINGS" OF THE EXISTING BUILDING, NOT "RECORD DRAWINGS", WHICH ARE THE ORIGINAL CONSTRUCTION DRAWINGS REVISED TO REFLECT "AS BUILT" CONDITIONS. MEASUREMENTS HAVE BEEN TAKEN TO EXTERIOR SURFACES ONLY, AND EXCEPT WHERE NOTED NO ATTEMPT HAS BEEN MADE TO VERIFY HIDDEN CONDITIONS.

Bay Window

NO REPRESENTATION IS MADE THAT THE BUILDING CONFORMS TO ANY CODE REQUIREMENTS, OR ANY CONSTRUCTION DRAWINGS THAT MAY HAVE BEEN PREPARED BY OTHERS.

ELECTRICAL SYSTEM

- CONTRACTOR TO COORDINATE STRUCTURAL JOISTS AND STUD LAYOUTS TO ACCOMMODATE THE ELECTRICAL POTLIGHTS, ETC. LOCATIONS. NOTE: REPORT ANY LAYOUT DISCREPANCIES TO THE ARCHITECT PRIOR TO THE INSTALLATION.
- SEE ALSO ATTACHED REFLECTED CEILING PLANS AND ELECTRICAL SPECIFICATIONS.
- CONTRACTOR TO INSTALL APPROVED ELECTRICAL PANEL(S) OF ADEQUATE SIZE TO HANDLE ALL ELECTRICAL REQUIREMENTS.
- CONTRACTOR TO ENSURE EXISTING ELECTRICAL PANEL(S) IS ADEQUATE TO SERVE BOTH EXISTING AND PROPOSED ADDITION'S POWER REQUIREMENTS.
- CONTRACTOR RESPONSIBLE FOR OBTAINING ONTARIO HYDRO PERMIT.

SURVEY NOTE

BUILDER / GENERAL CONTRACTOR MUST RETAIN THE SERVICES OF A PROFESSIONAL SURVEYOR FOR THE STAKING OUT OF NEW FOUNDATIONS, SURVEYOR MUST BE GIVEN 72 HOURS NOTICE BEFORE BEING REQUIRED ON SITE. TO BEGIN DEMOLITION/CONSTRUCTION:

- SITE FENCING-BUILDER / GENERAL CONTRACTOR MUST ENLOSE ENTIRE SITE WITH A FENCE THAT IS IN COMPLIANCE WITH THE CITY OF TORONTO MUNICIPAL CODE CHAPTER 363, ARTICLE III. THE MIN. REQUIREMENT IS A PLASTIC MESH FENCE, 1.2M HIGH, TIED TO POSTS SPACED NO MORE THAN 1.2M APART, WITH AN 11 GAUGE TOP AND BOTTOM WIRE THREADED THROUGH THE MESH AND LOOPED AROUND EACH POST. CONSTUCTION NOISE- ANY CONSTRUCTION WHICH GENERATES NOISE IS PROHIBITED IN RESIDENCIAL AREAS BETWEEN THE HOURS OF 7:00PM ONE DAY TO 7:00AM THE NEXT DAY, 9:00AM ON SATURDAYS, AND ALL DAY SUNDAY AND STATUTORY HOLIDAYS.
- CALL FOR INSPECTIONS- THE BUILDER/ GENERAL CONTRACTOR IS REQUIRED TO NOTIFY THE BUILDING INSPECTION OFFICE AT VARIOUS STAGES OF CONSTRUCTION AS REQUIRED BY DIVISION C, PART 1, ARTICLE 1.3.5.1. OF THE ONTARIO BUILDING CODE. THE PHONE NUMBER FOR THE BUILDING INSPECTION OFFICE RESPONABILE FOR THE PROJECT'S AREA WILL BE INCULDED IN THE PERMIT DOCUMENTS.
- PERMIT PLANS. THE PERMIT PLANS AND SPECIFICATIONS MUST BE ON THE SITE AT ALL TIMES. THE PERMIT PLANS AND SPECIFICATIONS PROVIDED TO THE BUILDER/ GENERAL CONTRACTOR WILL BE USED FOR INSPECTIONS.

#23

#16

ALLOWABLE REAR YARD SETBACK

11' - 0" 3.35 m

REAR DECK AND STAIRS UNIT 1-LOT A



CLIENT

Description ISSUED FOR C OF A 2023-11-10 REISSUED FOR BUILDING PERMIT 2023-10-20 ISSUED FOR CONSULTANT 2023-09-26 ISSUED FOR BUILDING PERMIT 2023-09-08 ISSUED FOR C OF A 2023-07-21 ISSUED FOR CLIENT 2023-07-17 ISSUED FOR CLIENT 2023-07-13

295 DOVERCOURT AVE

OTTAWA, ON

Discrepancies must be reported immediately to the Architect before proceeding. Only figured dimensons are to be used. Contractors must check all dimensions on site. This drawing is protected by copyright.

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CONSULTANTS





TORONTO - CANADA 416.546.2040 info@gbsarchitects.c DRAWING TITLE

SITE PLAN, OAA MATRIX, STATISTICS AND **GENERAL NOTES**

SA SCALE @ ARCH D 09/08/23 As indicated



PROJECT NO. 230118


STAGE DRAWING NO.

COFA A0-03

LOCATION OTTAWA

REVISION 10



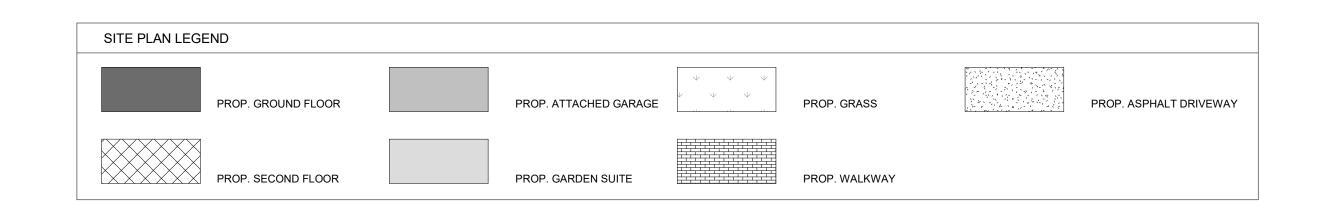

295 DOVERCOURT AVE

PROP. BASEMENT FLOOR-295 DOVERCOURT AVE

PROP. BASEMENT FLOOR-297 DOVERCOURT AVE

Calculating...

Schema 1 Legend

PROP. GROUND FLOOR-295 DOVERCOURT AVE

PROP. GROUND FLOOR-297 DOVERCOURT AVE


Calculating...

Schema 1 Legend

PROP. SECOND FLOOR-295 DOVERCOURT AVE

PROP. SECOND FLOOR-297 DOVERCOURT AVE

Calculating...

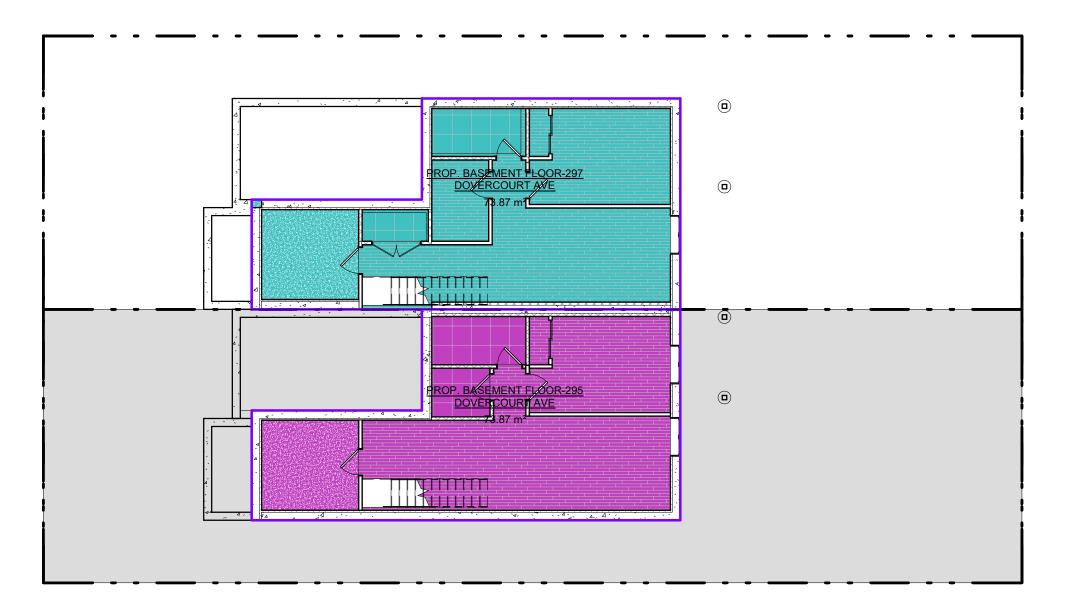


BASEMENT-PROPOSED

1" = 10'-0"



GROUND FLOOR-PROPOSED

1" = 10'-0"

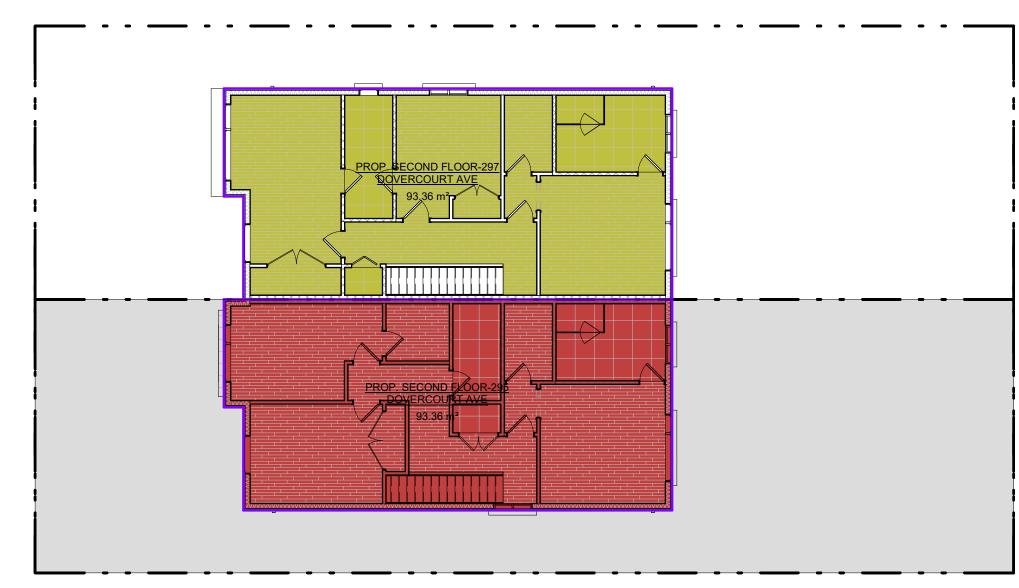

SECOND FLOOR-PROPOSED

1" = 10'-0"

E

Owner

295 DOVERCOURT AVE

OTTAWA, ON

K1Z 7H4

REVISIONS

No.	Description	Date
10	ISSUED FOR C OF A	2023-11-10
7	ISSUED FOR CONSULTANT	2023-09-26
6	ISSUED FOR BUILDING PERMIT	2023-09-08
4	ISSUED FOR C OF A	2023-07-21
3	ISSUED FOR CLIENT	2023-07-17
2	ISSUED FOR CLIENT	2023-07-13
1	ISSUED FOR CLIENT	2023-06-30

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ALL DIMENSIONS ARE SHOWN IN IMPERIAL & METRIC

CONSULTANTS

Area Schedule (297 DOVERCOURT AVE)

Area Schedule (295 DOVERCOURT AVE

 $\begin{array}{ccc} PROP. \ BASEMENT \ FLOOR-295 \ DOVERCOURT \ AVE \\ PROP. \ GROUND \ FLOOR-295 \ DOVERCOURT \ AVE \\ PROP. \ SECOND \ FLOOR-295 \ DOVERCOURT \ AVE \\ \end{array} \begin{array}{cccc} 73.87 \ m^2 \\ 93.36 \ m^2 \end{array}$

PROP. GROUND FLOOR-297 DOVERCOURT AVE 73.87 m²
PROP. SECOND FLOOR-297 DOVERCOURT AVE 93.36 m²
93.36 m²





TORONTO - CANADA 416.546.2040 info@qbsarchitects.cc

FLOOR AREA PLAN

	DRAWN	CHECKED
	CD	SA
	SCALE @ ARCH D	DATE
	1" = 10'-0"	09/08/23




PROJECT NO. **230118**

AGE DRAWING NO.

COFA A0-04


LOCATION OTTAWA

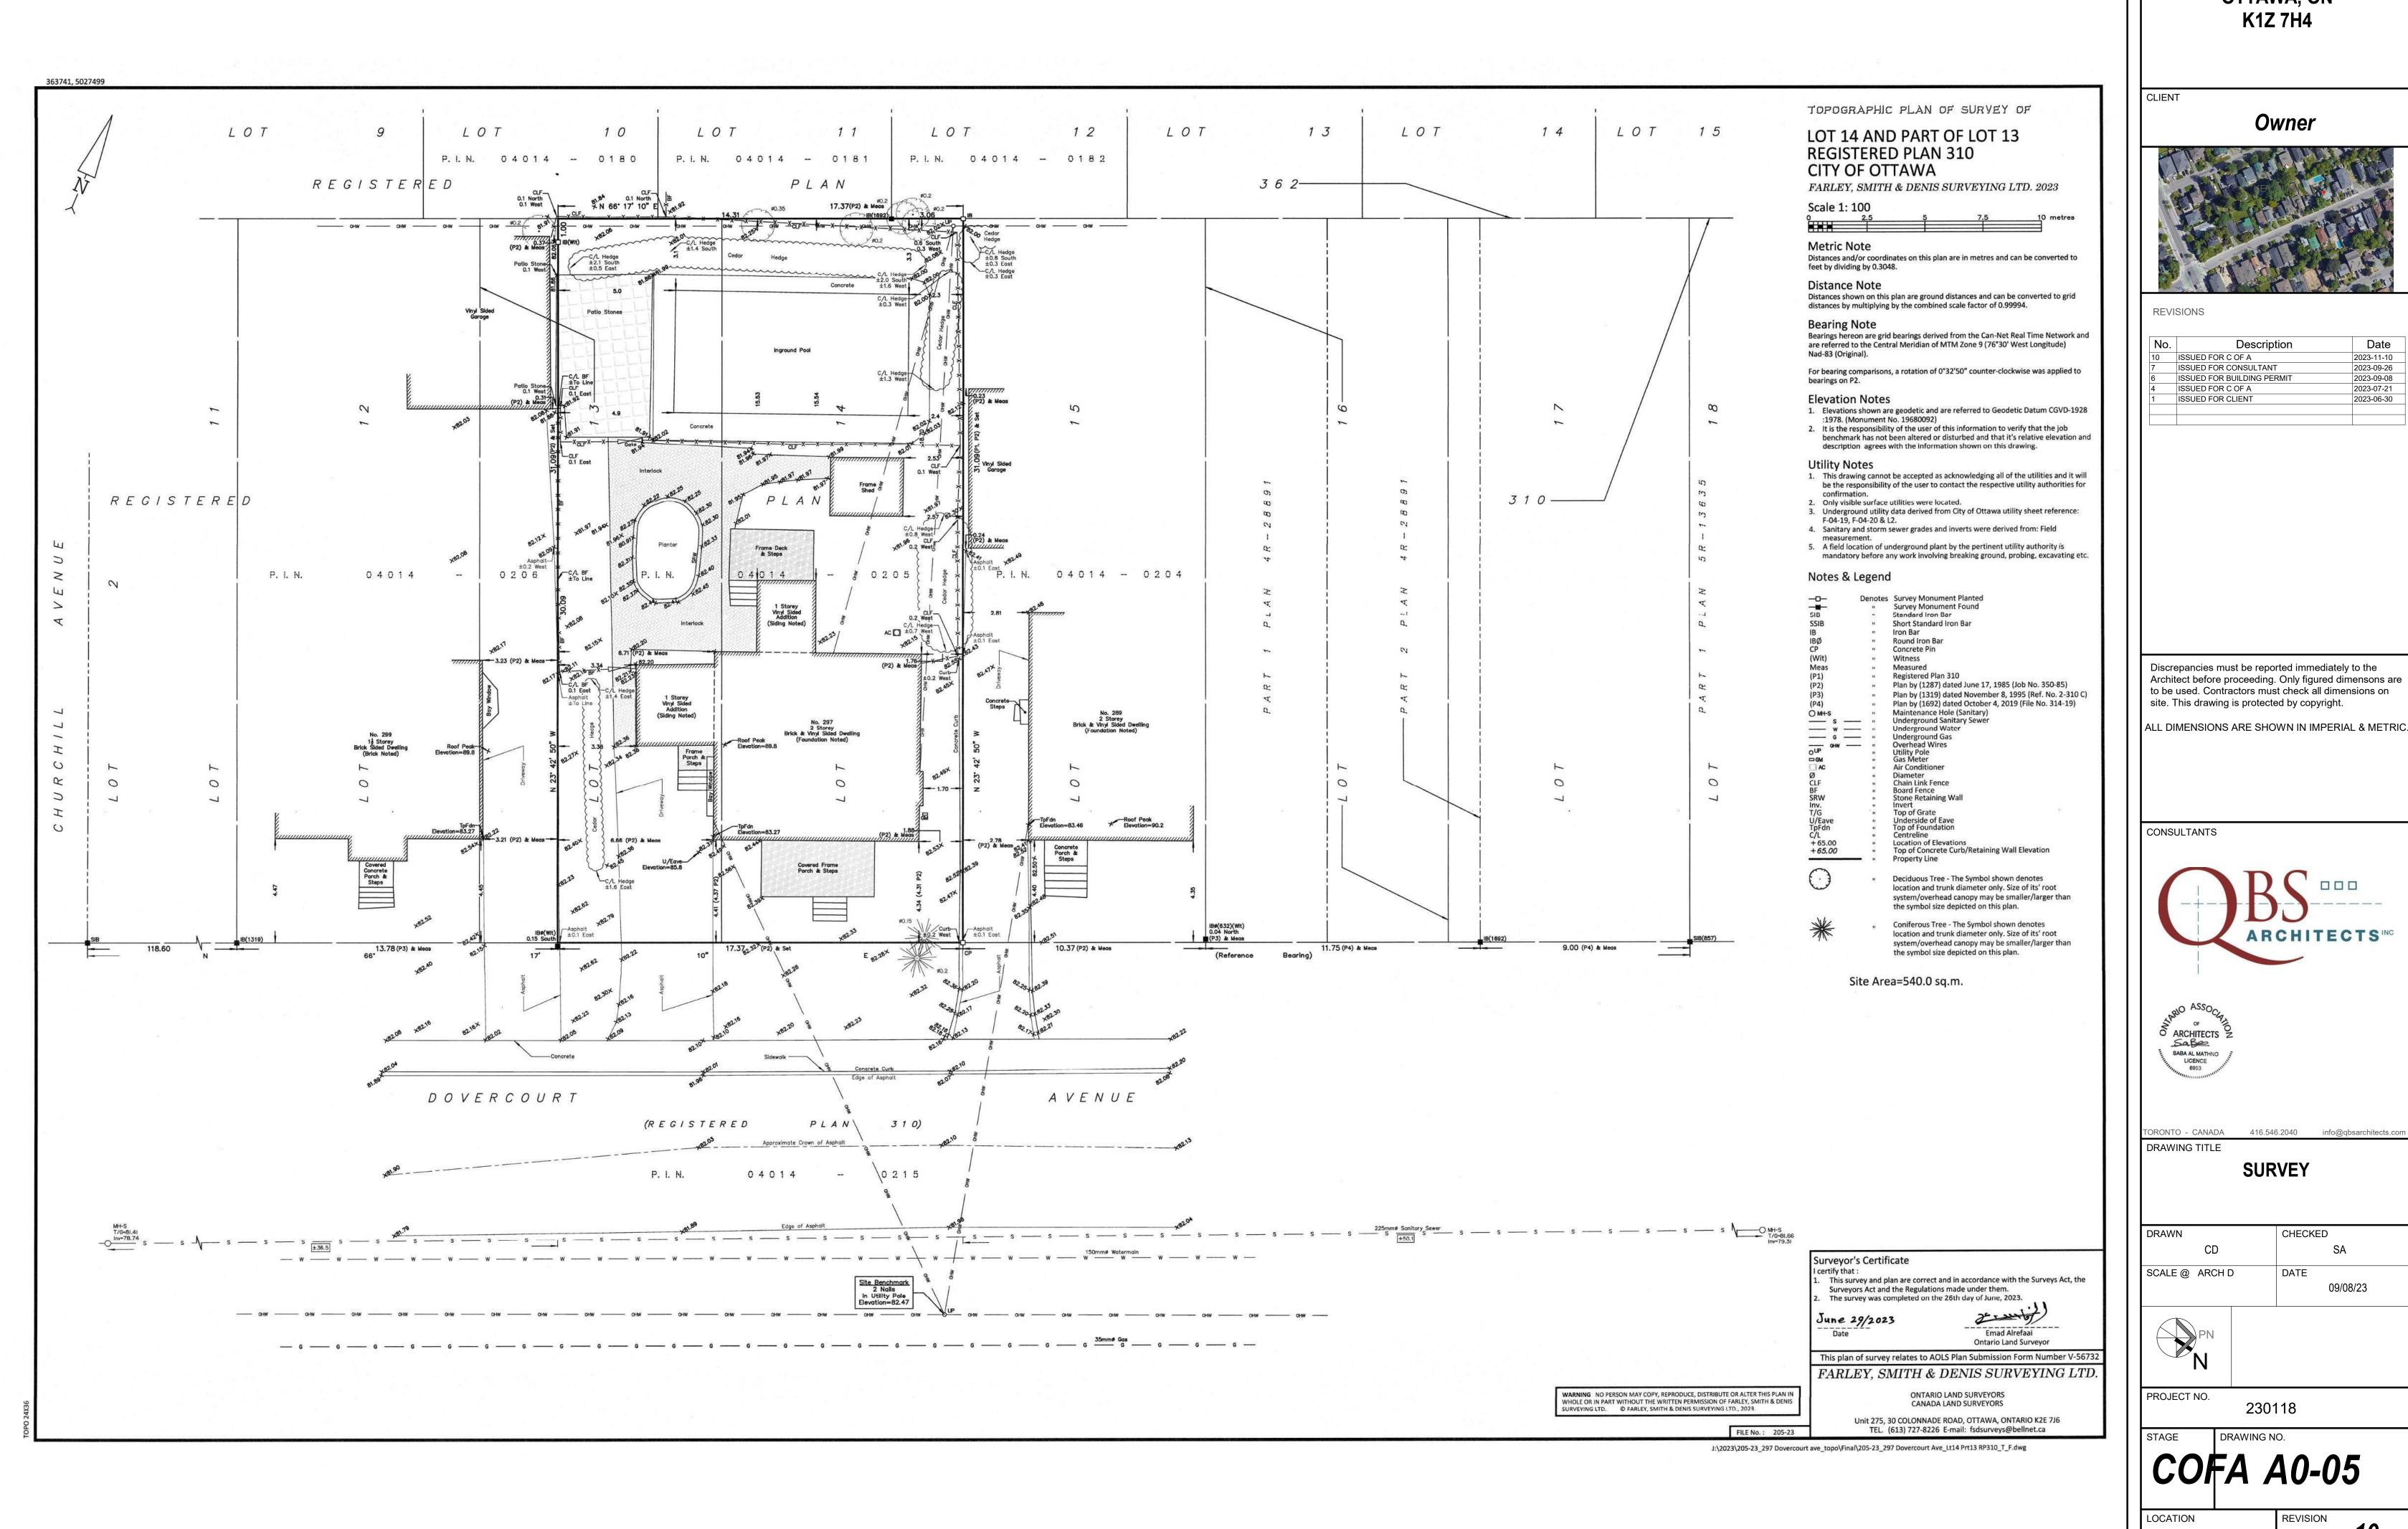

295 DOVERCOURT AVE OTTAWA, ON

No.	Description	Date
)	ISSUED FOR C OF A	2023-11-10
	ISSUED FOR CONSULTANT	2023-09-26
	ISSUED FOR BUILDING PERMIT	2023-09-08
	ISSUED FOR C OF A	2023-07-21
	ISSUED FOR CLIENT	2023-06-30

OTTAWA

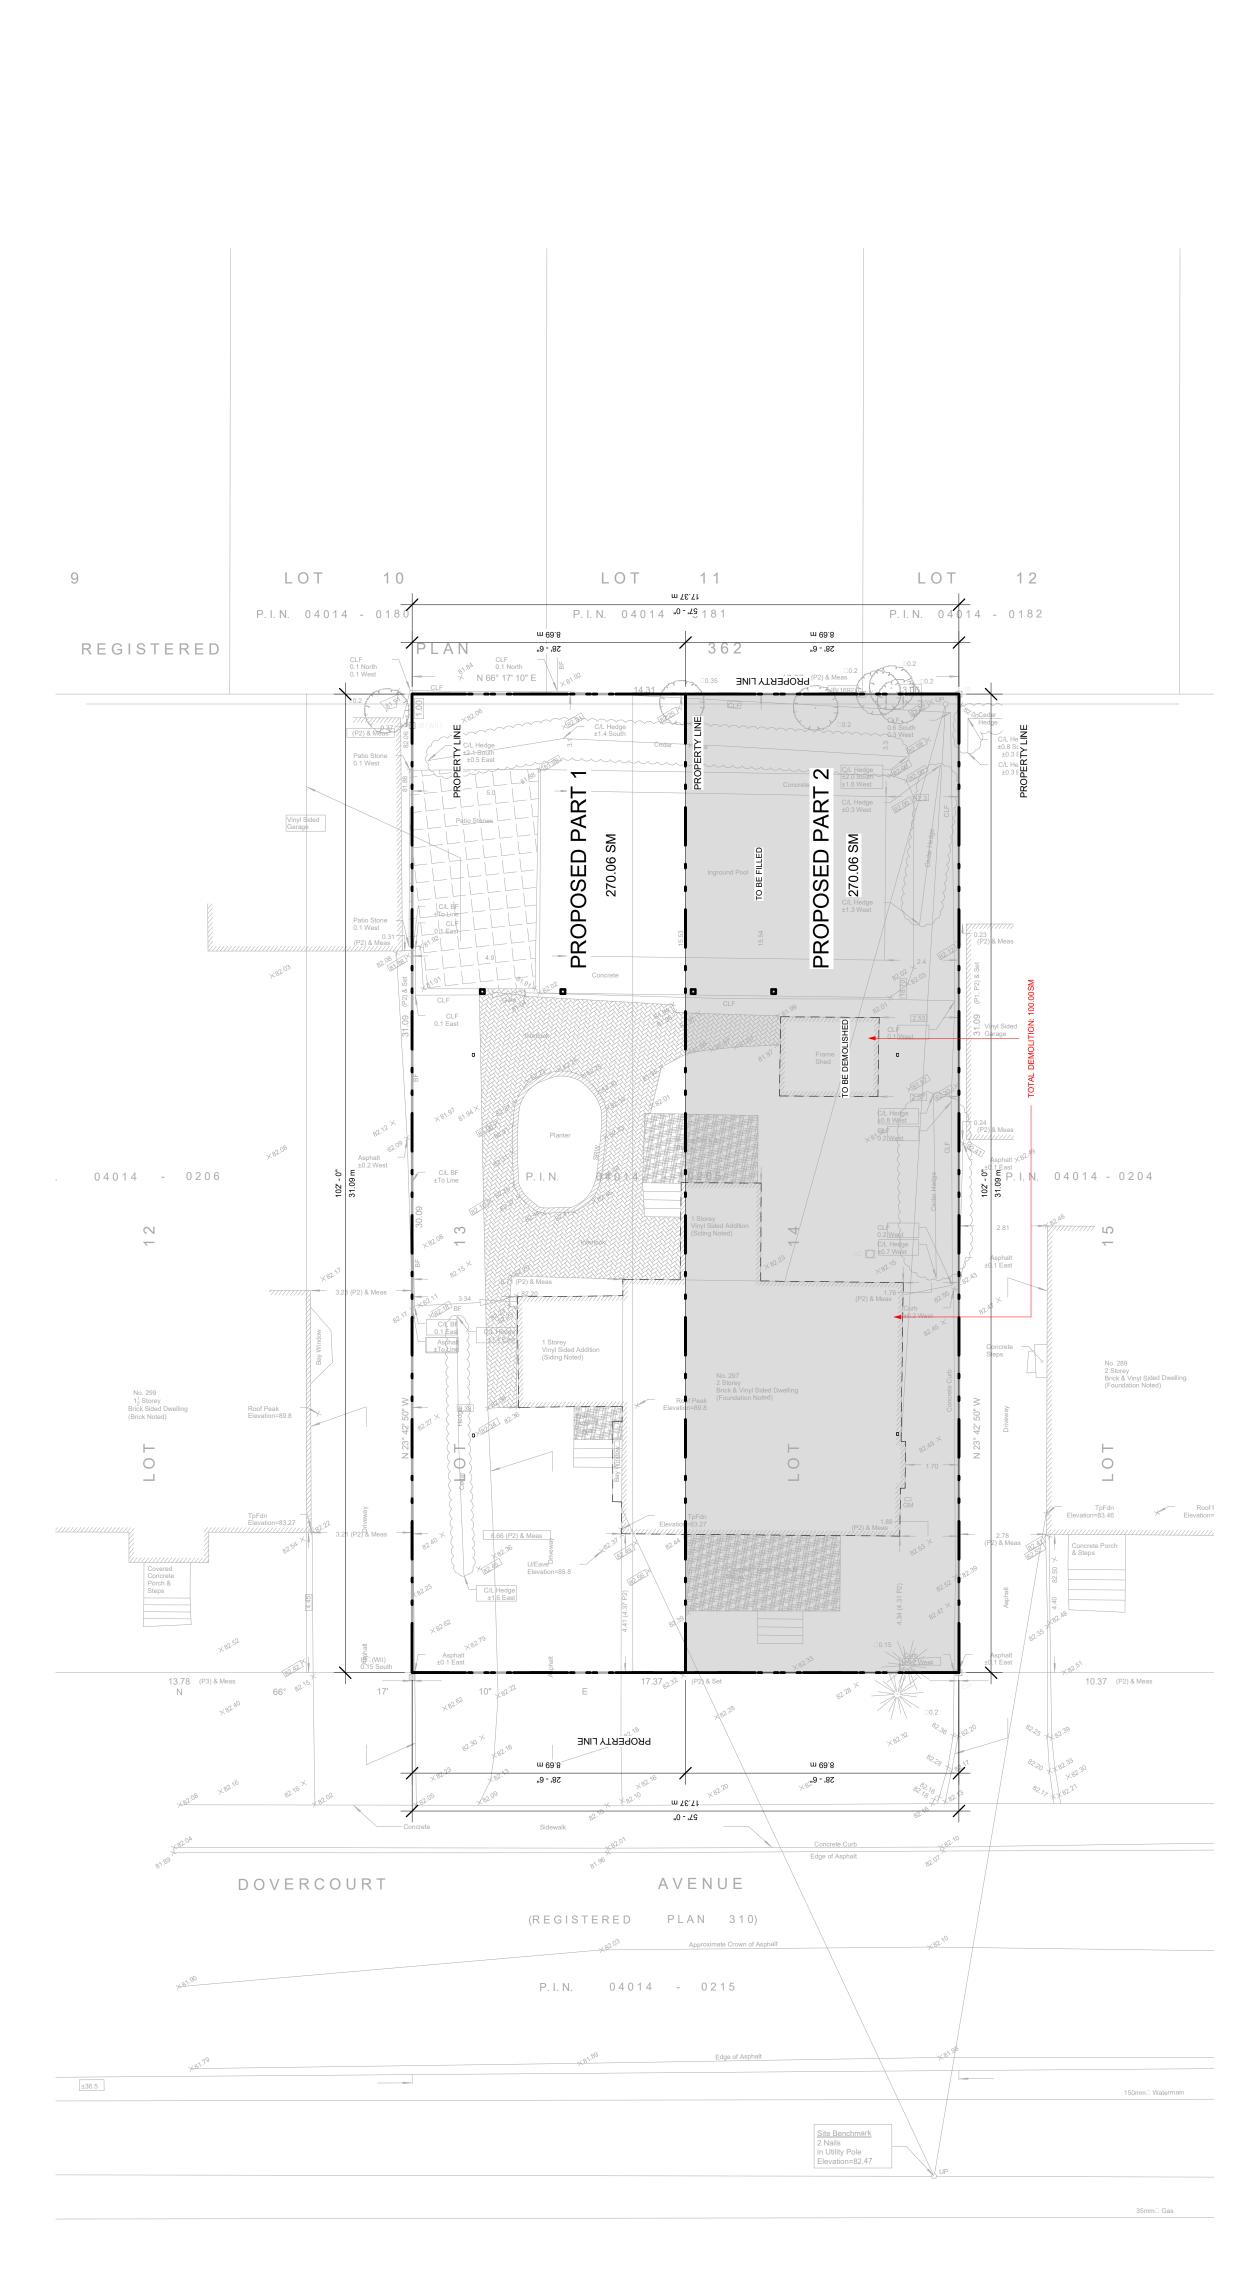

R PLAN

ALL DIMENSIONS ARE SHOWN IN IMPERIAL & METRIC. Discrepancies must be reported immediately to the Architect before proceeding. Only figured dimensons are to be used. Contractors must check all dimensions on site. This drawing is protected by copyright. Date 2023-12-04 2023-11-10 2023-09-26 2023-09-08 2023-07-21 2023-07-17 2023-06-30 PROJECT AVE 295 DOVERCOURT AVE OTTAWA, ON K1Z 7H4 PROPOSED R PLAN Owner Description
ISSUED FOR DEMO
ISSUED FOR C OF A
ISSUED FOR CONSULTANT
ISSUED FOR BUILDING PERMIT
ISSUED FOR C OF A
ISSUED FOR C LIENT
ISSUED FOR CLIENT SARCHITECTS 2
SABAAL MATHNO
LICENCE
LI CD CONSULTANTS REVISIONS DRAWN

SA CHECKED DATE


09/08/23

SCALE @ ARCH D 1" = 10'-0" Z

230118 PROJECT NO.

40-06


11 REVISION LOCATION

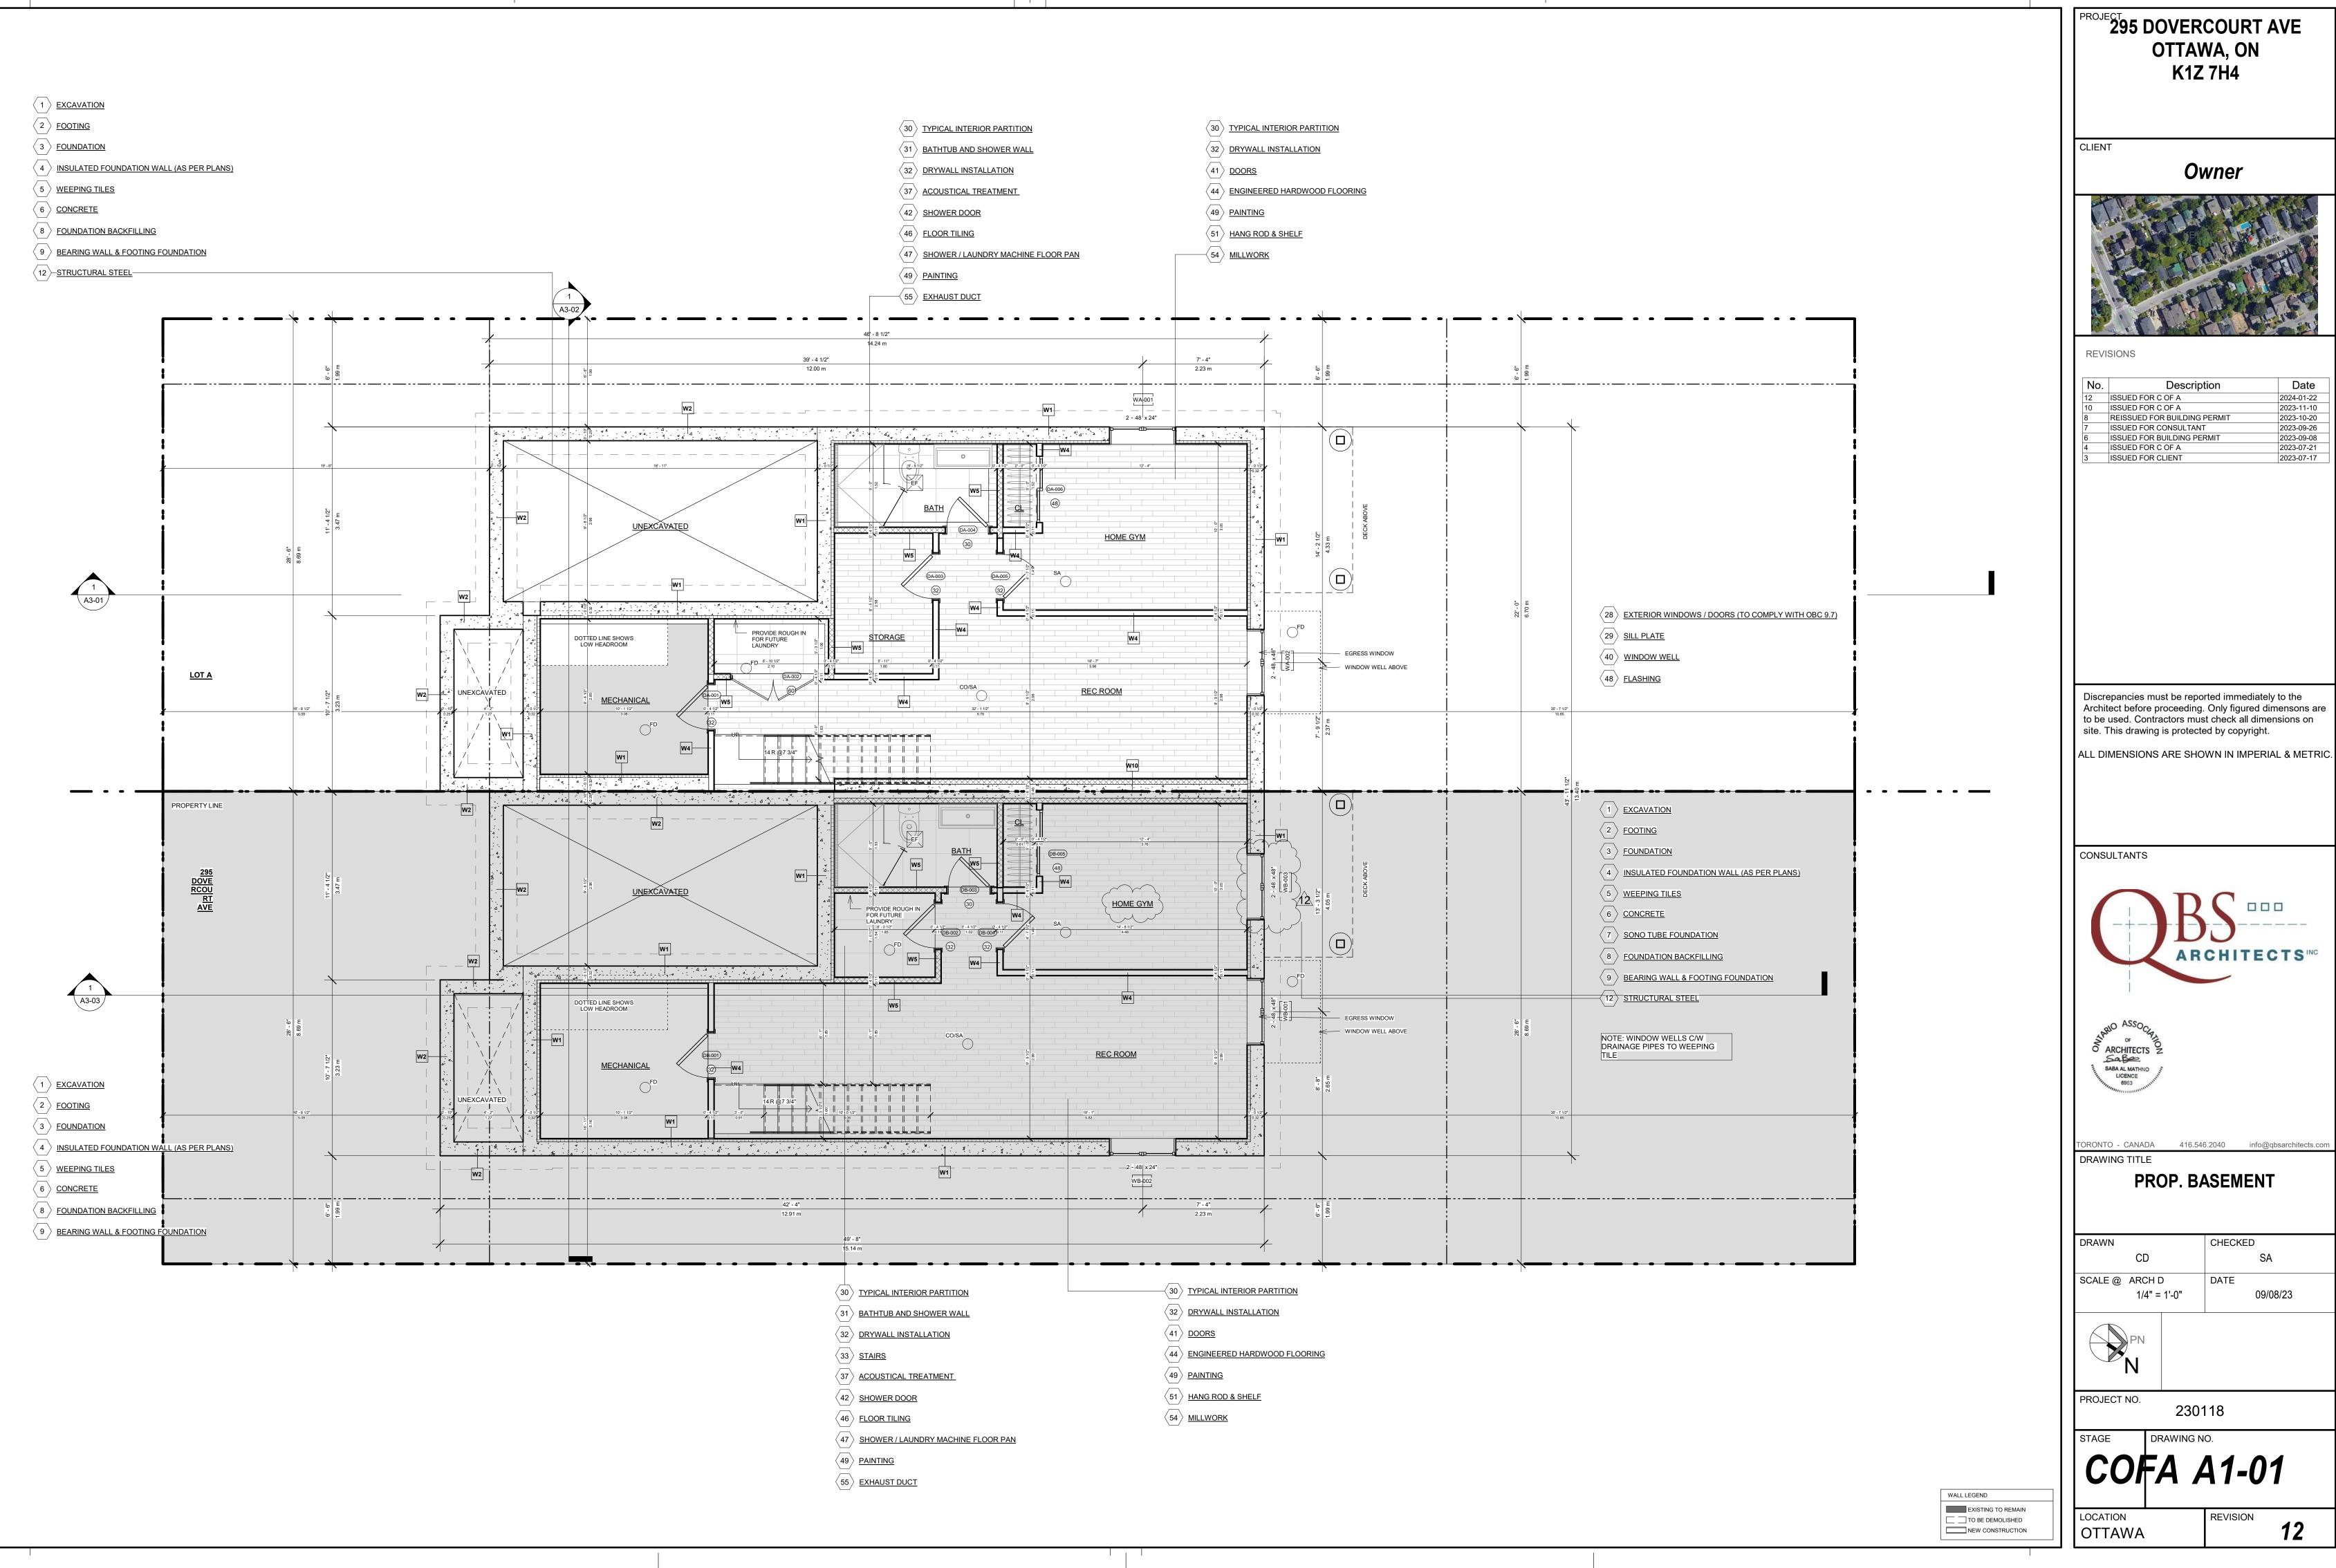





No.	Description	Date
12	ISSUED FOR C OF A	2024-01-22
10	ISSUED FOR C OF A	2023-11-10
8	REISSUED FOR BUILDING PERMIT	2023-10-20
7	ISSUED FOR CONSULTANT	2023-09-26
6	ISSUED FOR BUILDING PERMIT	2023-09-08
4	ISSUED FOR C OF A	2023-07-21
3	ISSUED FOR CLIENT	2023-07-17

ALL DIMENSIONS ARE SHOWN IN IMPERIAL & METRIC

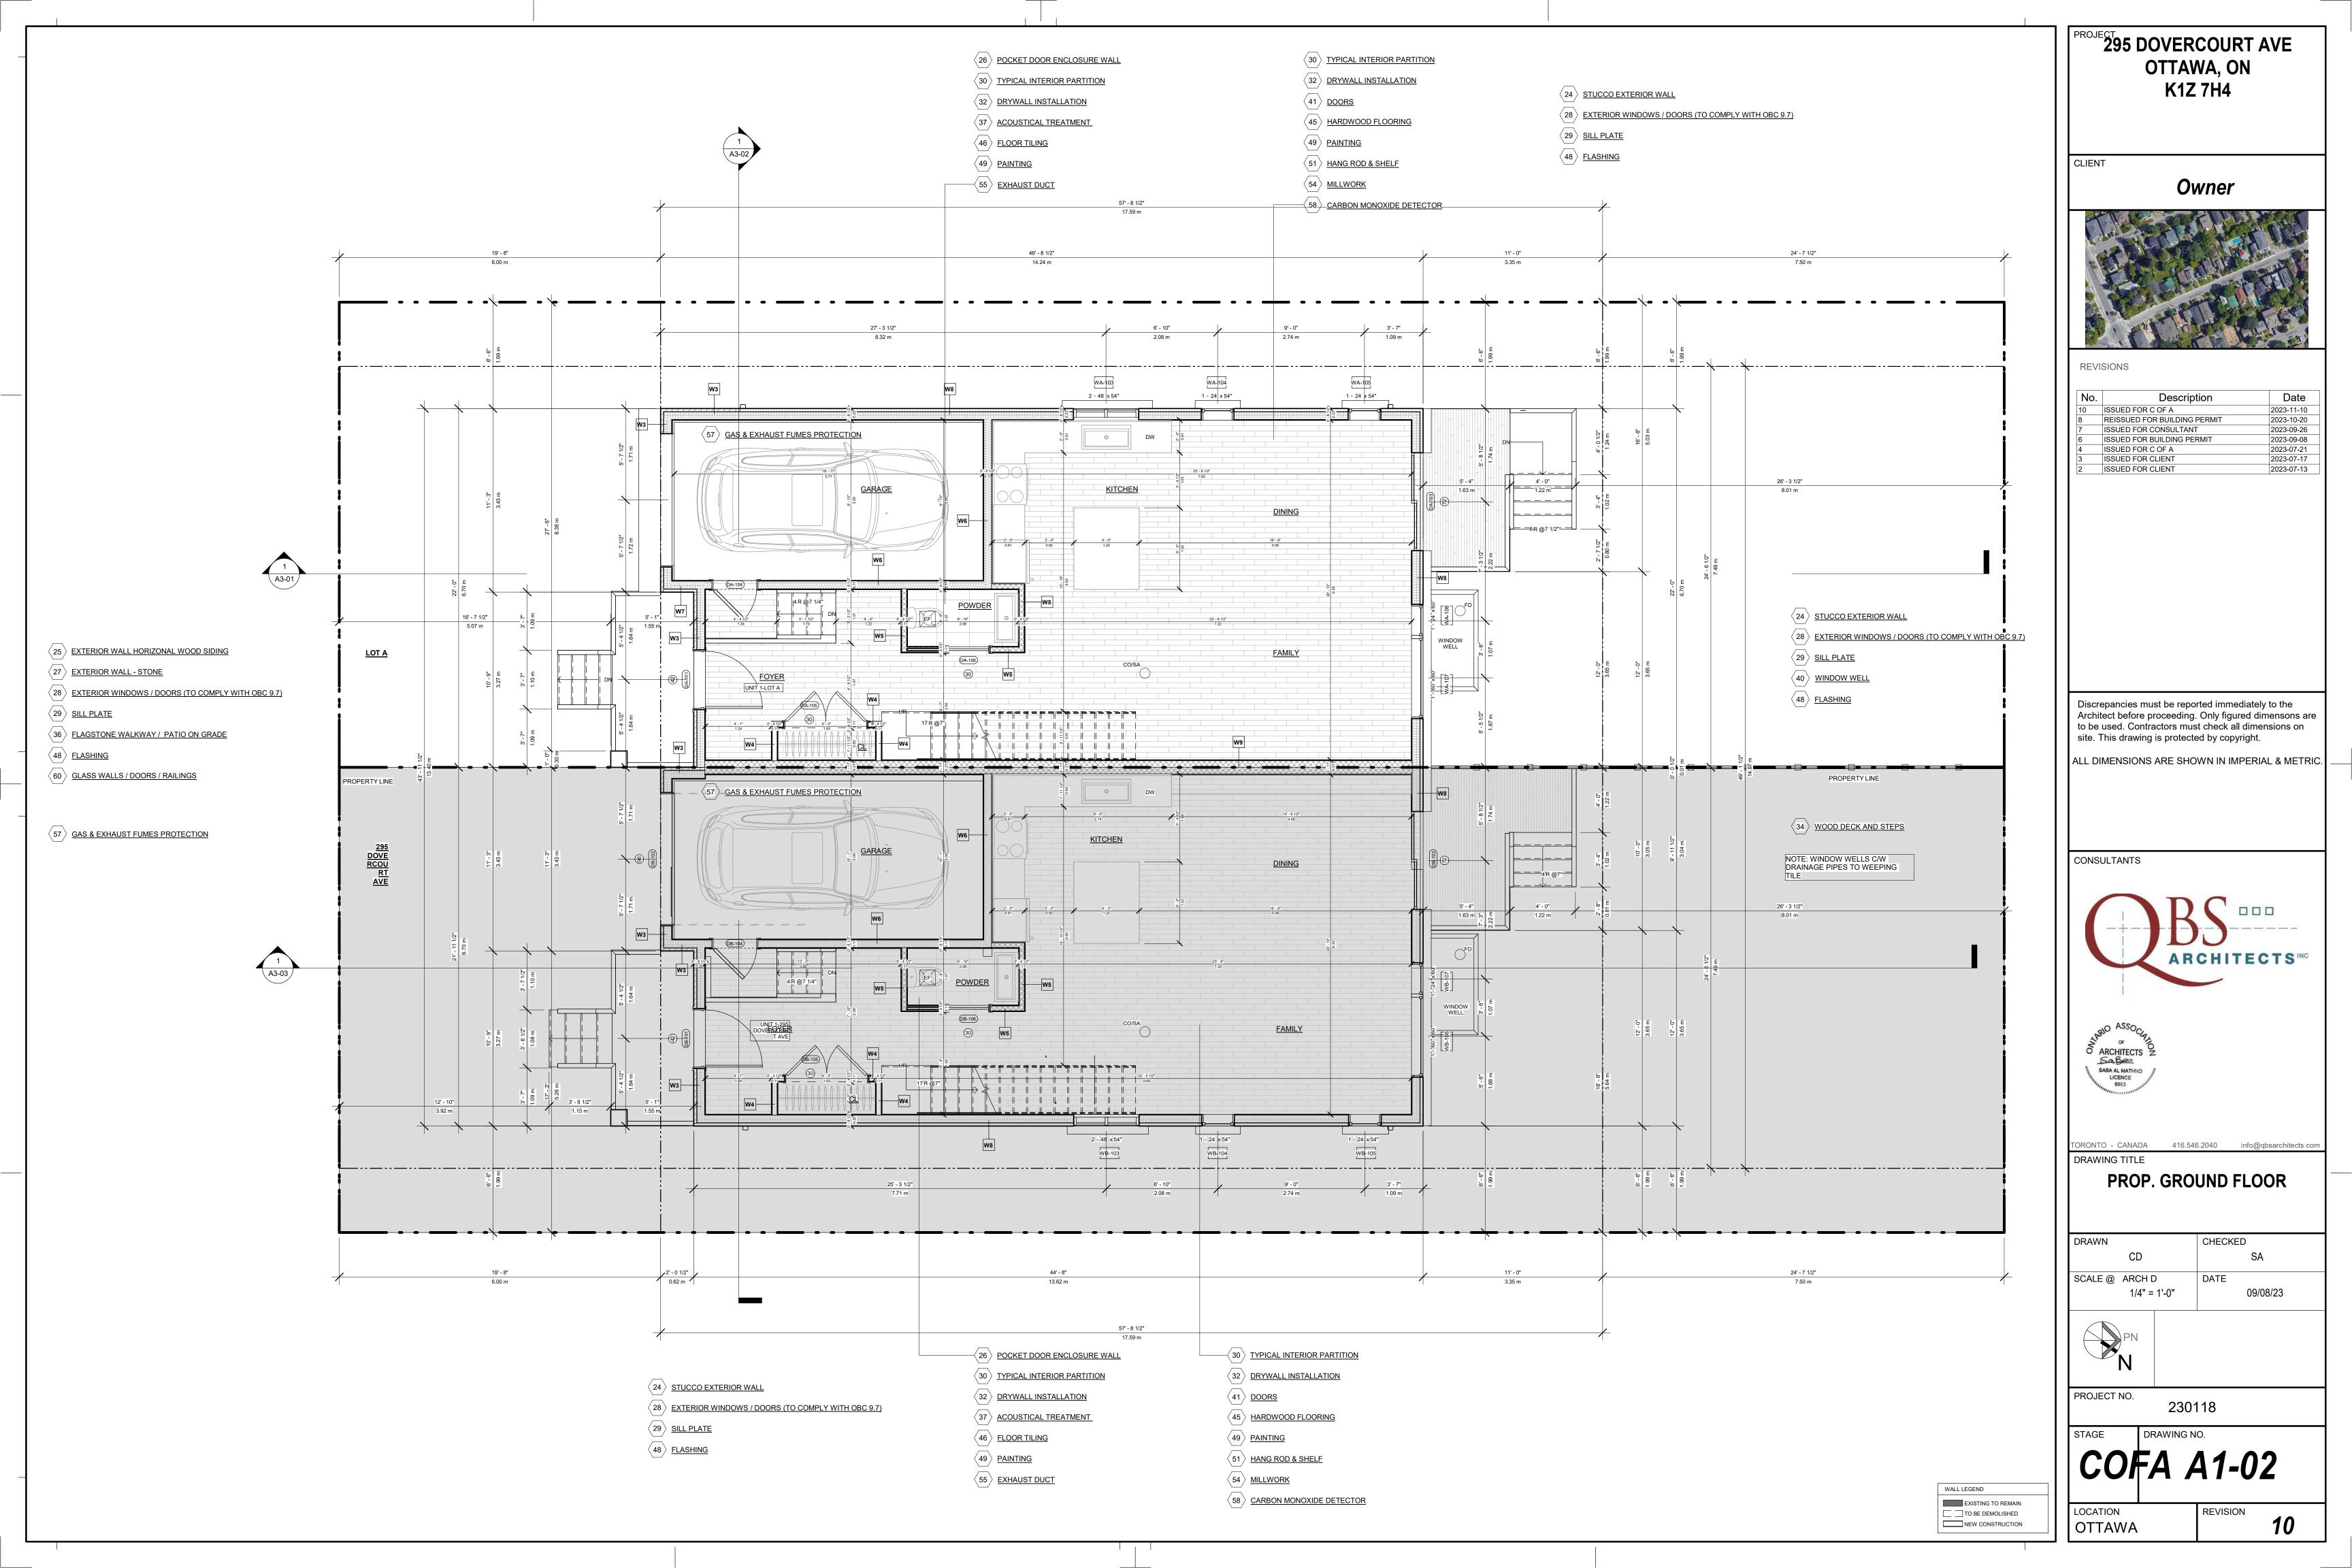

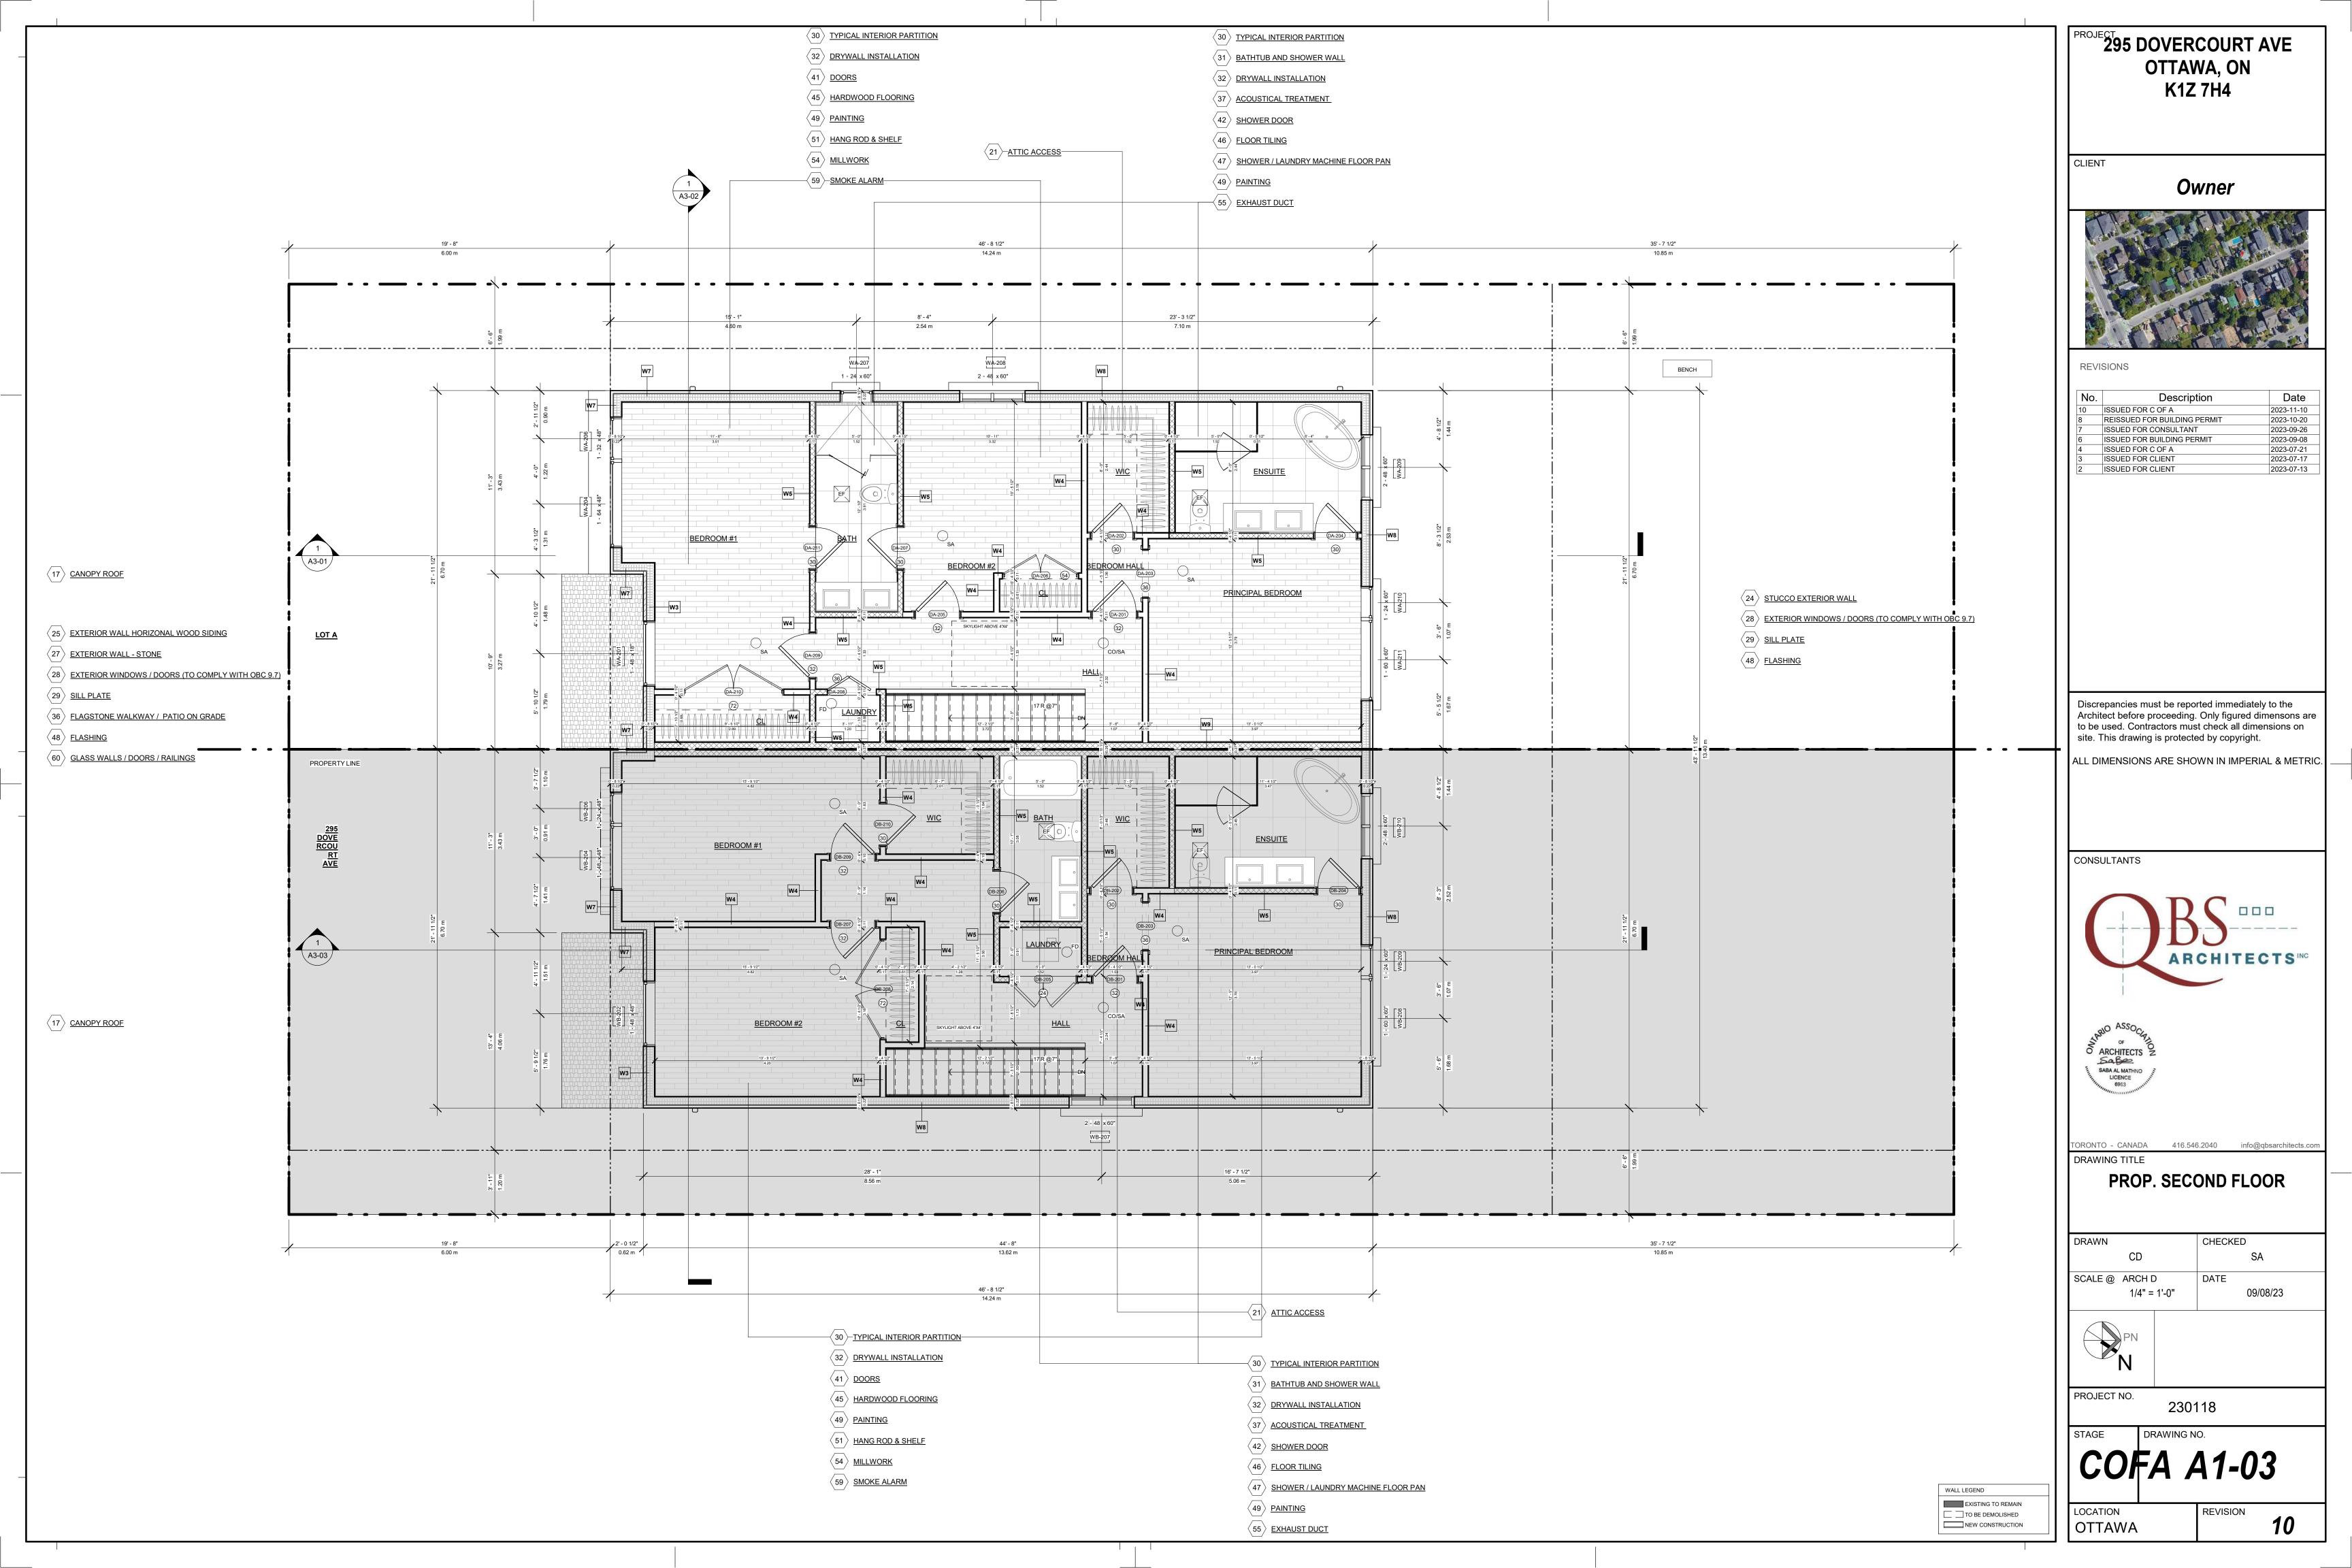

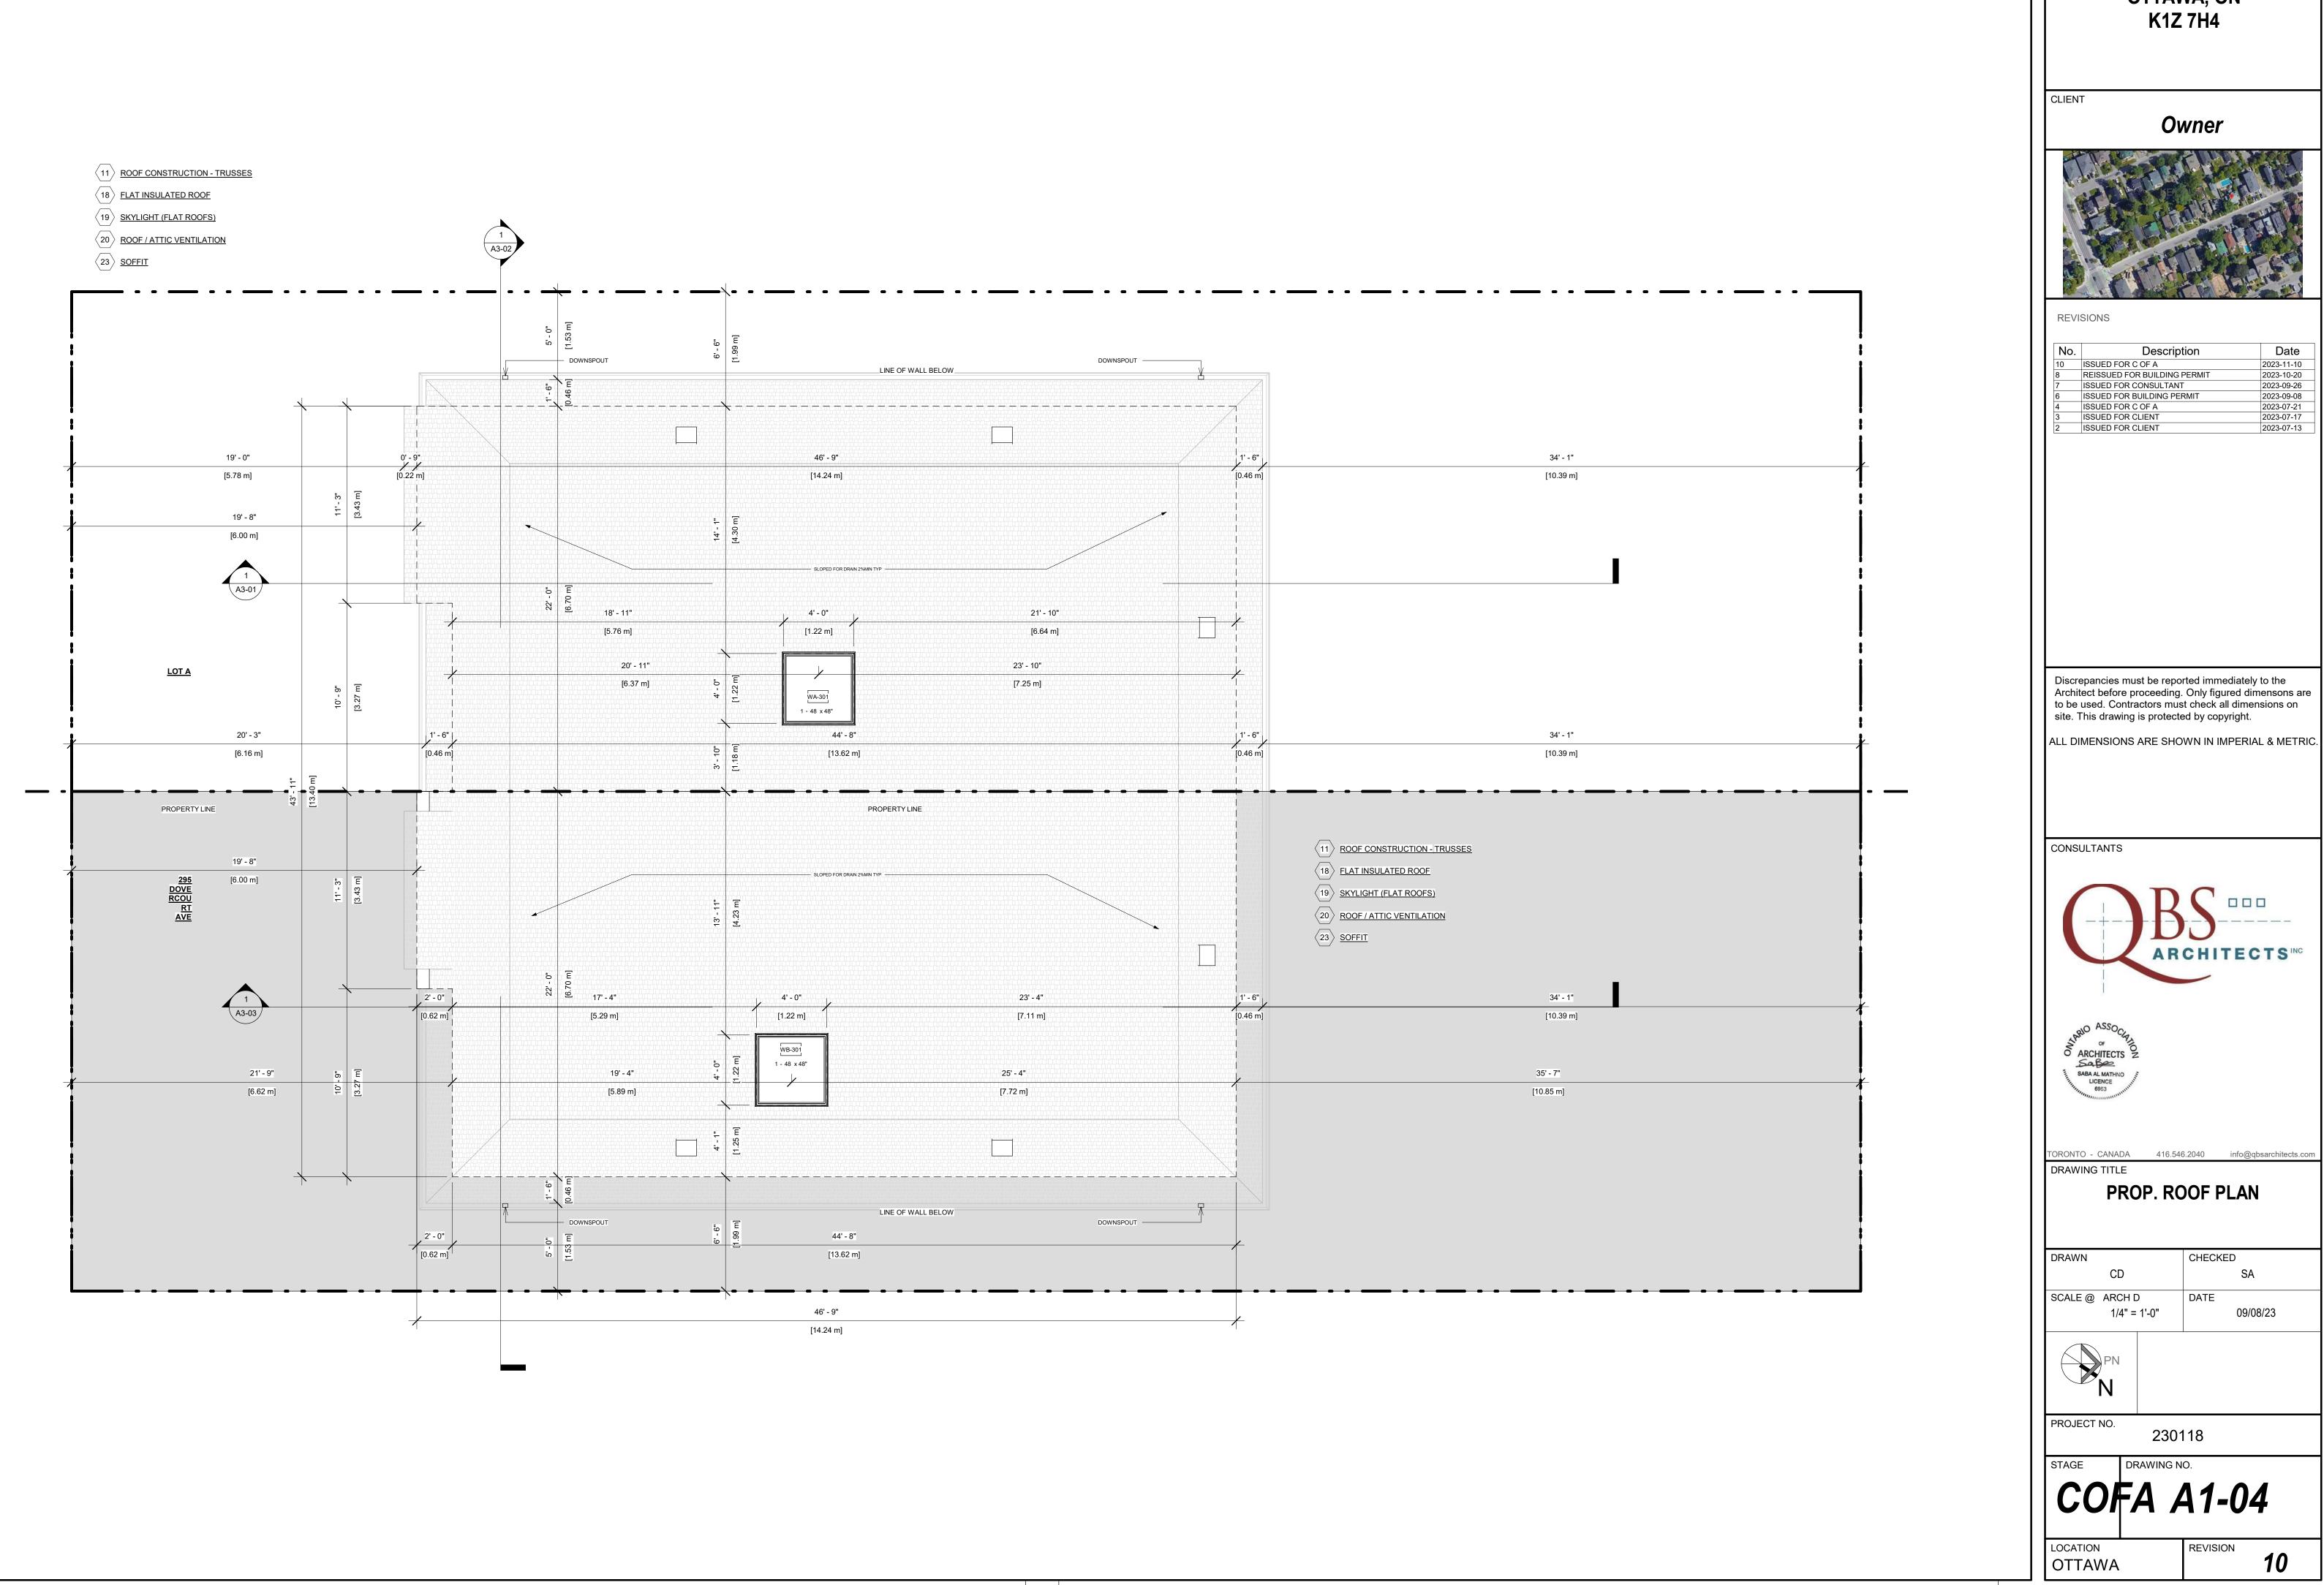



No.	Description	Date
0	ISSUED FOR C OF A	2023-11-10
	REISSUED FOR BUILDING PERMIT	2023-10-20
	ISSUED FOR CONSULTANT	2023-09-26
	ISSUED FOR BUILDING PERMIT	2023-09-08
	ISSUED FOR C OF A	2023-07-21
	ISSUED FOR CLIENT	2023-07-17
	ISSUED FOR CLIENT	2023-07-13



CLIENT

NOTE: ENSURE ADEQUATE ROOF SEPARATION TO ALLOW FOR FASCIA AND EAVES TROUGH @ LOWER ROOF.

Owner



REVISIONS

No.	Description	Date
0	ISSUED FOR C OF A	2023-11-10
}	REISSUED FOR BUILDING PERMIT	2023-10-20
,	ISSUED FOR CONSULTANT	2023-09-26
6	ISSUED FOR BUILDING PERMIT	2023-09-08
5	ISSUED FOR CONSULTANTS	2023-08-08
	ISSUED FOR C OF A	2023-07-21
}	ISSUED FOR CLIENT	2023-07-17

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PROP. FRONT ELEVATION


DRAWN	CHECKED
CD	SA
SCALE @ ARCH D As indicated	DATE 09/08/23

PROJECT NO. **230118**

STAGE DRAWING NO.

COFA A2-01

LOCATION REVISION
OTTAWA

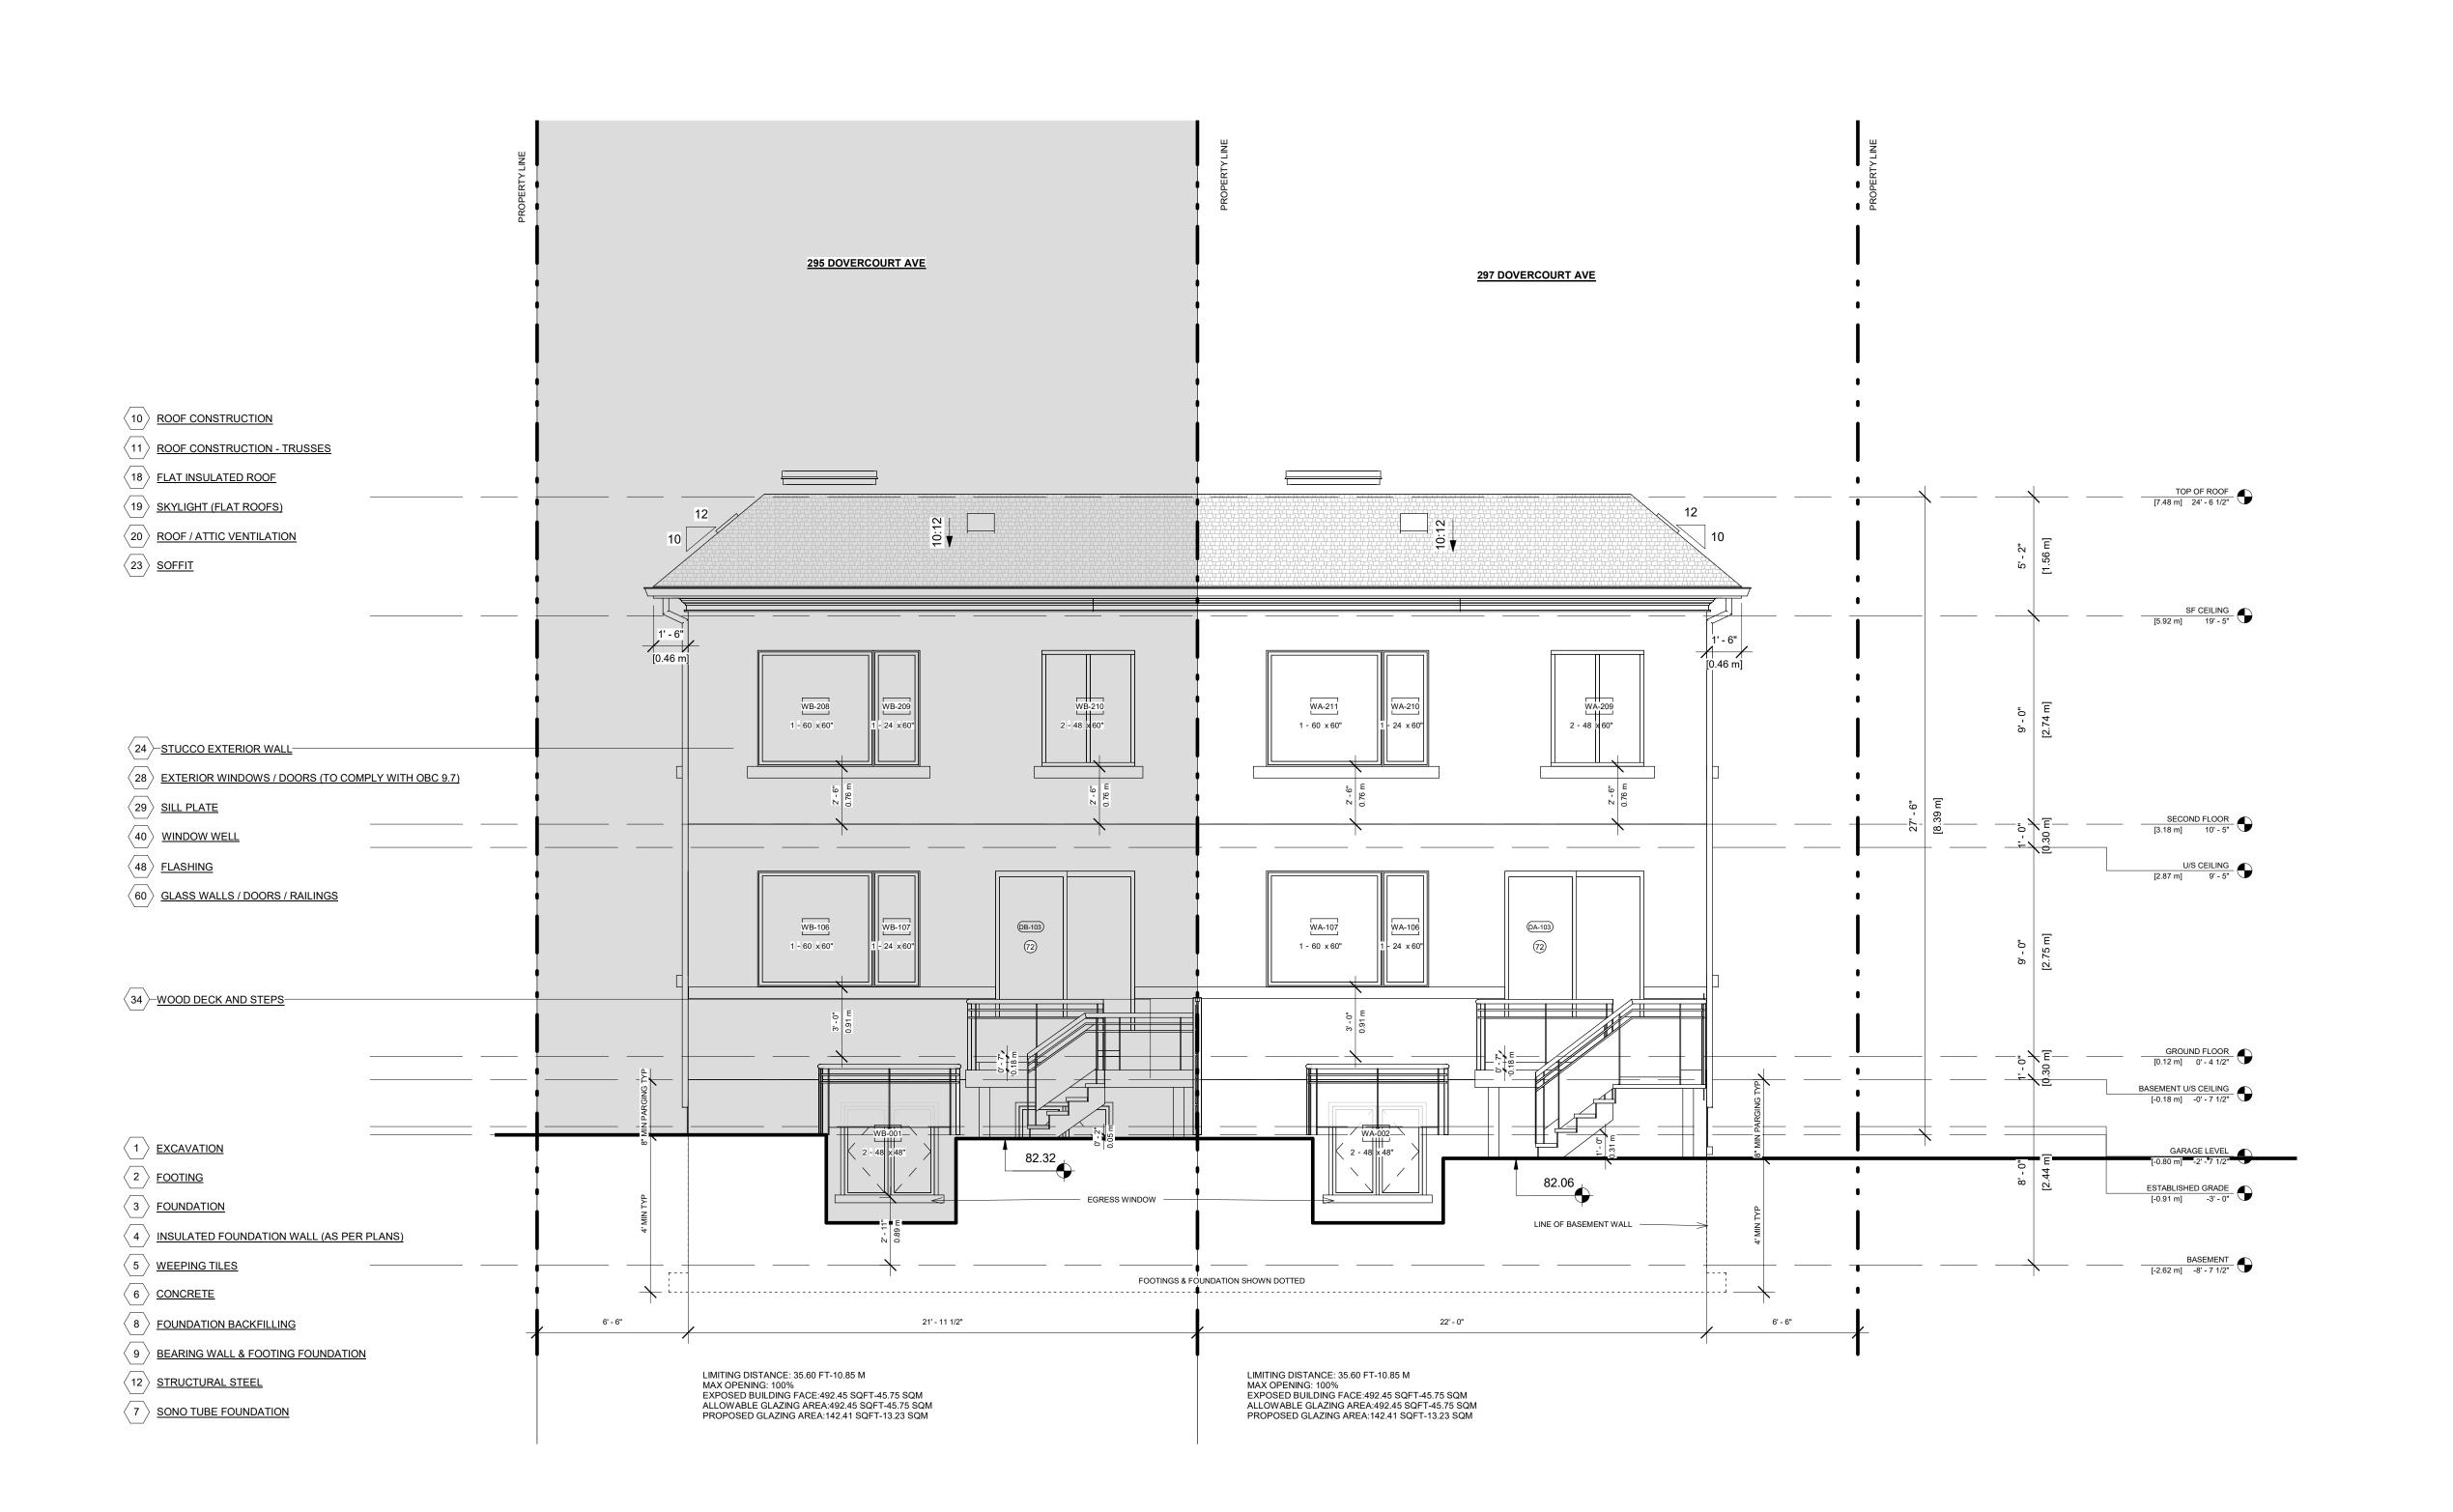

Owner



REVISIONS

No.	Description	Date
10	ISSUED FOR C OF A	2023-11-10
8	REISSUED FOR BUILDING PERMIT	2023-10-20
7	ISSUED FOR CONSULTANT	2023-09-26
6	ISSUED FOR BUILDING PERMIT	2023-09-08
5	ISSUED FOR CONSULTANTS	2023-08-08
4	ISSUED FOR C OF A	2023-07-21
3	ISSUED FOR CLIENT	2023-07-17

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PROP. REAR ELEVATION

DRAWN		CHECKE)
CD			SA
SCALE @ ARCH [)	DATE	
1/4" =	1'-0"		09/08/23


PROJECT NO.

230118

DRAWING NO. STAGE

COFA A2-02

LOCATION REVISION OTTAWA

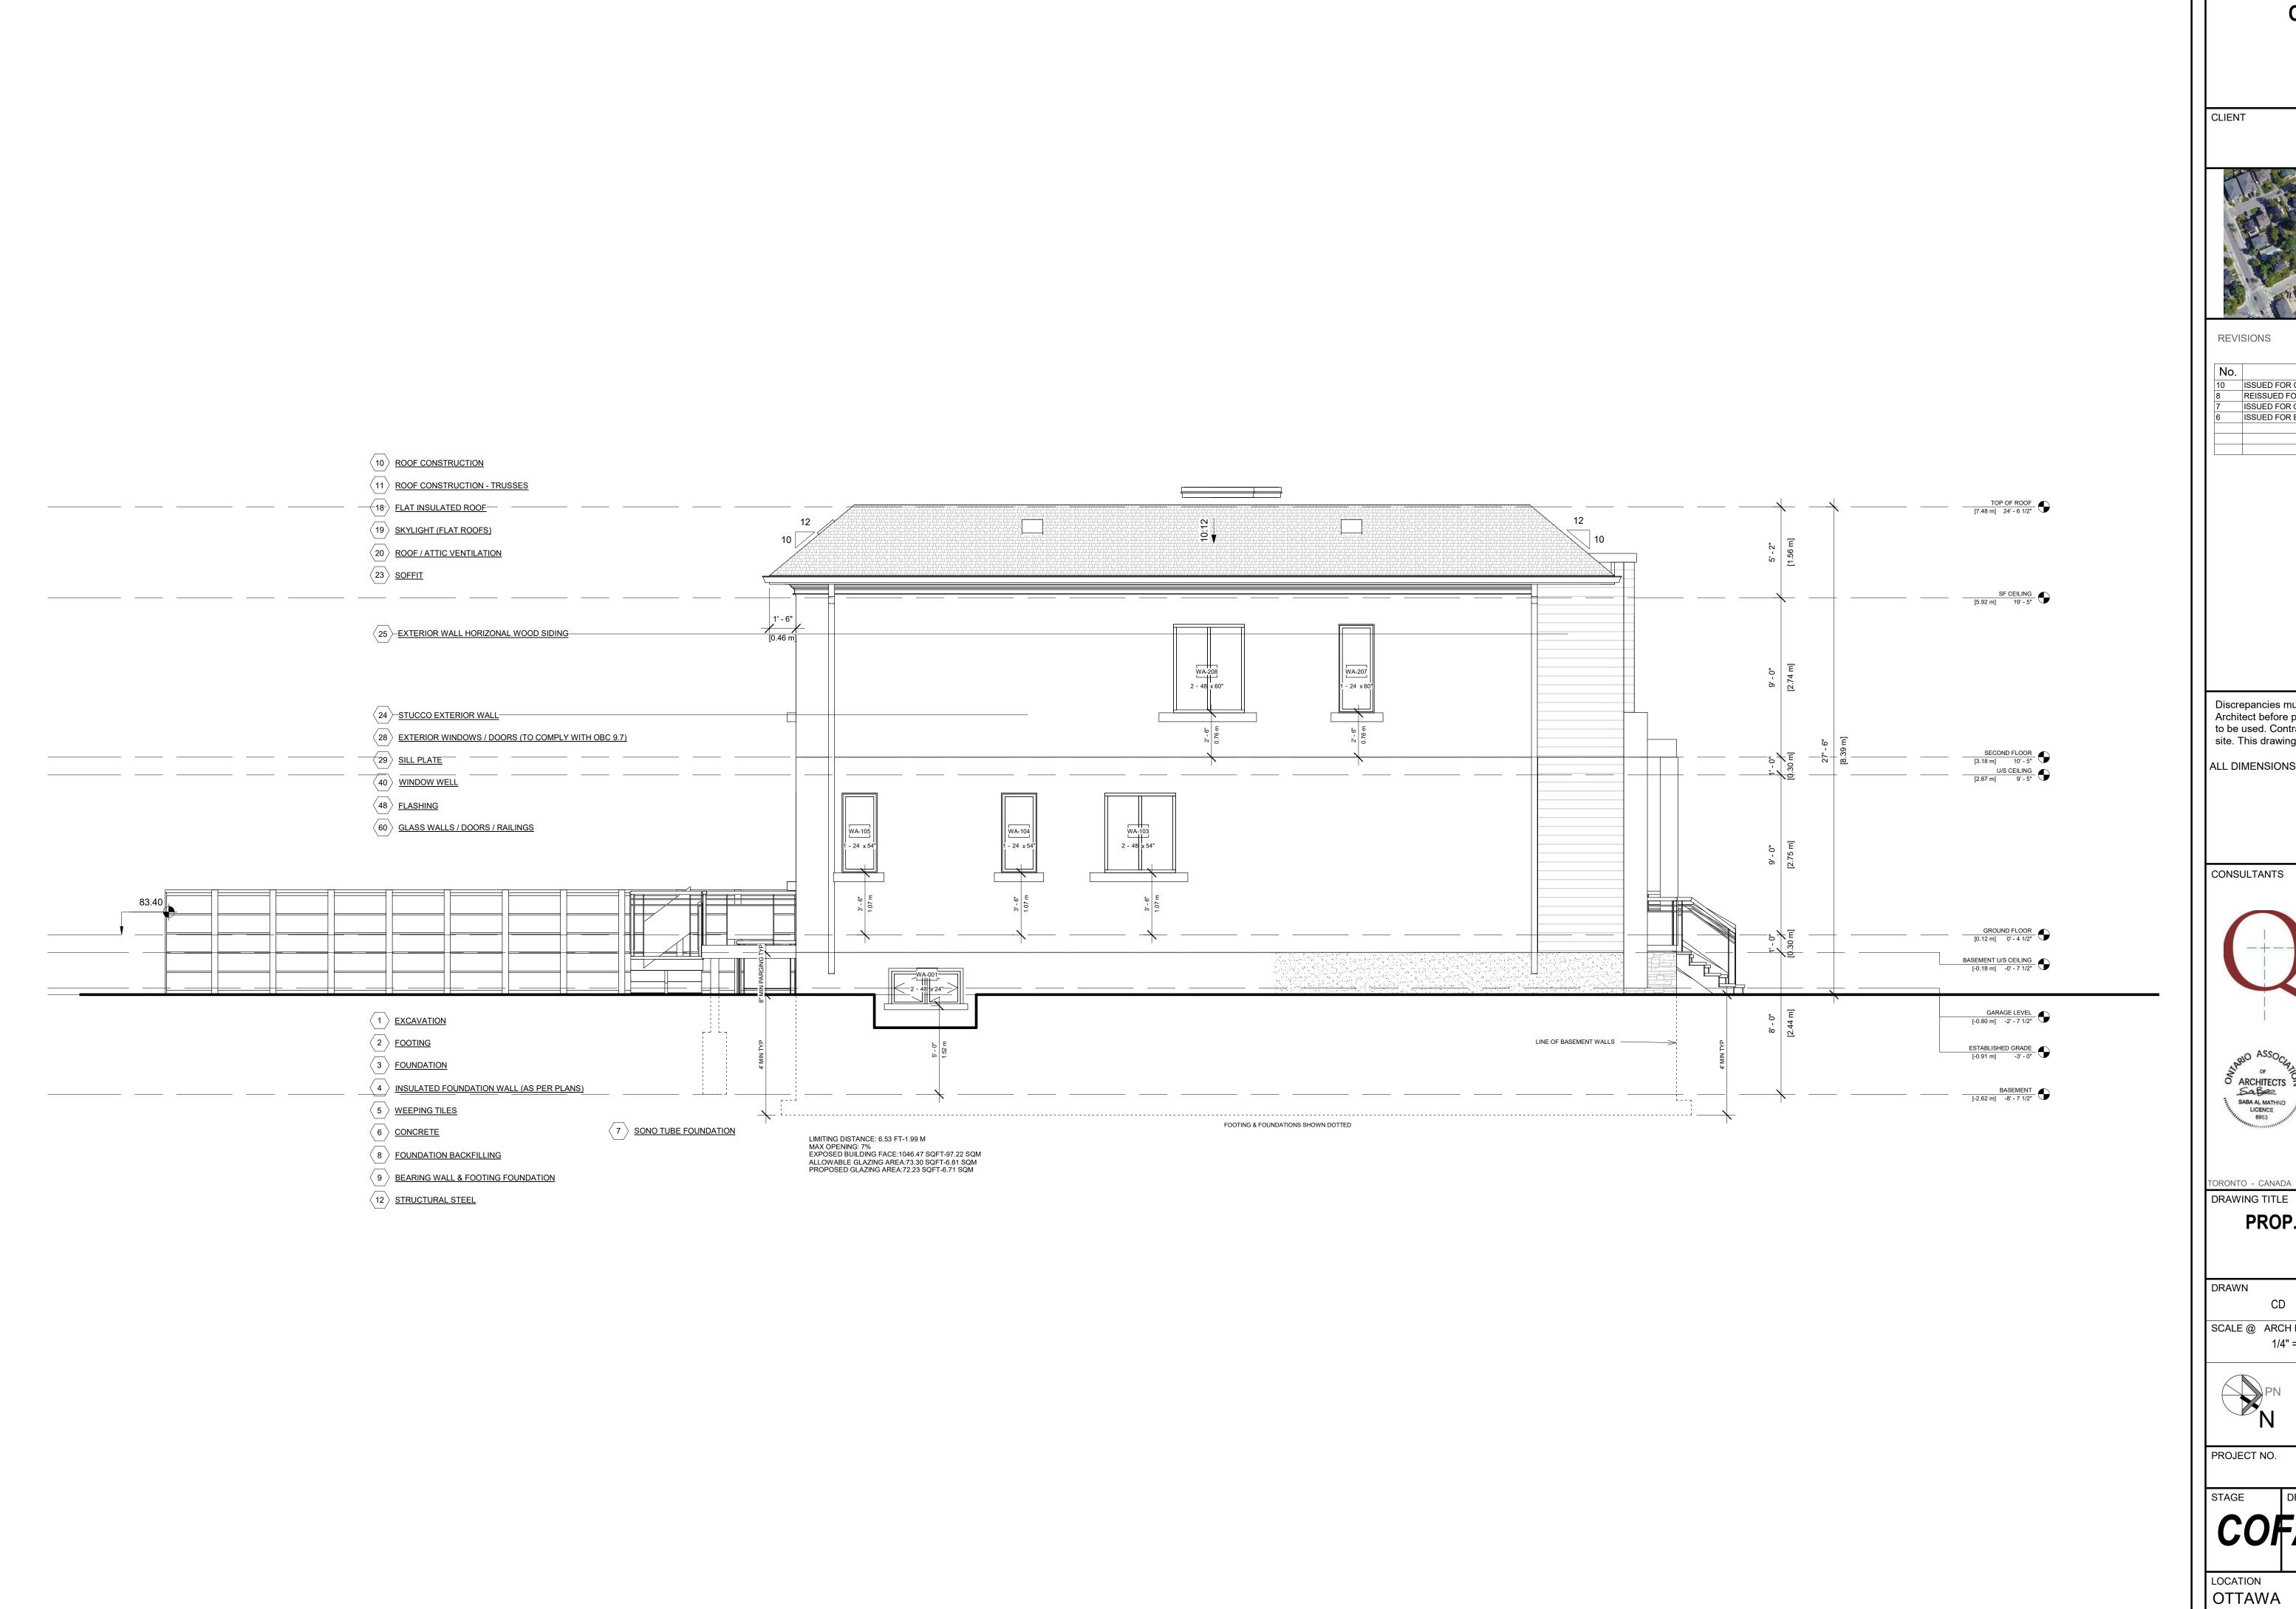

Owner



REVISIONS

No.	Description	Date
10	ISSUED FOR C OF A	2023-11-10
8	REISSUED FOR BUILDING PERMIT	2023-10-20
7	ISSUED FOR CONSULTANT	2023-09-26
6	ISSUED FOR BUILDING PERMIT	2023-09-08

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PROP. LEFT ELEVATION

	DRAWN	CHECKED
	CD	SA
	SCALE @ ARCH D	DATE
	1/4" = 1'-0"	09/08/23




PROJECT NO.

STAGE DRAWING NO.

COFA A2-03

230118

LOCATION REVISION

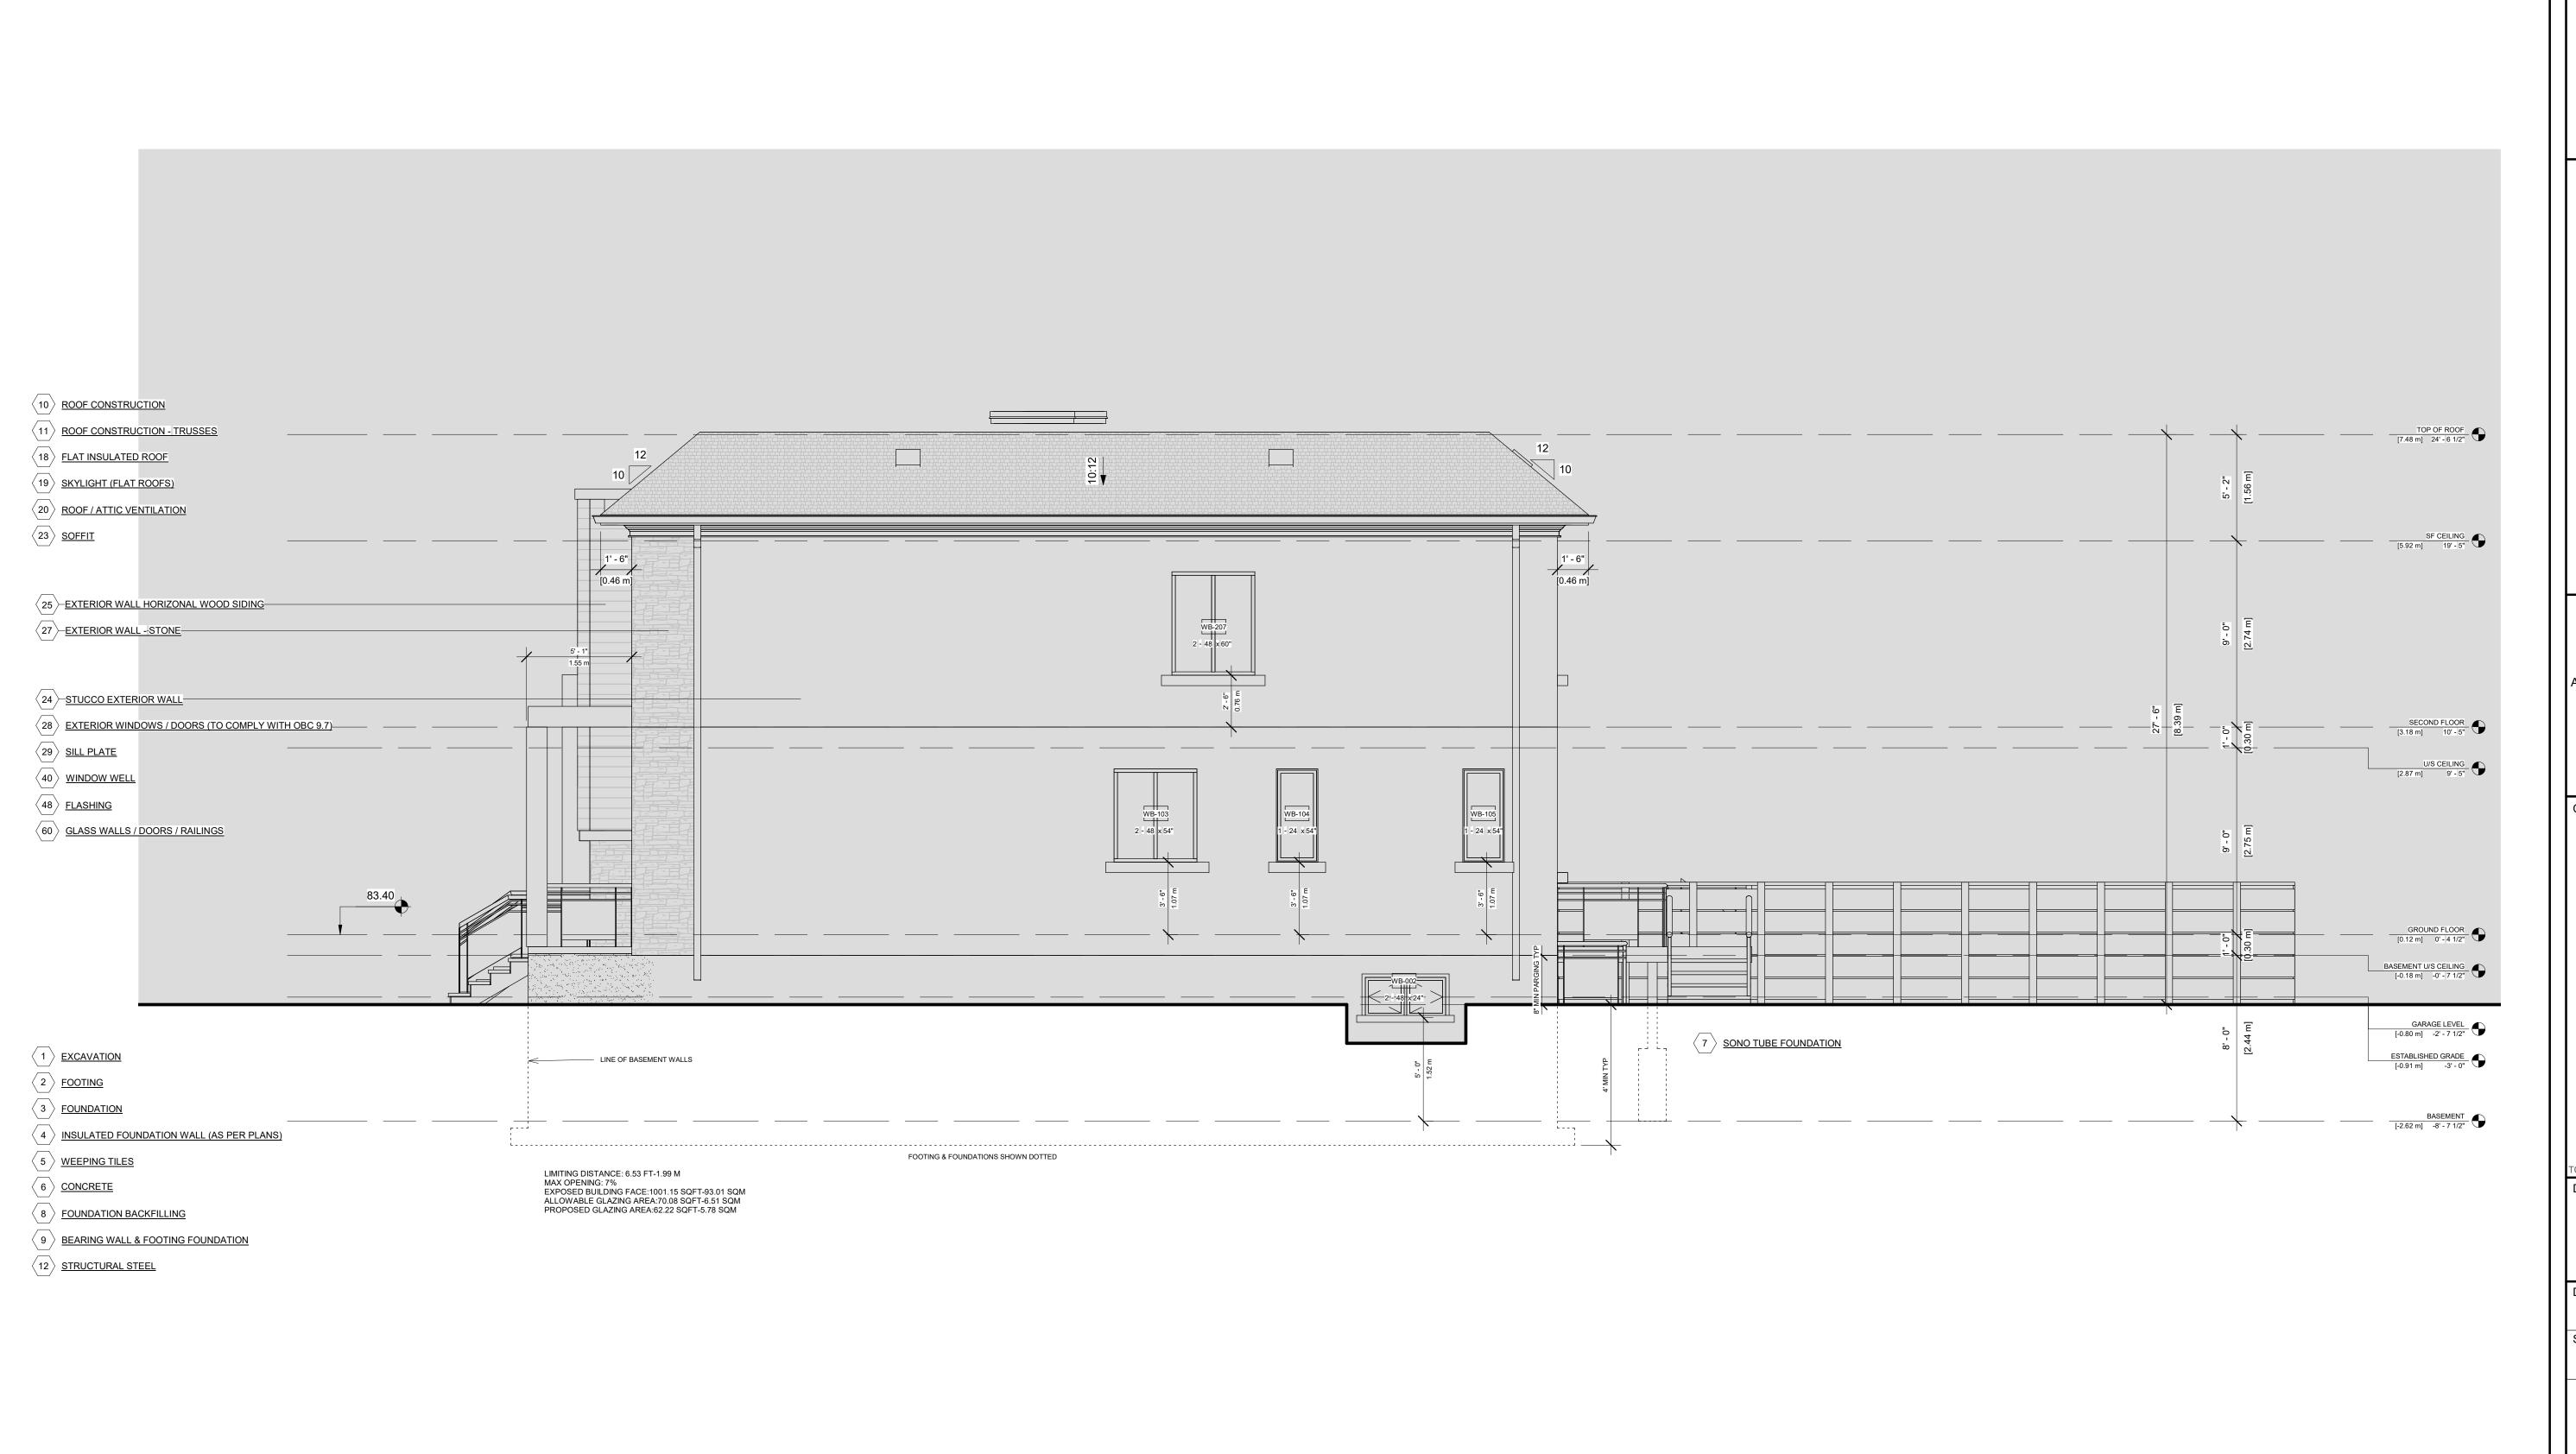

Owner



REVISIONS

No.	Description	Date
10	ISSUED FOR C OF A	2023-11-10
8	REISSUED FOR BUILDING PERMIT	2023-10-20
7	ISSUED FOR CONSULTANT	2023-09-26
6	ISSUED FOR BUILDING PERMIT	2023-09-08

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TORONTO - CANADA 416.546.2040 info@qbsarchitects.co DRAWING TITLE

CHECKED

PROP. RIGHT ELEVATION

CD			SA	
SCALE @ ARCH D		DATE		
1/4" =	1'-0"		09/08/23	
PN				


1 /

PROJECT NO. 230118

STAGE DRAWING NO.

COFA A2-04

LOCATION REVISION OTTAWA

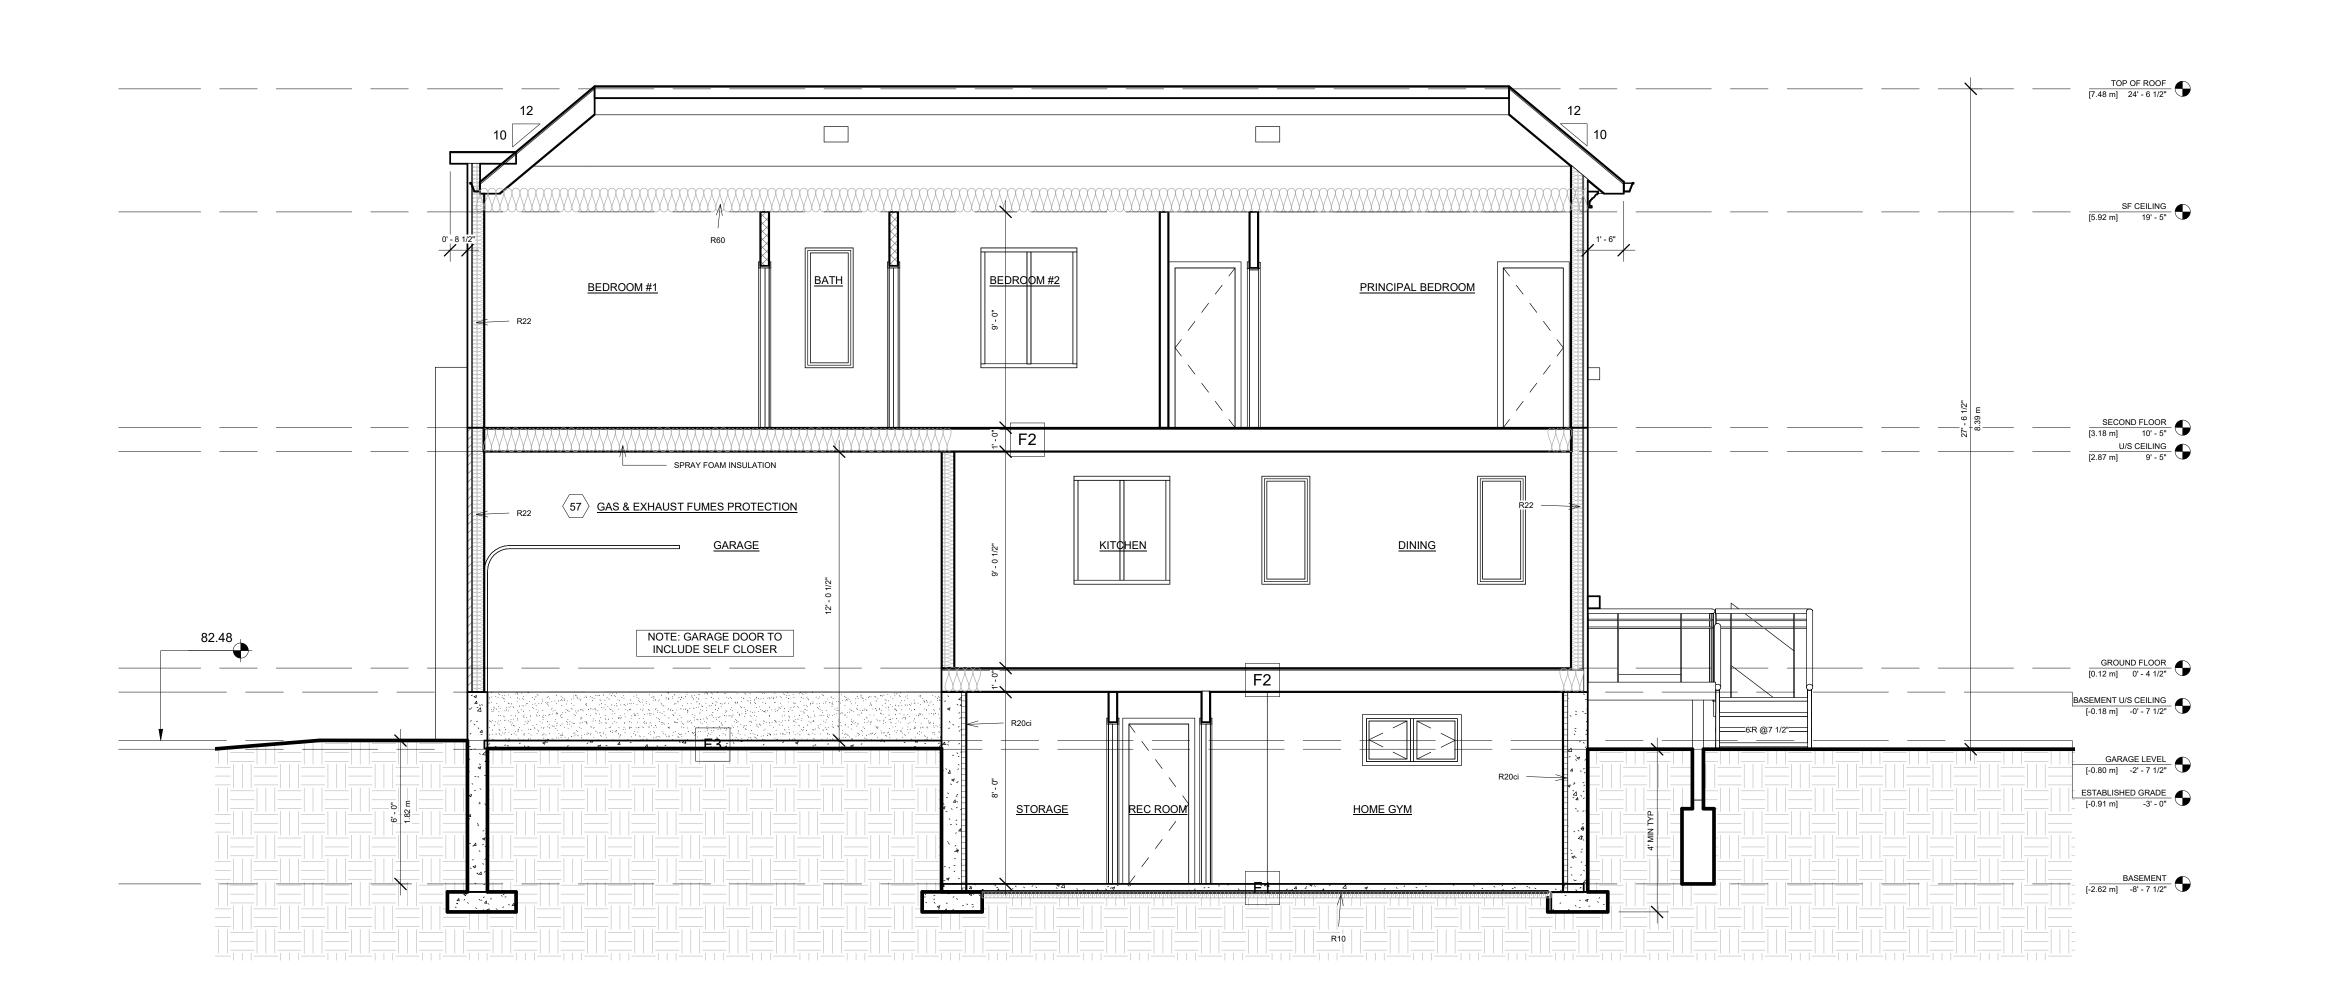

CLIENT

Owner



REVISIONS

No.	Description	Date
10	ISSUED FOR C OF A	2023-11-10
8	REISSUED FOR BUILDING PERMIT	2023-10-20
7	ISSUED FOR CONSULTANT	2023-09-26
6	ISSUED FOR BUILDING PERMIT	2023-09-08
5	ISSUED FOR CONSULTANTS	2023-08-08
4	ISSUED FOR C OF A	2023-07-21
3	ISSUED FOR CLIENT	2023-07-17

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DRAWING TITLE

SECTION

CHECKED

CD SA

SCALE @ ARCH D DATE

1/4" = 1'-0" 09/08/23

PROJECT NO.

230118

AGE DRAWING NO.

COFA A3-01

LOCATION RE OTTAWA

ARCHITECTURAL SHEET LIST Revision Number Sheet Issue Date Sheet Number 09/08/23 09/08/23 09/08/23 LANDSCAPE AREA PLAN LOT AREA AND LOT COVERAGE SITE PLAN,OAA MATRIX,STATISTICS AND GENERAL NOTES 09/08/23 FLOOR AREA PLAN SURVEY 09/08/23 PROPOSED R PLAN CONSTRUCTION NOTES 09/08/23 DEMOLITION PLAN PROP. BASEMENT PROP. GROUND FLOOR 09/08/23 PROP. SECOND FLOOR PROP. ROOF PLAN 09/08/23 09/08/23 PROP. FRONT ELEVATION 09/08/23 PROP. REAR ELEVATION PROP. LEFT ELEVATION 09/08/23 09/08/23 PROP. RIGHT ELEVATION SECTION 09/08/23 SECTION 09/08/23 SECTION WINDOW AND DOOR SCHEDULE DETAILS, WALL, FLOOR AND ROOF ASSEMBLIES 09/08/23



Committee of Adjustment Received | Reçu le

2024-02-01

City of Ottawa | Ville d'Ottawa Comité de dérogation

297 DOVERCOURT AVE OTTAWA, ON K1Z 7H4

CLIEN

Owner



REVISIONS

No.	Description	Date
10	ISSUED FOR C OF A	2023-11-10
7	ISSUED FOR CONSULTANT	2023-09-26
6	ISSUED FOR BUILDING PERMIT	2023-09-08
4	ISSUED FOR C OF A	2023-07-21
3	ISSUED FOR CLIENT	2023-07-17
2	ISSUED FOR CLIENT	2023-07-13
1	ISSUED FOR CLIENT	2023-06-30

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CONSULTA





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DRAWING TITLE

COVER

DRAWN	CHECKED
CD	SA
SCALE @ ARCH D	DATE 09/08/23



PROJECT NO. 230118

STAGE DRAWING

COFA A0-00

LOCATION RE OTTAWA

DRIVEWAY-295

DRIVEWAY-297

HARD LS-295

HARD LS-297

SOFT LS-295

SOFT LS-297



FRONT YARD LANDSCAPE

1" = 10'-0"

01 - FRONT YARD AREA CALCULA	TION-297 DOVERCOUF	RT AVE
Name	Area	AREA SI
SOFT LS-297	24.79 m²	24.79 m²
HARD LS-297	11.38 m²	11.38 m²
DRIVEWAY-297	18.04 m²	18.04 m²
6	54.21 m²	54.21 m²

01 - FRONT YARD AREA CALCULATION-	295 DOVERCOUR	T AVE
Name	Area	ARE
	•	
SOFT LS-295	25.88 m²	25.8
HARD LS-295	11.48 m²	11.4
DRIVEWAY-295	18.00 m ²	18.0


Schema 1 Legend

HARD LS-295

HARD LS-297

SOFT LS-295

SOFT LS-297

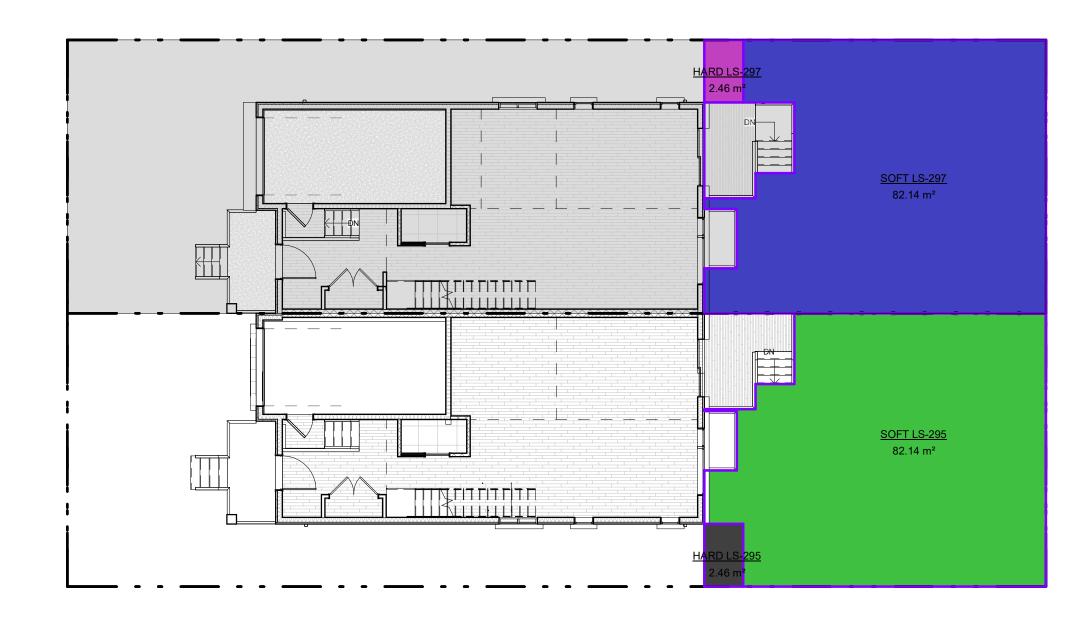

REAR LANDSCAPE

1" = 10'-0"

01 - REAR YARD AREA-2	97 DOVERCOURT AVE	
Name	Area	AREA
	71100	, <u>.</u>
HARD LS-297	2.46 m²	2.46 m ²
SOFT LS-297	82.14 m²	82.14 m
TOTAL REAR YARD AREA	84.60 m²	84.60 m

01 - REAR YARD AREA-295 DOVER	COURT AVE	
Name	Area	AREA :
HARD LS-295	2.46 m ²	2.46 m ²
SOFT LS-295	82.14 m²	82.14 m
TOTAL REAR YARD AREA	84.60 m²	84.60 m

297 DOVERCOURT AVE OTTAWA, ON K1Z 7H4

Owner



REVISIONS

No.	Description	Date
0	ISSUED FOR C OF A	2023-11-10
,	ISSUED FOR CONSULTANT	2023-09-26
i	ISSUED FOR BUILDING PERMIT	2023-09-08
	ISSUED FOR C OF A	2023-07-21
	ISSUED FOR CLIENT	2023-07-17
	ISSUED FOR CLIENT	2023-07-13
	ISSUED FOR CLIENT	2023-06-30

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LANDSCAPE AREA PLAN


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CD	SA	
SCALE @ ARCH D	DATE	
1" = 10'-0"	09/08/23	




PROJECT NO. 230118

COFA A0-01

LOCATION OTTAWA

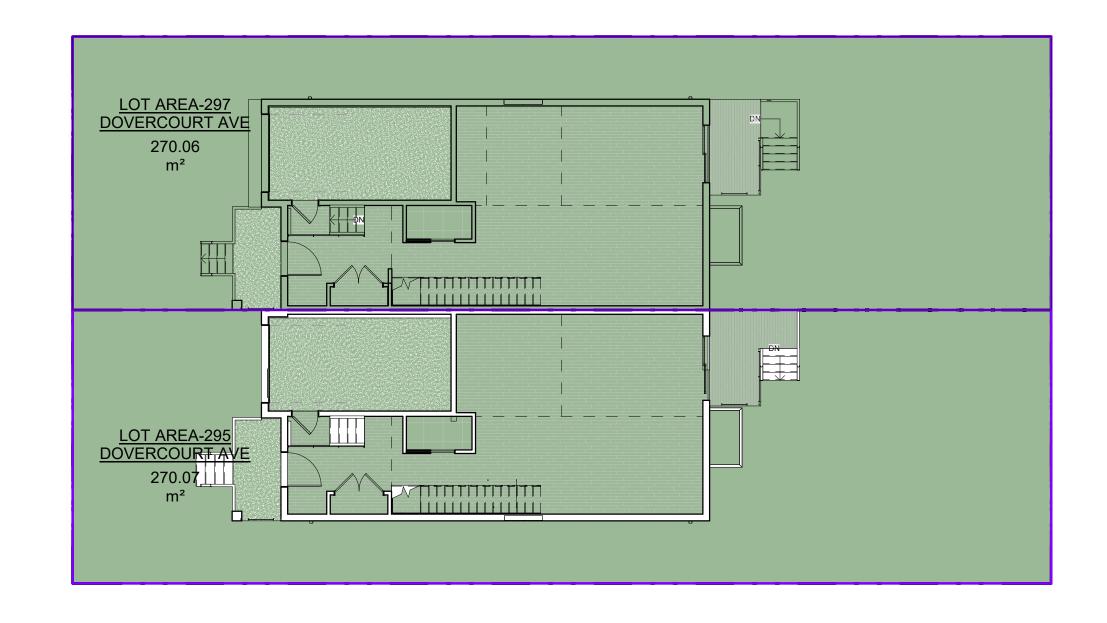

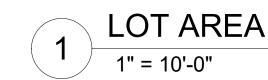

PROP. COVERAGE-295 DOVERCOURT AVE

PROP. COVERAGE-297 DOVERCOURT AVE



2 PROP. COVERAGE 1" = 10'-0"

297 DOVERCOURT AVE OTTAWA, ON K1Z 7H4

CLIENT

Owner



REVISIONS

No.	Description	Date
10	ISSUED FOR C OF A	2023-11-10
7	ISSUED FOR CONSULTANT	2023-09-26
6	ISSUED FOR BUILDING PERMIT	2023-09-08
4	ISSUED FOR C OF A	2023-07-21
3	ISSUED FOR CLIENT	2023-07-17
2	ISSUED FOR CLIENT	2023-07-13
1	ISSUED FOR CLIENT	2023-06-30

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CONSULTAN





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DRAWING TITLE

LOT AREA AND LOT COVERAGE

	DRAWN	CHECKED
	CD	SA
	SCALE @ ARCH D	DATE
	1" = 10'-0"	09/08/23




PROJECT NO. 230118

STAGE DRAWIN

COFA A0-02

LOCATION REVISIO
OTTAWA

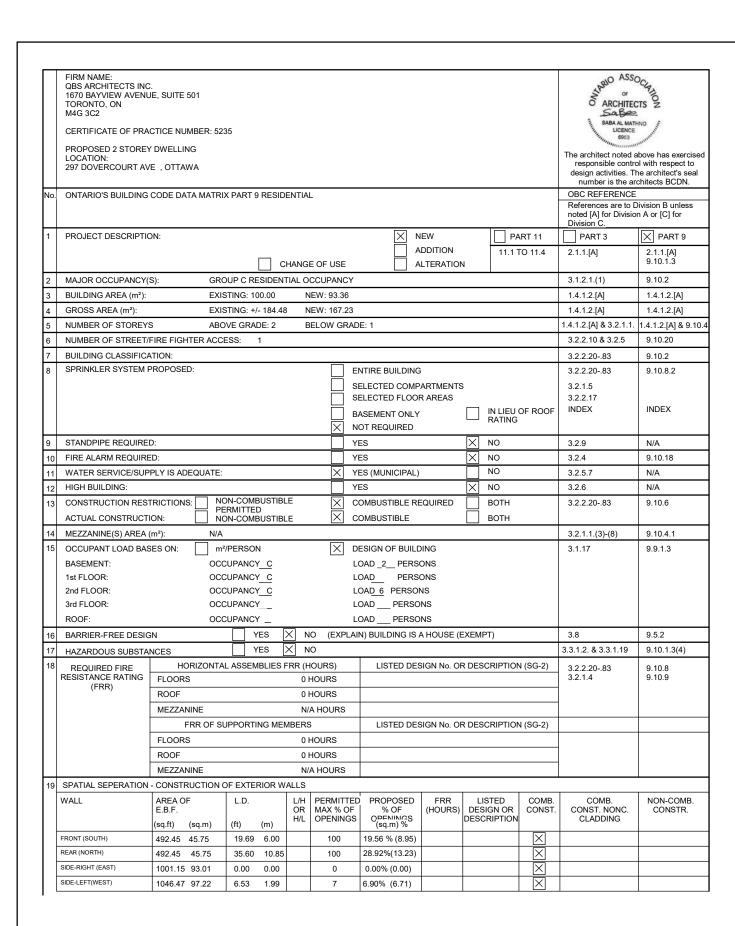

NEW BY-LAW

			(sq.m)	(sq.ft)
ZONING: R3R[2687] H(8.5)				
MINIMUM LOT AREA(SEMI-DETACHED): ALLOWABLE COVERAGE: N/A ALLOWABLE FSI: N/A			180.0 N/A N/A	1937.5 N/A N/A
PROPOSED BASEMENT FLOOR PROPOSED GROUND FLOOR PROPOSED SECOND FLOOR				
PROPOSED TOTAL GFA				
PROPOSED TOTAL GFA PROPOSED FSI 0.62				
PROPOSED FSI 0.62	ALLO	WABLE	PROPOS	 SED
PROPOSED FSI 0.62 PROPOSED COVERAGE: 34.57%	ALLO (m)	WABLE (ft)	PROPOS (m)	SED (ft)
PROPOSED FSI 0.62 PROPOSED COVERAGE: 34.57%	1	1		

	FIRM NAME: QBS ARCHITECTS INC 1670 BAYVIEW AVENU TORONTO, ON		501													STARIO ASSO	CIS Z
	M4G 3C2															SABA AL MATI	HNO ¿
	CERTIFICATE OF PRA	CTICE NU	IMBER: 5	5235	5											LICENCE 6963	. sentere grant
	PROPOSED 2 STOREY LOCATION:	/ DWELLIN	NG													The architect noted a	
	297 DOVERCOURT AV	E LOT B, (OTTAWA	4												responsible contro design activities. The	
L																number is the ar	
No.	ONTARIO'S BUILDING	CODE DA	TA MATE	RIX	PART 9	RESID	ENTIA	AL								OBC REFERENCE References are to D	
																noted [A] for Divisio Division C.	
1	PROJECT DESCRIPTION	ON:								X	NE	EW		PA	RT 11	PART 3	X PART 9
											AE	DDITION		11.1 T	O 11.4	2.1.1.[A]	2.1.1.[A]
L						c	HANG	E OF U	JSE		AL	TERATION	١				9.10.1.3
2	MAJOR OCCUPANCY(S):	GF	ROL	JP C RE	SIDEN.	TIAL C	CCUP	ANCY							3.1.2.1.(1)	9.10.2
3	BUILDING AREA (m²):		EX	KIST	ING: 100	0.00	1	NEW: 9	3.36							1.4.1.2.[A]	1.4.1.2.[A]
4	GROSS AREA (m²):				ING: +/-			NEW: 1								1.4.1.2.[A]	1.4.1.2.[A]
5	NUMBER OF STOREYS				E GRAD		E	BELOW	/ GRAD	E: 1						1.4.1.2.[A] & 3.2.1.1.	
6	NUMBER OF STREET/		ITER AC	CES	SS: 1											3.2.2.10 & 3.2.5	9.10.20
7	BUILDING CLASSIFICA		·D.					Г								3.2.2.2083	9.10.2
8	SPRINKLER SYSTEM F	PROPUSE	:D:						=	NTIRE BUILE						3.2.2.2083	9.10.8.2
								[_	ELECTED CO ELECTED FL			3			3.2.1.5 3.2.2.17	
								[=	ASEMENT O		AILAO	П	IN LIEU (OF ROOF	INDEX	INDEX
								[=	OT REQUIRE			Ш	RATING			
9	STANDPIPE REQUIRE	D:							Y	ES			X	NO		3.2.9	N/A
10	FIRE ALARM REQUIRE	D:							_	ES			$\overline{\times}$	NO		3.2.4	9.10.18
11	WATER SERVICE/SUP	PLY IS AD	EQUATE	E:					ΧY	ES (MUNICIF	PAL)		Ħ	NO		3.2.5.7	N/A
12	HIGH BUILDING:								Y	ES			X	NO		3.2.6	N/A
13	CONSTRUCTION REST	TRICTION:			N-COMB		.E		X c	OMBUSTIBL	E REG	QUIRED		вотн		3.2.2.2083	9.10.6
	ACTUAL CONSTRUCTI	ION:			MITTED N-COMB		_E		× c	OMBUSTIBL	E			вотн			
14	MEZZANINE(S) AREA ((m²):	N/A	/A												3.2.1.1.(3)-(8)	9.10.4.1
15	OCCUPANT LOAD BAS	SES ON:	r	m²/P	PERSON				X D	ESIGN OF B	UILDI	NG				3.1.17	9.9.1.3
	BASEMENT:		00	CCU	JPANCY_	C			L	OAD _2 PE	ERSO	NS					
	1st FLOOR:				JPANCY_	_				_	ERSO						
	2nd FLOOR: 3rd FLOOR:				JPANCY_ JPANCY					OA <u>D 6</u> PEF OAD PEI							
	ROOF:				JPANCY	_					RSON						
16	BARRIER-FREE DESIG	SN SN			YE	_	X N	NO (E		N) BUILDING			XEMI	PT)		3.8	9.5.2
17	HAZARDOUS SUBSTA				-			VO (1	2. 0	,				,		3.3.1.2. & 3.3.1.19	9.10.1.3(4)
18	REQUIRED FIRE		ORIZONT	TAL					S)	LISTED	DESI	IGN No. OF	R DES	CRIPTION	I (SG-2)	3.2.2.2083	9.10.8
	RESISTANCE RATING	FLOORS						HOUR							. ,	3.2.2.2063	9.10.8
	(FRR)	ROOF					0	HOUR	s							1	
		MEZZAN	NINE				N.	/A HOL	JRS								
		F	FRR OF	SUF	PORTIN	IG MEI	MBER:	s		LISTED	DESI	IGN No. OF	R DES	CRIPTION	I (SG-2)		
		FLOORS	s				0	HOUR	s								
		ROOF					0	HOUR	s								
$oxed{oxed}$		MEZZAN	NINE				N	/A HOL	JRS								
19	SPATIAL SEPERATION	- CONSTR	RUCTION	N OF	EXTER	IOR W	ALLS									1	1
	WALL	AREA OI E.B.F.	F		L.D.		L/H OR		MITTED .% OF	PROPOSI	ED	FRR (HOURS)		STED IGN OR	COMB. CONST.	COMB. CONST. NONC.	NON-COMB. CONSTR.
		(sq.ft)	(sq.m)		(ft)	(m)	H/L		NINGS	OPENING (sq.m) %	_{{s} s			RIPTION	551101.	CLADDING	00110111.
	FRONT (SOUTH)	492.45		+	19.69	6.00		1	00	19.56 % (8.					\times		
	REAR (NORTH)	492.45		\top	35.60	10.85		_	00	28.92%(13.					X		
1		1		-			t	+			-		_		_=	1	1

 1001.15
 93.01
 6.53
 1.99
 7
 6.21% (5.78)

 1046.47
 97.22
 0.00
 0.00
 0
 0.00% (0.00)

NEW BY-LAW

ZONING INFORMATION FOR PROJECT 239 ALDERCR	EST RD LC	T B- BY-L	AW 1229-99-	90
			(sq.m)	(sq.ft)
ZONING: R3R[2687] H(8.5)				
MINIMUM LOT AREA(SEMI-DETACHED): ALLOWABLE COVERAGE: N/A ALLOWABLE FSI: N/A			180.0 N/A N/A	1937.5 N/A N/A
PROPOSED BASEMENT FLOOR PROPOSED GROUND FLOOR PROPOSED SECOND FLOOR PROPOSED TOTAL GFA				
PROPOSED FSI 0.62				
PROPOSED COVERAGE: 34.57%				
SETBACKS	ALLOW	/ABLE	PROPOS	ED
	(m)	(ft)	(m)	(ft)
FRONT: REAR: SIDE-WEST (LEFT): SIDE-EAST (RIGHT): BUILDING HEIGHT: BUILDING LENGTH: LOT FRONTAGE(SEMI-DETACHED): GARAGE	6.0 7.5 0 1.2 8.0 17.59 6.0	19.69 24.60 0.00 3.94 26.25 57.71 19.69	6.0 10.85 0 1.99 7.74 14.24 8.69 PROVIDED	19.69 35.60 0.00 6.53 25.39 46.72 28.51

GENERAL NOTES

- ALL CONSTRUCTION TO COMPLY WITH CURRENT EDITION OF THE ONTARIO BUILDING CODE 2012 OBC, AS AMENDED.
- ALL WORKMANSHIP IS TO BE OF A STANDARD EQUAL IN ALL RESPECTS TO GOOD BUILDING PRACTICE. DRAWINGS AND SPECIFICATIONS ARE PROPERTY OF THE ARCHITECT AND MUST BE RETURNED ON COMPLETION OF THE PROJECT.
- REPORT IN WRITING ALL DISCOVERED ERRORS OR OMISSIONS TO THE ARCHITECT AT ONCE.
- DO NOT SCALE DRAWINGS. USE LATEST SCALE DRAWINGS ONLY.
- CONTRACTOR TO VERIFY ALL VERTICAL AND HORIZONTAL SITE DIMENSIONS PRIOR TO COMMENCING WORK INCLUDING EXTERIOR LANDSCAPING DIMENSIONS.
- CONTRACTOR TO PROVIDE PLYWOOD HOARDING AROUND THE PERIMETER OF THE JOB SITE BETWEEN THE PROPOSED NEW STRUCTURE TO THE PROPERTY LINE. IF ADDITIONAL STAGING/STORAGE AREA IS REQUIRED, CONTRACTOR TO APPLY FOR PERMIT TO BUILD HOARDING ON CITY PROPERTY. IN LIEU OF PLYWOOD HOARDING, A 7'-0" HIGH CHAIN LINK FENCE BY "FAST FENCE" OR EQUAL IS TO BE
- SITE MUST BE SAFE AND SECURE AT ALL TIMES. CONTRACTOR RESPONSIBLE FOR LOCKING THE CONSTRUCTION GATE NIGHTLY. CONTRACTOR MUST POST "NO TRESPASSING" AND "DANGER-CONSTRUCTION AREA" SIGNS AS WELL AS ANY OTHER SIGNS REQUIRED BY ANY GOVERNING BODY .G. HEALTH AND SAFETY, ETC.
- EXISTING GRADE DIMENSIONS DISTURBED DURING CONSTRUCTION TO BE MAINTAINED UNLESS OTHERWISE NOTED ON LOT DRAINAGE PLAN. ALL BACKFILL MUST BE EVELED. ADD 4" TOPSOIL AND SOD IN ALL AREAS DISTURBED DURING CONSTRUCTION.
- REPAIRS TO EXISTING LANDSCAPING USE TRIPLE MIX SOIL AT ALL PLANTING BEDS. REFER TO ARBORIST REPORT (WHERE APPLICABLE) FOR SPECIAL INSTRUCTION REGARDING EXCAVATION / CONSTRUCTION IN PROXIMITY TO MATURE TREES.
- EVERY EXCAVATION SHALL BE UNDERTAKEN IN SUCH A MANNER AS TO PREVENT MOVEMENT WHICH WOULD CAUSE DAMAGE TO ADJACENT PROPERTY, EXISTING STRUCTURES, UTILITIES, ROADS AND SIDEWALKS AT ALL STAGES OF CONSTRUCTION.
- ENSURE ADEQUATE BRACING OF FOUNDATION WALLS PRIOR TO BACKFILLING.
- ALL STRUCTURAL WOOD TO BE #2 SPRUCE OR BETTER UNLESS NOTED OTHERWISE
- PROVIDE POSTS UNDER ALL BEAMS / GIRDER TRUSSES, ETC. POSTS TO RUN CONTINUOUS TO FOUNDATION OR EQUIVALENT SUPPORT.
- ALL STUMPS, ROOTS AND OTHER DEBRIS SHALL BE REMOVED FROM HE SOIL TO A MIN. DEPTH OF 12" IN UNEXCAVATED AREAS UNDER A BUILDING. WOOD DEBRIS REMOVAL SHALL EXTEND 2'- 0" MIN. BEYOND THE PERIMETER OF THE BUILDING.
- ALL WOOD SCRAPS AND FORMS SHALL BE REMOVED FROM AROUND THE FOUNDATIONS BEFORE BACKFILLING AND FROM UNDER EXTERIOR STEPS OR PORCHES BEFORE CONSTRUCTION IS COMPLETED.
- ALL EXISTING SURFACES ADJACENT TO NEW CONSTRUCTION AND THROUGH WHICH CONSTRUCTION MATERIALS AND CONTRACTOR'S FORCES MOVE ARE TO BE PROTECTED.
- PROVIDE TEMPORARY DUST BARRIERS AS REQUIRED TO MAINTAIN DUST FREE ENVIRONMENT FOR ALL BUILDING AREAS OCCUPIED BY OWNER / TENANTS. CONTRACTOR SHALL MAINTAIN THE JOB SITE AND WORK IN A TIDY CONDITION. DAILY CLEAN UP OF JOB SITE IS REQUIRED.
- REMOVE ALL CONSTRUCTION DEBRIS FROM SITE UNLESS OTHERWISE NOTED. ALL WOOD FRAMING MEMBERS SUPPORTED ON CONCRETE WHICH IS IN DIRECT CONTACT WITH SOIL IS TO BE SEPARATED FROM CONCRETE WITH DAMP PROOFING MATERIAL (9.23.2.3 OBC)
- GARAGE ACCESS DOOR TO BUILDING TO BE C/W SELF CLOSURE MECHANISM AND GAS TIGHT.
- ALL WINDOWS LOCATED WITHIN 6'7" FROM GRADE, SHALL CONFORM TO CLAUSE 10.13 OF CSA STANDARD A440-M90 AND 9.7.6.1 OBC (RESISTANCE TO FORCED ENTRY). SUPPLY AND INSTALL 6" SMOOTH CUT LIMESTONE THRESHOLD / SILL AT ALL EXTERIOR DOORS / WINDOWS (INCLUDING BASEMENT).
- ALL GUARD RAILS ARE TO SUSTAIN MINIMUM LOADING AS PER OBC 4.1.10.1 AND 9.8.8 FOR HEIGHT AND SPACING OF PICKETS. HANDRAILS AND TO CONFIRM WITH 9.8.8 OBC.
- ALL INTERIOR TRIM TO BE POPLAR (PAINT) UNLESS OTHERWISE NOTED. EXTERIOR TRIM TO BE #1 CLEAR PINE (PAINT). NOTE: USE KIL ON ALL KNOTS PRIOR TO PRIMER COAT. ALL WOOD TO BE KEPT DRY
- ALL TRIM TO BE PRE-PAINTED (PRIMER + ONE COAT) PRIOR TO INSTALLATION.
- CONTRACTOR MUST RECEIVE PERMISSION FROM OWNER PRIOR TO INSTALLATION OF JOB SIGN. SEE INSTRUCTIONS TO CONTRACTOR FOR ADDITIONAL SPECIFICATIONS AND CASH ALLOWANCES.
- CONTRACTOR TO USE FLEXIBLE CORNER BEAD AT ALL RADIUSES DRYWALL EDGES.
- THESE WORKING DRAWINGS ARE BASED ON "MEASURED DRAWINGS" OF THE EXISTING BUILDING, NOT "RECORD DRAWINGS", WHICH ARE THE ORIGINAL CONSTRUCTION DRAWINGS REVISED TO REFLECT "AS BUILT" CONDITIONS. MEASUREMENTS HAVE BEEN TAKEN TO EXTERIOR SURFACES ONLY, AND EXCEPT WHERE NOTED NO ATTEMPT HAS BEEN MADE TO VERIFY HIDDEN CONDITIONS.

Bay Window

NO REPRESENTATION IS MADE THAT THE BUILDING CONFORMS TO ANY CODE REQUIREMENTS, OR ANY CONSTRUCTION DRAWINGS THAT MAY HAVE BEEN PREPARED BY OTHERS.

WATER METER

ESTABLISHED GRADE CALC: 82.44 + 82.51 / 2 = 82.48

- CONTRACTOR TO COORDINATE STRUCTURAL JOISTS AND STUD LAYOUTS TO ACCOMMODATE THE ELECTRICAL POTLIGHTS, ETC. LOCATIONS. NOTE: REPORT ANY LAYOUT DISCREPANCIES TO THE ARCHITECT PRIOR TO THE INSTALLATION.
- SEE ALSO ATTACHED REFLECTED CEILING PLANS AND ELECTRICAL SPECIFICATIONS.
- CONTRACTOR TO INSTALL APPROVED ELECTRICAL PANEL(S) OF ADEQUATE SIZE TO HANDLE ALL ELECTRICAL REQUIREMENTS. CONTRACTOR TO ENSURE EXISTING ELECTRICAL PANEL(S) IS ADEQUATE TO SERVE BOTH EXISTING AND PROPOSED ADDITION'S POWER REQUIREMENTS.
 - CONTRACTOR RESPONSIBLE FOR OBTAINING ONTARIO HYDRO PERMIT.

SURVEY NOTE

BUILDER / GENERAL CONTRACTOR MUST RETAIN THE SERVICES OF A PROFESSIONAL SURVEYOR FOR THE STAKING OUT OF NEW FOUNDATIONS, SURVEYOR MUST BE GIVEN 72 HOURS NOTICE BEFORE BEING REQUIRED ON SITE. TO BEGIN DEMOLITION/CONSTRUCTION:

SITE FENCING- BUILDER / GENERAL CONTRACTOR MUST ENLOSE ENTIRE SITE WITH A FENCE THAT IS IN COMPLIANCE WITH THE CITY OF TORONTO MUNICIPAL CODE CHAPTER 363, ARTICLE III. THE MIN. REQUIREMENT IS A PLASTIC MESH FENCE, 1.2M HIGH, TIED TO POSTS SPACED NO MORE THAN 1.2M APART, WITH AN 11 GAUGE TOP AND BOTTOM WIRE THREADED THROUGH THE MESH AND LOOPED AROUND EACH POST. CONSTUCTION NOISE- ANY CONSTRUCTION WHICH GENERATES NOISE IS PROHIBITED IN RESIDENCIAL AREAS BETWEEN THE HOURS OF 7:00PM ONE DAY TO 7:00AM THE NEXT DAY, 9:00AM ON SATURDAYS, AND ALL DAY SUNDAY AND STATUTORY HOLIDAYS.

- CALL FOR INSPECTIONS- THE BUILDER/ GENERAL CONTRACTOR IS REQUIRED TO NOTIFY THE BUILDING INSPECTION OFFICE AT VARIOUS STAGES OF CONSTRUCTION AS REQUIRED BY DIVISION C, PART 1, ARTICLE 1.3.5.1. OF THE ONTARIO BUILDING CODE. THE PHONE NUMBER FOR THE BUILDING INSPECTION OFFICE RESPONABILE FOR THE PROJECT'S AREA WILL BE INCULDED IN THE PERMIT DOCUMENTS.
- PERMIT PLANS. THE PERMIT PLANS AND SPECIFICATIONS MUST BE ON THE SITE AT ALL TIMES. THE PERMIT PLANS AND SPECIFICATIONS PROVIDED TO THE BUILDER/ GENERAL CONTRACTOR WILL BE USED FOR INSPECTIONS.

#23

ALLOWABLE REAR YARD SETBACK 24' - 7 1/2"

REAR DECK AND STAIRS UNIT 1-297 DOVERCOURT AVE

REVISIONS

CLIENT

No.	Description	Date
10	ISSUED FOR C OF A	2023-11-10
8	REISSUED FOR BUILDING PERMIT	2023-10-20
7	ISSUED FOR CONSULTANT	2023-09-26
6	ISSUED FOR BUILDING PERMIT	2023-09-08
4	ISSUED FOR C OF A	2023-07-21
3	ISSUED FOR CLIENT	2023-07-17
2	ISSUED FOR CLIENT	2023-07-13

297 DOVERCOURT AVE

OTTAWA, ON

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SITE PLAN,OAA MATRIX, STATISTICS AND **GENERAL NOTES**

DRAWN	CHECKED
CD	SA
SCALE @ ARCH D	DATE
As indicated	09/08/23




PROJECT NO. 230118


DRAWING NO.

COFA A0-03

OTTAWA

REVISION 10

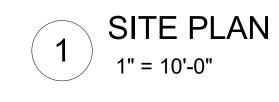

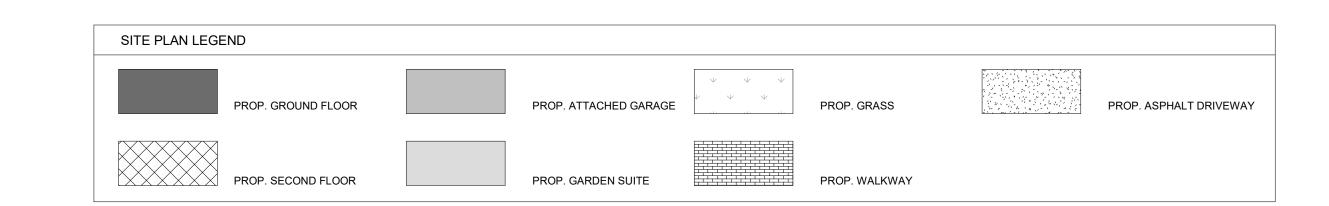

295 DOVERCOURT AVE

PROP. BASEMENT FLOOR-295 DOVERCOURT AVE

PROP. BASEMENT FLOOR-297 DOVERCOURT AVE

FROP BASEMENT FLOR 295 BOTE SOURT AVE FROP BASEMENT FLOR 295 DOVE SOURT AVE BY m

BASEMENT-PROPOSED

1" = 10'-0"

Schema 1 Legend

PROP. GROUND FLOOR-295 DOVERCOURT AVE

PROP. GROUND FLOOR-297 DOVERCOURT AVE

Schema 1 Legend


PROP. SECOND FLOOR-295 DOVERCOURT AVE

PROP. SECOND FLOOR-297 DOVERCOURT AVE

PROP GROWN HONE 297. PROP I G

GROUND FLOOR-PROPOSED

1" = 10'-0"

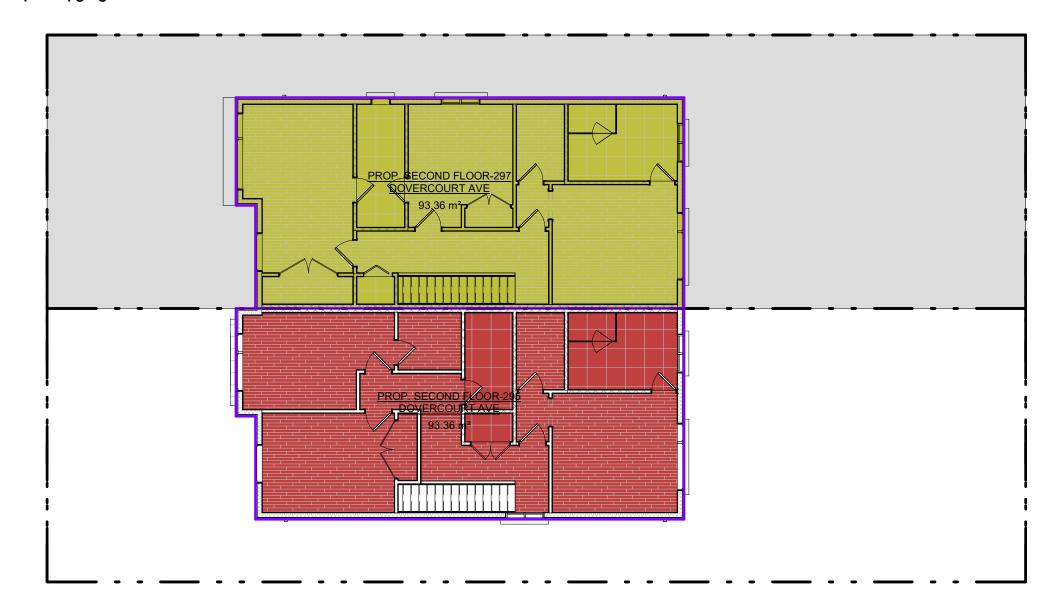

SECOND FLOOR-PROPOSED

1" = 10'-0"

CLIENT Owner

297 DOVERCOURT AVE

OTTAWA, ON

K1Z 7H4



REVISIONS

No.	Description	Date
10	ISSUED FOR C OF A	2023-11-10
7	ISSUED FOR CONSULTANT	2023-09-26
6	ISSUED FOR BUILDING PERMIT	2023-09-08
4	ISSUED FOR C OF A	2023-07-21
3	ISSUED FOR CLIENT	2023-07-17
2	ISSUED FOR CLIENT	2023-07-13
1	ISSUED FOR CLIENT	2023-06-30

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CONSULTAN

Area Schedule (297 DOVERCOURT AVE)

Area Schedule (295 DOVERCOURT AVE)

 PROP. BASEMENT FLOOR-295 DOVERCOURT AVE
 73.87 m²

 PROP. GROUND FLOOR-295 DOVERCOURT AVE
 73.87 m²

 PROP. SECOND FLOOR-295 DOVERCOURT AVE
 93.36 m²

 PROP. BASEMENT FLOOR-297 DOVERCOURT AVE
 73.87 m²

 PROP. GROUND FLOOR-297 DOVERCOURT AVE
 73.87 m²

 PROP. SECOND FLOOR-297 DOVERCOURT AVE
 93.36 m²

 241.11 m²





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FLOOR AREA PLAN

ı	DRAWN	CHECKED
ı	CD	SA
ı	SCALE @ ARCH D	DATE
ı	1" = 10'-0"	09/08/23




PROJECT NO. **230118**

STAGE DRAWING NO.

COFA A0-04


LOCATION OTTAWA

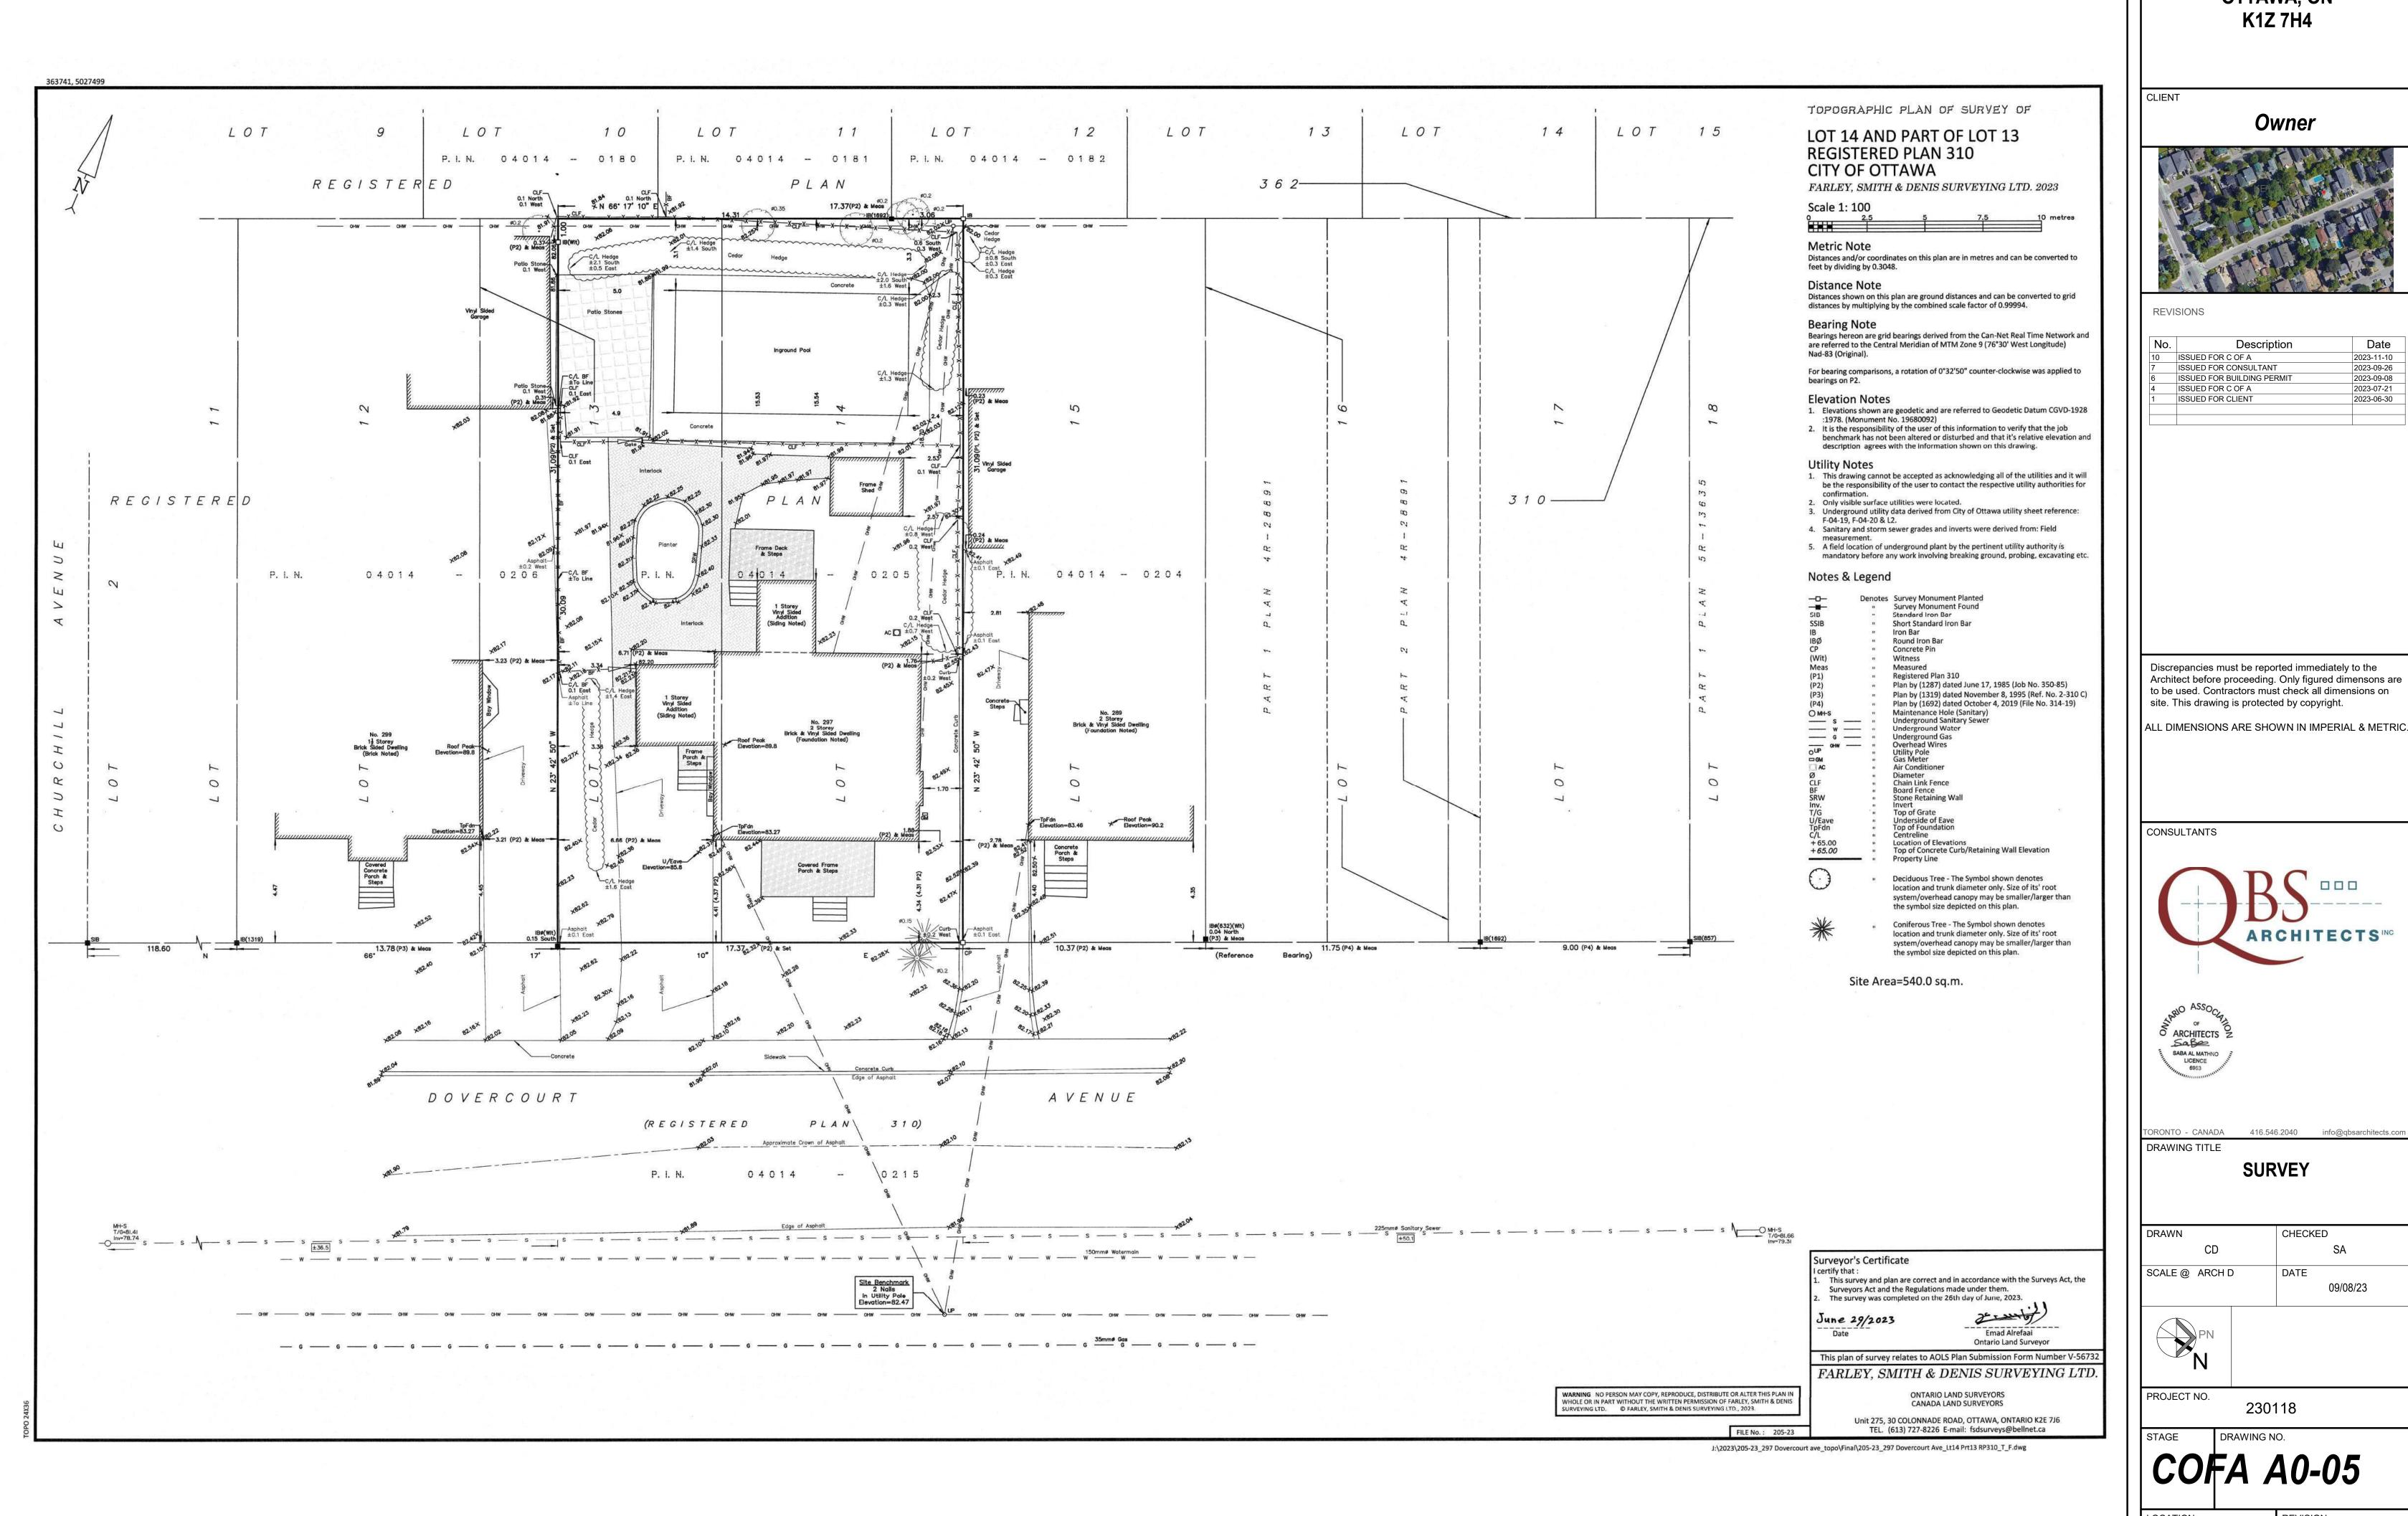

297 DOVERCOURT AVE OTTAWA, ON

ALL DIMENSIONS ARE SHOWN IN IMPERIAL & METRIC.

REVISION OTTAWA

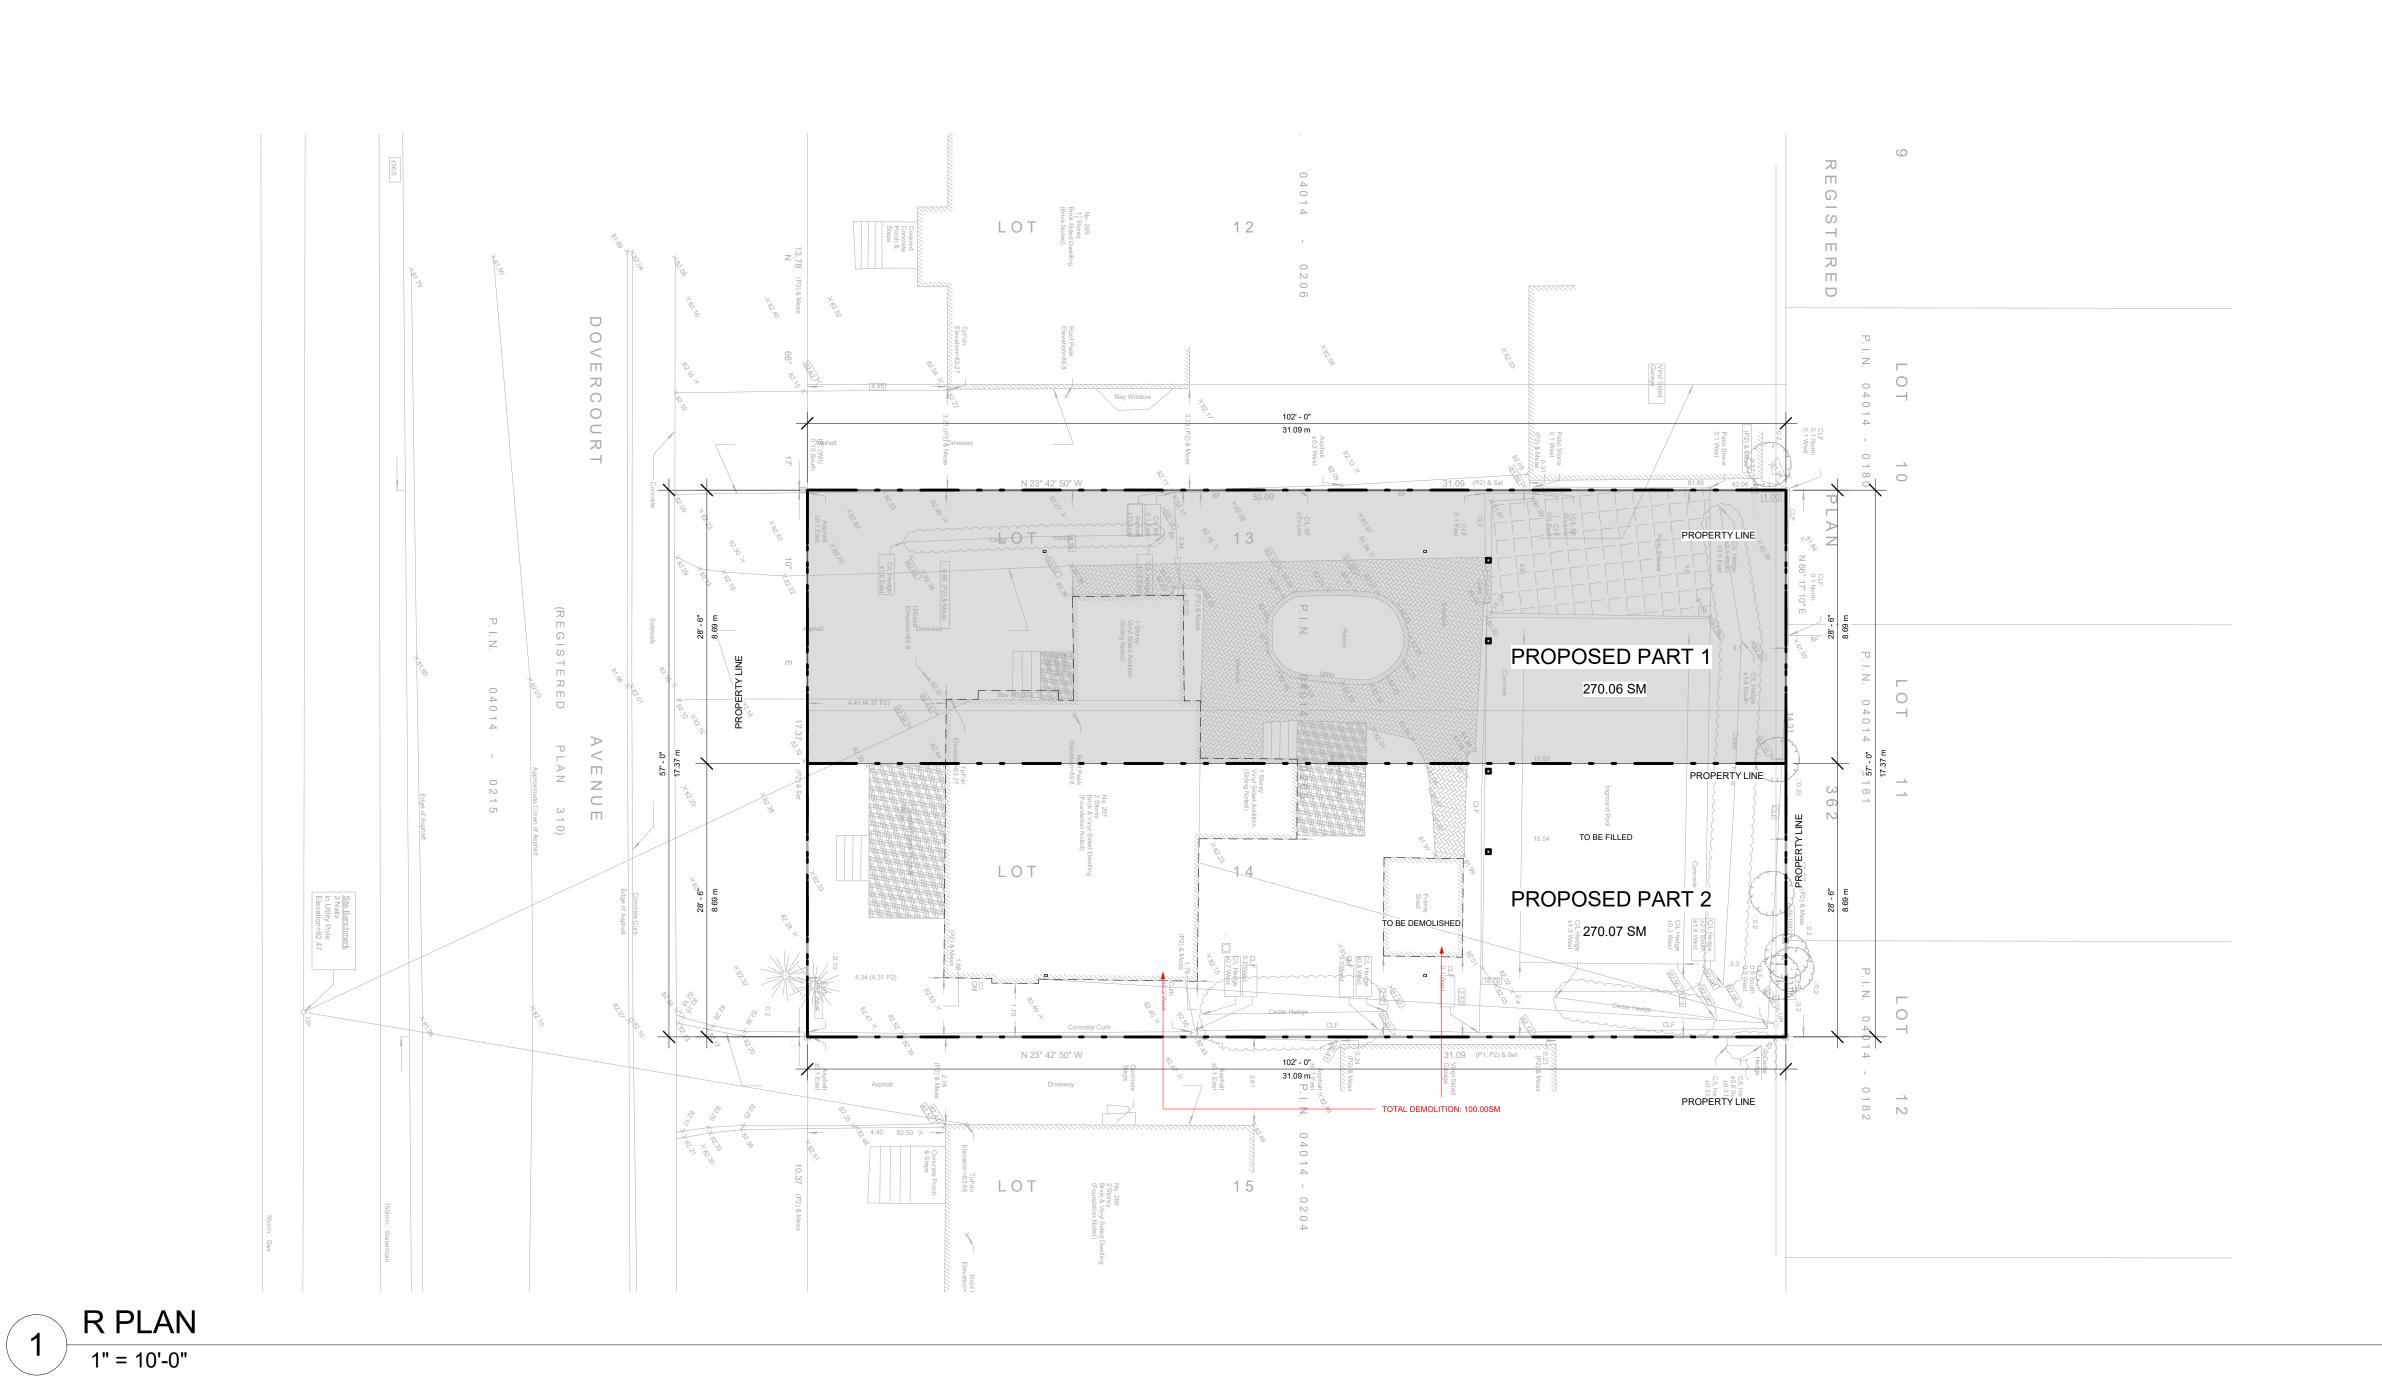

Owner



REVISIONS

Description	Date
ISSUED FOR DEMO	2023-12-04
ISSUED FOR C OF A	2023-11-10
ISSUED FOR CONSULTANT	2023-09-26
ISSUED FOR BUILDING PERMIT	2023-09-08
ISSUED FOR C OF A	2023-07-21
ISSUED FOR CLIENT	2023-07-17
ISSUED FOR CLIENT	2023-06-30
	ISSUED FOR DEMO ISSUED FOR C OF A ISSUED FOR CONSULTANT ISSUED FOR BUILDING PERMIT ISSUED FOR C OF A ISSUED FOR CLIENT

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PROPOSED R PLAN

DRAWN CHECKED

	CD	S	SA.
SCAL	.E @ ARCH D 1" = 10'-0"	DATE 09	/08/23




PROJECT NO.

230118

COFA A0-06

REVISION

LOCATION OTTAWA

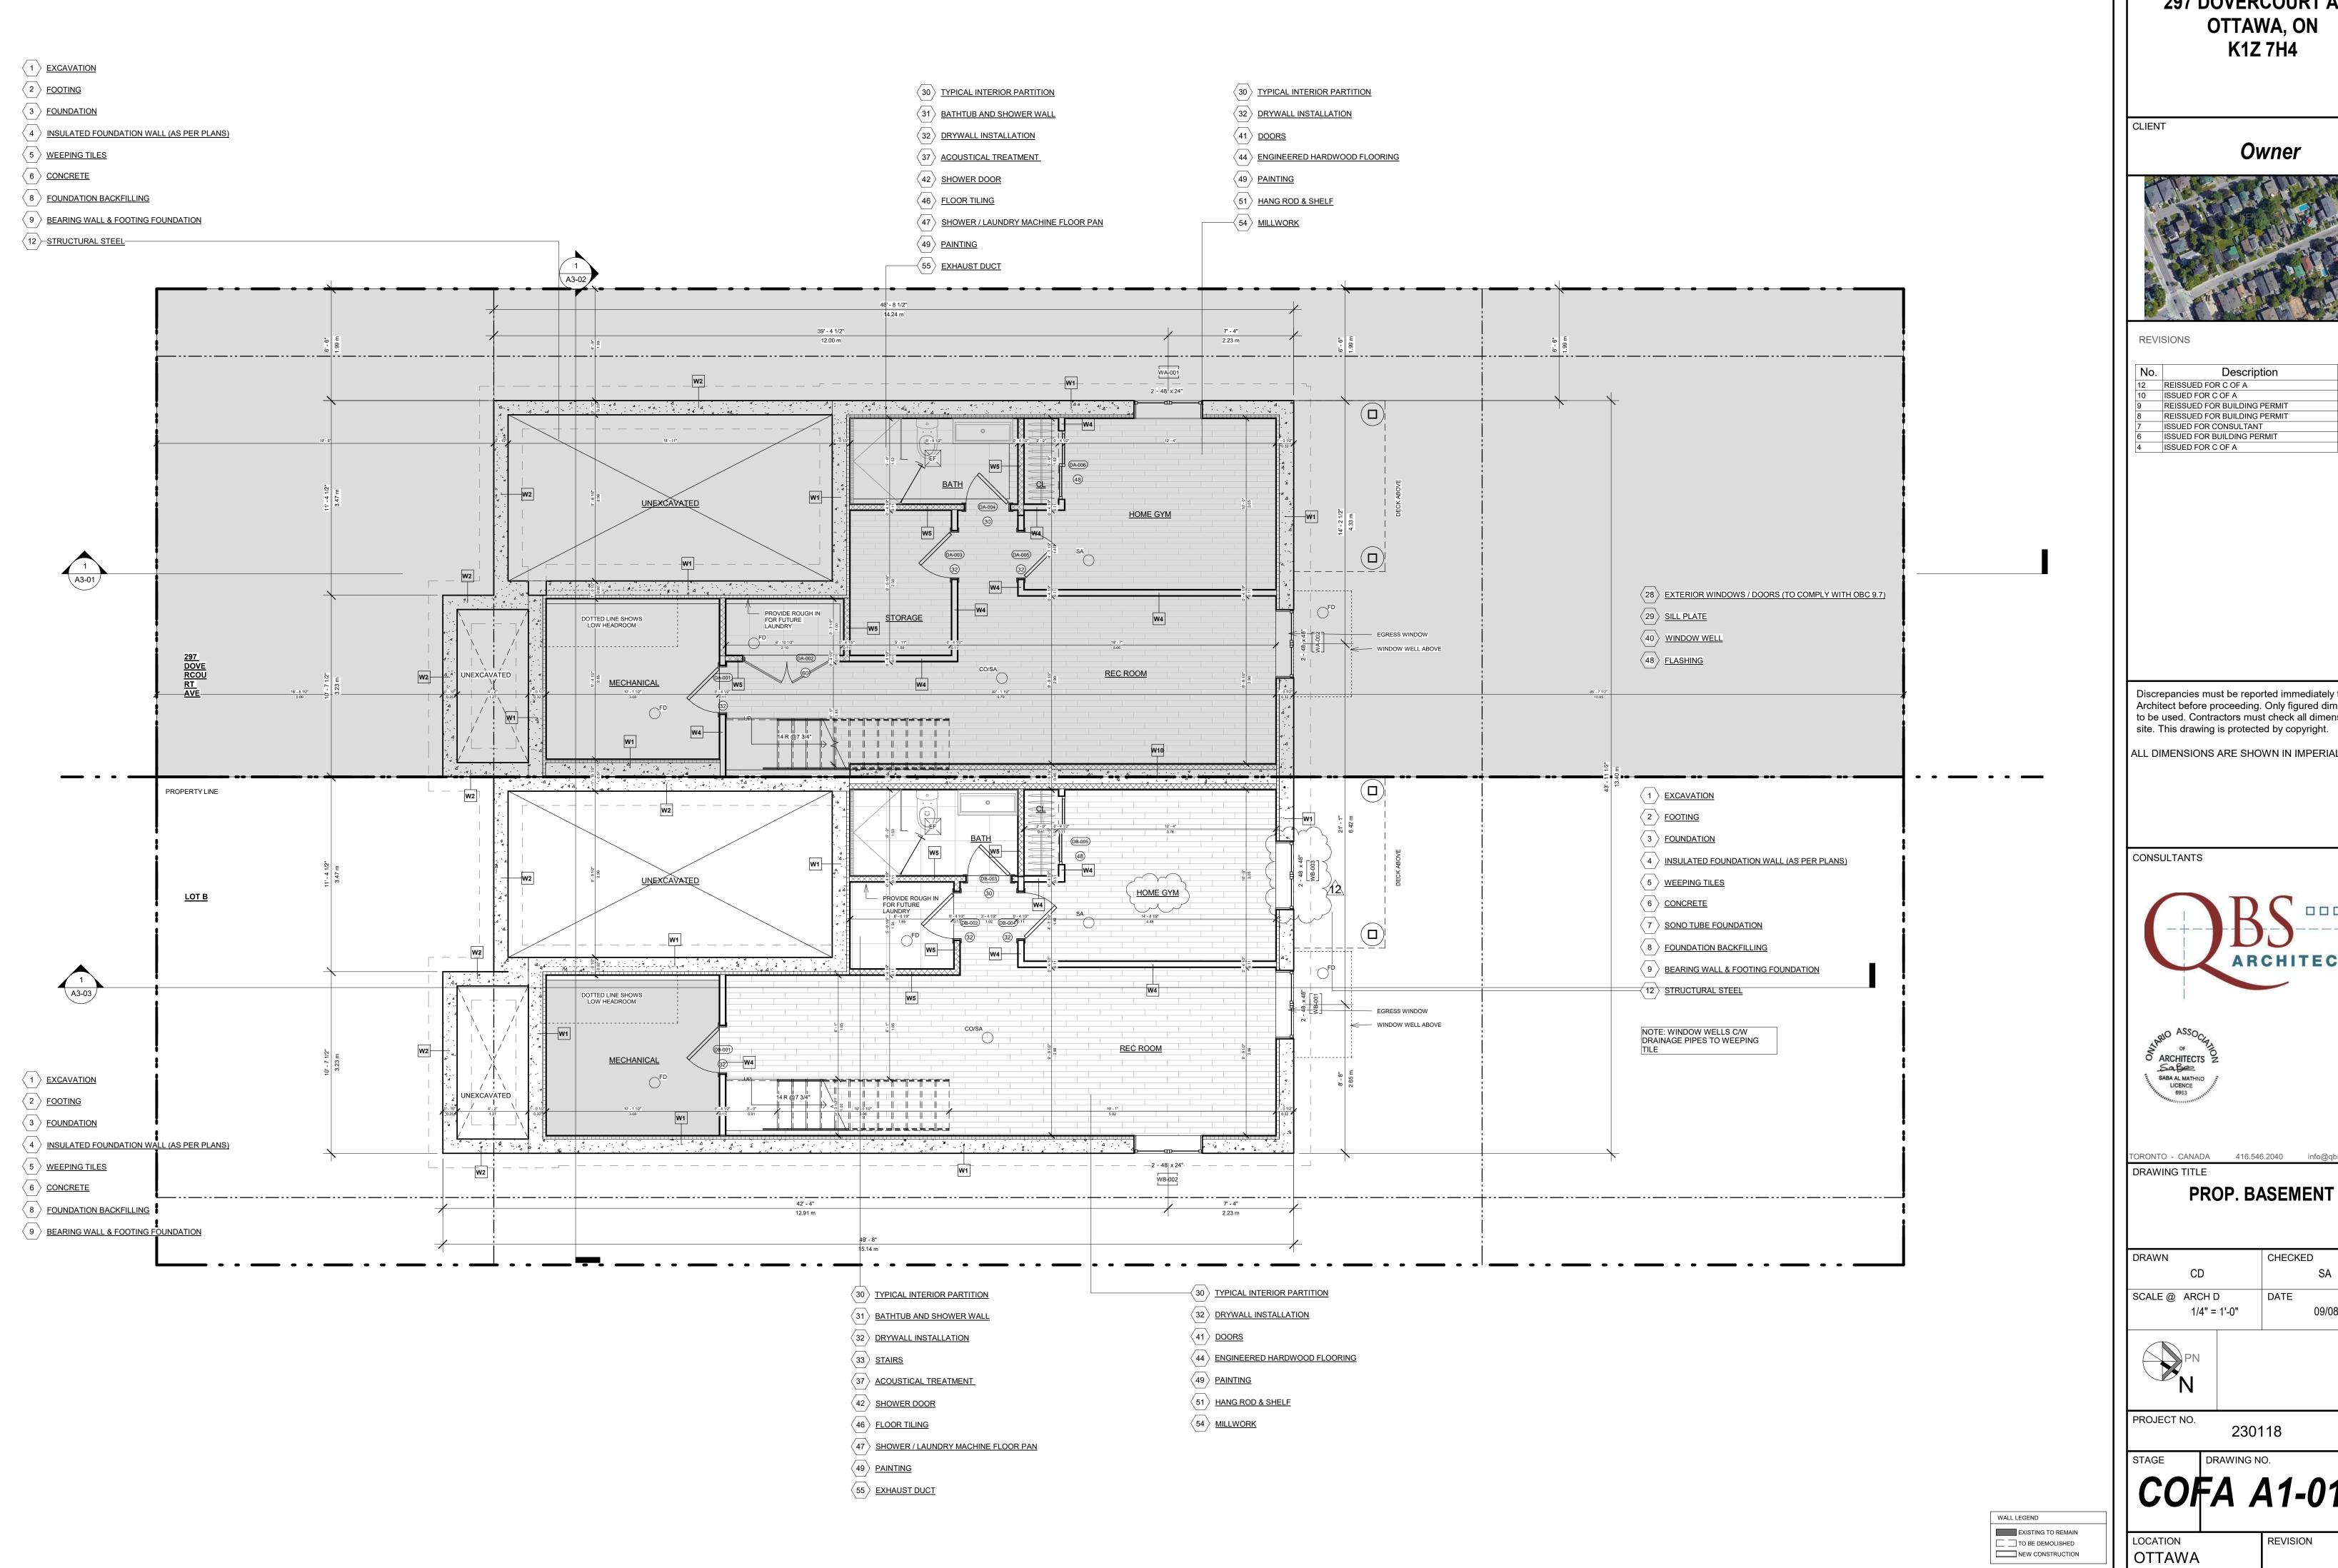

297 DOVERCOURT AVE OTTAWA, ON



No.	Description	Date
12	REISSUED FOR C OF A	2024-01-22
10	ISSUED FOR C OF A	2023-11-10
9	REISSUED FOR BUILDING PERMIT	2023-10-24
8	REISSUED FOR BUILDING PERMIT	2023-10-20
7	ISSUED FOR CONSULTANT	2023-09-26
6	ISSUED FOR BUILDING PERMIT	2023-09-08
4	ISSUED FOR C OF A	2023-07-21

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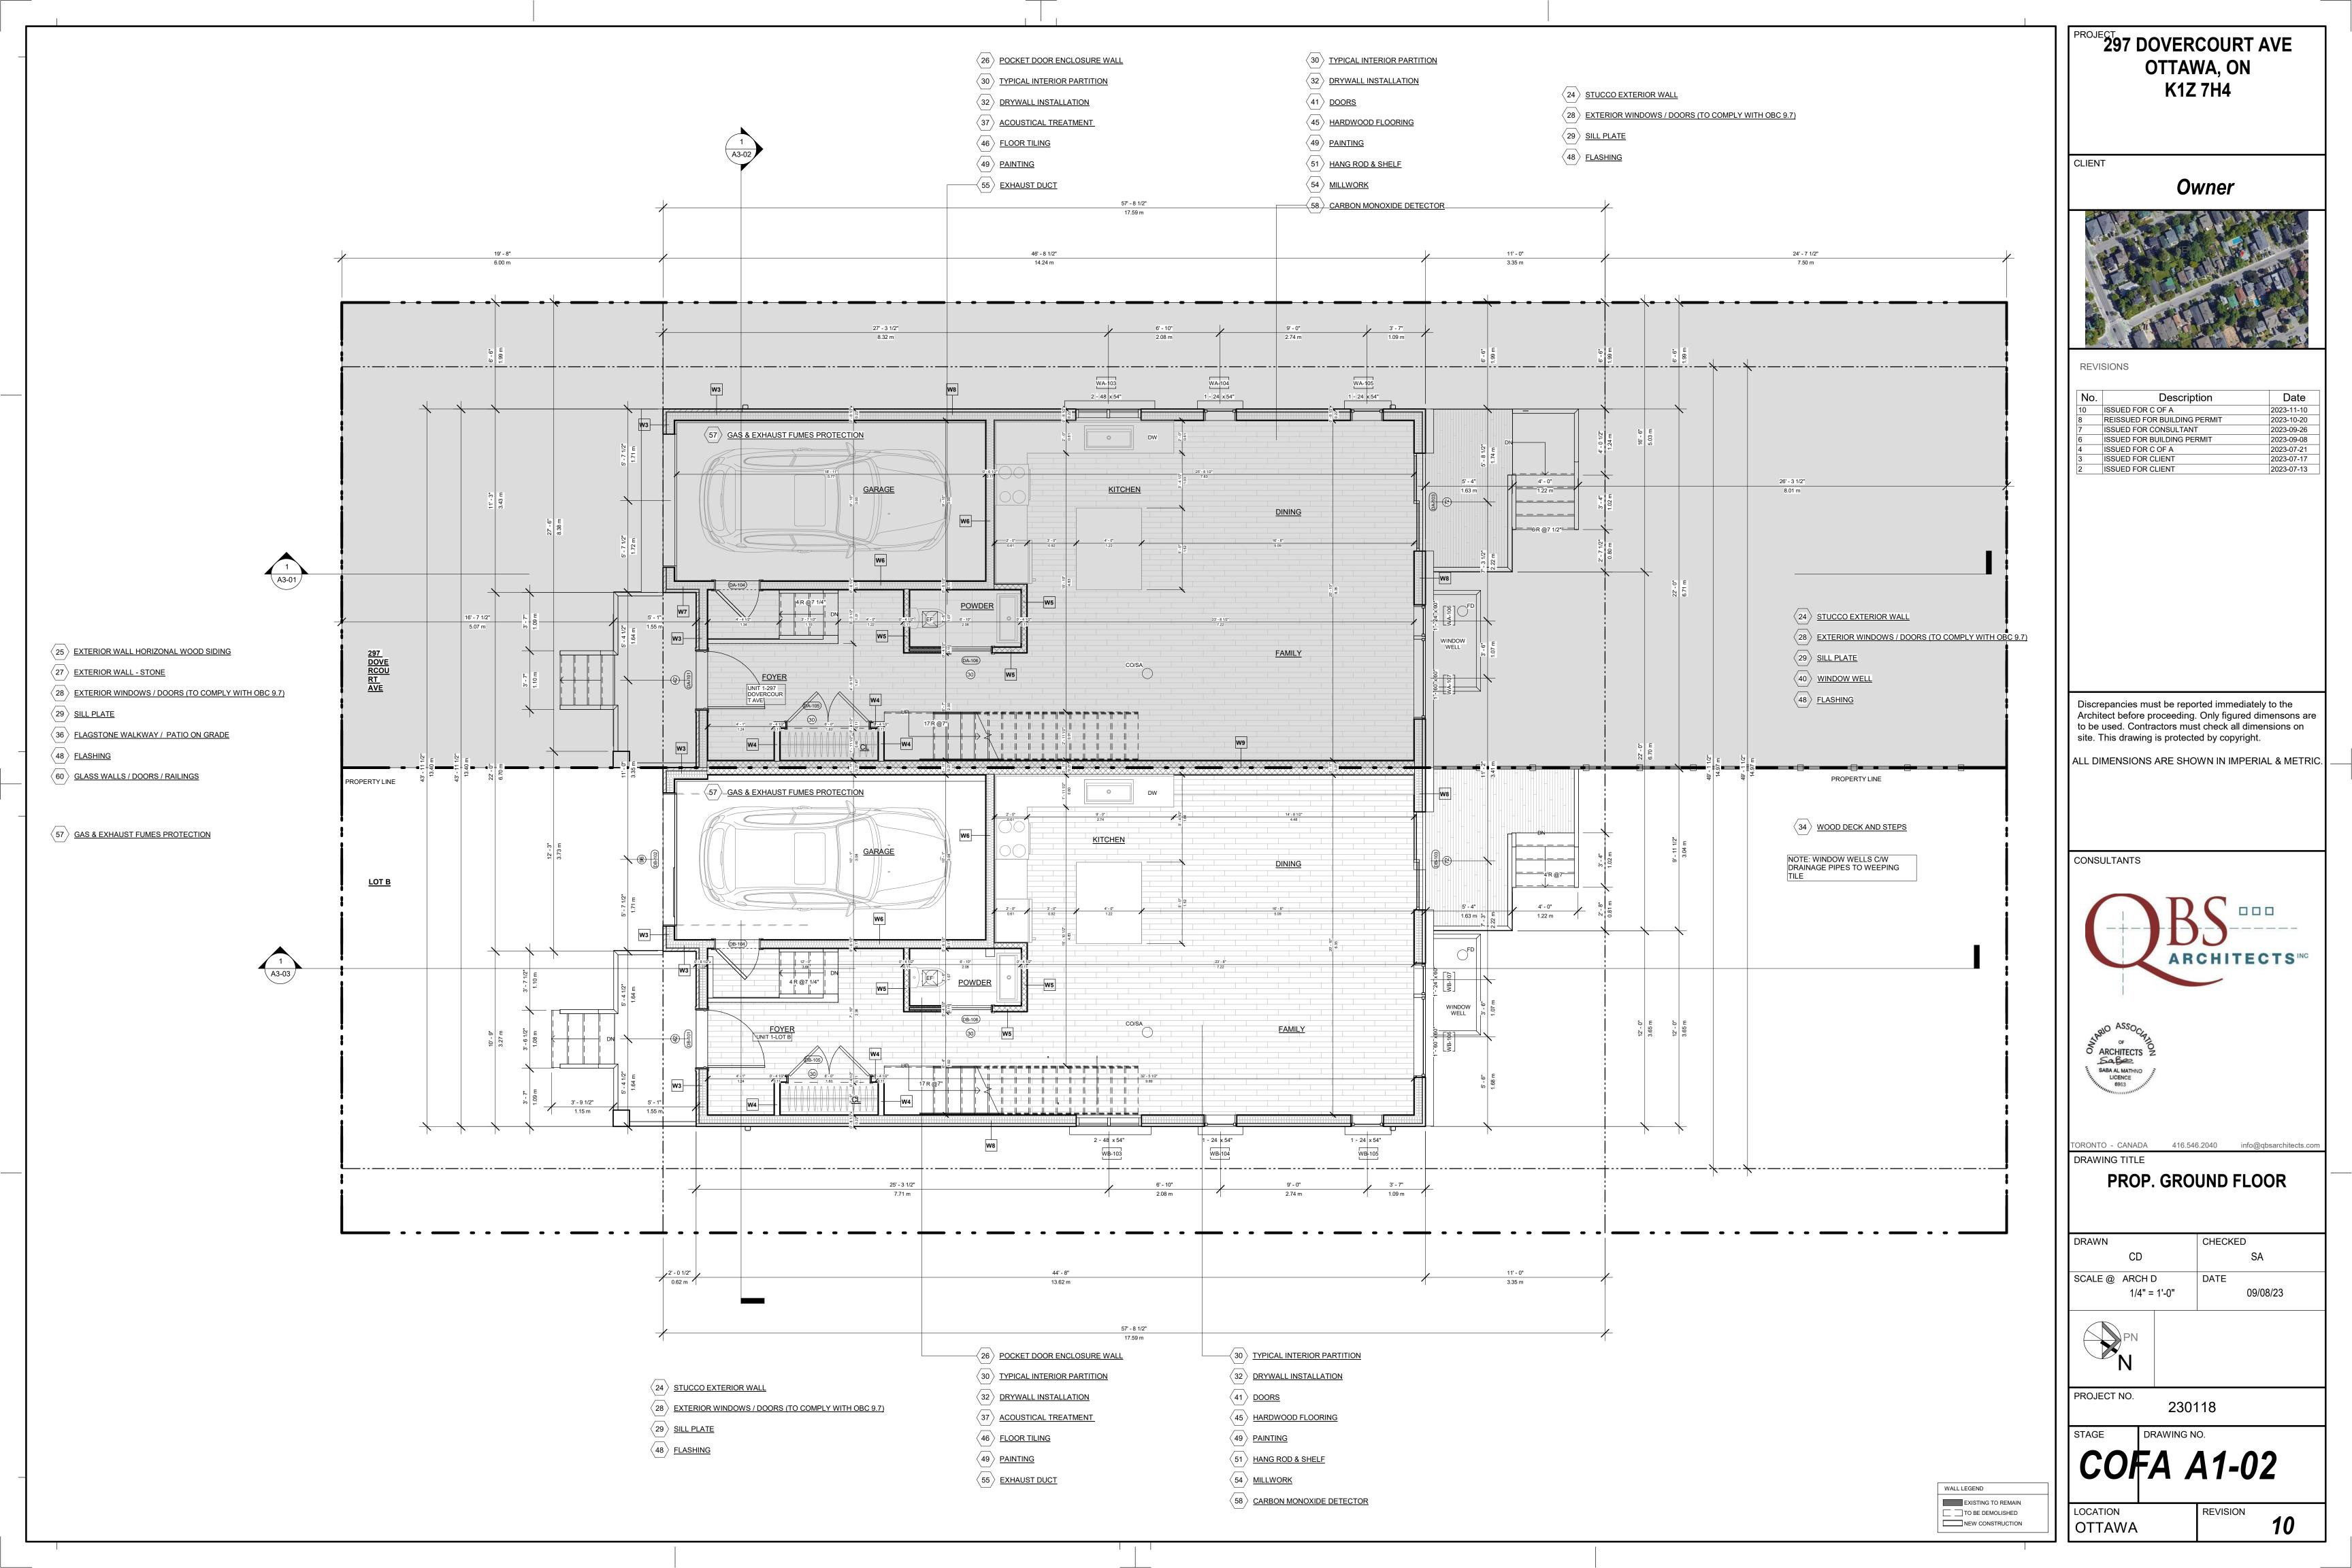
ALL DIMENSIONS ARE SHOWN IN IMPERIAL & METRIC





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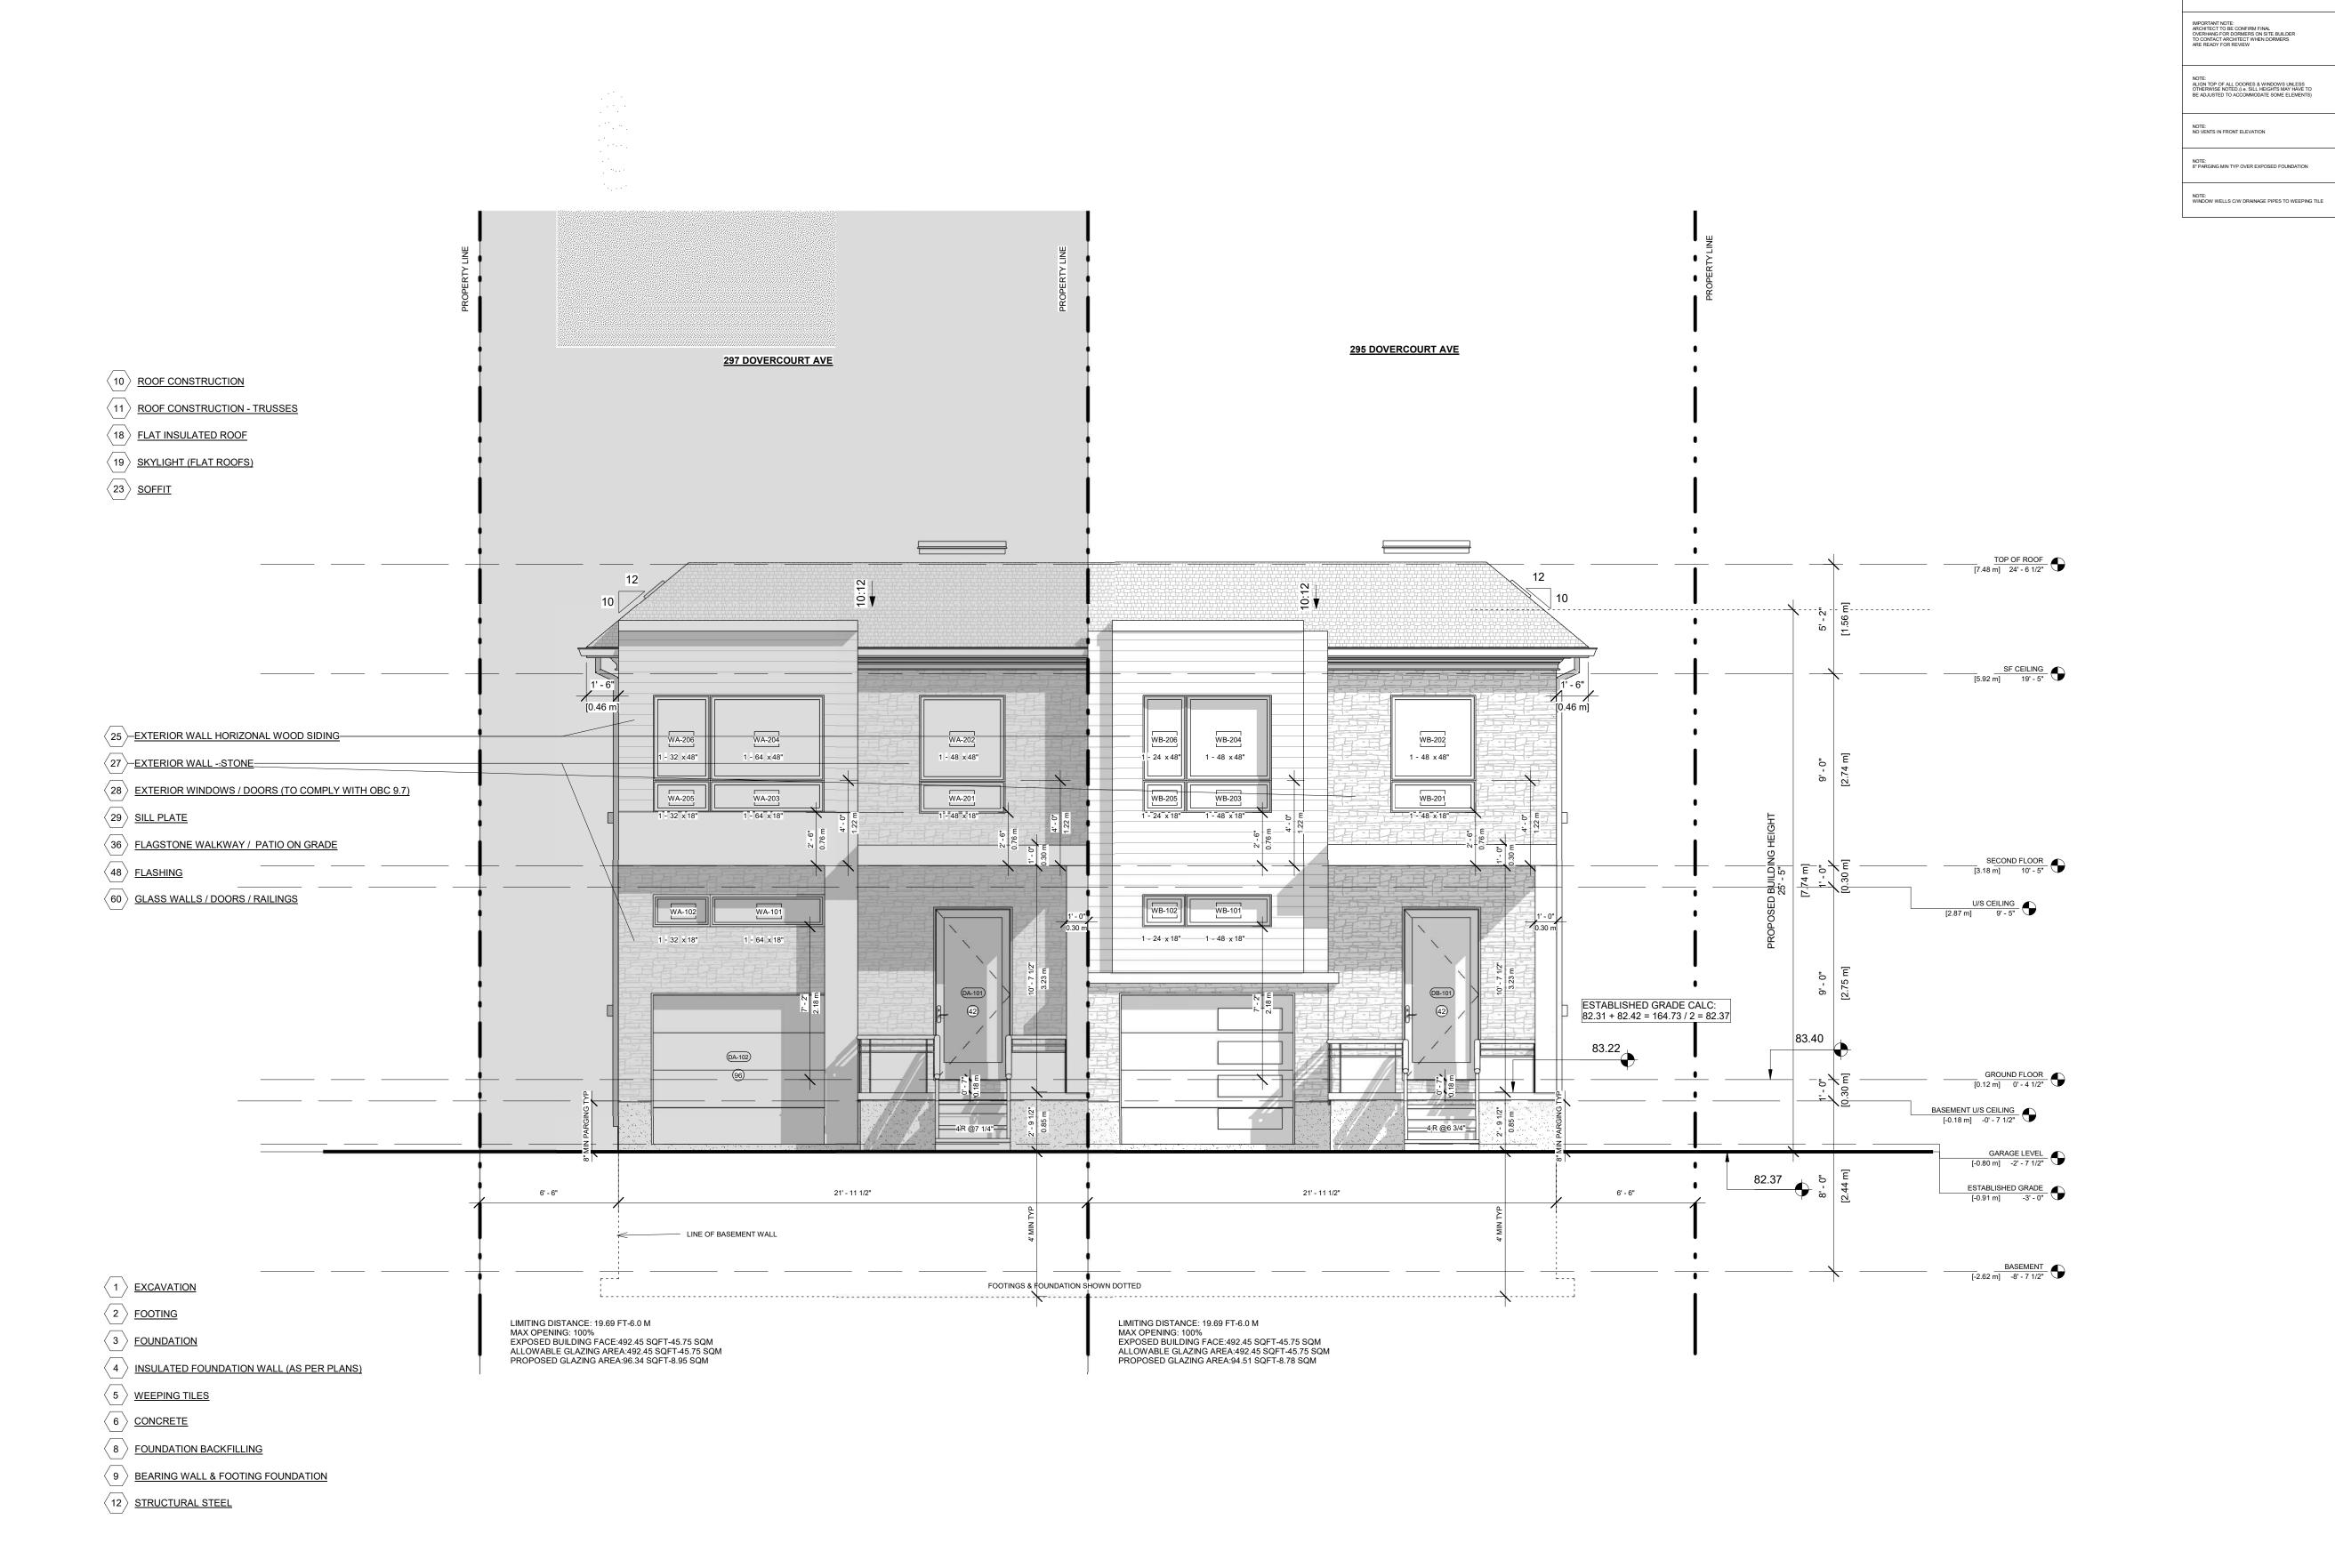
CD	SA
SCALE @ ARCH D 1/4" = 1'-0"	DATE 09/08/23
PN	

COFA A1-01





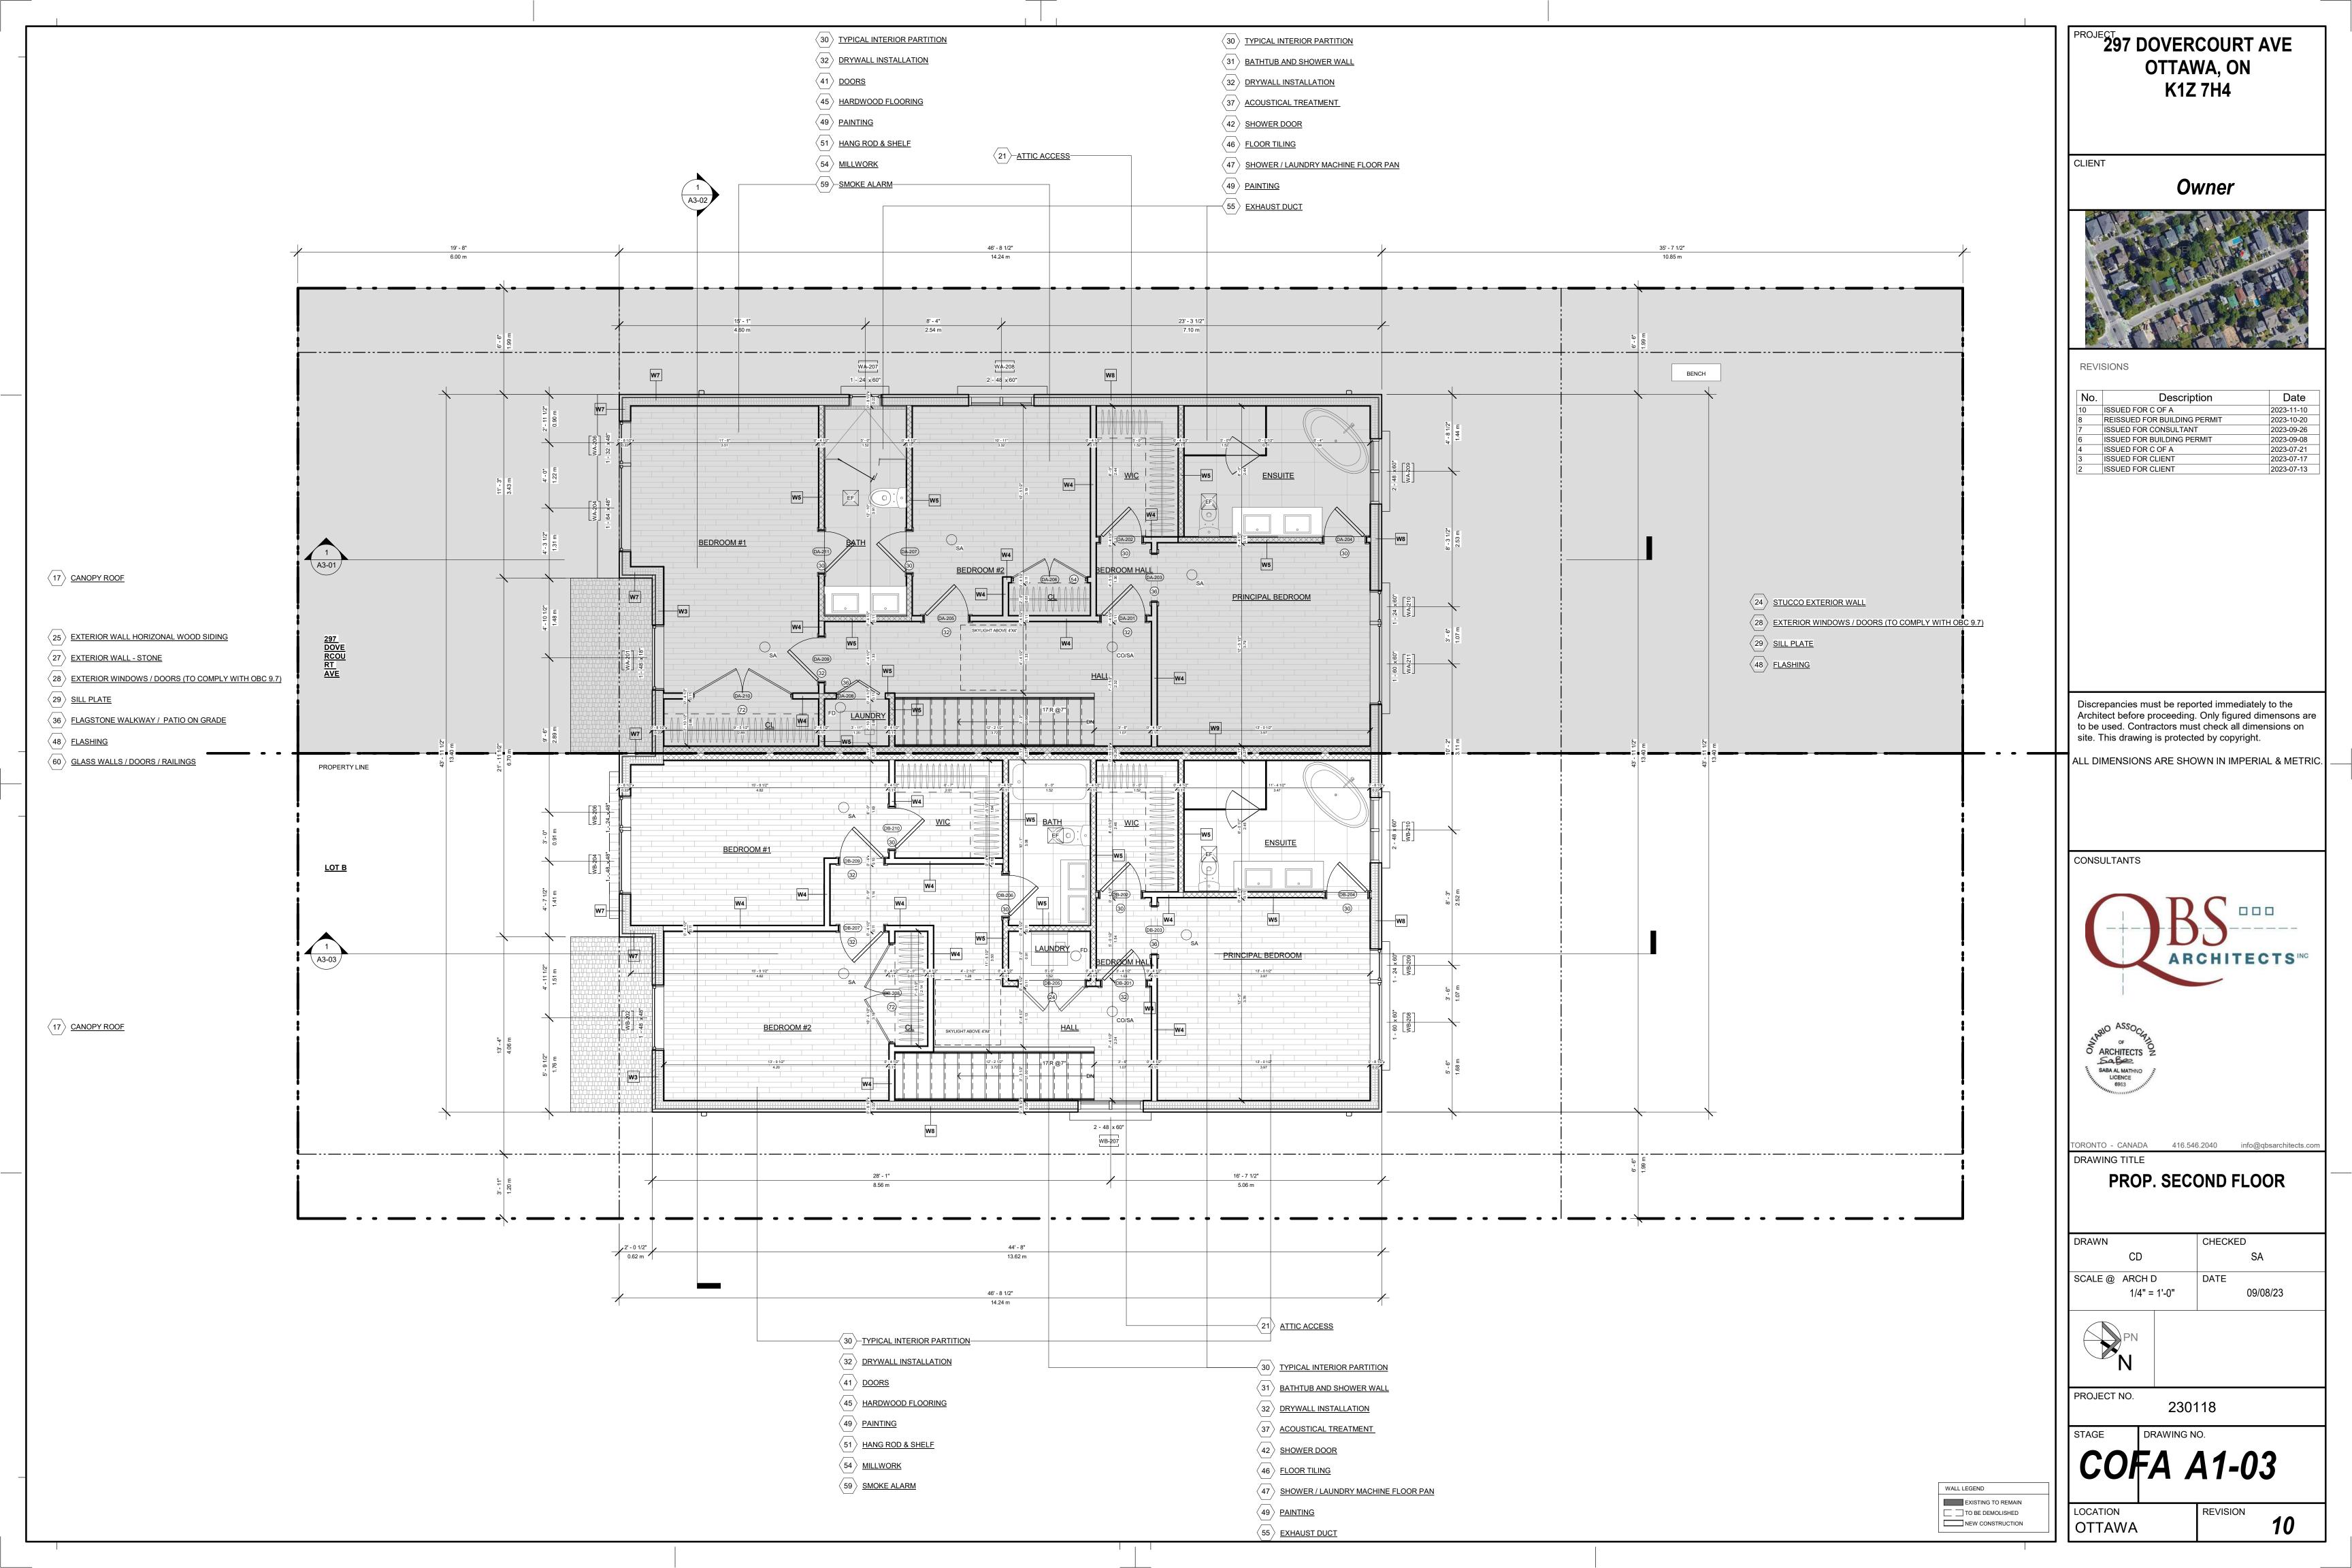

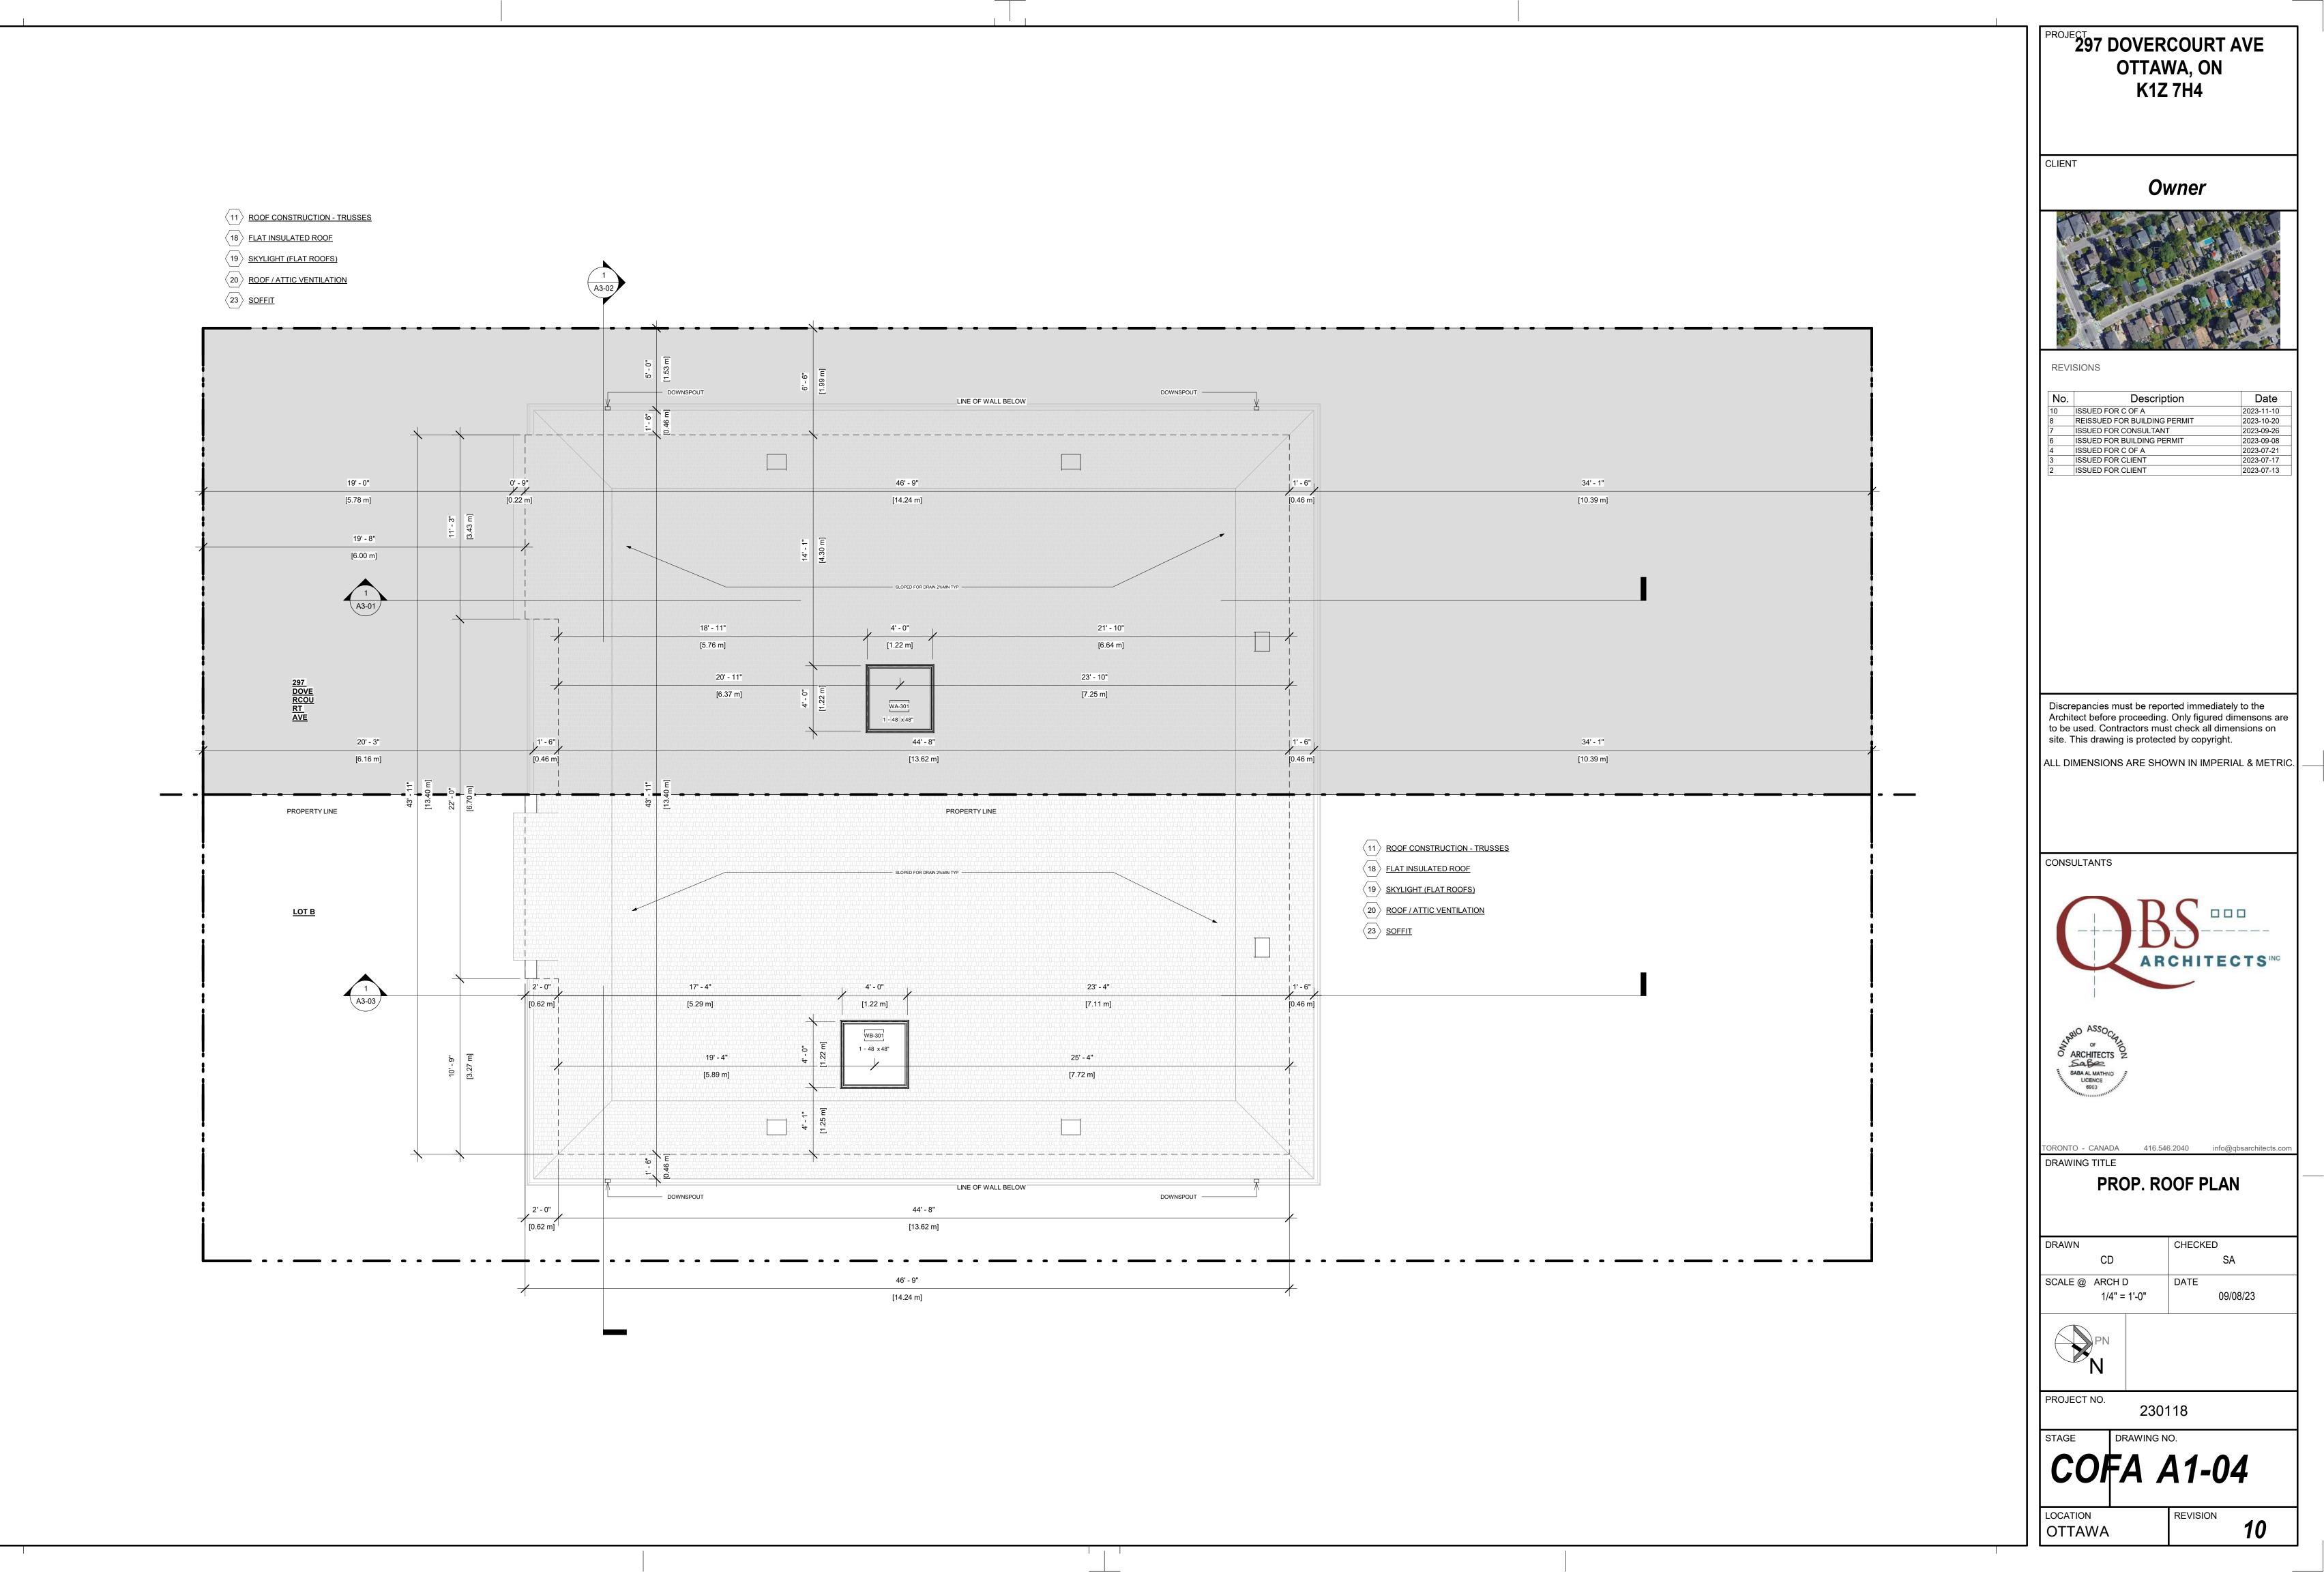

297 DOVERCOURT AVE OTTAWA, ON K1Z 7H4 NOTE: ENSURE ADEQUATE ROOF SEPARATION TO ALLOW FOR FASCIA AND EAVES TROUGH @ LOWER ROOF.

CLIENT

Owner



REVISIONS

No.	Description	Date
0	ISSUED FOR C OF A	2023-11-10
	REISSUED FOR BUILDING PERMIT	2023-10-20
	ISSUED FOR CONSULTANT	2023-09-26
	ISSUED FOR BUILDING PERMIT	2023-09-08
	ISSUED FOR CONSULTANTS	2023-08-08
	ISSUED FOR C OF A	2023-07-21
	ISSUED FOR CLIENT	2023-07-17

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DRAWING TITLE

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PROP. FRONT ELEVATION

	DRAWN	CHECKE	.D
	CD		SA
	SCALE @ ARCH D	DATE	09/08/23


PROJECT NO.

230118

STAGE DRAWING NO.

COFA A2-01

LOCATION OTTAWA

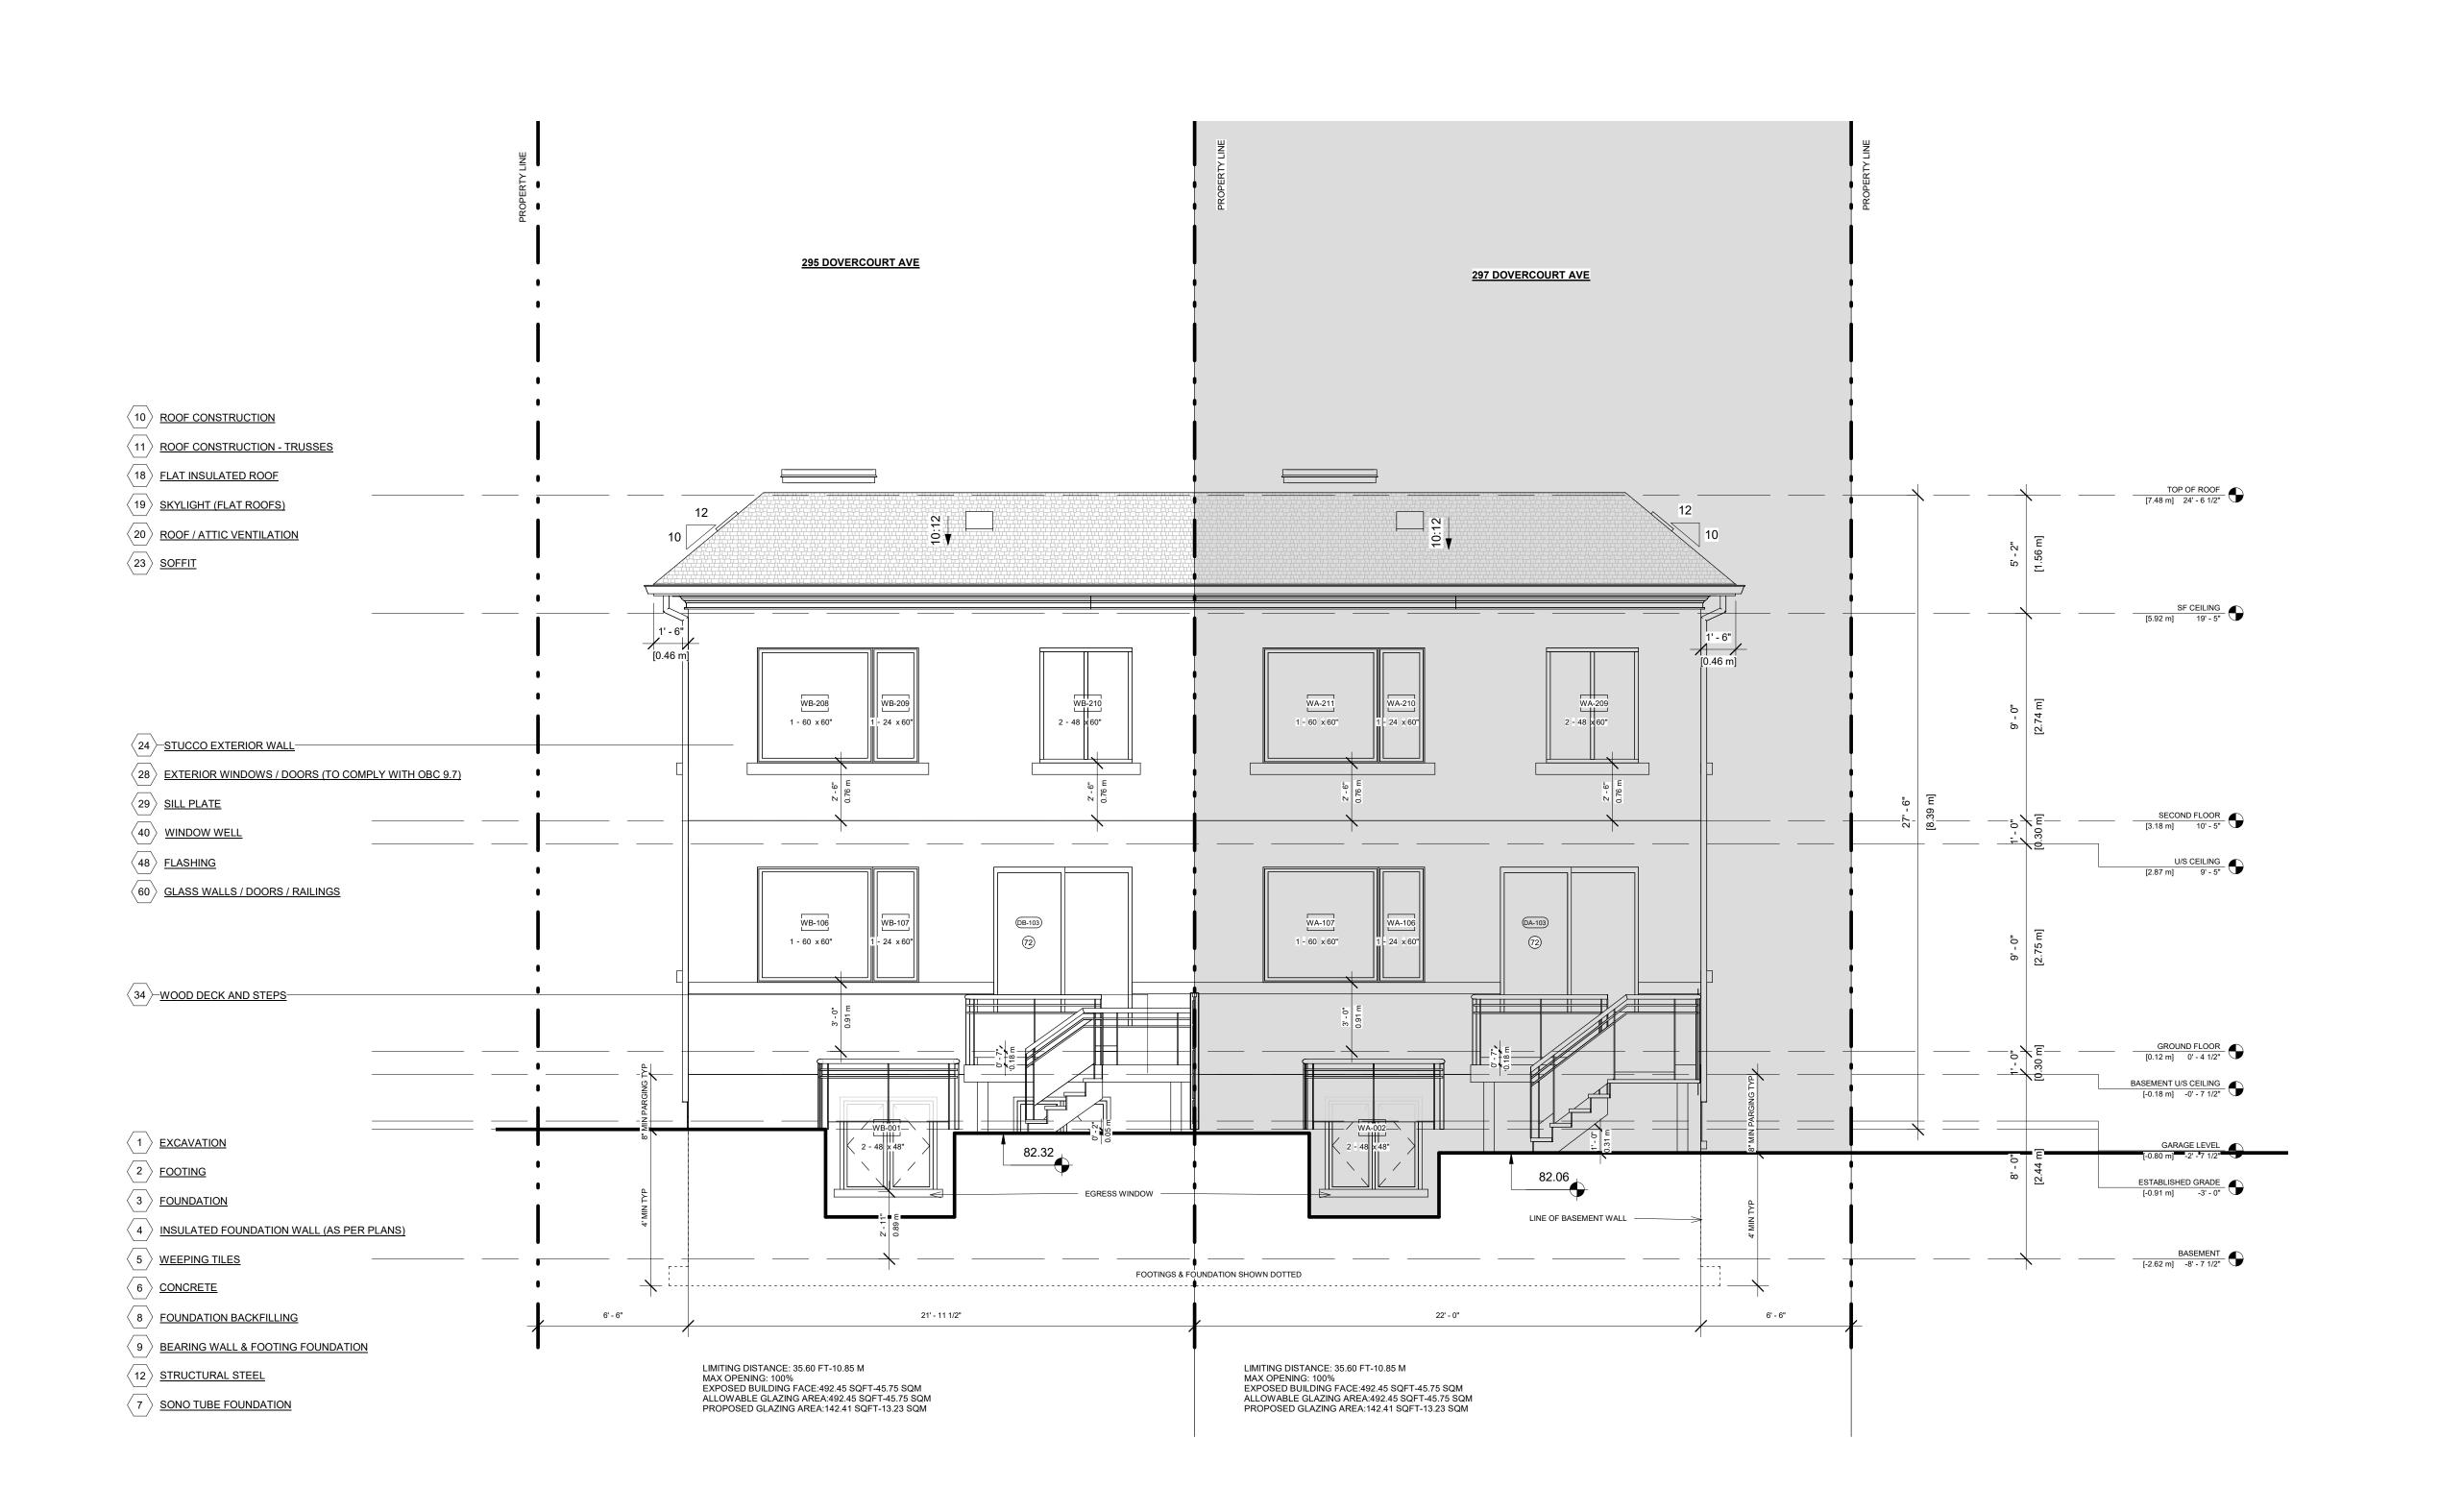

CLIENT

Owner



REVISIONS

No.	Description	Date
10	ISSUED FOR C OF A	2023-11-10
8	REISSUED FOR BUILDING PERMIT	2023-10-20
7	ISSUED FOR CONSULTANT	2023-09-26
6	ISSUED FOR BUILDING PERMIT	2023-09-08
5	ISSUED FOR CONSULTANTS	2023-08-08
4	ISSUED FOR C OF A	2023-07-21
3	ISSUED FOR CLIENT	2023-07-17

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PROP. REAR ELEVATION

	DRAWN	CHECKED
	CD	SA
	SCALE @ ARCH D 1/4" = 1'-0"	DATE 09/08/23

PROJECT NO. **230118**

STAGE DRAWING NO.

COFA A2-02

LOCATION RE



Owner



REVISIONS

No.	Description	Date
10	ISSUED FOR C OF A	2023-11-10
3	REISSUED FOR BUILDING PERMIT	2023-10-20
7	ISSUED FOR CONSULTANT	2023-09-26
3	ISSUED FOR BUILDING PERMIT	2023-09-08

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TORONTO - CANADA 416.546.2040 info@qbsarchitects.co DRAWING TITLE

PROP. LEFT ELEVATION

	DRAWN	CHECKE	ED
	CD		SA
	SCALE @ ARCH D 1/4" =	DATE	09/08/23




PROJECT NO.

STAGE DRAWING NO.

COFA A2-03

230118

LOCATION REVISION OTTAWA

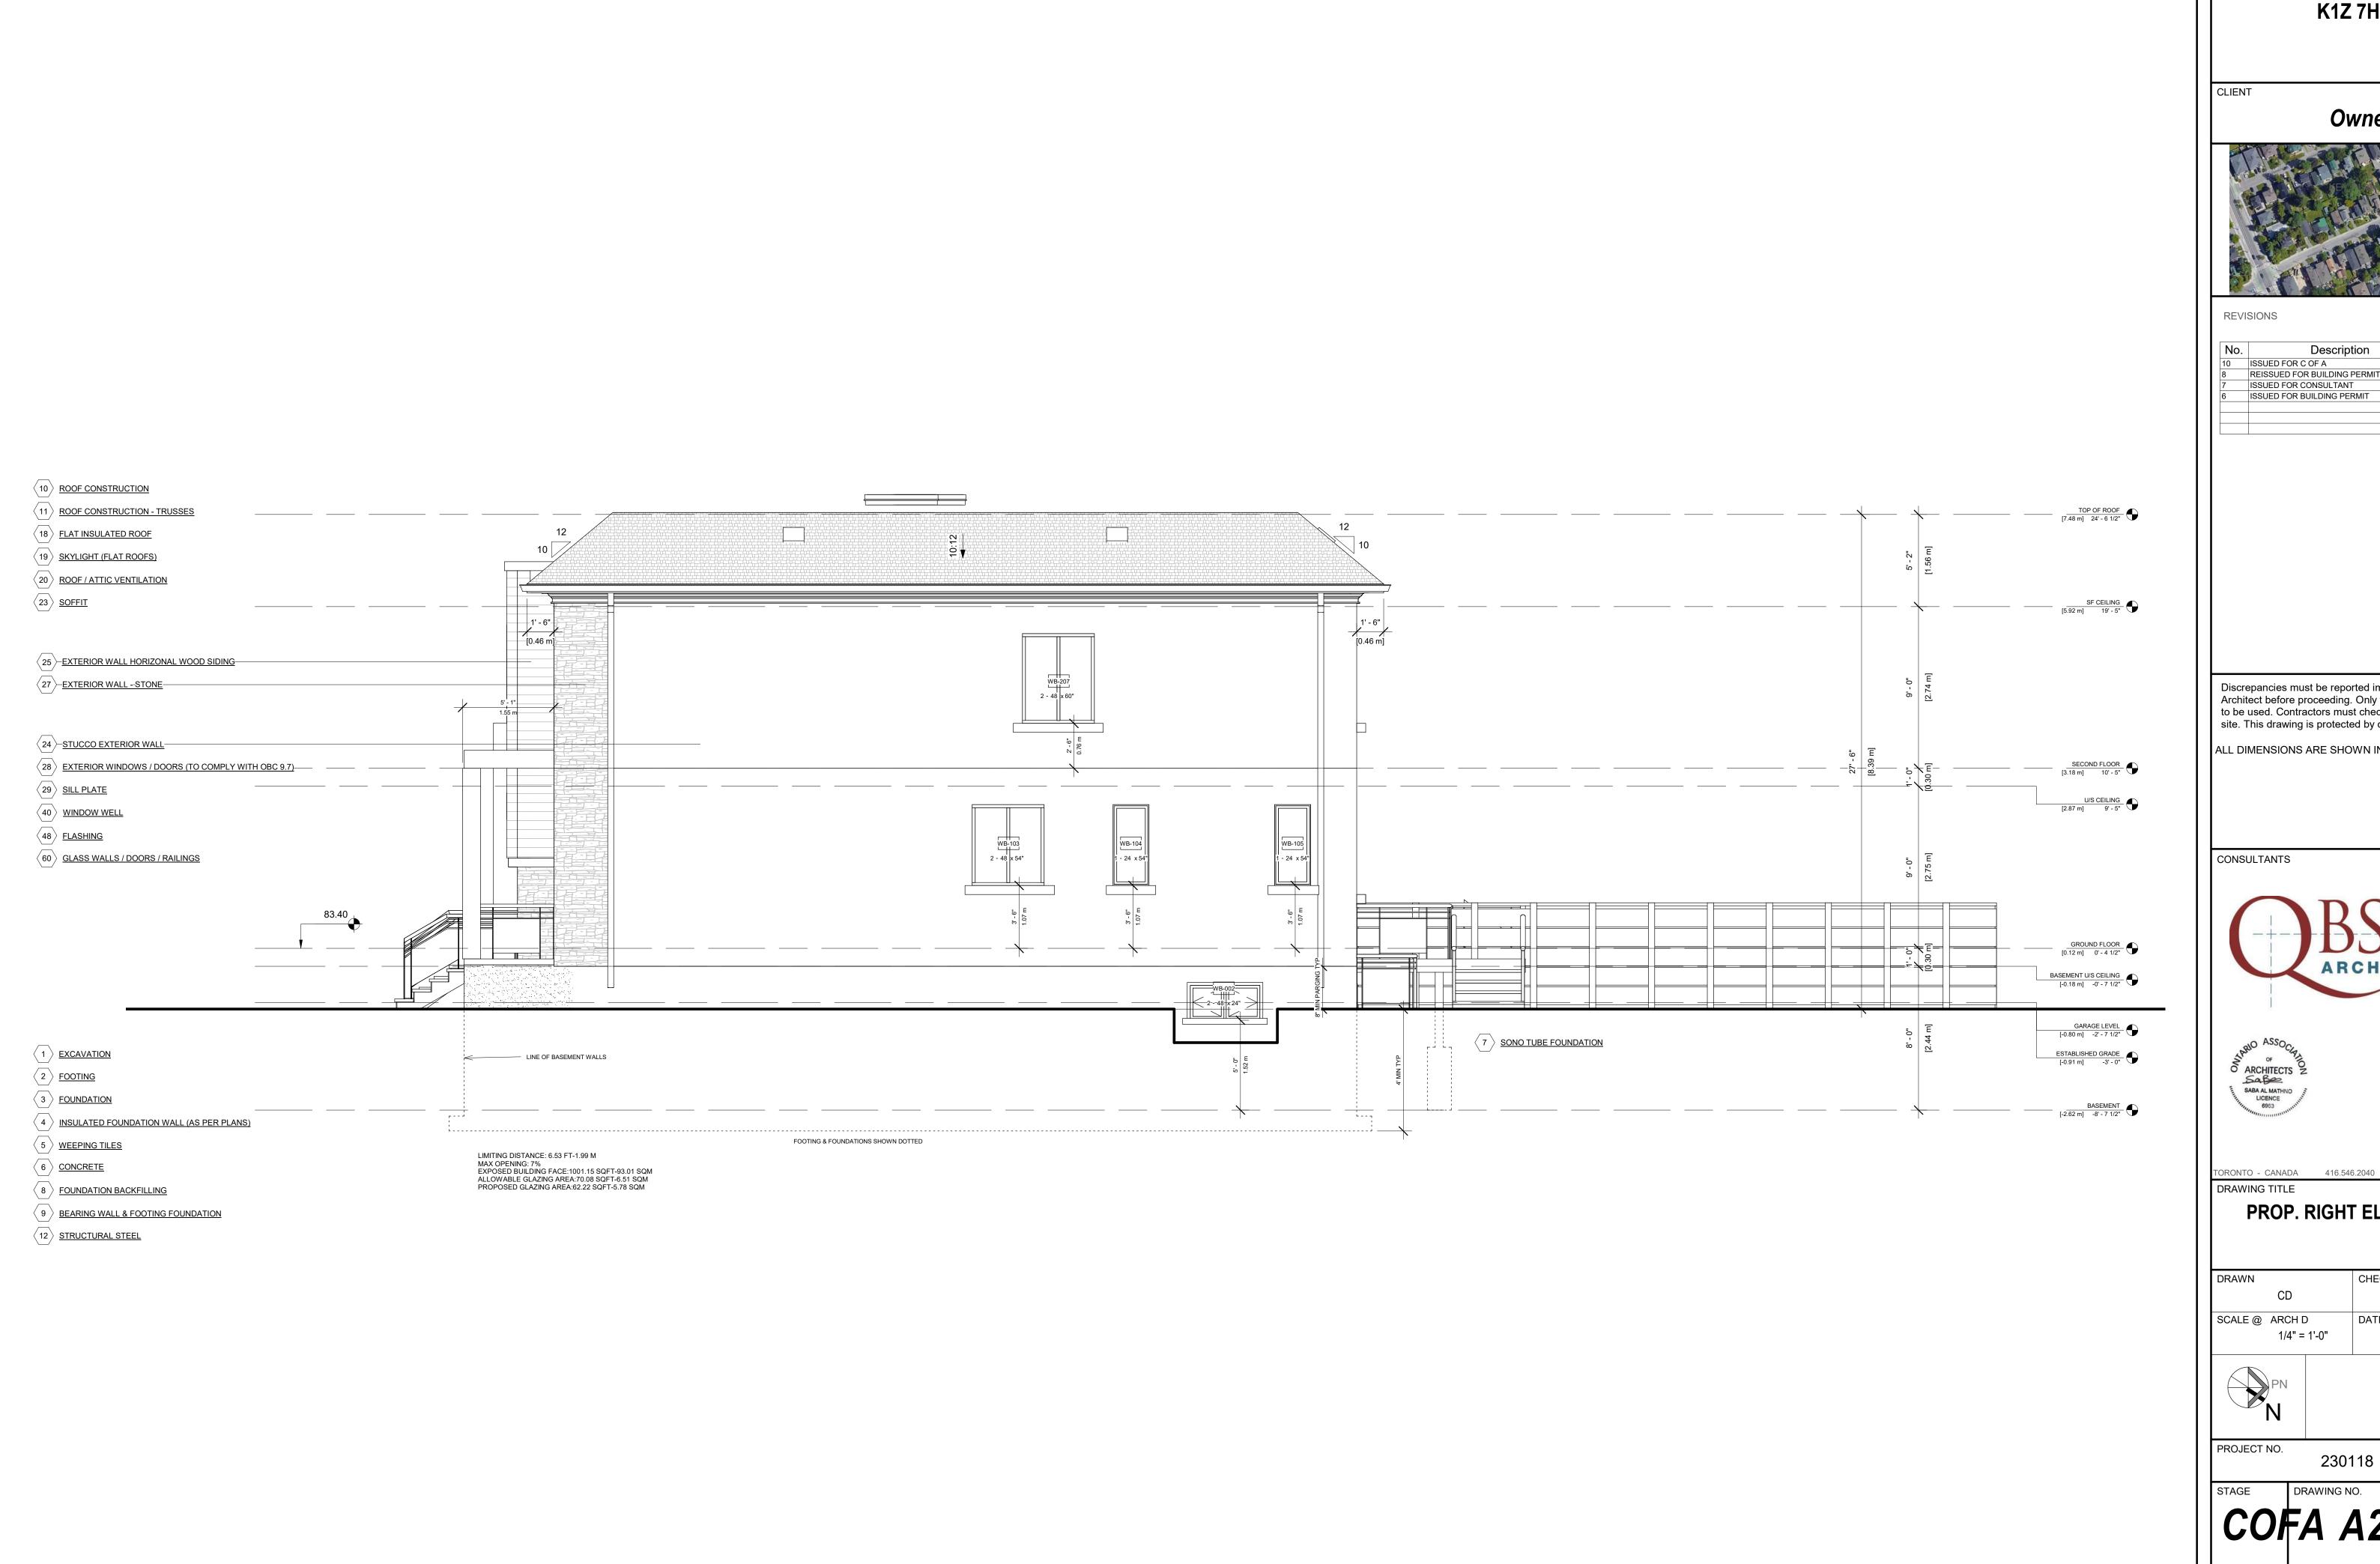

Owner



No.	Description	Date
10	ISSUED FOR C OF A	2023-11-10
8 REISSUED FOR BUILDING PERMIT 7 ISSUED FOR CONSULTANT		2023-10-20
		2023-09-26
6	6 ISSUED FOR BUILDING PERMIT 20:	

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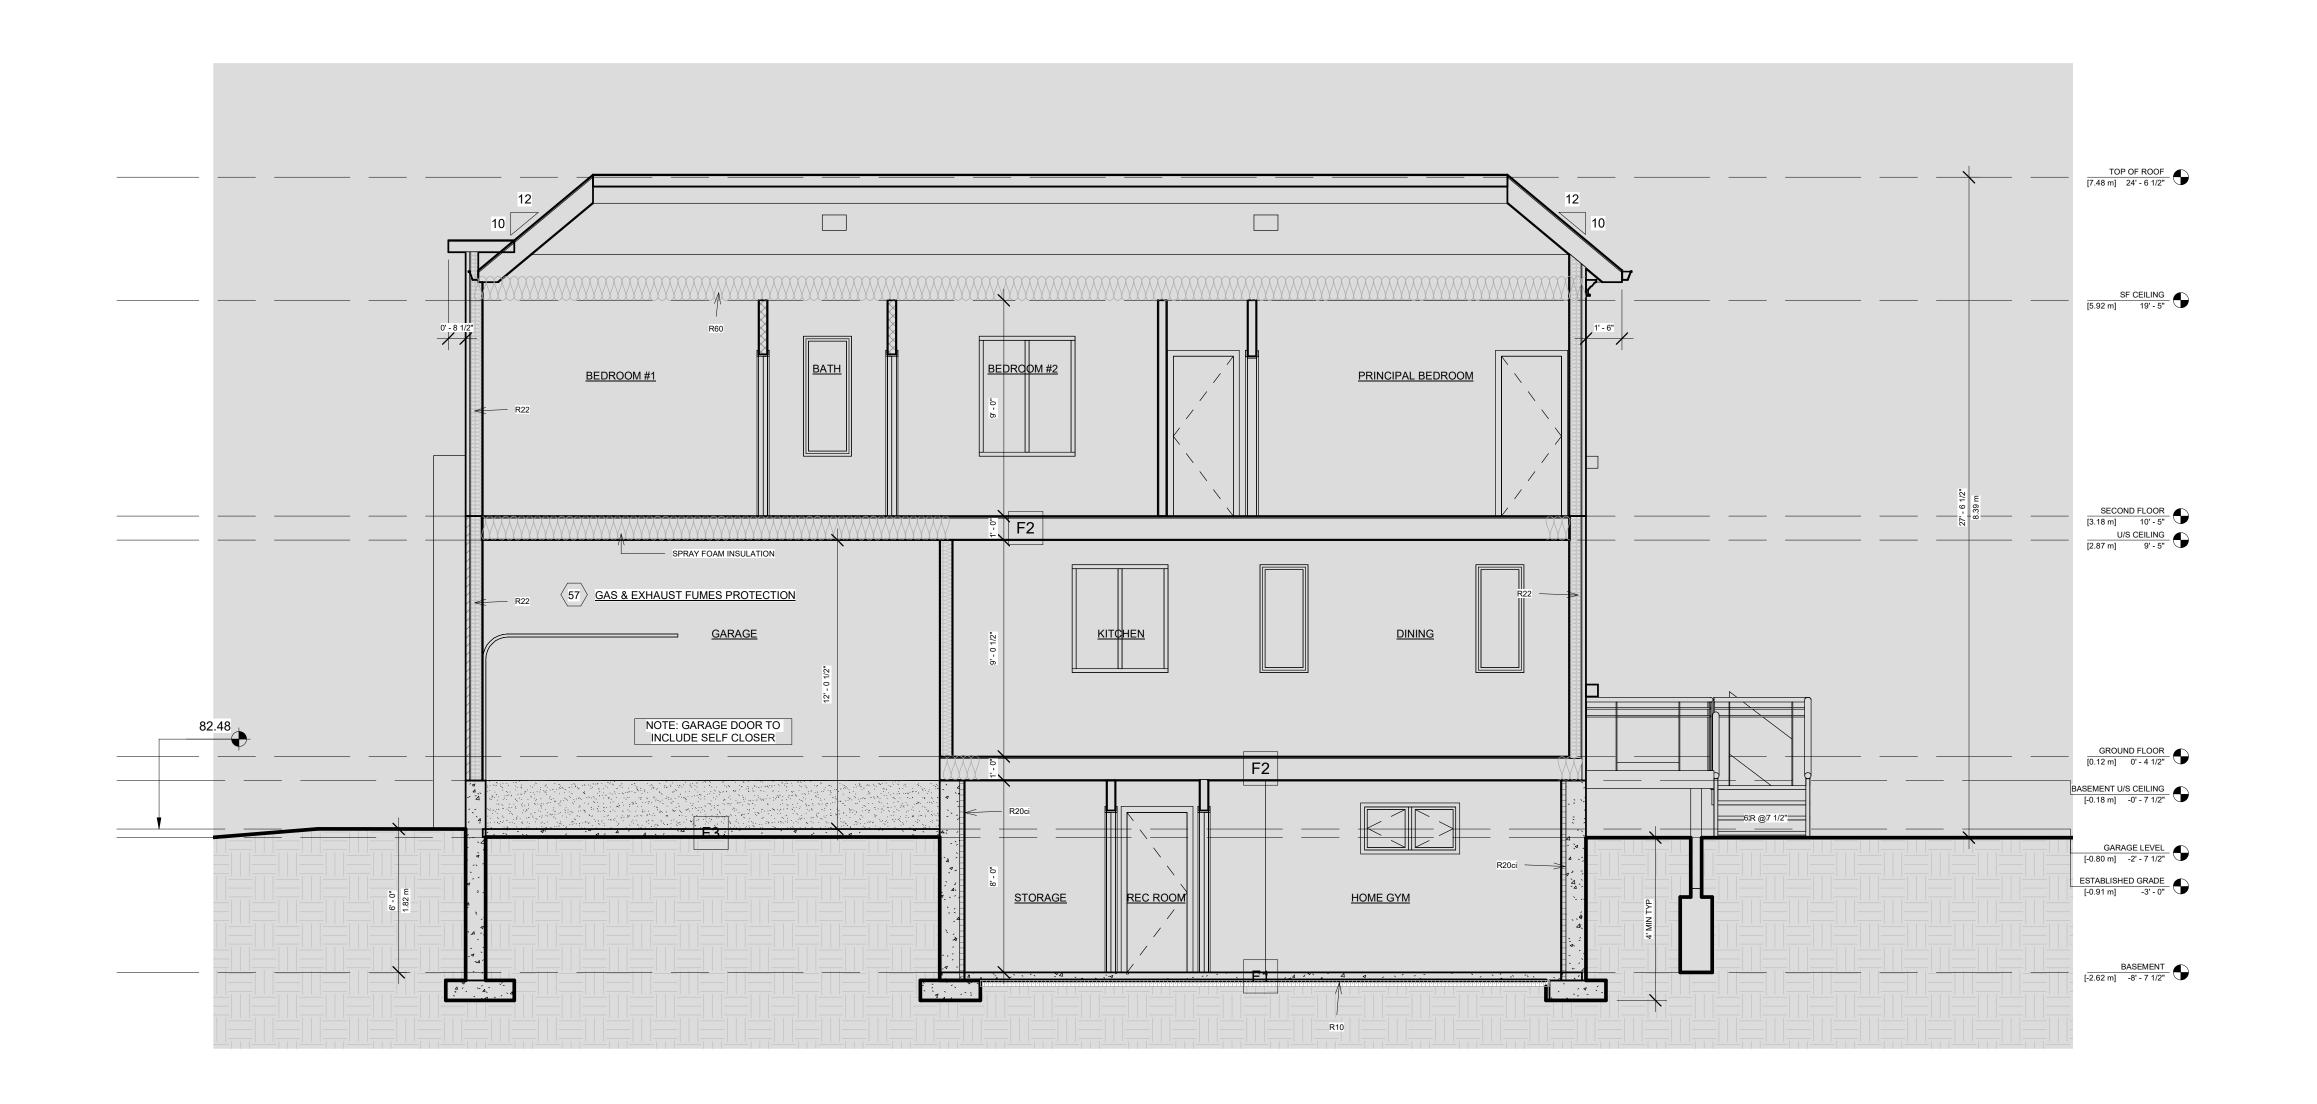
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PROP. RIGHT ELEVATION

	DRAWN	CHECKED
	CD	SA
	SCALE @ ARCH D 1/4" = 1'-0"	DATE 09/08/23

COFA A2-04

LOCATION REVISION OTTAWA



Owner



REVISIONS

No.	Description	Date
10	ISSUED FOR C OF A	2023-11-10
8	REISSUED FOR BUILDING PERMIT	2023-10-20
7	ISSUED FOR CONSULTANT	2023-09-26
6	ISSUED FOR BUILDING PERMIT	2023-09-08
5	ISSUED FOR CONSULTANTS	2023-08-08
4	ISSUED FOR C OF A	2023-07-21
3	ISSUED FOR CLIENT	2023-07-17

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SECTION


DRAWN	CHECKED
CD	SA
SCALE @ ARCH D 1/4" = 1'-0"	DATE 09/08/23

PROJECT NO. 230118

DRAWING NO.

COFA A3-01

REVISION OTTAWA

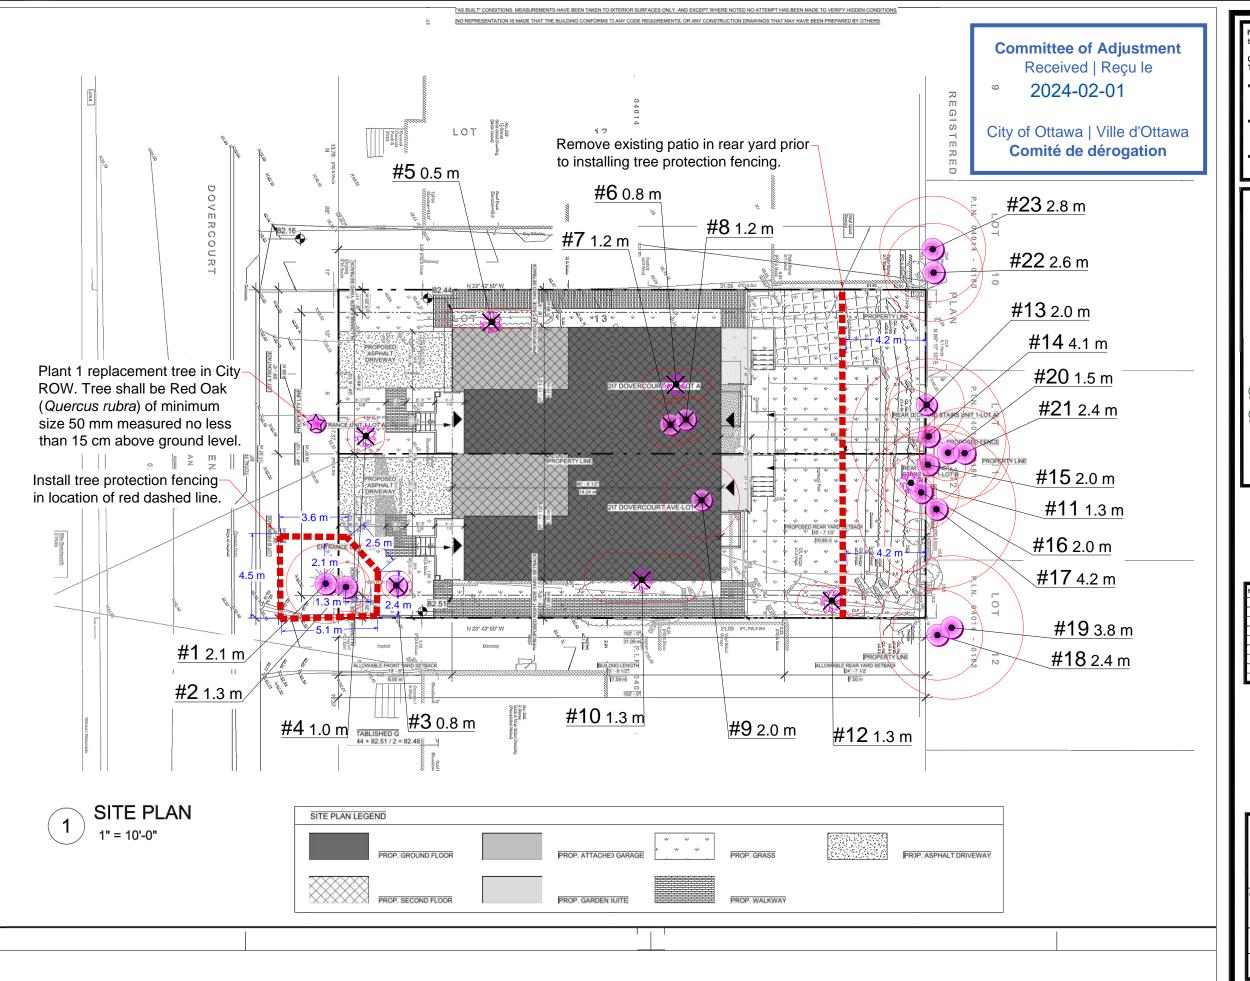

NOTES: Tree locations not surveyed, locations are field measured by the arborist. Work location estimated from clients provided site plan.

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PLAN KEY	
\otimes	TREE RECOMMENDED FOR REMOVAL
+	RETAINED TREE
×	CONIFEROUS TREE FOR REMOVAL
器	RETAINED CONIFEROUS TREE
+	REPLACEMENT TREE
\mathbb{C}	RETAINED HEDGEROW
(XX)	HEDGEROW FOR REMOVAL
	TREE PROTECTION FENCE
	TREE PROTECTION ZONE



DATE	BY	REVISIONS
9/7/2023	JB	



297 Dovercourt Ave Ottawa, ON

Pre-Construction Assessment

CLIENT: Quintessential Developments Inc.

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Tree Map Number	Species	Botanical	DBH (cm) @ 1.4 m	Tree Ownership	Minimum Tree Protection Distance (m)	Health	Structure	Overall Condition	Construction inside Min TPZ? (Y/N)	Construction Impact (None, Low, Medium, High)	Action	Permit Required? (Y/N)	Recommendations
1	Austrian Pine	Pinus nigra	21	City	2.1	Good	Good	Good	N	None	Preserve	N	Protect tree with tree protection fencing.
2	Colorado Blue Spruce	Picea pungens	13	Private	1.3	Good	Good	Good	N	None	Preserve	N	Protect tree with tree protection fencing.
3	Sand Cherry	Prunus x cistena	8	Private	8.0	Good	Good	Good	Υ	High	Remove	N	Remove tree to accommodate proposed construction.
4	Juniper	Juniperus species	10	Private	1.0	Good	Good	Good	Υ	High	Remove	N	Remove tree to accommodate proposed construction.
5	Eastern White Cedar	Thuja occidentalis	2-5	Private	0.5	Good	Good	Good	Y	High	Remove	N	Remove tree to accommodate proposed construction.
6	Eastern White Cedar	Thuja occidentalis	8	Private	8.0	Dead	Dead	Dead	Y	High	Remove	N	Remove tree to accommodate proposed construction.
7	Norway Maple	Acer platanoides	12	Private	1.2	Good	Good	Good	Υ	High	Remove	N	Remove tree to accommodate proposed construction.
8	Crab Apple	Malus profusion	12	Private	1.2	Fair	Fair	Fair	Y	High	Remove	N	Remove tree to accommodate proposed construction.
9	Lilac Tree	Syringa reticulata	20	Private	2.0	Good	Good	Good	Y	Medium	Remove	N	Remove tree to accommodate proposed construction.
10	Eastern White Cedar	Thuja occidentalis	5-13	Private	1.3	Good	Good	Good	Y	Medium	Remove	N	Remove tree to accommodate proposed construction.
11	Eastern White Cedar	Thuja occidentalis	5-13	Private	1.3	Good	Good	Good	N	None	Preserve	N	Protect tree with tree protection fencing.
12	Eastern White Cedar	Thuja occidentalis	2-8	Private	0.8	Good	Good	Good	N	None	Remove	N	Remove tree to accommodate proposed construction.
13	Manitoba Maple	Acer negundo	20	Boundary	2.0	Poor	Poor	Poor	N	None	Remove	N	Remove poor condition tree.
14	Manitoba Maple	Acer negundo	41	Boundary	4.1	Good	Good	Good	N	None	Preserve	N	Protect tree with tree protection fencing.
15	Norway Maple	Acer platanoides	20	Boundary	2.0	Good	Good	Good	N	None	Preserve	N	Protect tree with tree protection fencing.
16	Manitoba Maple	Acer negundo	20	Private	2.0	Good	Good	Good	N	None	Preserve	N	Protect tree with tree protection fencing.
17	Norway Maple	Acer platanoides	42	Neighbour	4.2	Good	Good	Good	N	None	Preserve	N	Protect tree with tree protection fencing.
18	Manitoba Maple	Acer negundo	24	Neighbour	2.4	Good	Good	Good	N	None	Preserve	N	Protect tree with tree protection fencing.
19	Manitoba Maple	Acer negundo	38	Neighbour	3.8	Good	Good	Good	N	None	Preserve	N	Protect tree with tree protection fencing.
20	Common Buckthorn	Rhamnus cathartica	15	Neighbour	1.5	Good	Good	Good	N	None	Preserve	N	Protect tree with tree protection fencing.
21	Manitoba Maple	Acer negundo	24	Neighbour	2.4	Good	Good	Good	N	None	Preserve	N	Protect tree with tree protection fencing.
22	Norway Maple	Acer platanoides	26	Neighbour	2.6	Good	Good	Good	N	None	Preserve	N	Protect tree with tree protection fencing.
23	Norway Maple	Acer platanoides	28	Neighbour	2.8	Good	Good	Good	N	None	Preserve	N	Protect tree with tree protection fencing.

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PLAN	PLAN KEY							
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	RETAINED HEDGEROW							
(XX)	HEDGEROW FOR REMOVAL							
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TREE PROTECTION FENCE

TREE PROTECTION ZONE

No.	DATE	BY	REVISIONS
1	9/7/2023	JB	
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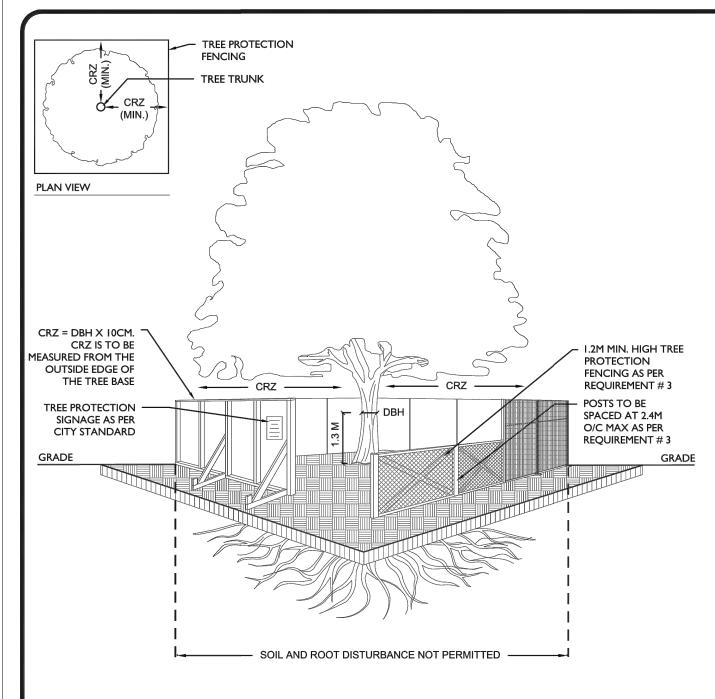
297 Dovercourt Ave Ottawa, ON

Pre-Construction Assessment

CLIENT: Quintessential Developments Inc.

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TREE PROTECTION REQUIREMENTS:

- PRIOR TO ANY WORK ACTIVITY WITHIN THE CRITICAL ROOT ZONE (CRZ = 10 X DIAMETER) OF A TREE, TREE PROTECTION FENCING MUST BE INSTALLED SURROUNDING THE CRITICAL ROOT ZONE, AND REMAIN IN PLACE UNTIL THE WORK IS COMPLETE.
- 2. UNLESS PLANS ARE APPROVED BY CITY FORESTRY STAFF, FOR WORK WITHIN THE CRZ:
 - DO NOT PLACE ANY MATERIAL OR EQUIPMENT INCLUDING OUTHOUSES;
- DO NOT ATTACH ANY SIGNS, NOTICES OR POSTERS TO ANY TREE;
- DO NOT RAISE OR LOWER THE EXISTING GRADE;
- TUNNEL OR BORE WHEN DIGGING;
- DO NOT DAMAGE THE ROOT SYSTEM, TRUNK, OR BRANCHES OR ANY TREE:
- ENSURE THAT EXHAUST FUMES FROM ALL EQUIPMENT ARE NOT DIRECTED TOWARD ANY TREE CANOPY.
- DO NOT EXTEND HARD SURFACE OR SIGNIFICANTLY CHANGE LANDSCAPING
- 3. TREE PROTECTION FENCING MUST BE AT LEAST 1.2M IN HEIGHT, AND CONSTRUCTED OF RIGID OR FRAMED MATERIALS (E.G. MODULOC STEEL, PLYWOOD HOARDING, OR SNOW FENCE ON A 2"X4" WOOD FRAME) WITH POSTS 2.4M APART, SUCH THAT THE FENCE LOCATION CANNOT BE ALTERED. ALL SUPPORTS AND BRACING MUST BE PLACED OUTSIDE OF THE CRZ, AND INSTALLATION MUST MINIMISE DAMAGE TO EXISTING ROOTS. (SEE DETAIL)
- 4. THE LOCATION OF THE TREE PROTECTION FENCING MUST BE DETERMINED BY AN ARBORIST AND DETAILED ON ANY ASSOCIATED PLANS FOR THE SITE (E.G. TREE CONSERVATION REPORT, TREE INFORMATION REPORT, ETC). THE PLAN AND CONSTRUCTED FENCING MUST BE APPROVED BY CITY FORESTRY STAFF PRIOR TO THE COMMENCEMENT OF WORK.
- 5. IF THE FENCED TREE PROTECTION AREA MUST BE REDUCED TO FACILITATE CONSTRUCTION, MITIGATION MEASURES MUST BE PRESCRIBED BY AN ARBORIST AND APPROVED BY CITY FORESTRY STAFF. THESE MAY INCLUDE THE PLACEMENT OF PLYWOOD, WOOD CHIPS, OR STEEL PLATING OVER THE ROOTS FOR PROTECTION OR THE PROPER PRUNING AND CARE OF ROOTS WHERE ENCOUNTERED.

THE CITY'S TREE PROTECTION BY-LAW, 2020-340 PROTECTS BOTH CITY-OWNED TREES, CITY-WIDE, AND PRIVATELY-OWNED TREES WITHIN THE URBAN AREA. PLEASE REFER TO WWW.OTTAWA.CA/TREEBYLAW FOR MORE INFORMATION ON HOW THE TREE BY-LAW APPLIES.

ACCESSIBLE FORMATS AND COMMUNICATION SUPPORTS ARE AVAILABLE, UPON REQUEST



TREE PROTECTION SPECIFICATION

TO BE IMPLEMENTED FOR RETAINED TREES, BOTH ON SITE AND ON ADJACENT SITES, PRIOR TO ANY TREE REMOVAL OR SITE WORKS AND MAINTAINED FOR THE DURATION OF WORK ACTIVITIES ON SITE.

SCALE: NTS

DATE:

MARCH 2021

DRAWING NO.: 1 of 1

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TREE RECOMMENDED FOR REMOVAL



RETAINED TREE



CONIFEROUS TREE FOR REMOVAL



RETAINED CONIFEROUS TREE



REPLACEMENT TREE
RETAINED HEDGEROW




HEDGEROW FOR REMOVAL



TREE PROTECTION FENCE
TREE PROTECTION ZONE



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No.	DATE	BY	REVISIONS
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DRAWING NO.: 001 SCALE: 1:200
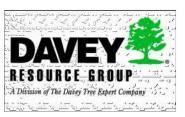
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