



NOTES IN REFERENCE to AUGUST 2024 MINOR VARIANCE: THE EXISTING BUILDING IS A DUPLEX AS COMPLETED IN 2016.

THE CURRENT PROPOSAL IS TO MODIFY THE INTERIOR IN ORDER TO SEGREGATE the BASEMENT AREA INTO A SEPARATE APARTMENT - CREATING A 3-UNIT BUILDING.

NO ADDITIONS OR MODIFICATIONS ARE REQUIRED or PROPOSED AS PART OF THE CONVERSION TO 3-UNITS.

THE SIZE, LOCATION and FEATURES OF THE BUILDING AS SHOWN ON THIS ELEVATION DRAWING WILL REMAIN AS-IS

SOUTH ELEVATION UNPROTECTED OPENINGS EXPOSED BUILDING FACE 5: TOTAL AREA OF BUILDING FACE = 26m2 DISTANCE 12.0m = 100% ALLOWED, 14% PROPOSED COMBUSTIBLE CONSTRUCTION COMBUSTIBLE CLADDING

SOUTH ELEVATION UNPROTECTED OPENINGS EXPOSED BUILDING FACE 2, 3, 4: TOTAL AREA OF BUILDING FACE = 7.7m2 DISTANCE 12.0m = 100% ALLOWED, 23% PROPOSED COMBUSTIBLE CONSTRUCTION COMBUSTIBLE CLADDING

WEST ELEVATION UNPROTECTED OPENINGS EXPOSED BUILDING FACE 1: TOTAL AREA OF BUILDING FACE = 1.0m2 DISTANCE 12.0m = 100% ALLOWED, 50% PROPOSED COMBUSTIBLE CONSTRUCTION COMBUSTIBLE CLADDING



STAMP:





VISIO	NS:	
No.	DESCRIPTION	DATE
04	RE-ISSUED FOR BUILDING PERMIT	2016/03/16
03	ISSUED FOR BUILDING PERMIT	2016/02/19
02	ISSUED FOR PERMIT REVIEW	2016/02/05
01	ISSUED FOR COORDINATION	2016/01/04

DRAWINGS COPYRIGHT ROBERTSON MARTIN ARCHITECTS

DO NOT COPY, DO NOT SCALE DRAWINGS. ALL DIMENSIONS TO BE CHECKED AND VERIFIED

PROJECT:

55 GORDON ST. DEVELOPMENT

55 GORDON ST. DRAWING:

OTTAWA, ONTARIO

WEST & EAST ELEVATION

APPROVED BY: DESIGNED BY: DB / NB DRAWN BY:


DATE:

AS SHOWN RMA PROJECT NUMBER

15212

A-3.0

SCALE:

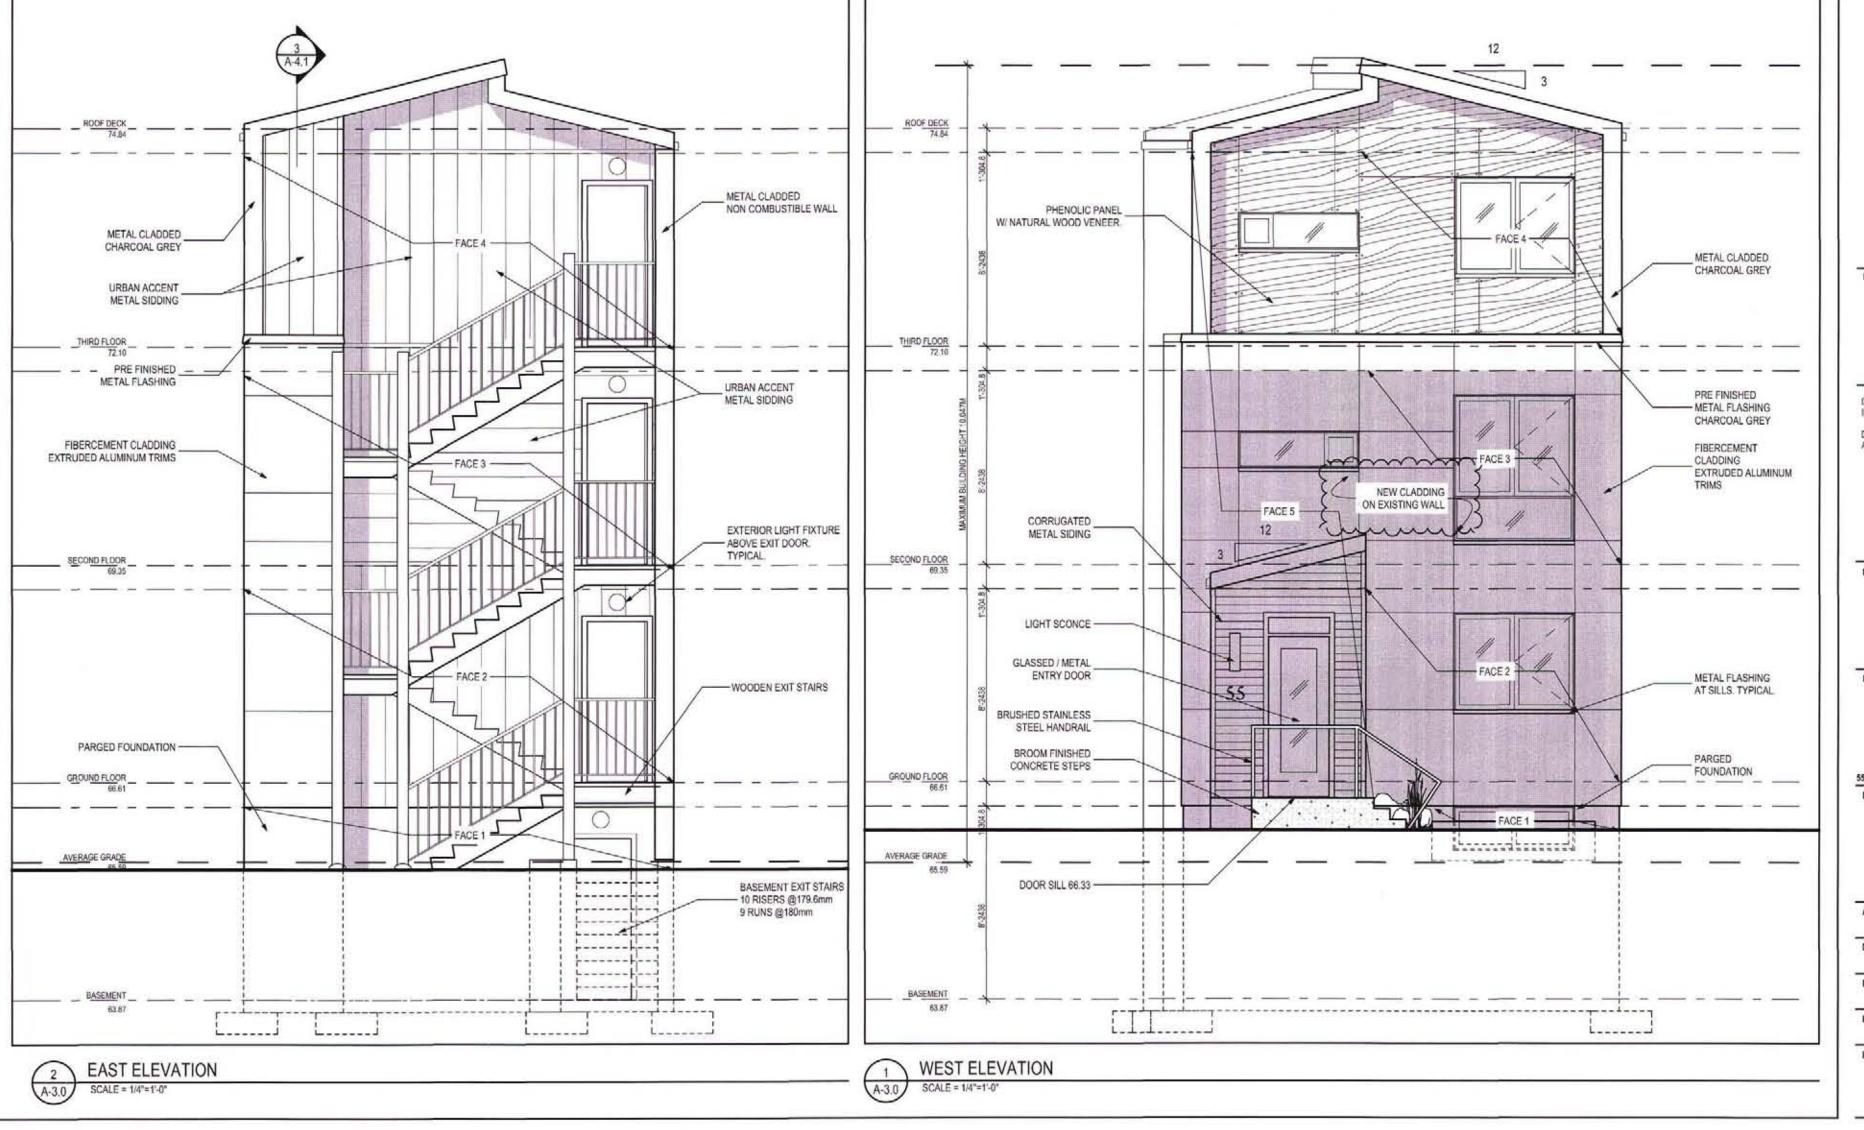

SOUTH ELEVATION UNPROTECTED OPENINGS EXPOSED BUILDING FACE 2, 3, 4:

WEST ELEVATION UNPROTECTED OPENINGS EXPOSED BUILDING FACE 1:

DISTANCE MORE THAN 10.0m = 100% ALLOWED, 9.3% PROPOSED

DISTANCE MORE THAN 10.0m = 100% ALLOWED, 15% PROPOSED

TOTAL AREA OF BUILDING FACE = 13.3m2

TOTAL AREA OF BUILDING FACE = 4.3m2

COMBUSTIBLE CONSTRUCTION

COMBUSTIBLE CONSTRUCTION

COMBUSTIBLE CLADDING

COMBUSTIBLE CLADDING

SOUTH ELEVATION UNPROTECTED OPENINGS EXPOSED BUILDING FACE 5: TOTAL AREA OF BUILDING FACE = 4.5m2 DISTANCE 5.9m = 100% ALLOWED, 11% PROPOSED COMBUSTIBLE CONSTRUCTION COMBUSTIBLE CLADDING SOUTH ELEVATION UNPROTECTED OPENINGS EXPOSED BUILDING FACE 4: TOTAL AREA OF BUILDING FACE = 48m2 DISTANCE 3.0m = 19% ALLOWED, 11% PROPOSED COMBUSTIBLE OR NON COMBUSTIBLE CONSTRUCTION NONCOMBUSTIBLE CLADDING SOUTH ELEVATION UNPROTECTED OPENINGS EXPOSED BUILDING FACE 3: TOTAL AREA OF BUILDING FACE = 48m2 DISTANCE 3.0m = 19% ALLOWED, 11% PROPOSED COMBUSTIBLE OR NON COMBUSTIBLE CONSTRUCTION NONCOMBUSTIBLE CLADDING SOUTH ELEVATION UNPROTECTED OPENINGS EXPOSED BUILDING FACE 2: TOTAL AREA OF BUILDING FACE = 48m2 DISTANCE 3.0m = 19% ALLOWED, 11% PROPOSED COMBUSTIBLE OR NON COMBUSTIBLE CONSTRUCTION NONCOMBUSTIBLE CLADDING SOUTH ELEVATION UNPROTECTED OPENINGS EXPOSED BUILDING FACE 1: TOTAL AREA OF BUILDING FACE = 11.2m2 DISTANCE 3.0m = 55% ALLOWED, 22% PROPOSED

COMBUSTIBLE CONSTRUCTION COMBUSTIBLE CLADDING

NOTES IN REFERENCE to AUGUST 2024 MINOR VARIANCE: THE EXISTING BUILDING IS A DUPLEX AS COMPLETED IN 2016.

THE CURRENT PROPOSAL IS TO MODIFY THE INTERIOR IN ORDER TO SEGREGATE the BASEMENT AREA INTO A SEPARATE APARTMENT - CREATING A 3-UNIT BUILDING.

NO ADDITIONS OR MODIFICATIONS ARE REQUIRED or PROPOSED AS PART OF THE CONVERSION TO 3-UNITS.

THE SIZE, LOCATION and FEATURES OF THE BUILDING AS SHOWN ON THIS ELEVATION DRAWING WILL REMAIN AS-IS Robertson Martin Architects 216 Pretoria Ave, Ottawa, ON, K1S 1X2





EVISIO	NS:	
No.	DESCRIPTION	DATE
04	RE-ISSUED FOR BUILDING PERMIT	2016/03/16
03	ISSUED FOR BUILDING PERMIT	2016/02/19
02	ISSUED FOR PERMIT REVIEW	2016/02/05
01	ISSUED FOR COORDINATION	2016/01/04

DRAWINGS COPYRIGHT ROBERTSON MARTIN ARCHITECTS

DO NOT COPY. DO NOT SCALE DRAWINGS. ALL DIMENSIONS TO BE CHECKED AND VERIFIED

55 GORDON ST. DEVELOPMENT

55 GORDON ST

OTTAWA, ONTARIO

SOUTH ELEVATION


APPROVED BY: DESIGNED BY: DB / NB DRAWN BY:

DATE:

SCALE: AS SHOWN SHEET NUMBER:

15212

A-3.1

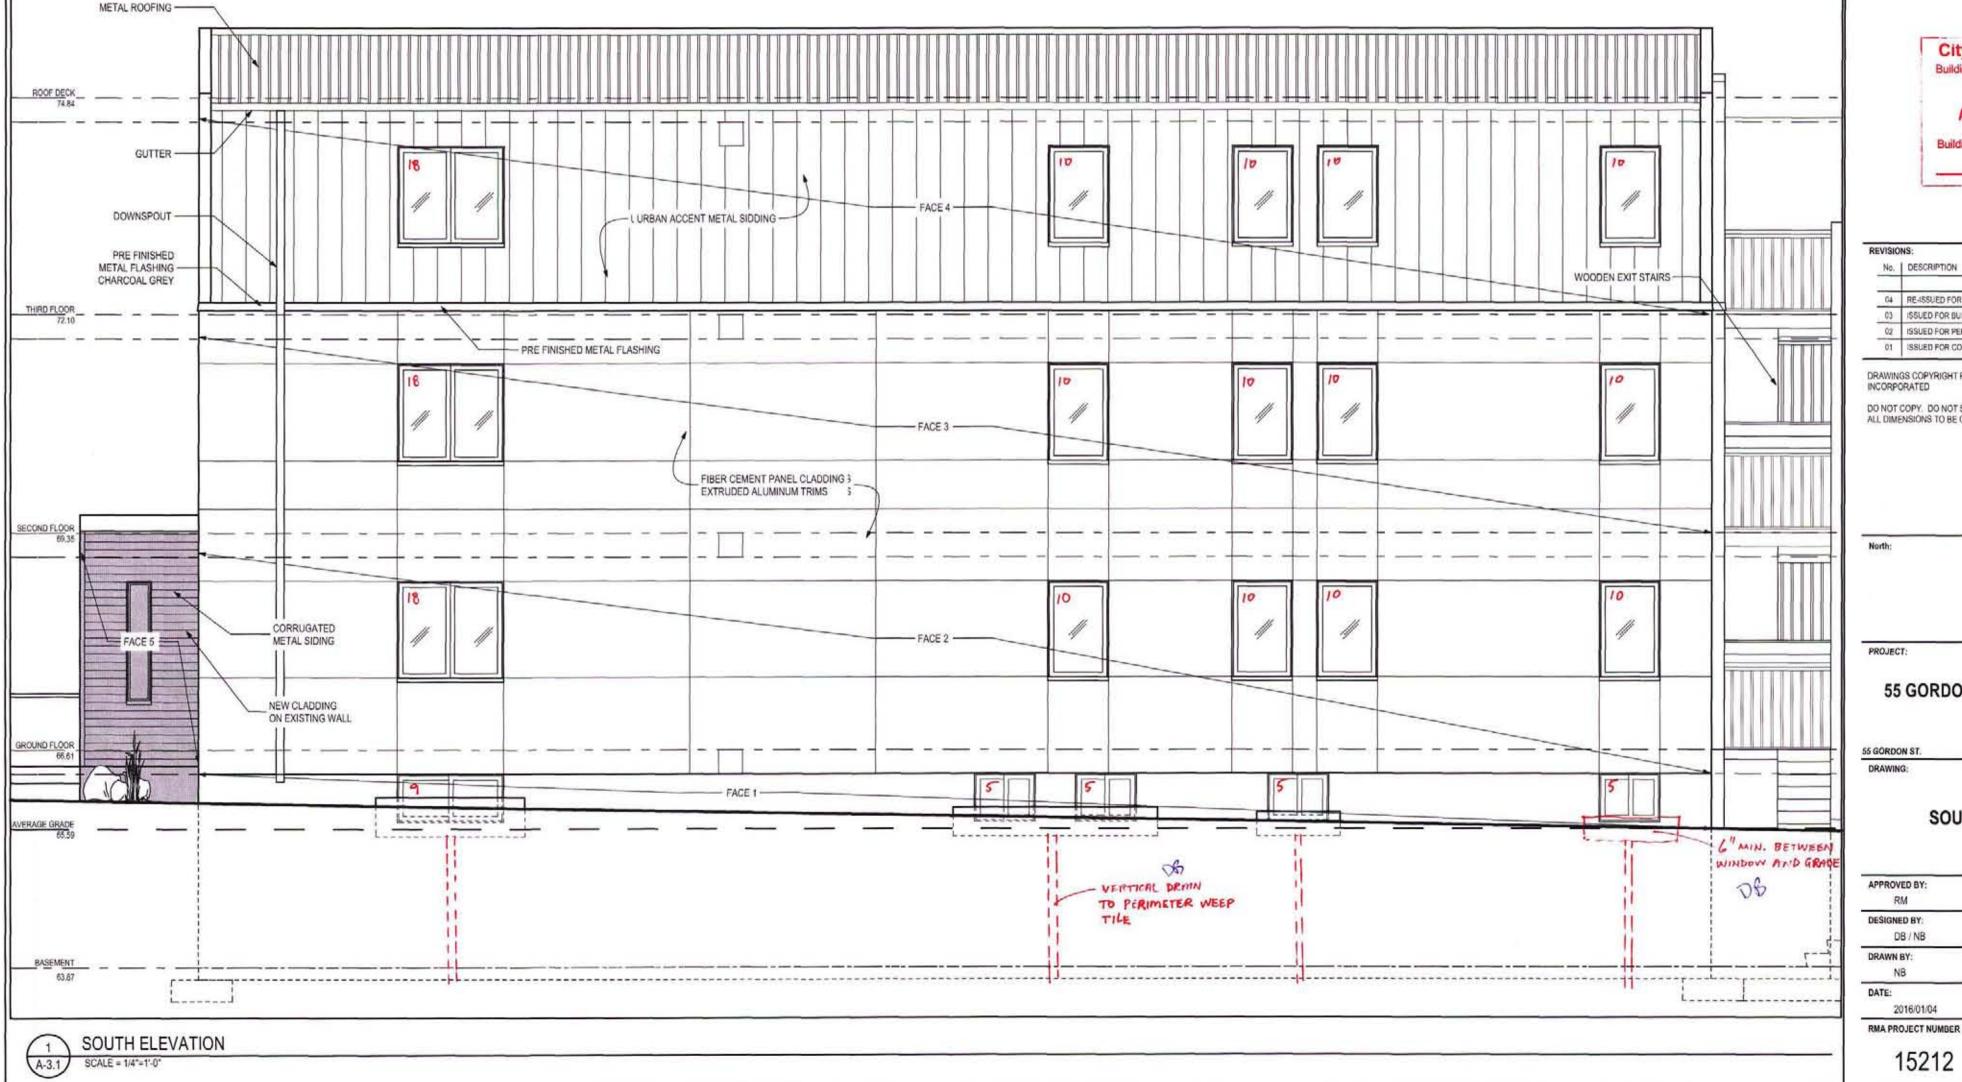

NOTES IN REFERENCE to AUGUST 2024 MINOR VARIANCE: THE EXISTING BUILDING IS A DUPLEX AS COMPLETED IN 2016.

THE CURRENT PROPOSAL IS TO MODIFY THE INTERIOR IN ORDER TO SEGREGATE the BASEMENT AREA INTO A SEPARATE APARTMENT - CREATING A 3-UNIT BUILDING.

NO ADDITIONS OR MODIFICATIONS ARE REQUIRED or PROPOSED AS PART OF THE CONVERSION TO 3-UNITS.

- PITCH BEYOND

THE SIZE, LOCATION and FEATURES OF THE BUILDING AS SHOWN ON THIS ELEVATION DRAWING WILL REMAIN AS-IS



STAMP:

METAL ROOFING

- GUTTER

- DOWNSPOUT





EVISIONS:				
No.	DESCRIPTION	DATE		
04	RE-ISSUED FOR BUILDING PERMIT	2016/03/16		
03	ISSUED FOR BUILDING PERMIT	2016/02/19		
02	SSUED FOR PERMIT REVIEW	2016/02/05		
01	ISSUED FOR COORDINATION	2016/01/04		

DRAWINGS COPYRIGHT ROBERTSON MARTIN ARCHITECTS

DO NOT COPY. DO NOT SCALE DRAWINGS. ALL DIMENSIONS TO BE CHECKED AND VERIFIED

55 GORDON ST. DEVELOPMENT

OTTAWA, ONTARIO


NORTH ELEVATION

DESIGNED BY: DB / NB DRAWN BY:

SCALE: 2016/01/04

RMA PROJECT NUMBER

A-3.2 15212

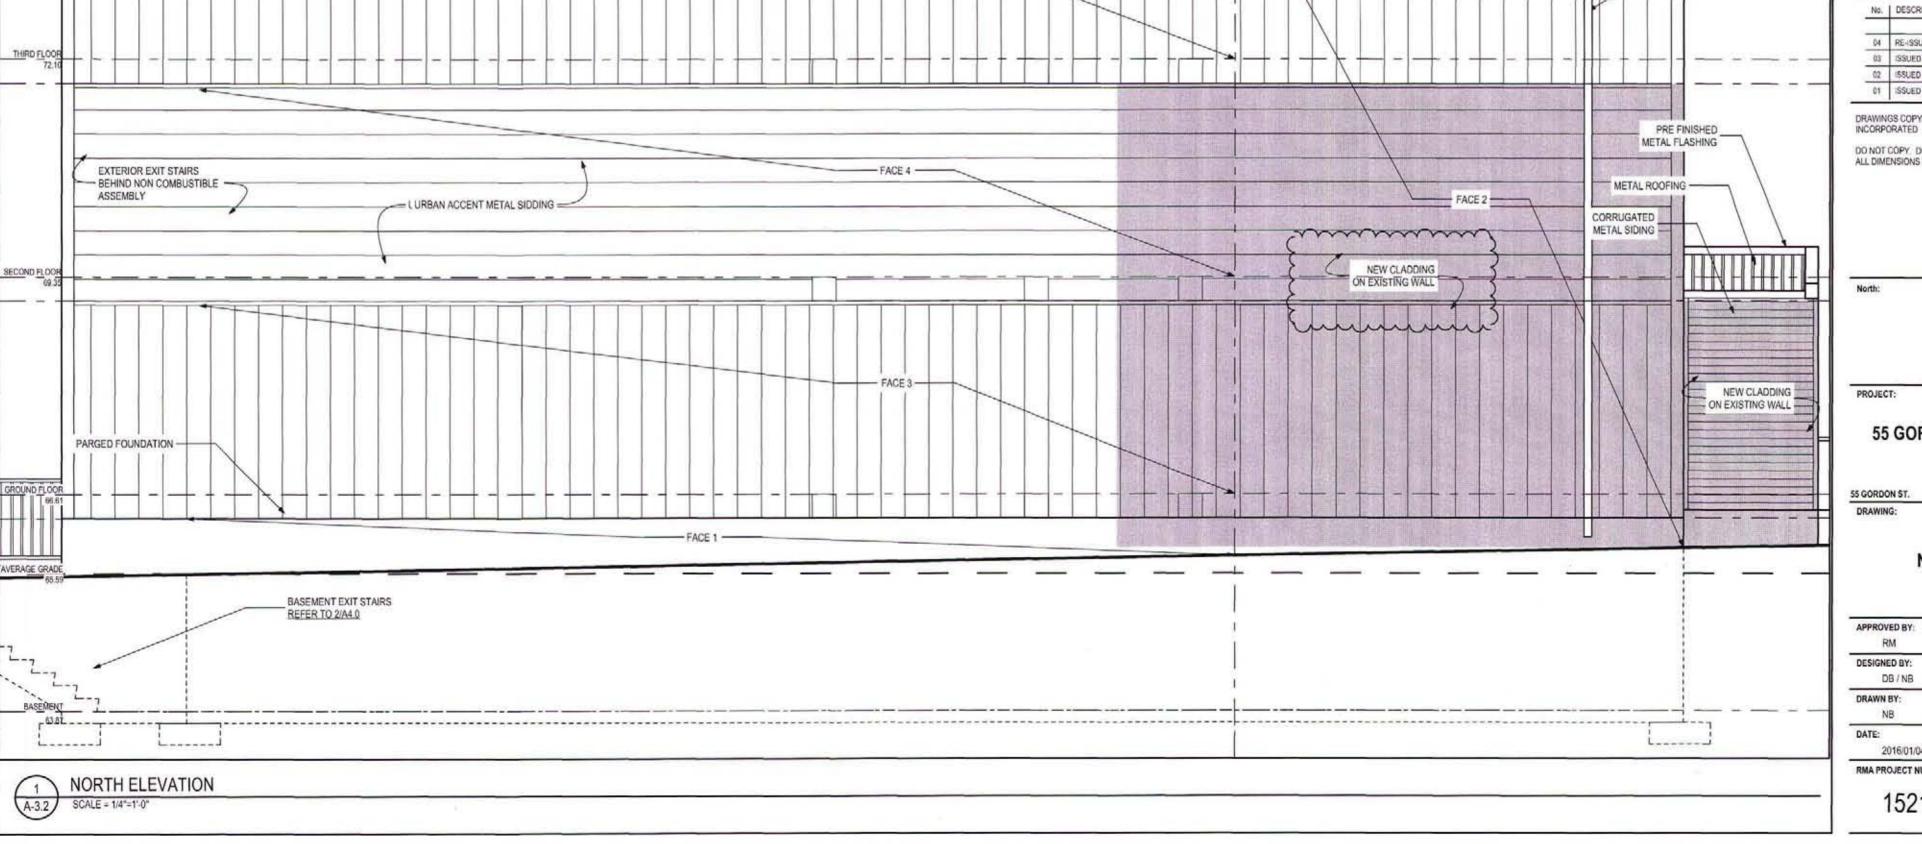

NORTH ELEVATION UNPROTECTED OPENINGS EXPOSED BUILDING FACE 3, 4 & 5:

NORTH ELEVATION UNPROTECTED OPENINGS EXPOSED BUILDING FACE 2:

NORTH ELEVATION UNPROTECTED OPENINGS EXPOSED BUILDING FACE 1:

TOTAL AREA OF BUILDING FACE = 31m2

TOTAL AREA OF BUILDING FACE = 48m2

NON COMBUSTIBLE CONSTRUCTION NONCOMBUSTIBLE CLADDING

NON COMBUSTIBLE CONSTRUCTION NONCOMBUSTIBLE CLADDING

NON COMBUSTIBLE CONSTRUCTION NONCOMBUSTIBLE CLADDING

DISTANCE LESS THAN 1.2m = 0% ALLOWED, 0% PROPOSED

DISTANCE LESS THAN 1.2m = 0% ALLOWED, 0% PROPOSED

TOTAL AREA OF BUILDING FACE = 8m2 DISTANCE LESS THAN 1.2m = 0% ALLOWED, 0% PROPOSED