

LANDSCAPE / PLANTING PLAN

LEGEND	
PROPERTY LINE	REGRADING LIMITS
PROPOSED BUILIDNG	
PROPOSED ASPHALT	100/5YR POND LIMITS
SOD SOD	EXISTING CEDAR HEDGE
STONE AND SLAB PATHWAY	

Committee of Adjustment Received | Reçu le 2024-07-25 City of Ottawa | Ville d'Ottawa Comité de dérogation

PLANT LIST					
KEY	QTY	BOTANICAL NAME	COMMON NAME	CAL/ HT.	CONDITION/REMARKS
REES					
Qr	2	Quercus rubra	Red Oak	70mm	W.B. Staked
SrIP	2	Syringa reticulata 'Ivory Pillar'	Ivory Pillar Tree Lilac	50mm	W.B. Staked

TREE SOIL VOLUME MATRIX				
Soil Volume Area, Tree Quantity and Size	Tree Quantity	OTTAWA TARGET SOIL VOLUME (m3)	Design Soil Volume	SOIL ADEQUACY percentage
AREAA- 2 Large shade trees in plant bed				
Plant bed (708.5 sq m x 0.45 metre deep)	2	36.0	318.9	885.70%
AREA B- 1 small tree in plant bed				
plant bed (22.7 sq m x .45 metre deep)	1	15.0	10.2	68.10%

NOTE:

THIS PLAN IS ISSUED FOR SITE PLAN CONTROL SUBMISSION ONLY. ADDITIONAL DETAILING AND SPECIFICATIONS ARE REQUIRED PRIOR TO TENDERING OR CONSTRUCTION.

DRAWINGS TO BE READ IN CONJUNCTION WITH TREE CONSERVATION REPORT. REFER TO TREE CONSERVATION REPORT PREPARED BY MARIETTA RUHLAND DATED 2021-12-13 FOR TREE PROTECTION **MEASURES AND DETAILS.**

TREES TO BE PLANTED 2M FROM HYDRO LINE WHERE APPLICABLE. CRZ PROTECTION FENCE TO BE 80CM FROM TRUNK.

GENERAL NOTES

.1 All general site information and conditions compiled from existing plans, surveys and consultant's field notes. Report all discrepancies prior to any work. No responsibility is born by the Consultant for unknown subsurface conditions.

.2 The location of the utilities is approximate only, and the exact location should be determined by consulting the municipal authorities and utility companies concerned. The Contractor shall prove the location of utilities and shall be responsible for adequate protection from damage.

.3 All dimensions shown are to be verified on site prior to any construction. No deviations are to be made from the layouts as shown on this plan without prior consultation with

the Landscape Architect and Owner.

.4 Obtain approval of Landscape Architect for granular base and layout of all pavement areas prior to construction.

.5 Stake planting locations and receive approval of Landscape Architect, prior to excavation of any planting pits. No substitutions of plant material shall be made without prior approval of the Landscape Architect.

.6 Where clay is encountered proper drainage must be ensured in tree/shrub pits, prior to planting. Have method approved by Landscape Architect.


.7 All sodded areas to receive a minimum of 150mm of topsoil over graded sub-base. If sod with mesh is used, mesh to be removed completely during sodding operations. Sod shall come from an approved source and shall be laid within 24 hours of being cut in the nursery. Only nursery sod shall be

.8 Final subgrade is to approved by the Landscape Architect prior to sod being laid.

.9 Maintain positive surface runoff through the entire construction period.

.10 Reinstate all areas and items damaged as a result of construction activities.

6		
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4		
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2		
1	ISSUED FOR REVIEW	FEB 07/22
no.	issue / revision	date

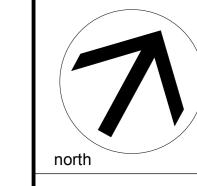

Ruhland & Associates Ltd

project

3776 ALBION RD, OTTAWA ON


LANDSCAPE / PLANTING **PLAN**


	scale	drawn by	designed by	
	1:125	C. Reed	C. Reed	
	date	checked by	plot date	
	February 2022	M. Ruhland		


drawing number

20-1620

Contractor to check and verify all dimensions on the job

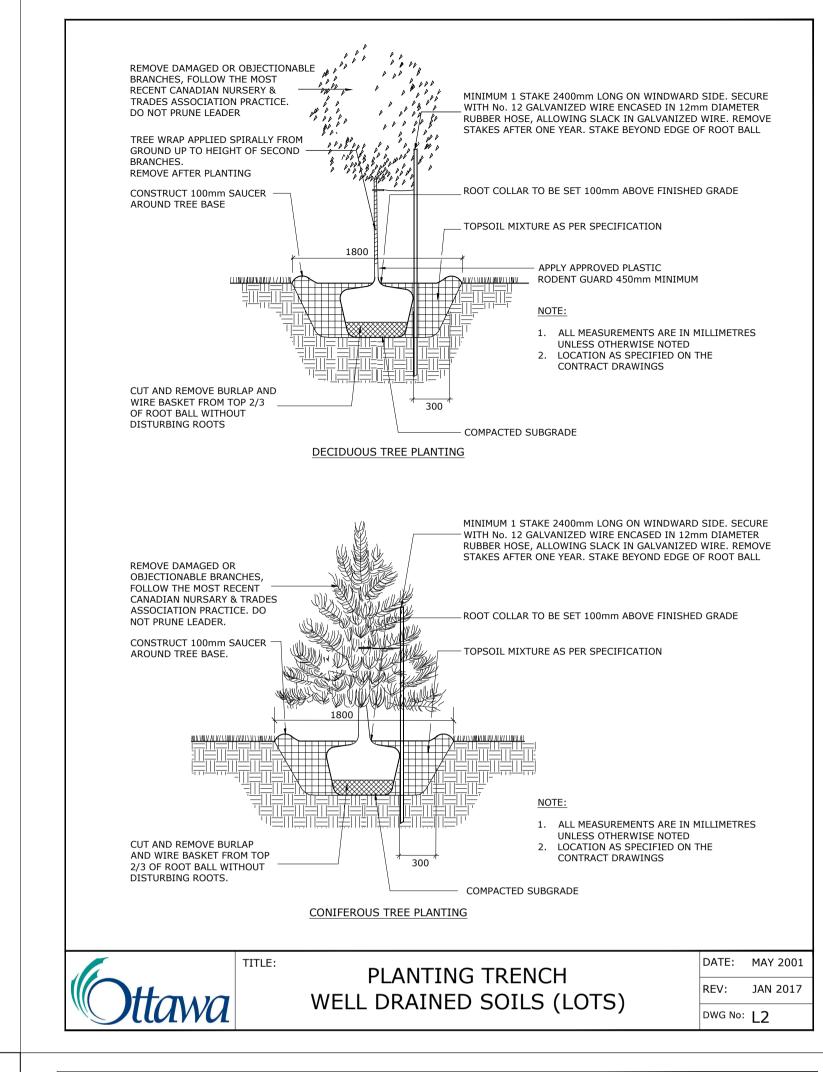

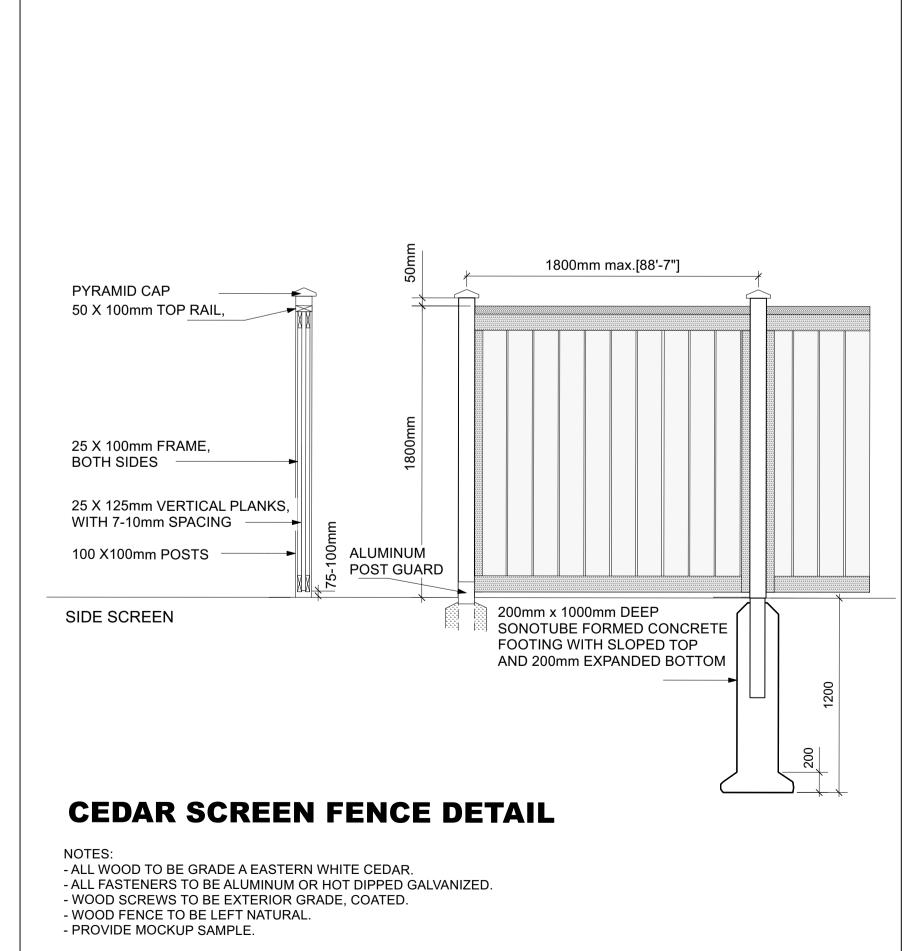

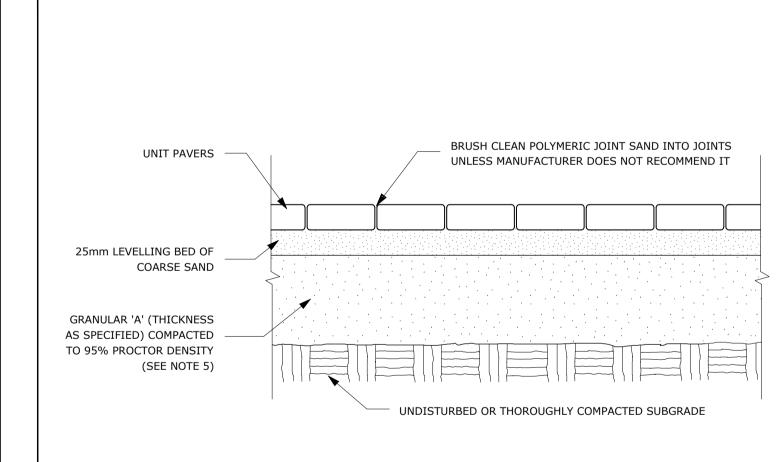

- 1. THE LEVELING COURSE (BEDDING SAND) SHALL BE PLACED LOOSE, IN A UNIFORM LAYER AT A MAXIMUM DEPTH OF 25mm TO ACHIEVE THE FINAL COMPACTED THICKNESS AND GRADE AS SPECIFIED
- 2. INSTALL SOLID EDGE RESTRAINT BETWEEN UNIT PAVERS AND ANY SOFT SURFACE (SOD, PLANTING BED, ETC.)
- 3. UNIT PAVERS ARE THEN PLACED ON TOP OF THE LEVELING COURSE AND ADDITIONAL SAND SWEPT BETWEEN THE UNIT PAVERS
- 4. THE UNIT PAVERS ARE THEN VIBRATED INTO PLACE WITH A VIBRA-PLATE AND WATER IS ADDED TO ASSIST IN THE SETTLING OF THE JOINT SAND
- 5. GRANULAR 'A' DEPTH TO BE 100mm FOR PEDESTRIAN AREAS AND 150mm FOR VEHICULAR ACCESSES. OR AS
- RECOMMENDED BY GEOTECHNICAL INVESTIGATION
- 6. USE OF THIS DETAIL REQUIRES THE PRIOR APPROVAL OF THE GENERAL MANAGER

Ottawa

UNIT PAVING - ON GRANULAR BASE

DATE: MAY 2001

REV: FEB 2016

DWG No: SC9

ADDITIONAL NOTES FOR NUMBER 5: 100mm DEPTH GRANULAR 'A' TO BE USED (AFTER APPROVAL) ONLY IN PEDESTRIAN WHERE NO SNOW REMOVAL IS PLANNED. ALL OTHER PEDESTRIAN AREAS ARE TO RECEIVE 150mm COMPACTED GRANULAR 'A' MINIMUM, VEHICULAR 200mm MINIMUM. FURTHER ADJUSTMENTS TO BE SPECIFIED IN RELATION TO SITE CONDITIONS AND GEOTECHNICAL RECOMMENDATIONS.

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2024-07-25

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Comité de dérogation

6			
5			
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1	ISSUED FOR REVIEW issue / revision		FEB 07/22
no.			date
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project

north

3776 ALBION RD, OTTAWA ON

drawing title

DETAILS


scale	drawn by	designed by
	C. Reed	C. Reed
date	checked by	plot date
December 2021	M. Ruhland	Feb, 7th 2022

oject drawing number

L - 02

Contractor to check and verify all dimensions on the job

36"x24"- 914mmx610mm

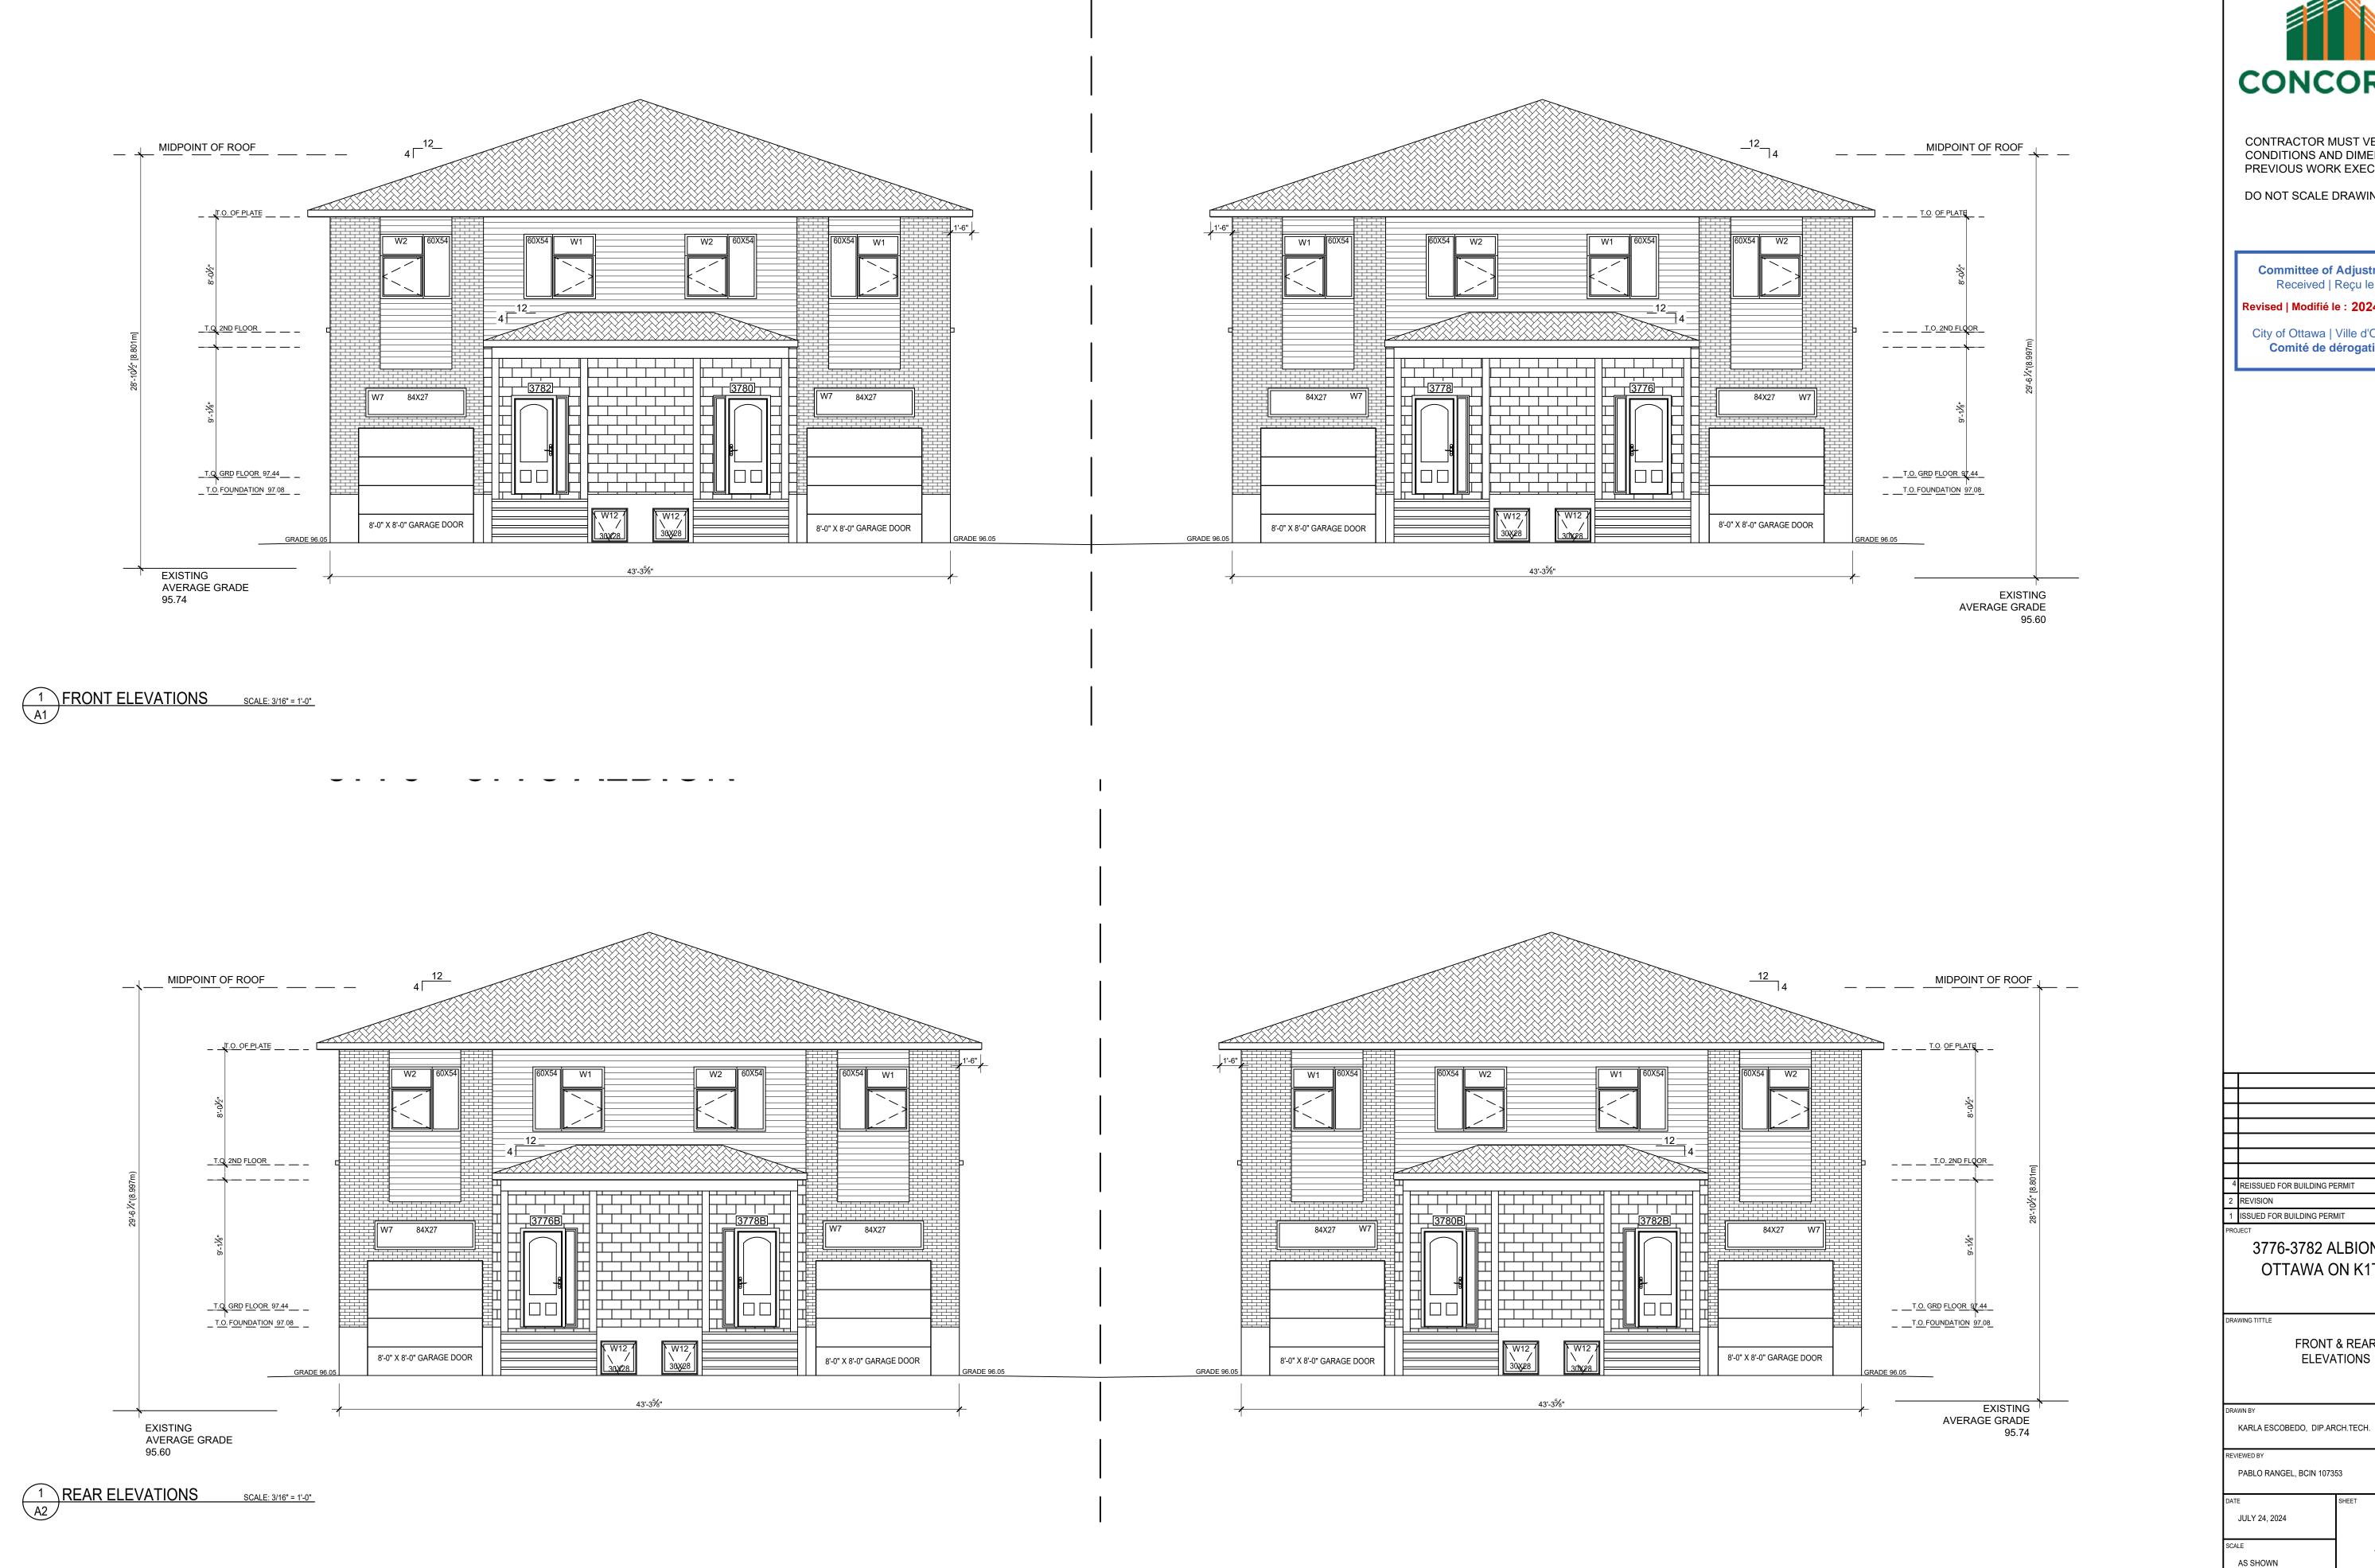



CONTRACTOR MUST VERIFY SITE CONDITIONS AND DIMENSIONS PREVIOUS WORK EXECUTION.

DO NOT SCALE DRAWINGS.

Committee of Adjustment Received | Reçu le

Revised | Modifié le : 2024-08-02

City of Ottawa | Ville d'Ottawa Comité de dérogation

4	REISSUED FOR BUILDING PERMIT	JULY/02/2024
2	REVISION	FEB/11/2024
١	ISSUED FOR BUILDING PERMIT	MAY/26/2023
30	JECT	


3776-3782 ALBION RD S OTTAWA ON K1T 1A5

FRONT & REAR **ELEVATIONS**

A1



NORTH ELEVATION SCALE: 3/16" = 1'-0"

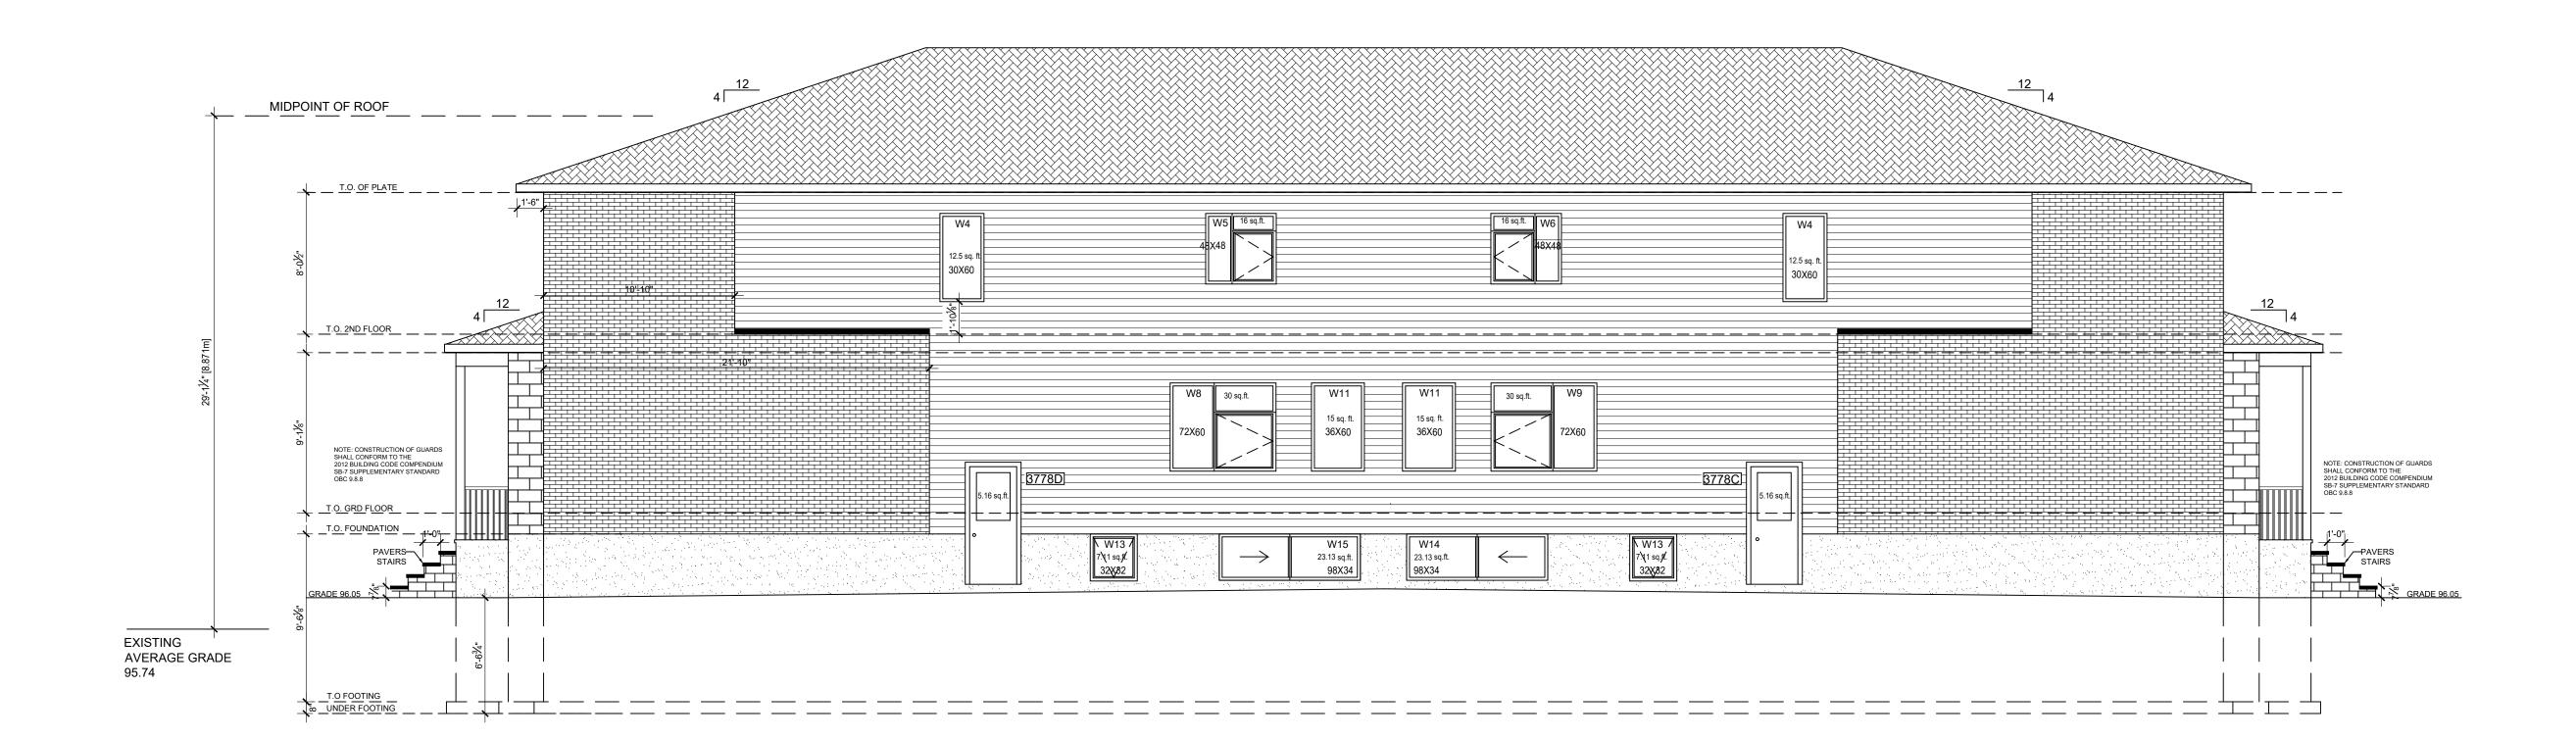

2 SOUTH ELEVATION SCALE: 3/16" = 1'-0"



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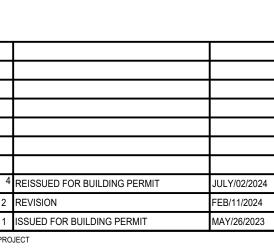
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3776-3782 ALBION RD S OTTAWA ON K1T 1A5

DRAWING TIT

SIDE ELEVATIONS

RAWN BY

KARLA ESCOBEDO, DIP.ARCH.TECH.

EVIEWED BY


PABLO RANGEL, BCIN 107353

JULY 24, 2024

AS SHOWN

A2

3776 and 3780 Albion Road: Proposed Areas Requiring Minor Variance Relief

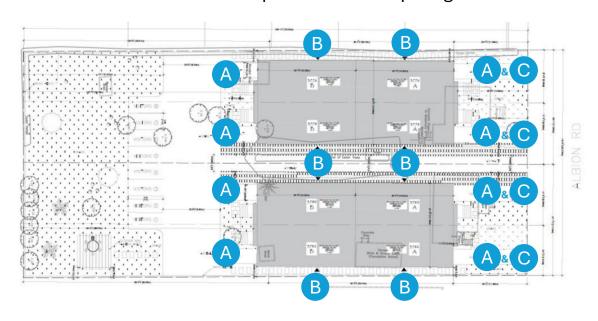

Committee of Adjustment Received | Reçu le

Revised | Modifié le : 2024-08-08

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