

City of Ottawa | Ville d'Ottawa

Comité de dérogation

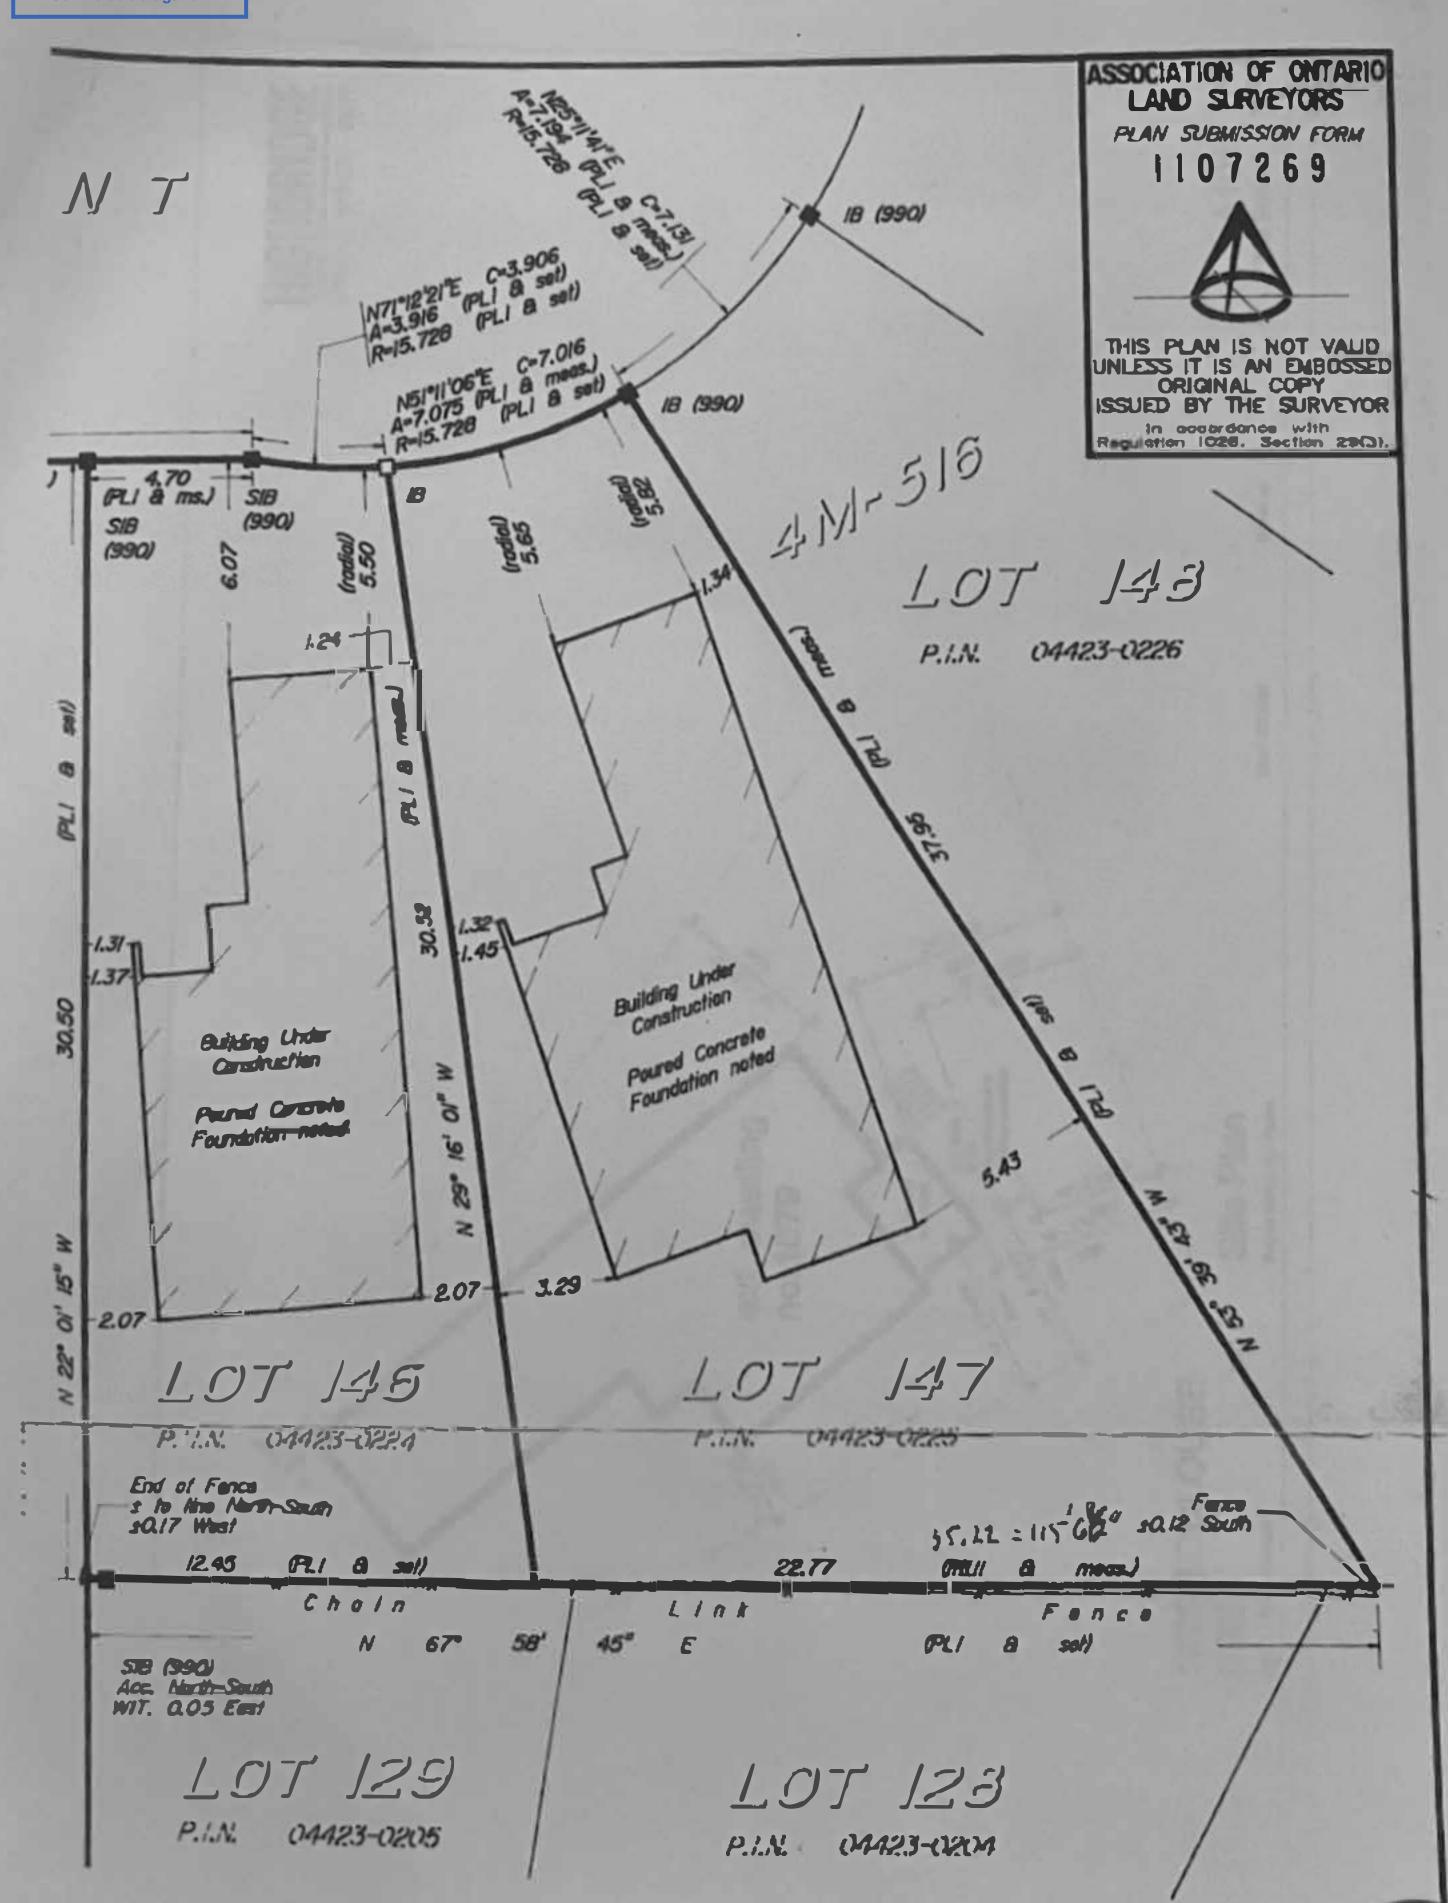

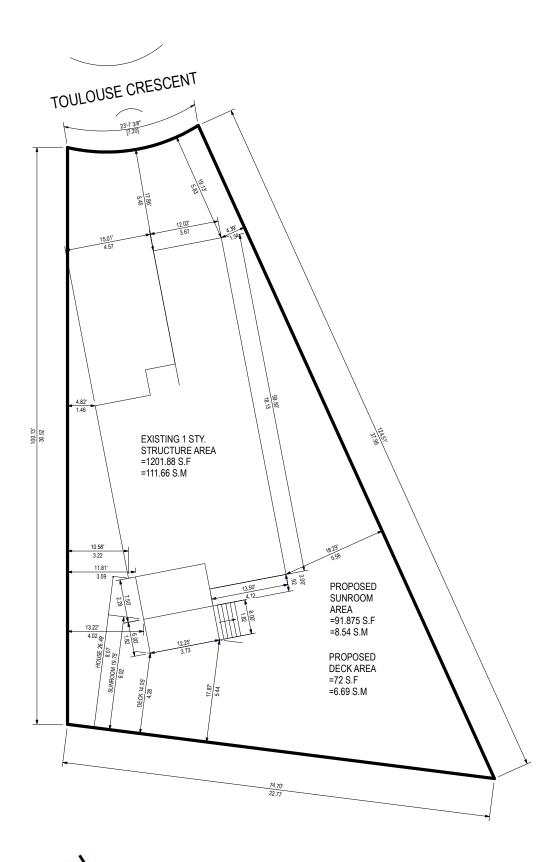

N

SITE PLAN
SCALE = 1:200

TEC.

1. THE WALLS AND ROOF STRUCTURAL PANELS OF THE SUNROOM WILL BE PREFABRICATED BY

LIFESTYLE SUNROOMS INC. AND WILL BE INSTALLED BY ITS TRAINED SKILLED INSTALLERS.

2. A PROFESSIONAL ENGINEER UNDERTAKES THE GENERAL REVIEW OF THE INSTALLATION.

3. A FINAL PROJECT REVIEW LETTER WILL BE SUBMITTED TO THE BUILDING DEPARTMENT AFTER THE

COMPLETION.

4. (1). STAIRS RISER DIMENSIONS SHALL CONFIRM TO ARTICLES $9.8.4.2\,\mathrm{AND}\,9.8.4.3\,\mathrm{OF}$ THE 2012

OBC WHICH STIPULATES THAT RISERS DESIGNED FOR PRIVATE USE MUST HAVE A MAXIMUM RISE OF

NO MORE THAN 200 mm OR A MINIMUM RISE OF NO LESS THAN 125 mm AND A MAXIMUM RIIN

OF NO MORE THAN 355 mm OR A MINIMUM RUN OF NO MORE THAN 255 mm AND A MAXIMUM TREAD DEPTH OF 355 mm OR A MINIMUM TREAD DEPTH OF NO LESS THAN 235 mm.

4. (2). REQUIRED EXIT STAIRS SHALL HAVE A WIDTH. MEASURED BETWEEN WALL FACES OR GUARDS.

OF NOT LESS THAN 900 mm AS PER ARTICLE 9.8.2.1 OF THE 2012 OBC.

5. THE WIDTH OF THE LANDING IF REQUIRED SHALL BE NOT LESS THAN THE GREATER REQUIRED

STAIR WIDTH WHERE ONE OR MORE OF THE STAIR WIDTHS DO NOT EXCEED THEIR RESPECTIVE

REQUIRED WIDTHS. OR NOT LESS THAN THE LESSER ACTUAL.. STAIR WIDTH WHERE ALL OF THE WIDTHS

OF THE STAIRS EXCEED THEIR RESPECTIVE REQUIRED WIDTHS AS PER ARTICLES $9.8.6.2\,$ AND $9.8.6.3\,$

OF THE 2012 OBC.

6. ALL HAND BAILS AND GUARDS SHALL BE BUILT AS PER OBC 2012 AND SUPPLEMENTARY STANDARD SB-7. EXTERIOR HANDRAIL AND GUARDS TO BE AT LEAST 900 mm OR 35. MEASURED

VERTICALLY ABOVE THE NOSING OF ANY TREAD AND/OR PLATFORM NOT MORE THAN 1800 mm OR

5°-11• ABOVE THE FINISHED GROUND AS PER SUBSECTIONS 9.8.7 AND 9.8.8 OF 2012 OBC;

PICKET AND/OR GUARD SPACING MUST BE NO MORE THAN 100 mm OR 4• APART AS PER

9.8.8.5 OF THE 2012 OBC; ALL BALUSTERS TO BE SPACED NO MORE THAN 1200 mm OR 45°

APART.
7.TO CARRY RAINWATER AWAY FROM THE SUNROOM. DOWNSPOUTS WILL BE INSTALLED AT

OUTSIDE CORNERS OF ROOM IN ACCORDANCE TO ARTICLES 9.26.18.2, 7.3.3.7, AND 5.6.2.2 OF THE 2012 OBC.

8. ALL ADDITIONAL ASPECTS OF THE PROJECT WILL BE INSTALLED..LED ACCORDING TO TACBOC DETAILS AND

COMPLY WITH THE REQUIREMENTS STIPULATED BY THE 2012 OBC. INCLUDING DOORS (TO SECTION 9.6.); WINDOWS (TO SECTION 9.7.); SKYLIGHTS(TO SUBSECTION 9.7.7.); GLASSES(TO

SUBSECTION 9.7.3.); WOOD FRAME CONNECTIONS. DECK FARMING ,STICK BUILT WAL.1.S AND

SUBFLOORING (TO SUBSECTION 9.23.14):BUILT-UP BEAMS (TO ARTICLE 9.23.8.3); BUILT-UP COLUMNS (TO ARTICLE 9.17.4.2); ROOFING (TO SECTION 9.26.); ROOF DRAINS AND DOWNSPOUTS

(TO SUBSECTION 9.26.18.); FLASHING (TO SUBSECTIONS 9.20.13 &9.26.3 &9.26.4); CLADDING(TO

SECTION 9.27.); CAULKING (TO SUBSECTION 9.27.4.); INTERIOR FINISHING (TO SUBSECTION 9.29.)

FLOORING (TO SECTION 9.30.); STAIRS. RAMPS. HANDRAILS AND GUARDS (TO SECTION 9.8.); LIGHTING

OUTLETS (TO SECTION 9.34.)

SITE PLAN DATA

 LOT AREA
 5068.53ft² (470.88m²)

 GFA
 EXISTING
 1201.88ft² (111.66m²)

 PROPOSED SUNROOM
 91.875ft² (8.54m²)

TOTAL...... 1,365.75ft² (126.88m²)

GFA/LOT AREA RATIO 26.9%



944 CRAWFORD DR.
PETERBOROUGH, ONTARIO, K9J 3X2
WWW.LIFESTYLESUNROOMS.COM

TEL: 800-465-0593 FAX: 800-934-0822

PROJECT

LIFESTYLE UNHEATED SUNROOM ADDITION

PROJECT ADDRESS

1679 TOULOUSE CRESCENT, ORLÉANS, ON K1C 6K3

DRAWING TITLE

SITE PLAN

PAGE NUMBER

1

92088

DRAWING


REVISION | PROJECT

BCIN: 28441

MODEL TYPE			
225 STUDIO (6.5" ALUM. TOP)			
CLIENT			
MARCO & LOUISE TURINGIA			
DATE	SCALE		
2024-07-26	SCALE = 1:200		
DRAWN BY:	CHECKED BY:		
A.A. & S.S.			


I CERTIFY THAT I, SHAWN SAWATZKY, HAVE REVIEWED AND TAKE RESPONSIBILITY FOR THIS DESIGN AND I HAVE MET THE REQUIREMENTS AND QUALIFICATIONS AS SET OUT IN THE ONTARIO BUILDING CODE.

LIFESTYLE ENGINEERING

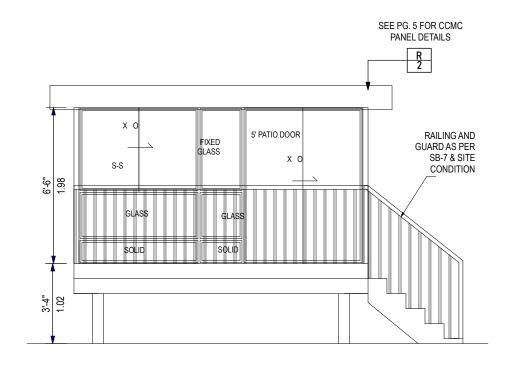


EAST ELEVATION

SCALE = 1/4" = 1'

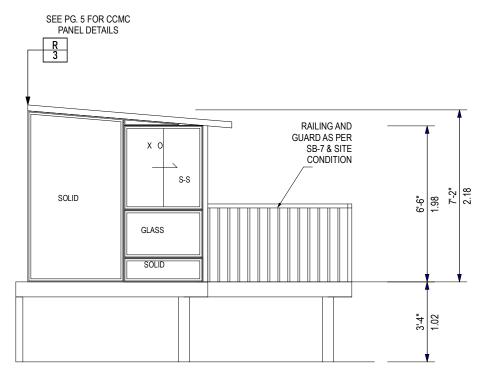

NORTH ELEVATION

SCALE = 1/4" = 1'

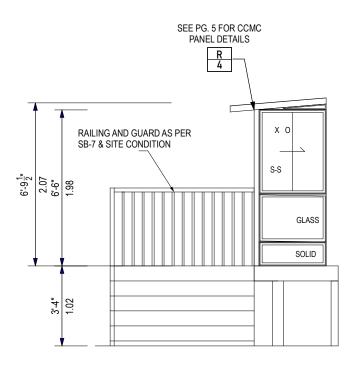

SOUTH ELEVATION

SCALE = 1/4" = 1'



944 CRAWFORD DR. PETERBOROUGH, ONTARIO, K9J 3X2 WWW.LIFESTYLESUNROOMS.COM

> TEL: 800-465-0593 FAX: 800-934-0822

PROJECT

LIFESTYLE UNHEATED SUNROOM ADDITION

PROJECT ADDRESS

1679 TOULOUSE CRESCENT, ORLÉANS, ON K1C 6K3

DRAWING TITLE

ELEVATIONS

PAGE NUMBER

REVISION | PROJECT | DRAWING

	920	88	1	
MODEL TYPE				
225 STUDIO (6.5" ALUM. TOP)				
CLIENT				
MARCO & LOUISE TURINGIA				
DATE		SCALE		
2024-07-		SCALE: 1/4" = 1'		
DRAWN	BY:	CHECKED BY:		
A.A. & S	.S.			

I CERTIFY THAT I, SHAWN SAWATZKY, HAVE REVIEWED AND TAKE RESPONSIBILITY FOR THIS DESIGN AND I HAVE MET THE REQUIREMENTS AND QUALIFICATIONS AS SET OUT IN THE ONTARIO BUILDING CODE.

BCIN: 28441

LIFESTYLE ENGINEERING