



24/24/24/-24-246 Posessialt BM FIN A1/24/240-24 Kind W 194-36 D1114 O.E.

FL

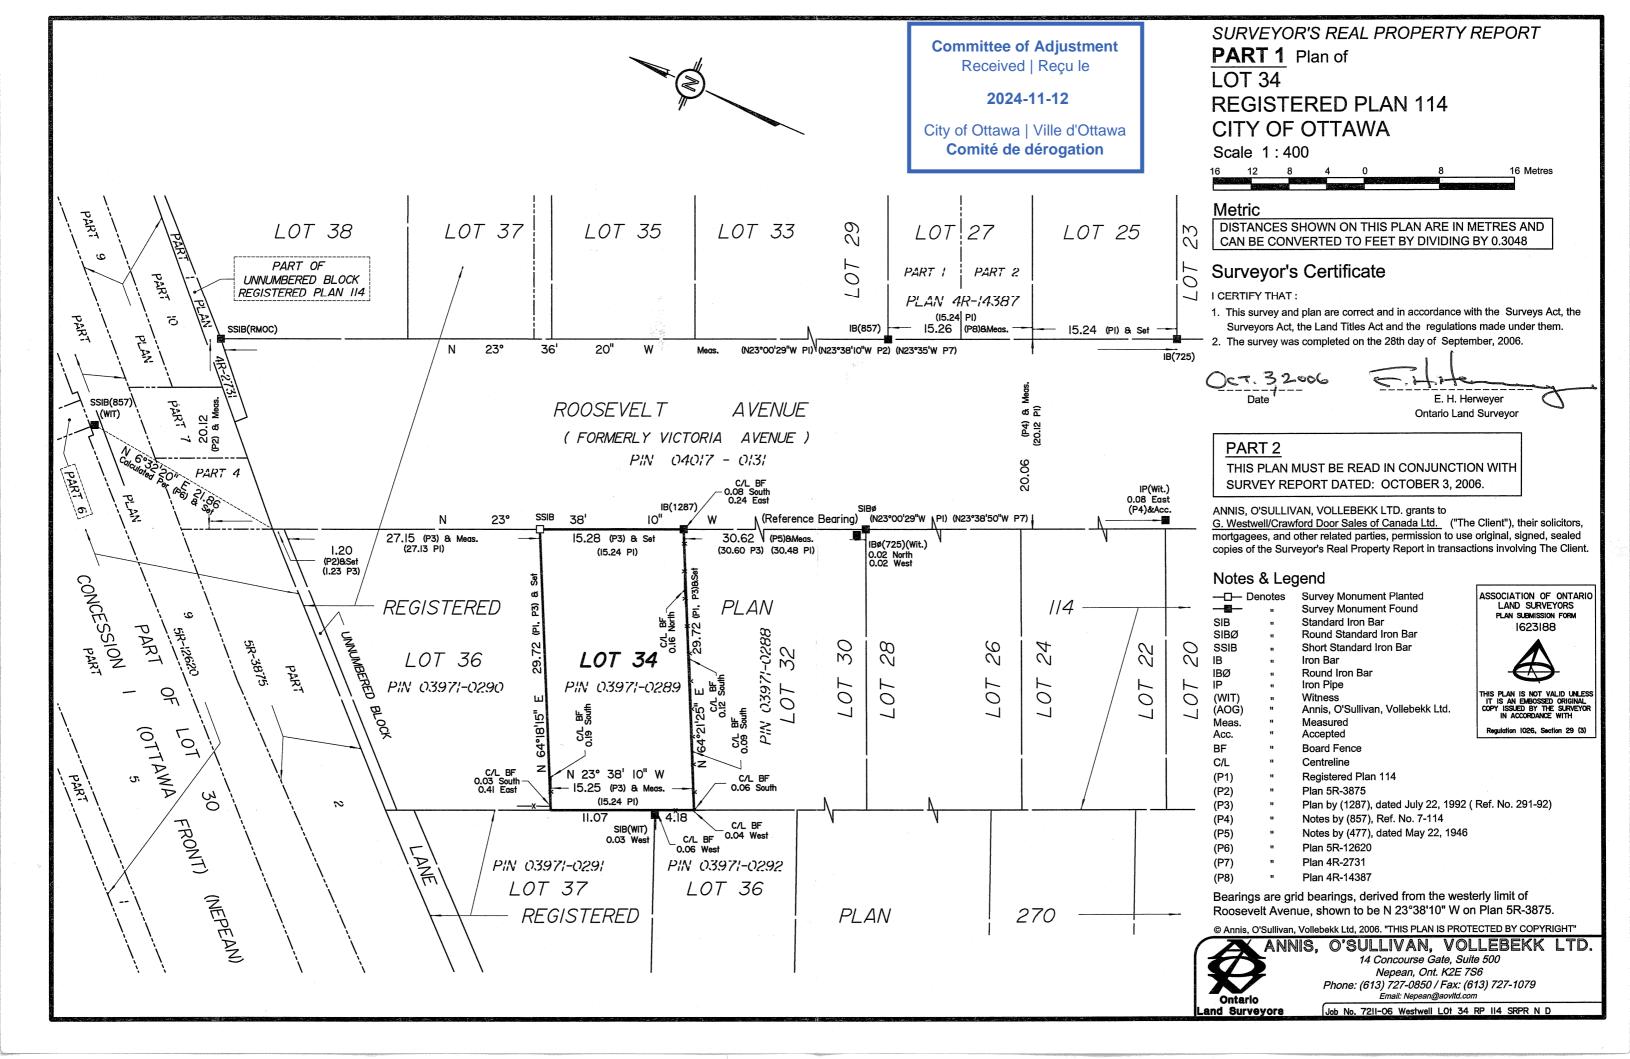

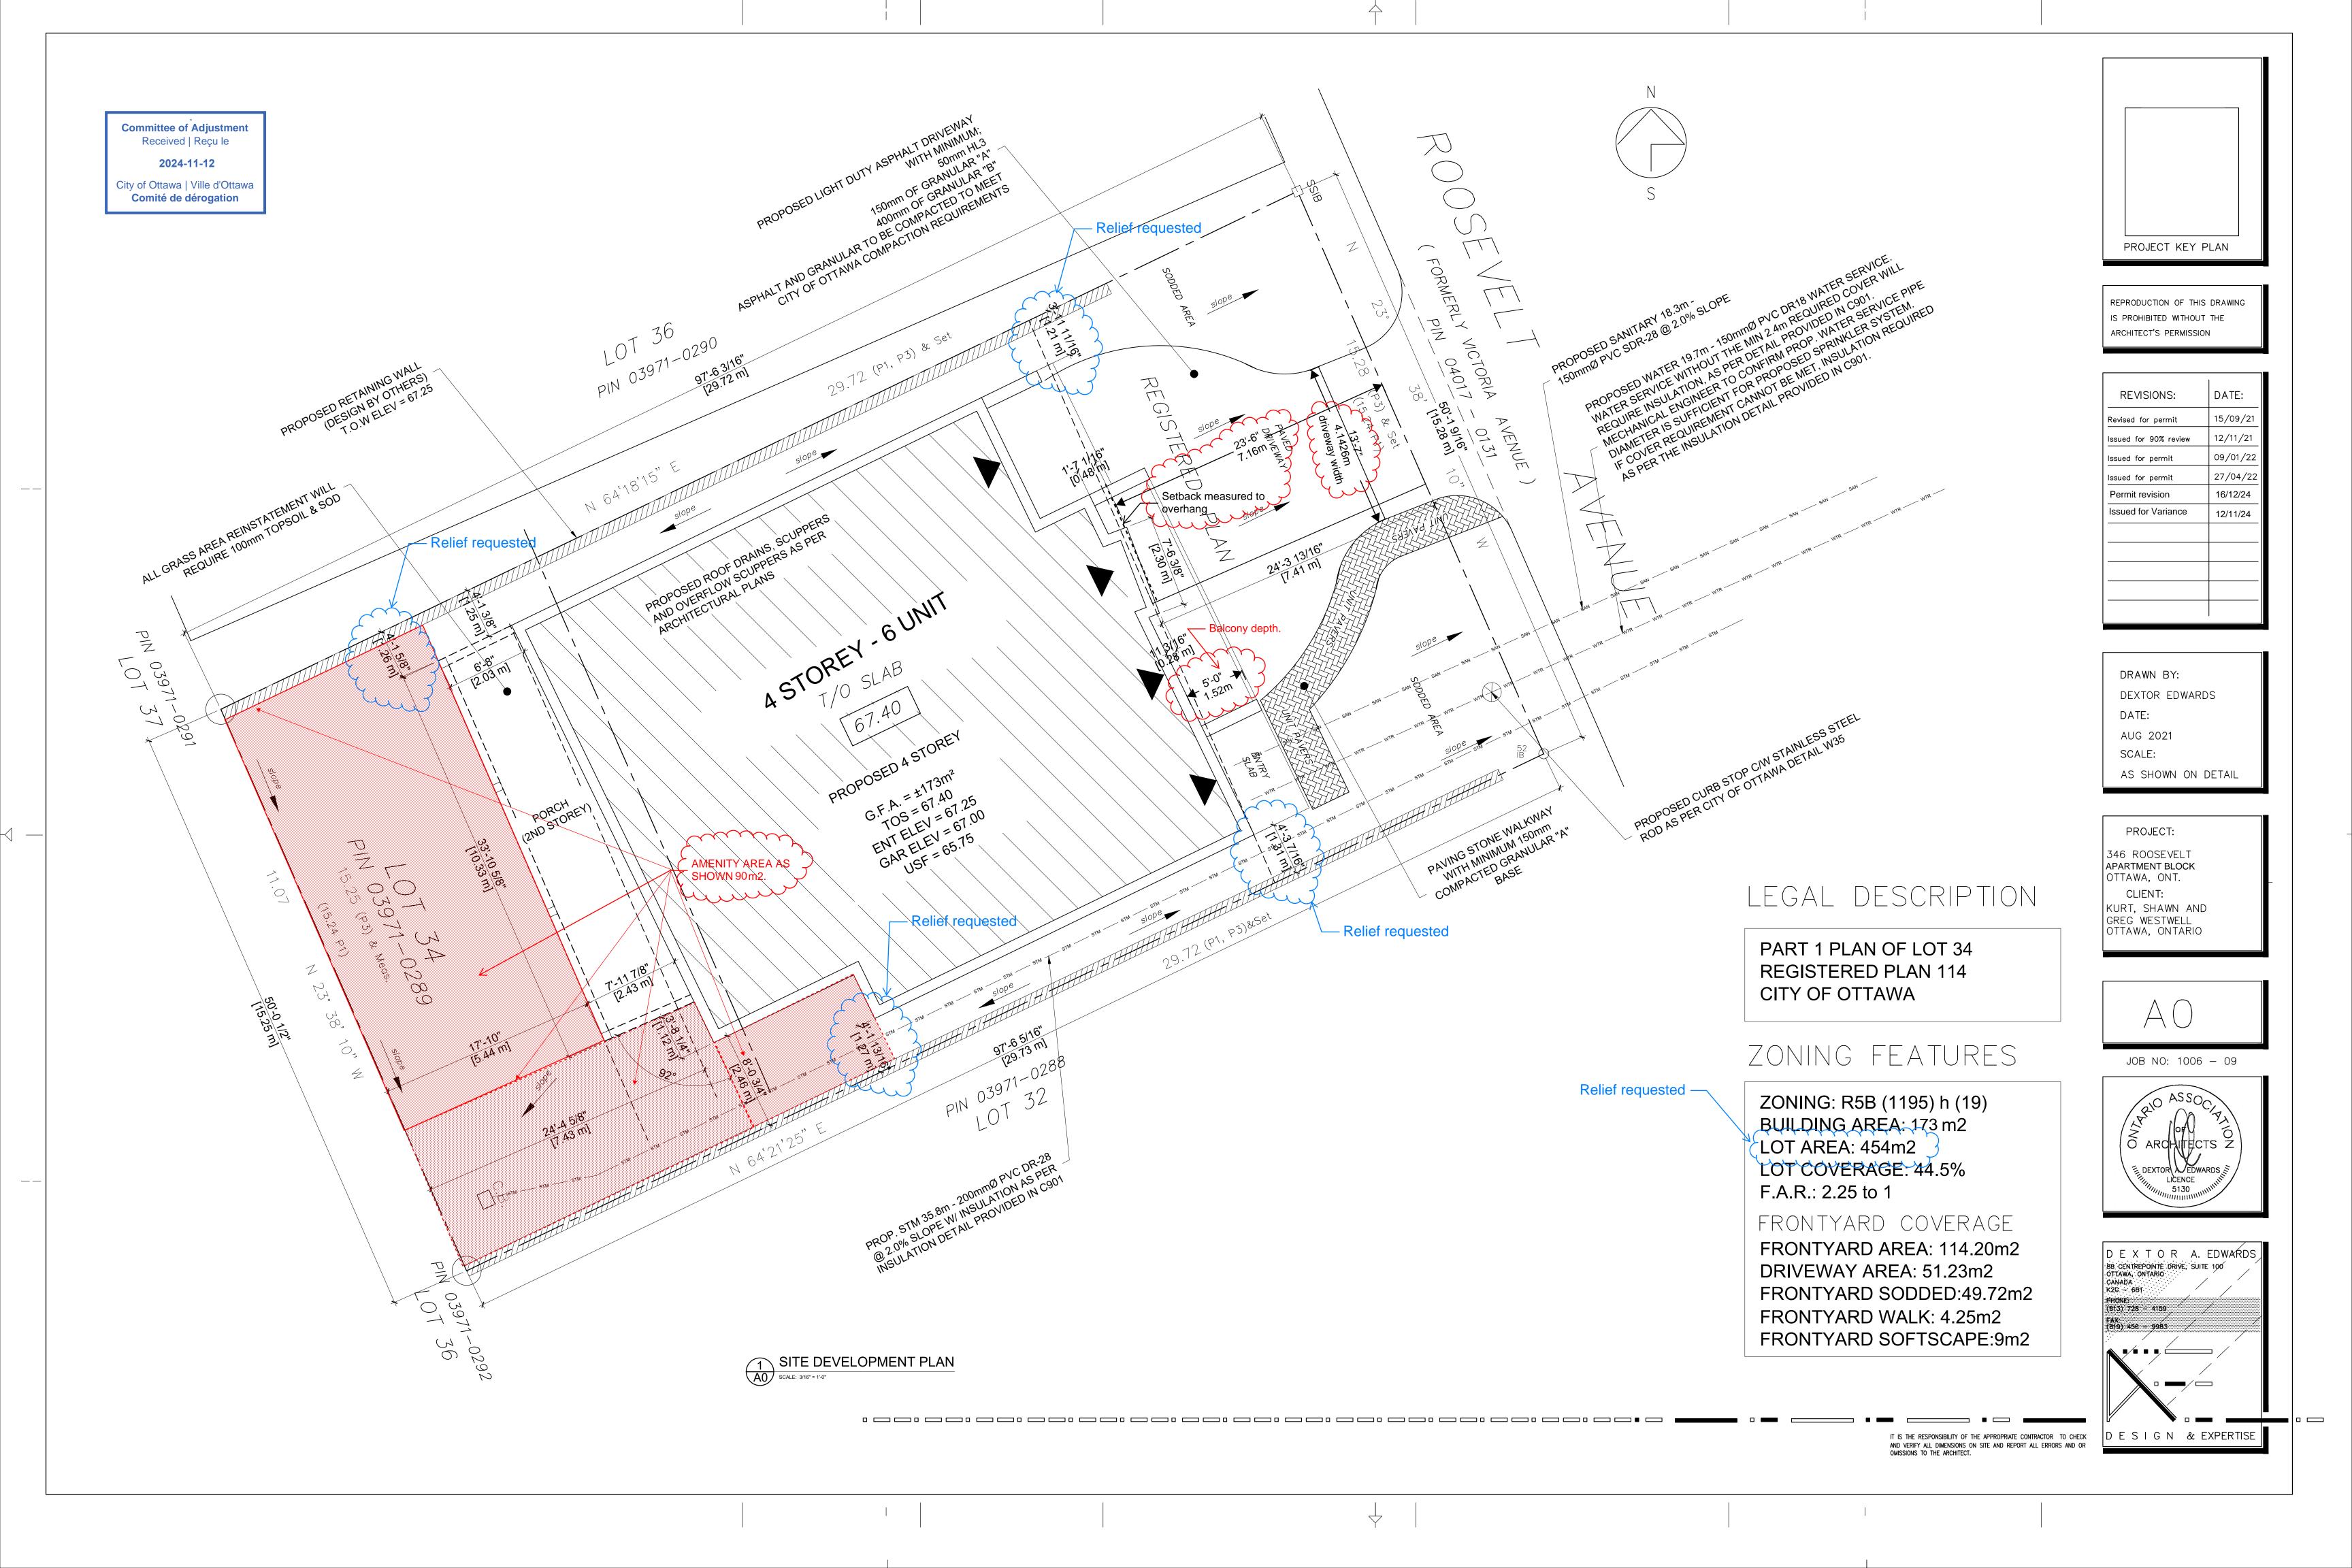

## **SOUTH - ELEVATION AT SIDEYARD**

PERCENTAGE OF EXPOSED BUILDING FACE AT SOUTH ELEVATION FOR SPATIAL SEPARATION AS PER O.B.C. SECTION 3.2.3.1

PROPOSED AREA OF BUILDING FACE AT 1.2m LIMIT = 167 m2 (1,797.63 SQ.FT.) PROPOSED GLAZING PERCENTAGE AT THIS FACE = 5.0% (8.4 m2.)

ALLOWABLE GLASS AREA AT BLDG FACE BASED ON 1.2m (11.7m2)

AT ACTUAL LIMITING DISTANCE = MAX 14%

THEREFORE THE EXTERIOR WALLS AT THIS BUILDING FACE IS ALLOWED TO BE GLAZED UP TO 14% IN ACCORDANCE WITH O.B.C. 3.2.3.1.D 14% IS WELL WITHIN THE O.B.C. LIMITATION BUT THE WALL ASSEMBLY ADJACENT TO THE PROTECTED OPENINGS SHALL BE RATED 1HR. AS PER O.B.C. 3.2.3.7.(3) AS COMBUSTIBLE CONSTRUCTION WITH NON-COMBUSTIBLE CLADDING

TOTAL SURFACE AREA = 167 m2. UNPROTECTED OPENINGS= 8.4 m2

RATIO L/H

5.0 %

LEGEND


- 1 PROVIDE 4" CAP FLASHING AS SHOWN.
- 2 PROVIDE TRANSITION METAL FLASHING AT JOINT WITH DRIP EDGE AS SHOWN.
- 3 PROVIDE METAL CORBEL PROFILE AS SHOWN. (SEE SHEET A12)
- 4 PROVIDE DRIP FLASHING & J-MOULD AT WINDOW PERIMETER TO RECEIVE SIDING. (TYP.)
- 5 PRE-FIN METAL WRAP AROUND SPANDREL TO MATCH WINDOW FRAME COLOUR & FINISH.
- 6 SHEARWALLS INDICATED SHALL HAVE ONE FACE CONTINUOUS 5/8" T&G PLYWOOD NAILED AT ALL EDGES WITH 3" COMMON NAILS 4" o.c.

THE PLYWOOD PANELS ARE TO BE NAILED AT EACH INTERMEDIATE STUD WITH 3" COMMON NAILS 12" o.c.

STAGGER ALL PANEL JOINTS TO FALL ON DIFFERENT MEMBERS FROM ONE SIDE TO THE OTHER.

- 7 1 1/4" X 1/4" CORRUGATED METAL PANEL 26 Ga C/W GALVANIZED FINISH (TYP.).
- 8 PRE-PAINTED GALV. STEEL SIDING BY IDEAL ROOFING INDUSTRIAL METRO 26 Ga (TYP.).
- 9 PRE-FORMED METAL PANELS C/W GALVALUME FINISH (TYP.).
- 10 SEE SHEET A22 FOR PORCH STAIR DETAILS
- 11 PROVIDE FLEXIBLE FLASHING BEHIND EXT. CLADDING TO SIT UP 6" MIN. ON EXT. SHEATHING. (TYP.)
- 12 PROVIDE 2" DIA. PERIMETER PIPE RAILING AT 3'-6" ABOVE ROOF DECK C/W SUPPORTS AT 48" o.c. MAX.
- 13 PROVIDE SOLID STAIN FINISH TO MATCH PRE-FIN FLASHING & WRAP AROUND SPANDRELS.



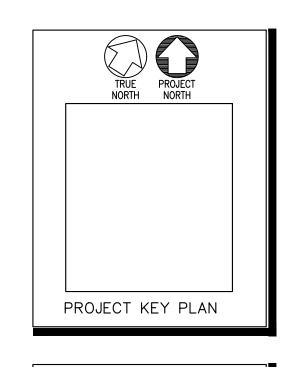

REPRODUCTION OF THIS DRAWING IS PROHIBITED WITHOUT THE ARCHITECT'S PERMISSION

REVISIONS:	DATE:
Revised for permit	15/09/21
issued for permit	09/01/22
issued for permit	15/08/22
Issued for Variance	12/11/24


DRAWN BY: DEXTOR EDWARDS DATE: AUG 2021 SCALE: AS SHOWN ON DETAIL


PROJECT: 346 ROOSEVELT APARTMENT BLOCK OTTAWA, ONT. CLIENT: KURT, SHAWN AND GREG WESTWELL OTTAWA, ONTARIO



JOB NO: 1006 - 09



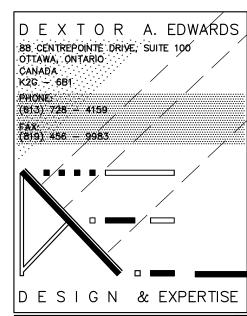

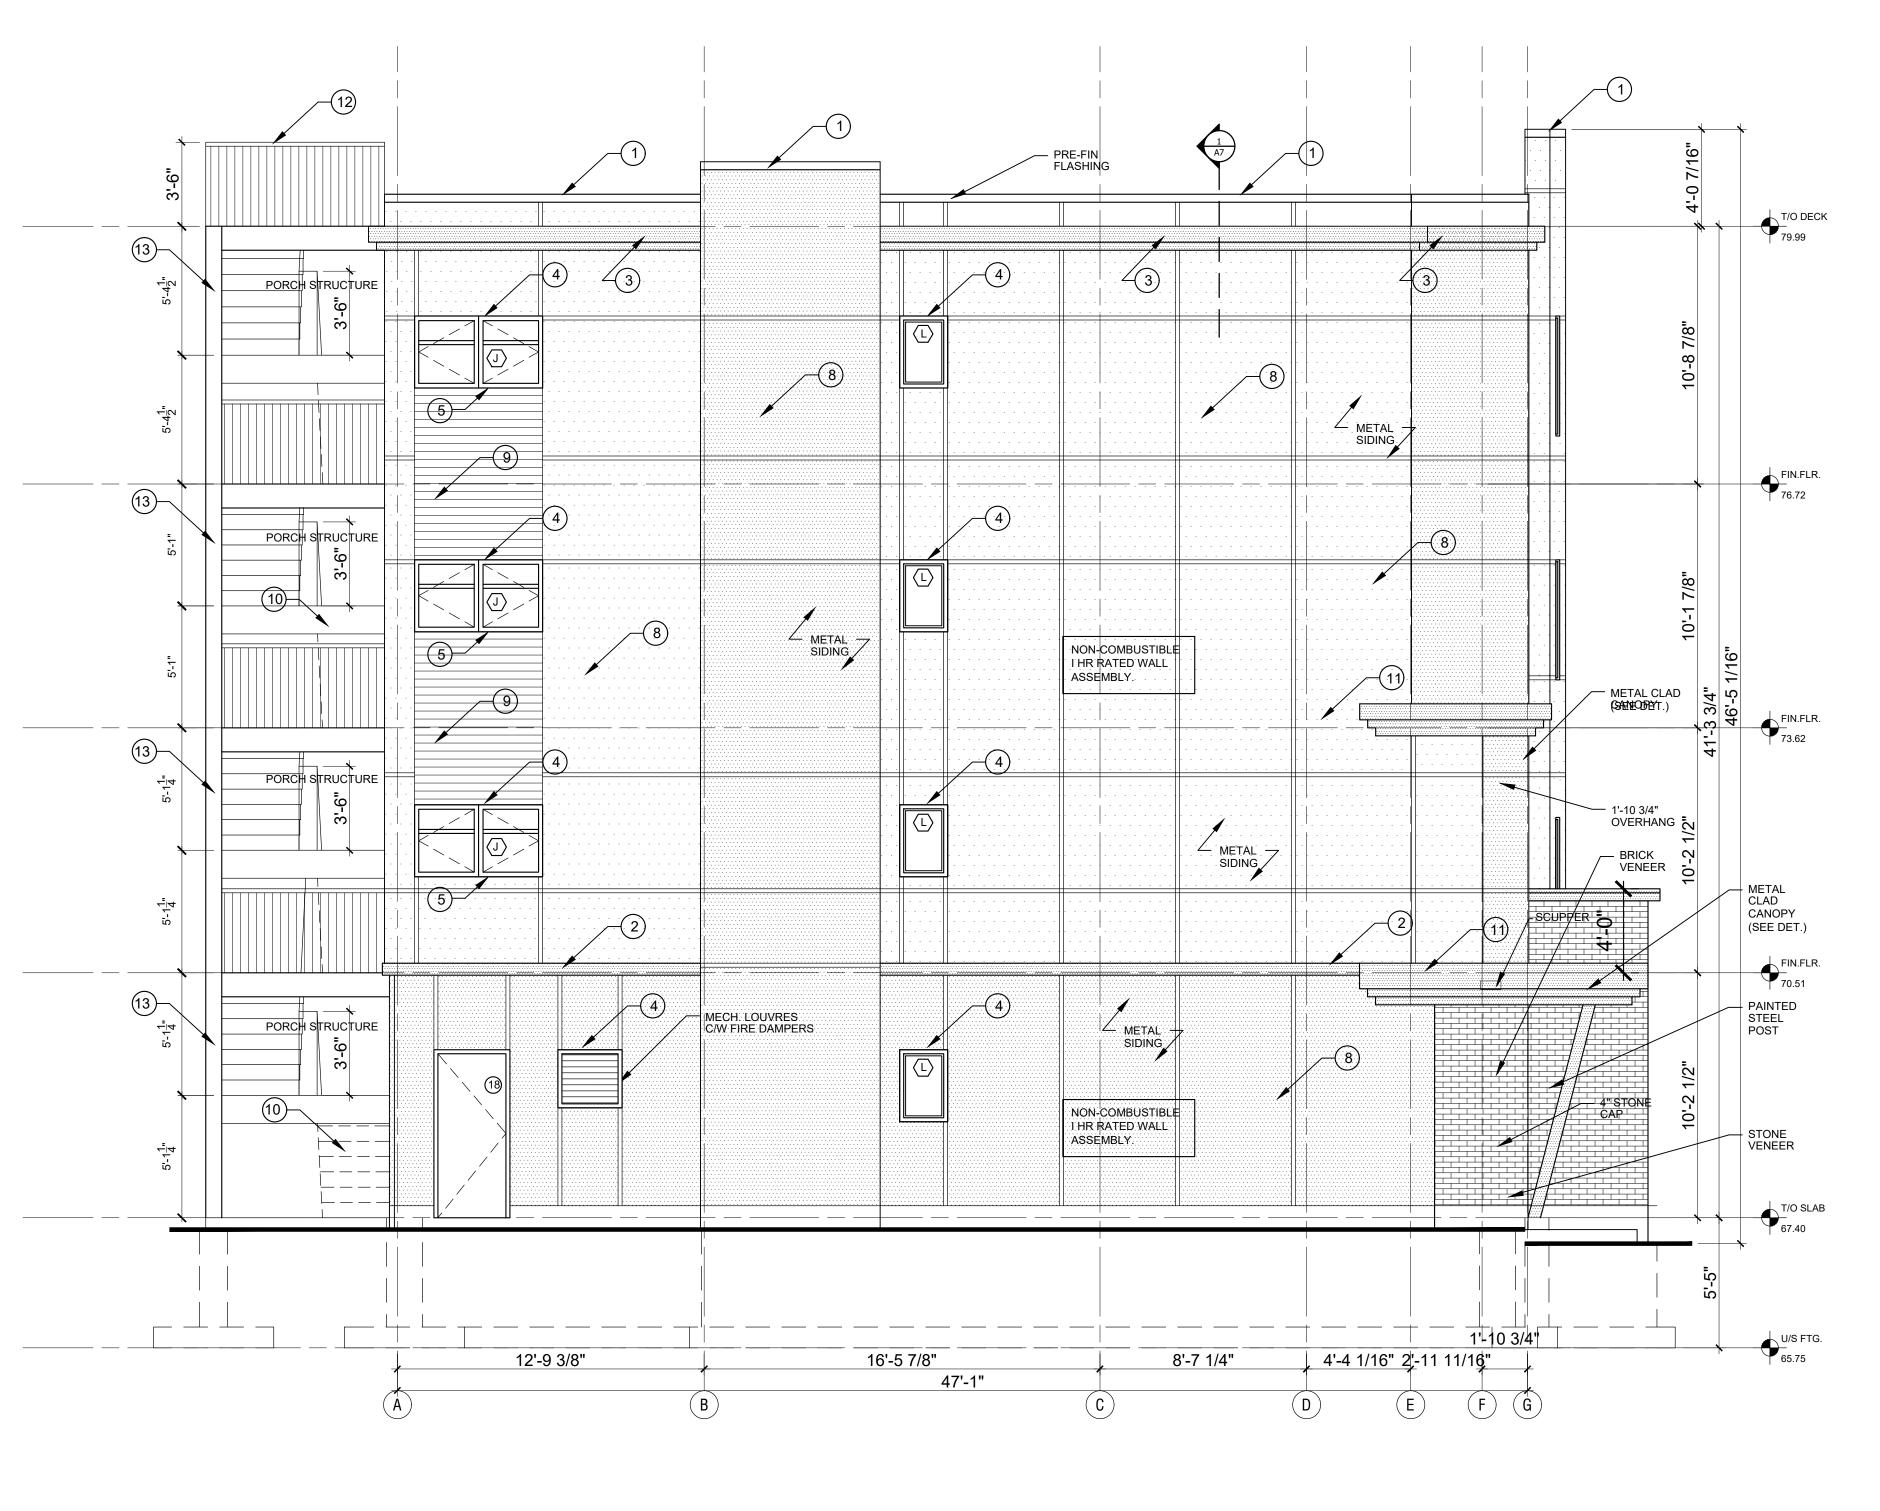

2 SOUTH/LEFT SIDE ELEVATION

IT IS THE RESPONSIBILITY OF THE APPROPRIATE CONTRACTOR TO CHECK AND VERIFY ALL DIMENSIONS ON SITE AND REPORT ALL ERRORS AND OR OMISSIONS TO THE ARCHITECT.


Committee of Adjustment
Received | Reçu le
2024-11-12


City of Ottawa | Ville d'Ottawa


Comité de dérogation

## LEGEND


- 1 PROVIDE 4" CAP FLASHING AS SHOWN.
- 2 PROVIDE TRANSITION METAL FLASHING AT JOINT WITH DRIP EDGE AS SHOWN.
- 3 PROVIDE METAL CORBEL PROFILE AS SHOWN. (SEE SHEET A12)
- 4 PROVIDE DRIP FLASHING & J-MOULD AT WINDOW PERIMETER TO RECEIVE SIDING. (TYP.)
- 5 PRE-FIN METAL WRAP AROUND SPANDREL TO MATCH WINDOW FRAME COLOUR & FINISH.
- 6 SHEARWALLS INDICATED SHALL HAVE ONE FACE CONTINUOUS 5/8" T&G PLYWOOD NAILED AT ALL EDGES WITH 3" COMMON NAILS 4" o.c.
  - THE PLYWOOD PANELS ARE TO BE NAILED AT EACH INTERMEDIATE STUD WITH 3" COMMON NAILS 12" o.c.
- STAGGER ALL PANEL JOINTS TO FALL ON DIFFERENT MEMBERS FROM ONE SIDE TO THE OTHER.
- 7 1 1/4" X 1/4" CORRUGATED METAL PANEL 26 Ga C/W GALVANIZED FINISH (TYP.).
- 8 PRE-PAINTED GALV. STEEL SIDING BY IDEAL ROOFING INDUSTRIAL METRO 26 Ga (TYP.).
- 9 PRE-FORMED METAL PANELS C/W GALVALUME FINISH (TYP.).
- 10 SEE SHEET A22 FOR PORCH STAIR DETAILS
- 11 PROVIDE FLEXIBLE FLASHING BEHIND EXT. CLADDING TO SIT UP 6" MIN. ON EXT. SHEATHING. (TYP.)
- 12 PROVIDE 2" DIA. PERIMETER
  PIPE RAILING AT 3'-6" ABOVE
  ROOF DECK C/W SUPPORTS
  AT 48" o.c. MAX.
- 13 PROVIDE SOLID STAIN
  FINISH TO MATCH
  PRE-FIN FLASHING &
  WRAP AROUND SPANDRELS.

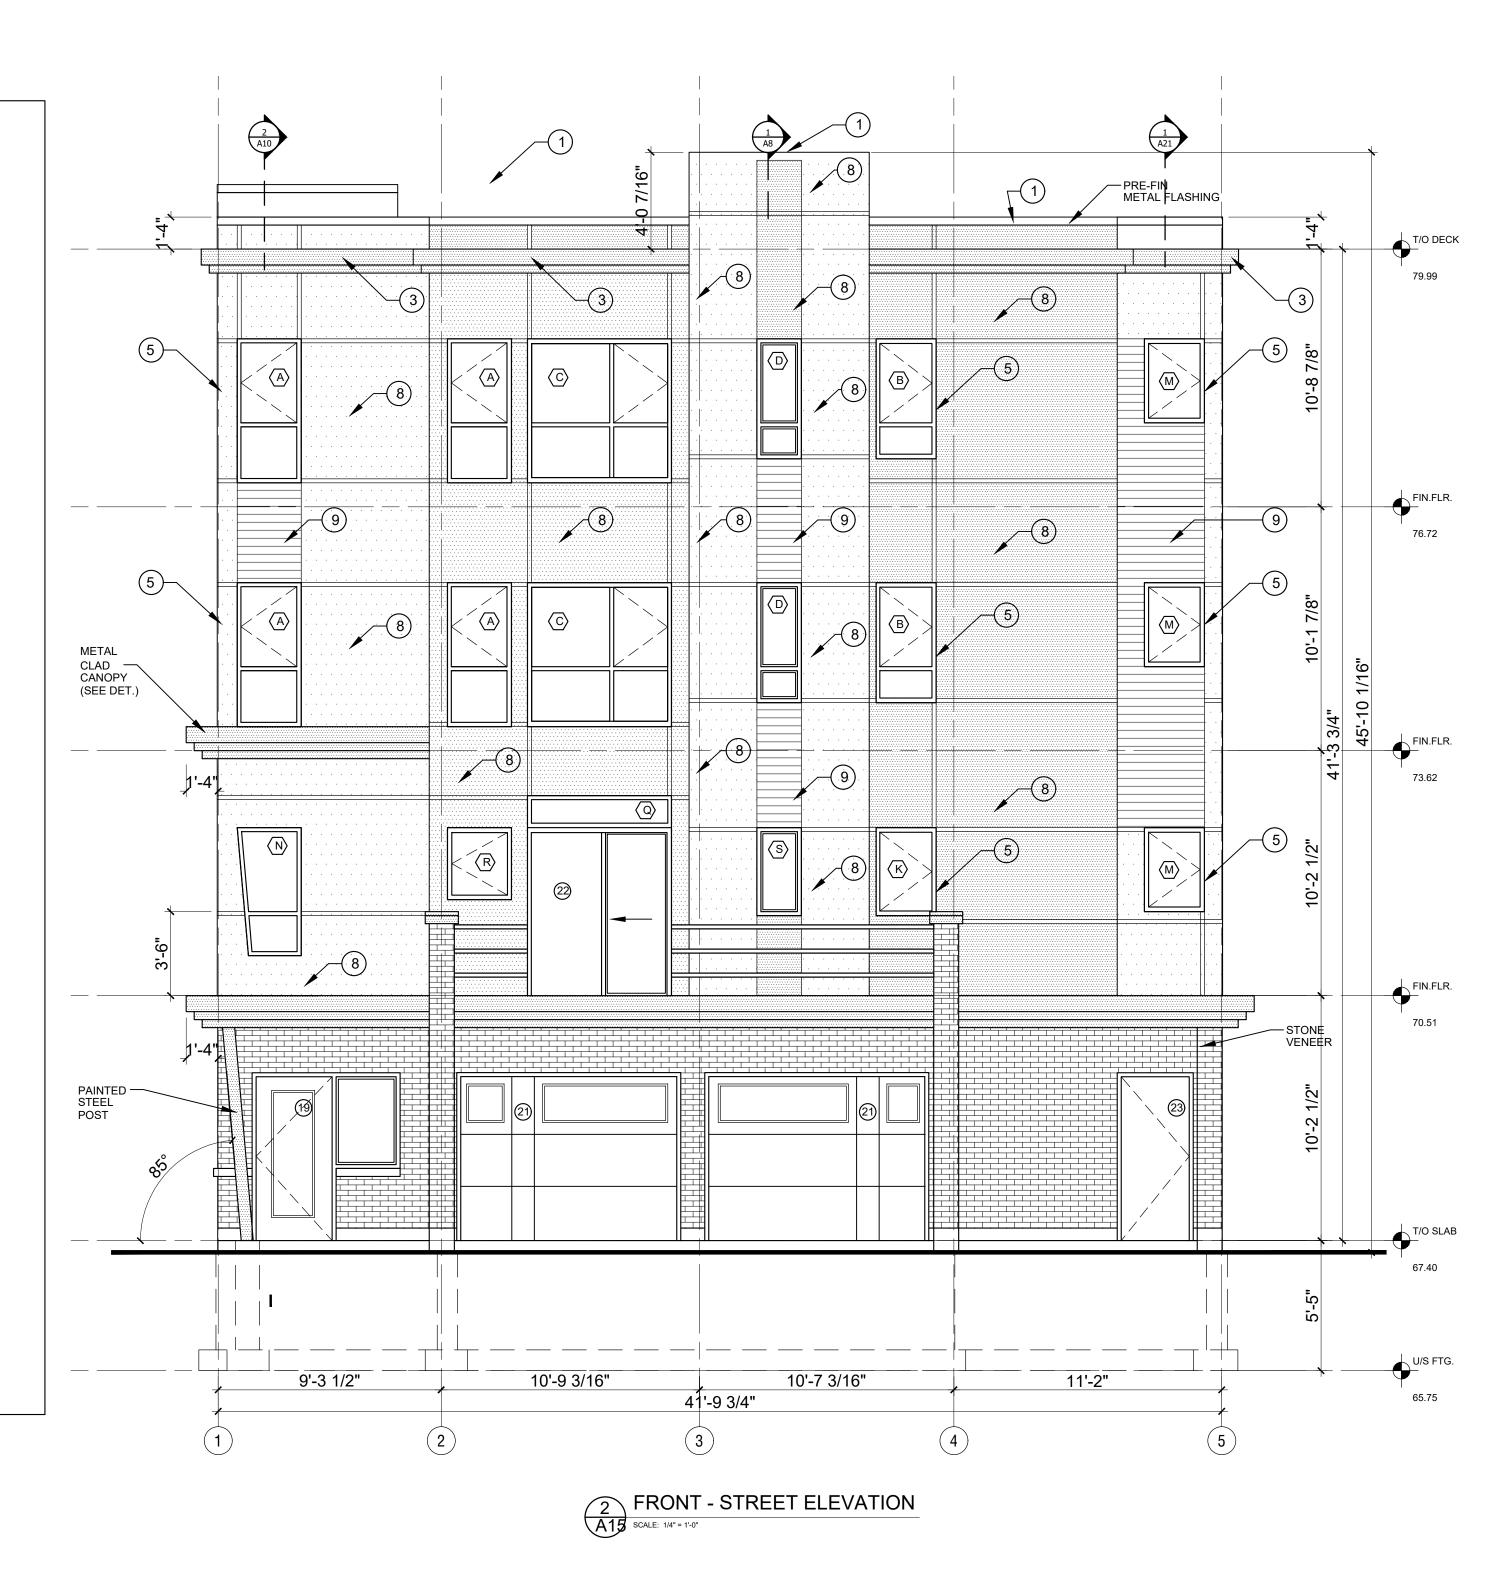

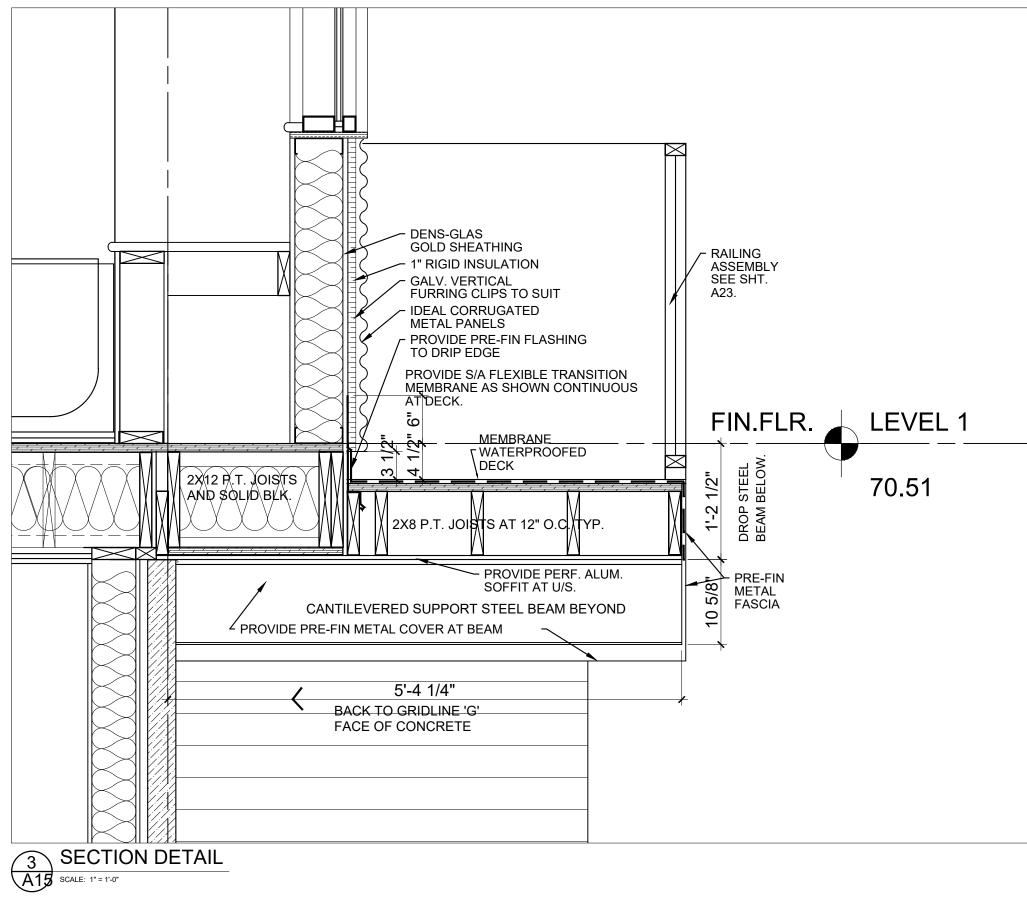

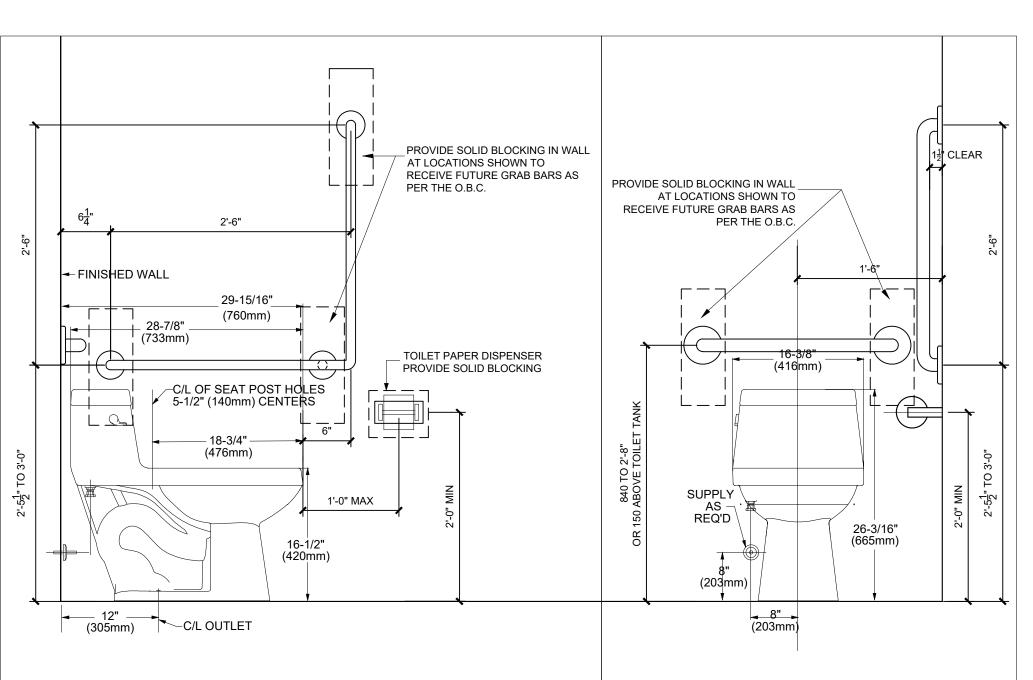



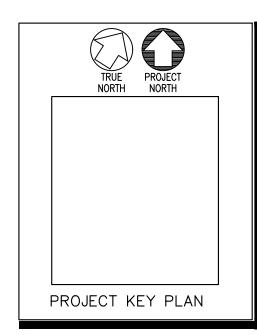

REPRODUCTION OF THIS DRAWING
IS PROHIBITED WITHOUT THE
ARCHITECT'S PERMISSION

REVISIONS:	DATE:
Revised for permit	15/09/21
issued for permit	09/01/22
issued for permit	15/08/22
Issued for Variance	12/11/24

DRAWN BY:

DEXTOR EDWARDS

DATE:

AUG 2021

SCALE:

AS SHOWN ON DETAIL

PROJECT:


346 ROOSEVELT
APARTMENT BLOCK
OTTAWA, ONT.

CLIENT:
KURT, SHAWN AND
GREG WESTWELL
OTTAWA, ONTARIO



JOB NO: 1006 - 09



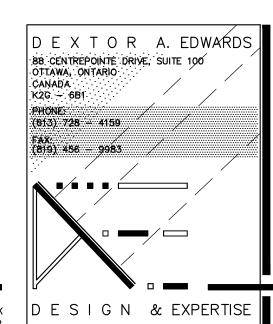

IT IS THE RESPONSIBILITY OF THE APPROPRIATE CONTRACTOR TO CHECK AND VERIFY ALL DIMENSIONS ON SITE AND REPORT ALL ERRORS AND OR OMISSIONS TO THE ARCHITECT.

# NORTH - ELEVATION AT SIDEYARD

PERCENTAGE OF EXPOSED BUILDING FACE AT NORTH ELEVATION FOR SPATIAL SEPARATION AS PER O.B.C. SECTION 3.2.3.1

PROPOSED AREA OF BUILDING FACE AT 1.2m LIMIT = 142 m2 (1,528.6 SQ.FT.)
PROPOSED GLAZING PERCENTAGE AT THIS FACE = 2.7% (3.9 m2.)

ALLOWABLE GLASS AREA AT BLDG FACE BASED ON 1.2m (3.9m2)
AT ACTUAL LIMITING DISTANCE = MAX 14%

THEREFORE THE EXTERIOR WALLS AT THIS BUILDING FACE IS ALLOWED TO BE GLAZED UP TO 14% IN ACCORDANCE WITH O.B.C. 3.2.3.1.D 14% IS THE ACTUAL O.B.C. LIMITATION BUT THE WALL ASSEMBLY ADJACENT TO THE PROTECTED OPENINGS SHALL BE RATED 1HR.

2.7 %

TOTAL SURFACE AREA = 142 m2.

UNPROTECTED OPENINGS= 3.9 m2

\_\_\_\_

AS PER O.B.C. 3.2.3.7.(3) AS COMBUSTIBLE CONSTRUCTION WITH NON-COMBUSTIBLE CLADDING

RATIO L/H 2:1

#### LEGEND


- 1 PROVIDE 4" CAP FLASHING AS SHOWN.
- 2 PROVIDE TRANSITION METAL FLASHING AT JOINT WITH DRIP EDGE AS SHOWN.
- 3 PROVIDE METAL CORBEL PROFILE AS SHOWN. (SEE SHEET A12)
- 4 PROVIDE DRIP FLASHING & J-MOULD AT WINDOW PERIMETER TO RECEIVE SIDING. (TYP.)
- 5 PRE-FIN METAL WRAP AROUND SPANDREL TO MATCH WINDOW FRAME COLOUR & FINISH.
- 6 SHEARWALLS INDICATED SHALL HAVE ONE FACE CONTINUOUS 5/8" T&G PLYWOOD NAILED AT ALL EDGES WITH 3" COMMON NAILS 4" o.c.

THE PLYWOOD PANELS ARE TO BE NAILED AT EACH INTERMEDIATE STUD WITH 3" COMMON NAILS 12" o.c.

STAGGER ALL PANEL JOINTS TO FALL ON DIFFERENT MEMBERS FROM ONE SIDE TO THE OTHER.

- 7 1 1/4" X 1/4" CORRUGATED METAL PANEL 26 Ga C/W GALVANIZED FINISH (TYP.).
- 8 PRE-PAINTED GALV. STEEL SIDING BY IDEAL ROOFING INDUSTRIAL METRO 26 Ga (TYP.).
- 9 PRE-FORMED METAL PANELS C/W GALVALUME FINISH (TYP.).
- 10 SEE SHEET A22 FOR PORCH STAIR DETAILS
- 11 PROVIDE FLEXIBLE FLASHING BEHIND EXT. CLADDING TO SIT UP 6" MIN. ON EXT. SHEATHING. (TYP.)
- 12 PROVIDE 2" DIA. PERIMETER
  PIPE RAILING AT 3'-6" ABOVE
  ROOF DECK C/W SUPPORTS
  AT 48" o.c. MAX.
- 13 PROVIDE SOLID STAIN
  FINISH TO MATCH
  PRE-FIN FLASHING &
  WRAP AROUND SPANDRELS.



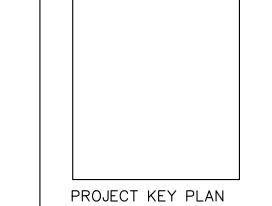

REPRODUCTION OF THIS DRAWING

IS PROHIBITED WITHOUT THE

ARCHITECT'S PERMISSION

REVISIONS:	DATE:
Revised for permit	15/09/21
issued for permit	09/01/22
issued for permit	15/08/22
Issued for Variance	12/11/24

DRAWN BY:

DEXTOR EDWARDS

DATE:

AUG 2021

SCALE:

AS SHOWN ON DETAIL


PROJECT:

346 ROOSEVELT
APARTMENT BLOCK
OTTAWA, ONT.
CLIENT:
KURT, SHAWN AND
GREG WESTWELL
OTTAWA, ONTARIO



JOB NO: 1006 - 09




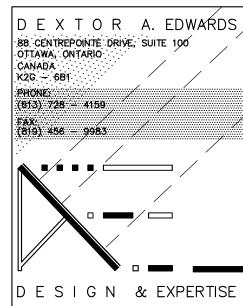

NORTH/RIGHT SIDE ELEVATION

See Married

15 The REPORTSHIPT OF the APPROVAL Contribution to Order AL Effords and Early Microbial To the Approval of the Approv

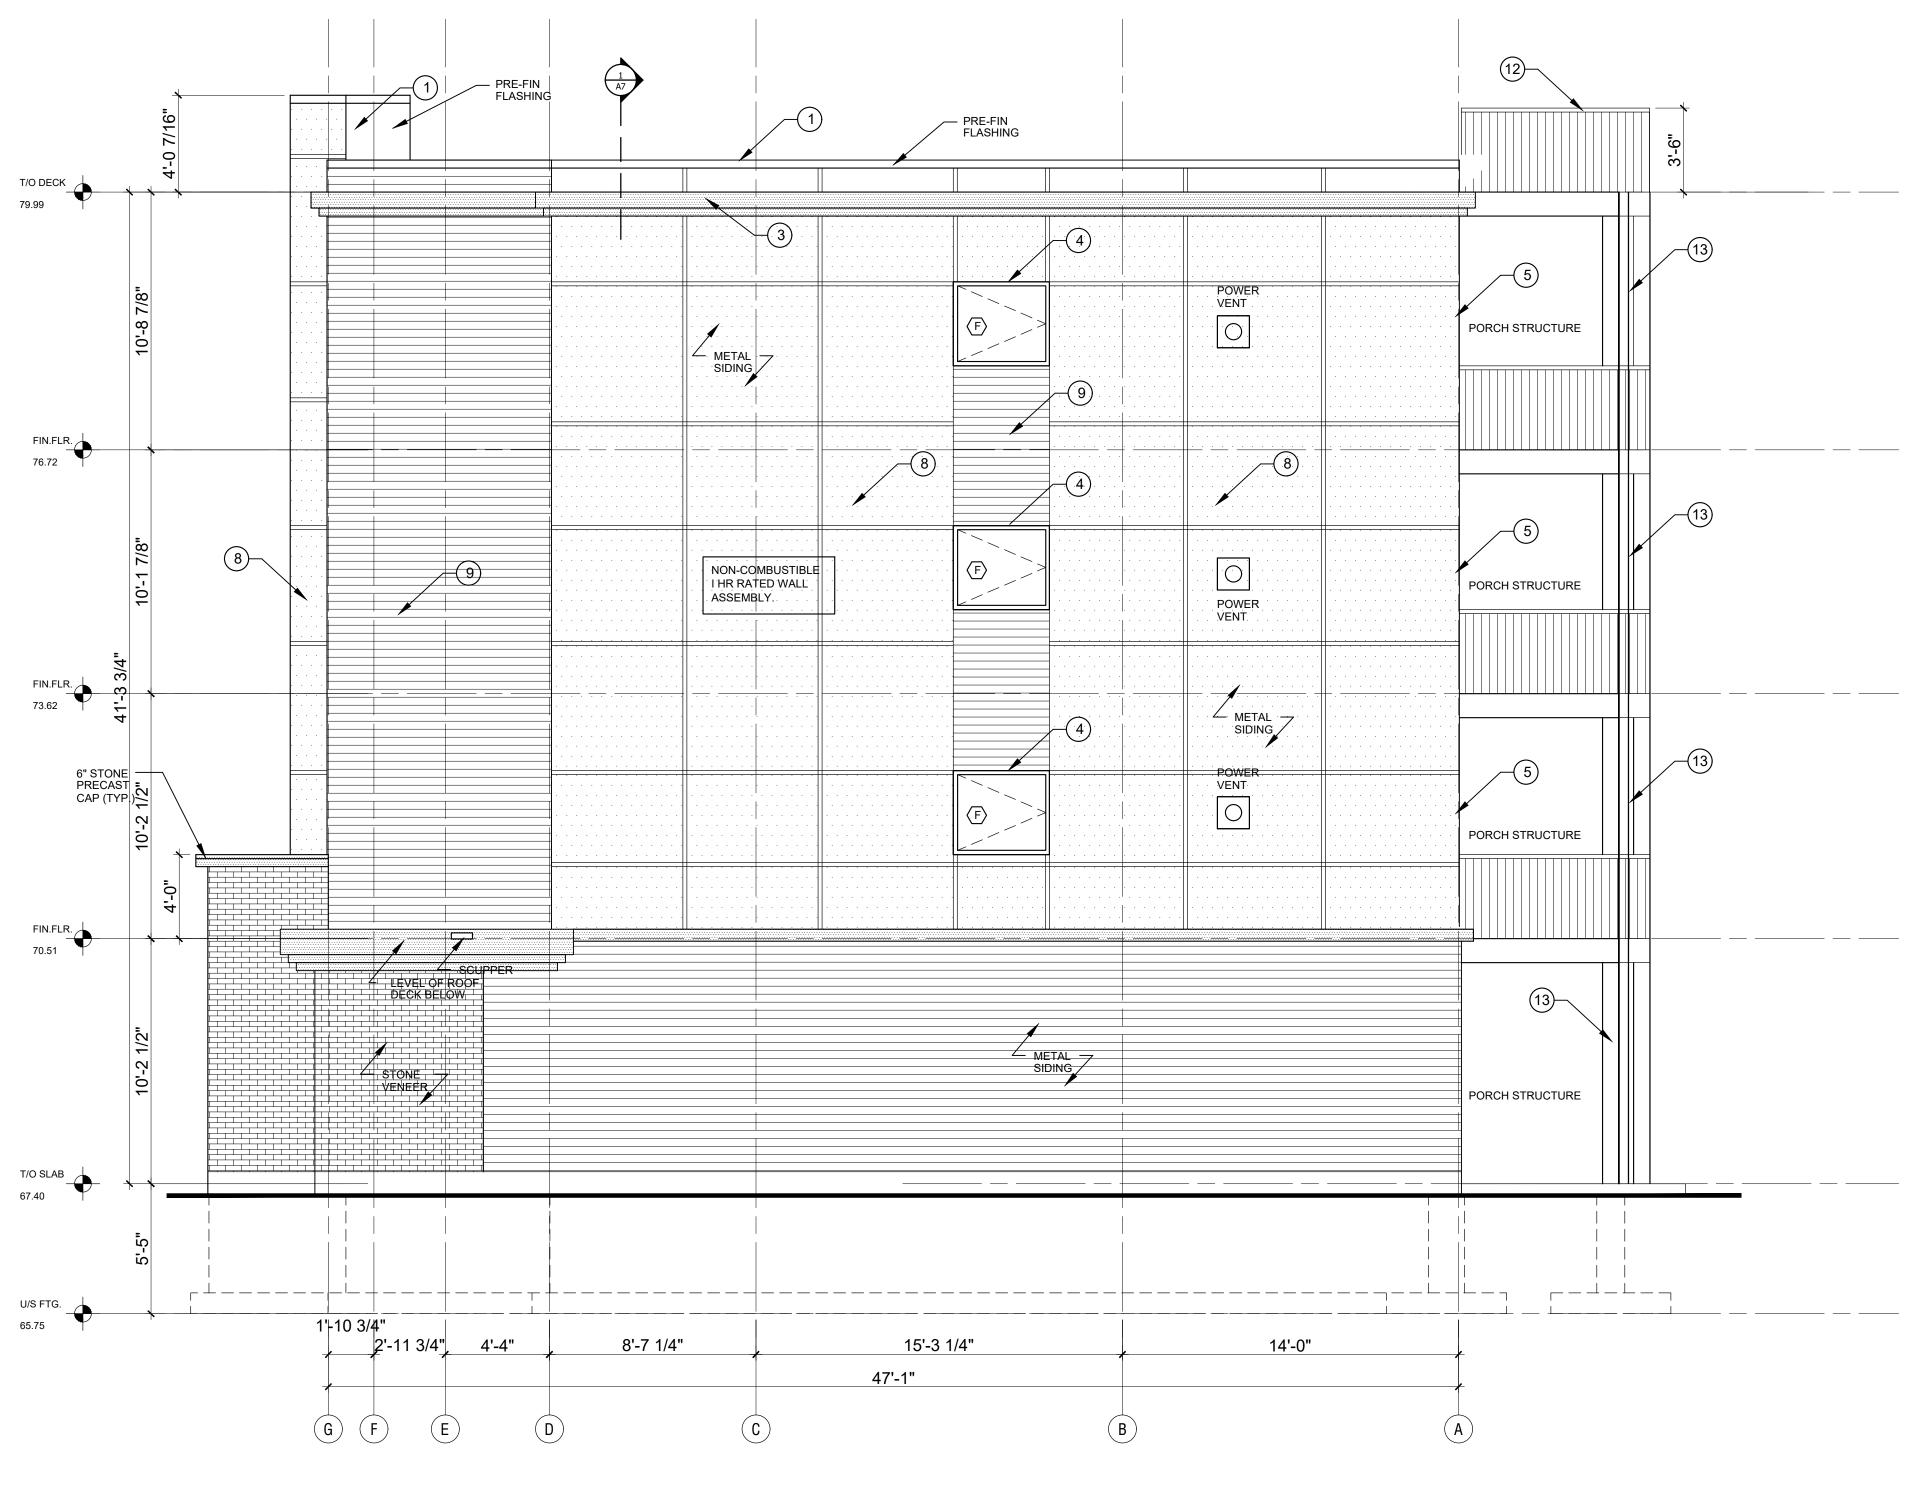

## **REAR - ELEVATION**

PERCENTAGE OF EXPOSED BUILDING FACE AT NORTH ELEVATION FOR SPATIAL SEPARATION AS PER O.B.C. SECTION 3.2.3.1

PROPOSED AREA OF BUILDING FACE AT 7.4m LIMIT = 109 m2 (1,178.57 SQ.FT.) PROPOSED GLAZING PERCENTAGE AT THIS FACE = 21% (23.25 m2.)

ALLOWABLE GLASS AREA AT BLDG FACE BASED ON 7.4m (23.25m2)

AT ACTUAL LIMITING DISTANCE = MAX 88%

THEREFORE THE EXTERIOR WALLS AT THIS BUILDING FACE IS ALLOWED TO BE GLAZED UP TO 88% IN ACCORDANCE WITH O.B.C. 3.2.3.1.D 88% IS THE ACTUAL O.B.C. LIMITATION BUT THE WALL ASSEMBLY ADJACENT TO THE PROTECTED OPENINGS SHALL BE RATED 1HR. AS PER O.B.C. 3.2.3.7.(3) AS COMBUSTIBLE CONSTRUCTION ESPECIALLY SINCE THE DISTANCE IS GREATER THAN 5m AND THE BUILDING IS SPRINKLERED.

TOTAL SURFACE AREA = 109 m2.

UNPROTECTED OPENINGS= 23.25 m2

22 %

RATIO L/H

### LEGEND

- 1 PROVIDE 4" CAP FLASHING AS SHOWN.
- 2 PROVIDE TRANSITION METAL FLASHING
- AT JOINT WITH DRIP EDGE AS SHOWN.

  3 PROVIDE METAL CORBEL PROFILE AS
- 4 PROVIDE DRIP FLASHING & J-MOULD AT WINDOW PERIMETER TO RECEIVE SIDING. (TYP.)

SHOWN. (SEE SHEET A12)

- 5 PRE-FIN METAL WRAP AROUND SPANDREL TO MATCH WINDOW FRAME COLOUR & FINISH.
- 6 SHEARWALLS INDICATED SHALL HAVE ONE FACE CONTINUOUS 5/8" T&G PLYWOOD NAILED AT ALL EDGES WITH 3" COMMON NAILS 4" o.c.

THE PLYWOOD PANELS ARE TO BE NAILED AT EACH INTERMEDIATE STUD WITH 3" COMMON NAILS 12" o.c.


STAGGER ALL PANEL JOINTS TO FALL ON DIFFERENT MEMBERS FROM ONE SIDE TO THE OTHER.

- 7 1 1/4" X 1/4" CORRUGATED METAL PANEL 26 Ga C/W GALVANIZED FINISH (TYP.).
- 8 PRE-PAINTED GALV. STEEL SIDING BY IDEAL ROOFING INDUSTRIAL METRO 26 Ga (TYP.).
- 9 PRE-FORMED METAL PANELS C/W GALVALUME FINISH (TYP.).
- 10 SEE SHEET A22 FOR PORCH STAIR DETAILS
- 11 PROVIDE FLEXIBLE FLASHING BEHIND EXT. CLADDING TO SIT UP 6" MIN. ON EXT. SHEATHING. (TYP.)
- 12 PROVIDE 2" DIA. PERIMETER
  PIPE RAILING AT 3'-6" ABOVE
  ROOF DECK C/W SUPPORTS
  AT 48" o.c. MAX.
- 13 PROVIDE SOLID STAIN
  FINISH TO MATCH
  PRE-FIN FLASHING &
  WRAP AROUND SPANDRELS.

Committee of Adjustment
Received | Reçu le

2024-11-12

City of Ottawa | Ville d'Ottawa
Comité de dérogation

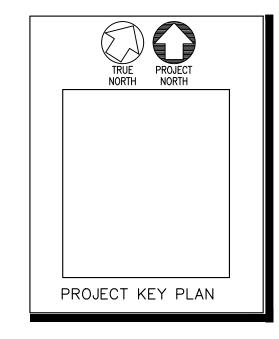

REPRODUCTION OF THIS DRAWING
IS PROHIBITED WITHOUT THE
ARCHITECT'S PERMISSION

REVISIONS:	DATE:
Revised for permit	15/09/21
issued for permit	09/01/22
issued for permit	15/08/22
Issued for Variance	12/11/24
	I

DRAWN BY:
DEXTOR EDWARDS
DATE:
AUG 2021
SCALE:
AS SHOWN ON DETAIL

PROJECT:


346 ROOSEVELT
APARTMENT BLOCK
OTTAWA, ONT.

CLIENT:
KURT, SHAWN AND
GREG WESTWELL
OTTAWA, ONTARIO



JOB NO: 1006 - 09



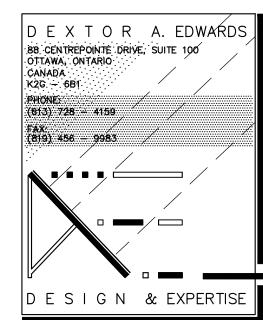

IT IS THE RESPONSIBILITY OF THE APPROPRIATE CONTRACTOR TO CHECK AND VERIFY ALL DIMENSIONS ON SITE AND REPORT ALL ERRORS AND OR OMISSIONS TO THE ARCHITECT.

