



GENERAL NOTES LEGEND SURFACES ALL DRAWINGS ARE TO BE READ IN CONJUNCTION WITH ALL OTHER DRAWINGS AND SPECIFICATIONS, INCLUDING OTHER CONSULTANTS DRAWINGS AND SPECIFICATIONS. PROPOSED GRASS ANY DISCREPANCIES BETWEEN DRAWINGS WILL BE REPORTED TO THE PROJECT LEAD IMMEDIATELY FOR RIVERSTONE CLARIFICATION PRIOR TO COMMENCING ANY CONSTRUCTION. CONCRETE PAVERS ALL GENERAL SITE INFORMATION AND CONDITIONS POURED CONCRETE HAVE BEEN COMPILED FROM EXISTING PLANS AND SURVEYS. ASPHALT PAVING CONTRACTOR IS RESPONSIBLE TO CHECK AND VERIFY ALL DIMENSIONS ON SITE AND REPORT ALL ERRORS PROPOSED NEW BUILDING AND / OR OMISSIONS TO THE ARCHITECT. CONCRETE RETAINING WALL NOTE-D: REFER TO LANDSCAPE PLAN FOR ALL EXTERIOR EXISTING BUILDING LANDSCAPING. TO BE DEMOLISHED NOTE-E: DO NOT SCALE DRAWINGS. ALL CONTRACTORS MUST COMPLY WITH ALL PROPERTY LINE APPLICABLE CODES AND REGULATIONS. SETBACK LINE **SURVEY INFO** TOPOGRAPHIC SURVEY OF : EXISTING FENCE $\times \!\!\!\!-\!\!\!\!\times \!\!\!\!-\!\!\!\!\times \!\!\!\!-\!\!\!\!\times$ **NEW FENCE** OVERHEAD WIRES -OHW-OHW-

EXISTING TO REMAIN

NEW PROPOSED

DIRECTIONAL ARROWS

BUILDING ACCESS

BUILDING EGRESS

UTILITY POLE

FIRE HYDRANT

SIAMESE CONNECTION

CATCH BASIN / MANHOLE

DEPRESSED CURB

LANDSCAPE LIGHT

WALL MOUNTED LIGHT

EXISTING GRADE ELEVATION

PROPOSED GRADE ELEVATION

LIGHT POLE

LOT CORNERS

BIKE PARKING

CAR PARKING R: RESIDENTIAL

V: VISITOR

BF PARKING

V: VISITOR

V: VISITOR

R: RESIDENTIAL V: VISITOR

BF PARKING (TYPE A) R: RESIDENTÌAL

BF PARKING (TYPE B) R: RESIDENTIAL


H: HORIZONTAL 0.6M x 1.8M

V: VERTICAL 0.5M x 1.5M S: STACKED 0.37M x 1.8M

 \bigcirc — \square

 \times XX.XXm

 \times XX.XXm

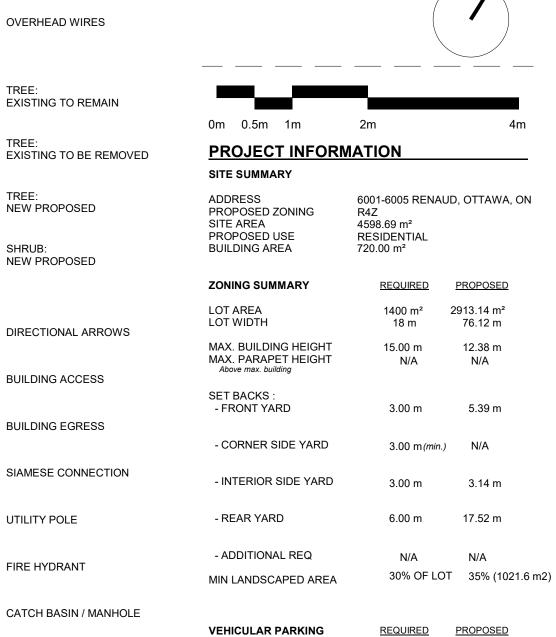

24(10 int)

PROPOSED

<u>PROPOSED</u>

<u>PROPOSED</u>

151.00 m² BALCONIES

107.00 m² EXTERIOR

REQUIRED

REQUIRED

REQUIRED

60.00 m²

60.00 m²

GFA - OBC

420.00 m²

313.00 m²

361.00 m²

321.00 m²

MIN PARKING SPACES

(incl. in count)

BICYCLE PARKING

MIN PARKING SPACES

WASTE CONTAINERS

ORGANICS (L)

AMENITY AREA

BUILDING SUMMARY

SEMI-BASEMENT

GROUND

LEVEL 2

LEVEL 3

PRIVATE

COMMUNAL

GARBAGE (0.231 y3/ unit) RECYCLING GMP (0.018 y³ / unit) RECYCLING FIBRE (0.062 y³ / unit)

MIN VISITOR PARKING SPACES

MIN ACCESSIBLE PRKG SPACES 1




88 Saint-Joseph Boulevard, Gatineau QC J8Y 3W5

This document and all information herein is confidential and the intellectual property of Rossmann Architecture Inc It is disclosed in confidence on terms that it will not be disclosed to any third party, used, sold, loaned, licensed, or reproduced in whole or in any part in any manner or form for manufacturing, tendering or for any other purpose without the written permission of Rossmann Architecture Inc. The copyright is retained by Rossmann

Ce document, ainsi que tous informations contenues a l'intérieur, est la propriété de Rossmann Architecture Inc. Il est divulgué en confidence sous les termes qu'il ne sera pas divulgué a aucun tierce partie, utilisé, vendu, prete, licensé ou reproduis en son entier ou en partie d'aucune maniere pour la manifacture, soumission ou pour autres fins sans la permission écrite de Rossmann Architecture Inc. Le droit d'auteur est retenu par

PROJECT TEAM / ÉQUIPE DU PROJET :

Rossmann Architecture Inc.

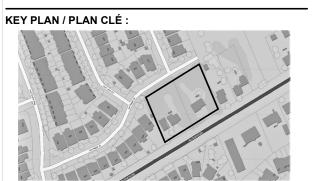



1.19	RD WIDENING	24-10-03
1.18	PERMIT	24-09-03
1.17	PERMIT DRAFT	24-08-23
1.16	SPC	24-07-15
1.15	COORDINATION	24-05-29
1.14	ISSUED FOR 66%	24-05-21
1.13	ISSUED FOR 66%	24-05-09
1.11	SPC REVISION	24-04-05
1.10	SPC REVISION	23-12-15
1.9	SPC REVISION	23-10-06
1.8	ISSUED FOR SPC	23-06-27
1.7	ISSUED FOR SPC	23-04-28
1.6	ISSUED FOR SPC	23-04-05
1.4	ISSUED FOR 66%	23-02-24
1.3	City discussion	22-11-16
revision	description	date

PROJECT NAME / NOME DU PROJET :

6001-6005 Renaud

DRAWING NAME / NOM DU DESSIN

SITE PLAN

DRAWING INFORMATION /	
INFORMATION DU DESSIN	:

22170 PROJECT NO. / NO. DE PROJET 2024-08-05 DRAWN BY / DESSINÉ PAR E.T. REVIEWED BY / VÉRIFIÉ PAR : As indicated

SCALE / ÉCHELLE :

PROJECT PHASE / PHASE DU PROJET DWG NO. / NO. DESSIN :

1.19 [△]

REVISION NO. / NO. DE RÉVISION : BIM 360://22170 - 6001-6005 Renaud/22170_6001-6005Renaud_DOCUMENTATION.rvt

I OSSMANN — A R C H I T E C T U R E —

.1 All general site information and conditions compiled from existing plans, surveys and consultant's field notes. Report all discrepancies prior to any work. No responsibility is born by the Consultant for unknown subsurface conditions. .2 The location of the utilities is approximate only, and the exact location should be determined by consulting the municipal authorities and utility companies concerned. The Contractor shall prove the location of utilities and shall be responsible for adequate protection from damage. .3 All dimensions shown are to be verified on site prior to any construction. No deviations are to be

made from the layouts as shown on this plan without prior consultation with the Landscape Architect and .4 Obtain approval of the Consultant(s) for granular

base and layout of all pavement areas prior to construction. .5 Stake planting locations and receive approval of ORNAMENTAL GRASSES Landscape Architect, prior to excavation of any planting pits. No substitutions of plant material shall

GENERAL NOTES


Architect. .6 Where clay is encountered proper drainage must be ensured in tree/shrub pits, prior to planting. Have method approved by Landscape Architect. .7 Maintain positive surface runoff through the entire construction period.

be made without prior approval of the Landscape

.8 Reinstate all areas and items damaged as a result of construction activities.

CANOPY COVERAGE CALCULATION

	COVERAGE	AREA (m2)
SOIL VOLUME EXTENTS	TOTAL CANOPY COVER	1662
FOR TREE PLANTING	SITE AREA	2914
TREE CANOPY EXTENT AT MATURITY	Percent coverage	57.0%

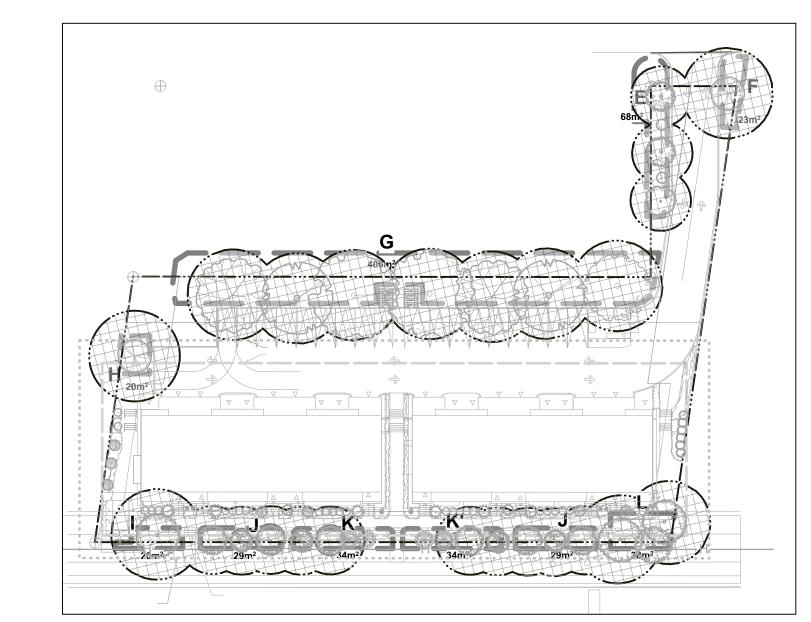

TREE CANOPY & SOIL VOLUME AREAS

Scale: 1:500

SOIL VOLUME CALCULATION

LEGEND

PHASING

— PROPERTY LINE

7.5m GEOTECHNICAL

BUILDING OFFSET

BUILDING OFFSET

HYDRO LINE

PERENNIALS

REMAIN

TREE PROTECTION FENCE


4.5m GEOTECHNICAL

HYDRO LINE HEIGHT RESTRICTED AREA

EXISTING TREES TO

CRITICAL ROOT ZONE

plant bed (68 sq m x 0.8 ave metre deep)	5	59.0	54.4	92%
AREA F - 1 small tree	-			
plant bed (23 sq m x 1 ave metre deep)	1	25.0	23.0	92%
AREA G - 7 medium trees				
plant bed (406 sq m x 0.6 ave metre deep)	7	126.0	243.6	1939
AREA H - 1 small tree				
plant bed (20 sq m x 0.9 ave metre deep)	1	20.0	18.0	90%
AREA I - 1 ornamental trees				
plant bed (20 sq m x 0.9 metre deep	1	20.0	18.0	90%
AREA J - 3 ornamental trees				
plant bed (29 sq m x 1 metre deep	3	36.0	29.0	819
AREA K, K' - 2 ornamental trees, 2 small orname	ental conifers			
plant bed (34 sq m x 1 metre deep	4	38.0	34.0	89%
AREA L - 3 ornamental trees				
plant bed (38 sq m x 0.9 metre deep	3	36.0	34.2	95%

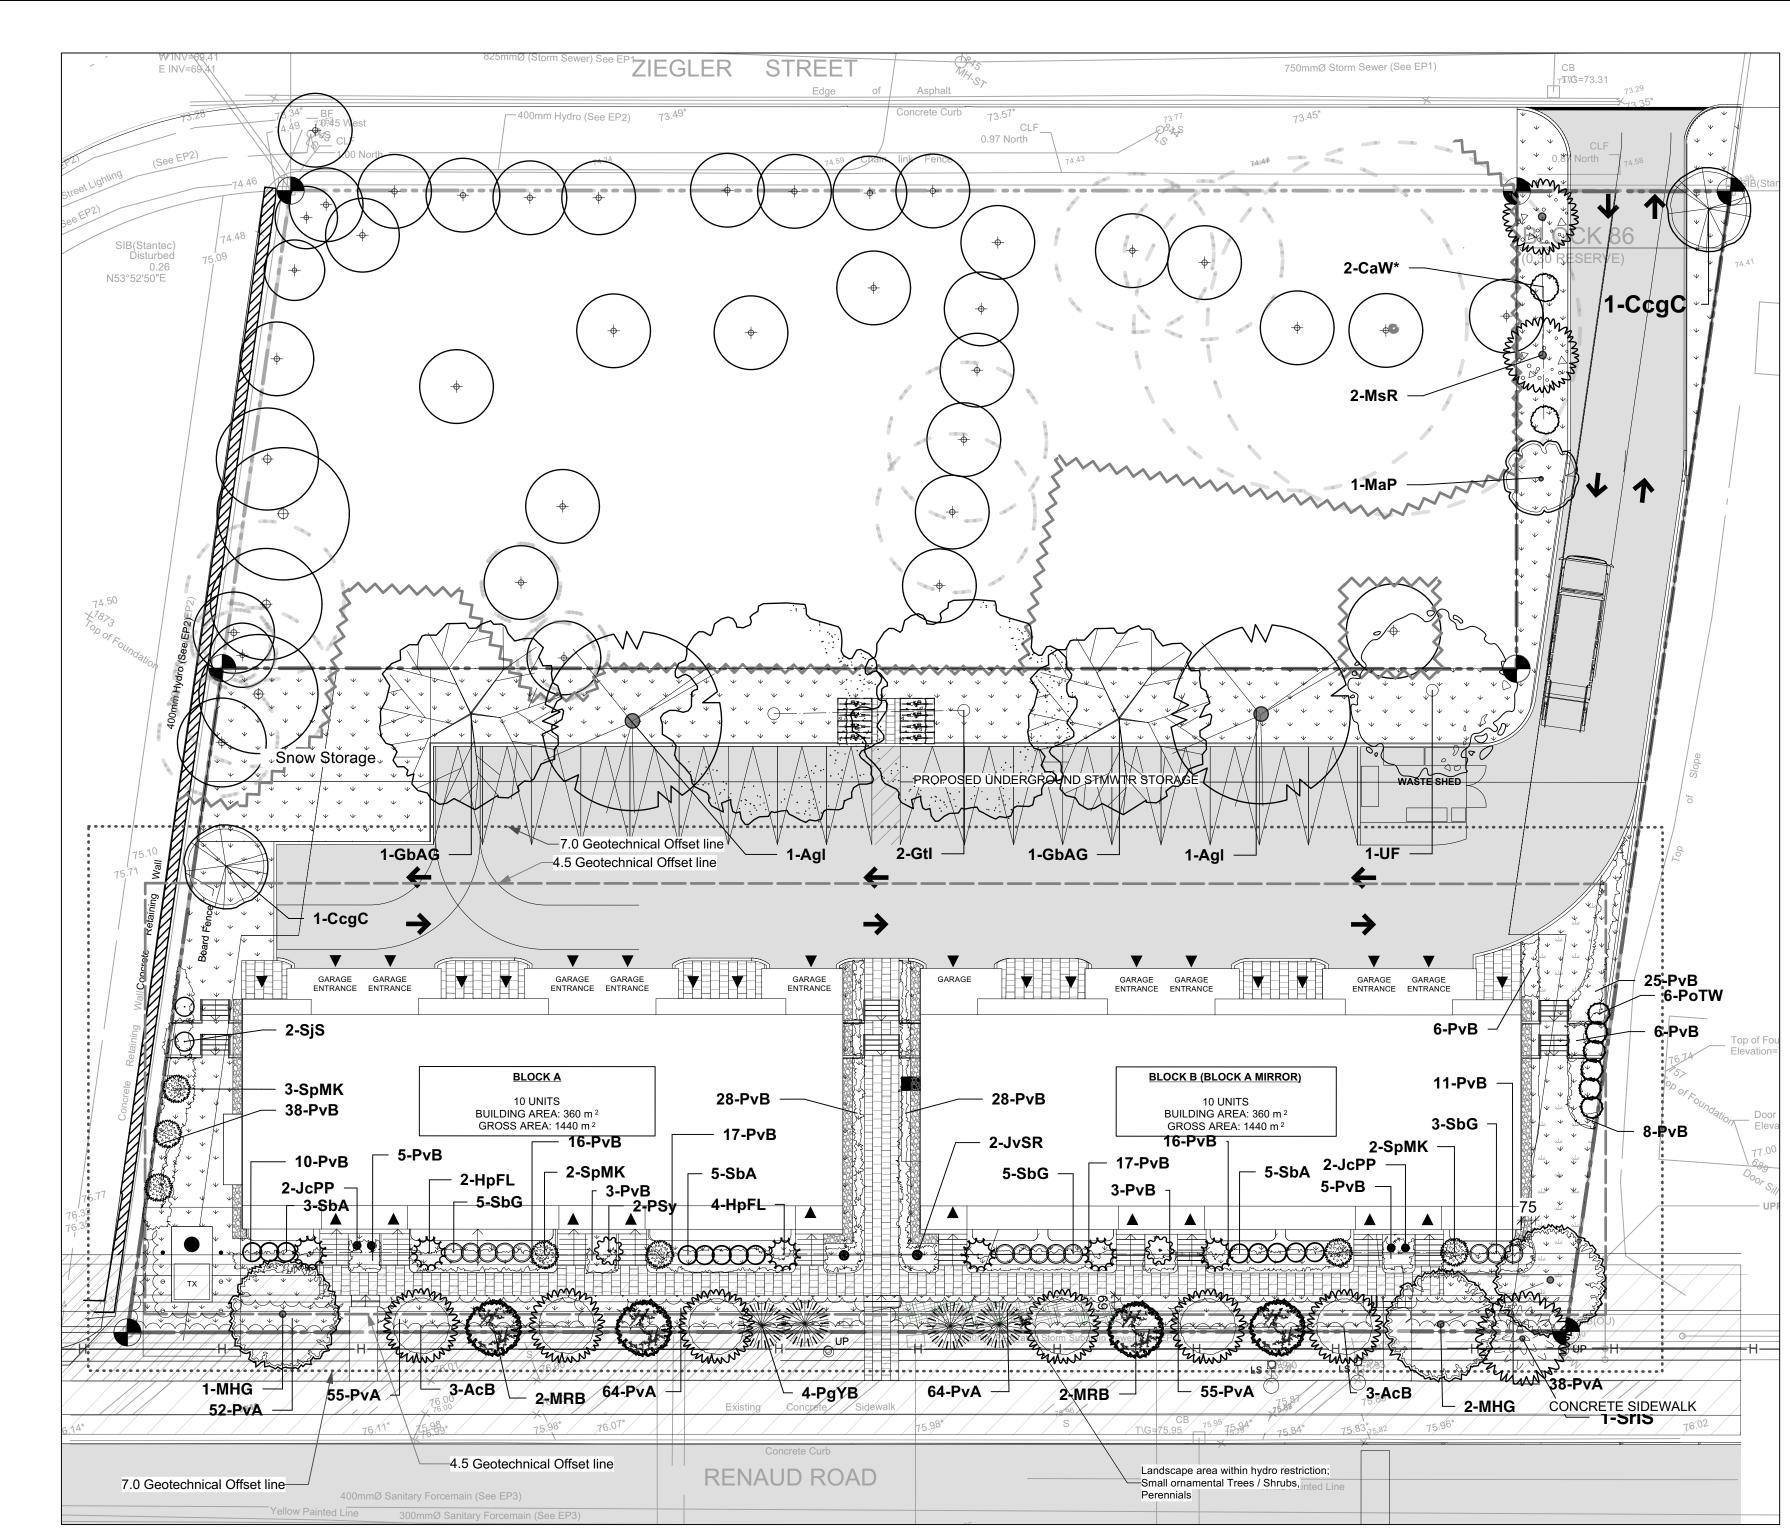

LANDSCAPE / PLANTING PLAN Scale: 1:200

Plant Li	ist				
ID	Qty	Botanical Name	Common Name	Scheduled Size	Remarks
		MEDIUM TREES: 9 - 13.5m ht, 8.5 - 20m Ø canopy			
Agl	2	Aesculus glabra	Ohio Buckeye	50mm caliper	WB, Staked
GbAG	2	Ginkgo biloba 'Autumn Gold'	Autumn Gold Maidenhair Tree	60mm caliper	WB, Staked
Gtl	2	Gleditsia triacanthos var. inermis 'Impcole'	Imperial Honeylocust	70mm caliper	WB, Staked
UF	1	Ulmus minor x parvifolia 'Frontier'	Frontier Elm	60mm caliper	WB, Staked
		SMALL TREES: 6 - 8m ht, 6 - 8m Ø canopy			
CcgC	2	Crataegus crus-galli inermis 'Cruzam'	Thornless Crusader Cockspur Hawtl	<u> </u>	WB, Staked
		ORNAMENTAL TREES: 4 - 7m ht, 4 - 6m Ø canopy (6m ht max under power lines)			
AcB	6	Amelanchier canadensis 'Ballerina'	Ballerina Serviceberry (tree form)	50mm caliper	WB, Staked
MHG	3	Malus x `Harvest Gold`	Harvest Gold Crabapple	50mm caliper	WB, Staked
MRB	4	Malus x `Royal Beauty`	Royal Beauty Crabapple	45mm caliper	WB, Staked
SrIS	1	Syringa reticulata 'Ivory Silk'	Ivory Silk Tree Lilac	50mm caliper	WB, Staked
		SMALL ORNAMENTAL TREES: <4.5m ht, <4			
CaW*	2	Caragana arborescens 'Walker'	Walker's Weeping Peashrub	125cm STEM	WB, Specimen
MaP	1	Morus alba 'Pendula'	Weeping Mulberry, male	150cm stem	Fruitless, B&B
MsR	2	Malus sargentii "Rosea"	Pink Flowering Crabapple	45mm caliper	WB, Staked
PgYB	4	Picea glauca 'Yukon. Blue'	Yukon Blue White Spruce	75cm spd	WB, Staked
		SHRUBS			
HpFL	6	Hydrangea paniculata 'Fire Light'	Fire Light pannicle hydrangea	2 gallon pot	0.9m o.c.
JcPP	4	Juniperus communis 'Pencil Point'	Pencil Point Juniper	150cm stem	Potted
JvSR	2	Juniperus virginiana 'Skyrocket' (J. scopulorum	Skyrocket Juniper	150cm stem	Potted
PoTW	6	Physocarpus opulifolius 'Tiny Wine'	Tiny Wine Dwarf Ninebark	50cm ht.	Potted
PSy	2	Philadelphus 'Sybile'	Minnesota Snowflake Mockorange	60mm dia.	WB Staked
SbA	13	Spiraea bumalda 'Anthony Waterer'	Anthony Waterer Spirea	50cm ht.	Potted, 0.9m o.
SbG	13	Spiraea bumalda 'Goldflame'	Goldflame Spirea	50cm ht	0.9m o.c.
SjS	2	Spiraea japonica 'Shirobana'	Shirobana Spirea	50cm ht.	0.8m o.c.
SpMK	7	Syringa patula 'Miss Kim'	Miss Kim Dwarf Lilac	100cm ht.	3 gallon Pot

		PERENNIALS			
D	Qty	Description	Types	Sched. Size	Remarks
PvA	264	Ornamental grasses	Karl Foerster Feather Reed Grass, Blue Fescue	150mm pot	40-60cm o.c.
PvB	242	Sun flowering perennials	Coneflower, Black-eyed Susan, Spiked Speedwell, Seathrift, Beebalm, Daylily, Siberian Iris, Cardinal Flower, Ozark Sundrops	150mm pot	60cm o.c.

NOTE:

NOTE:

THIS PLAN IS ISSUED FOR BUILDING PERMIT SUBMISSION ONLY. ADDITIONAL DETAILING AND **SPECIFICATIONS ARE REQUIRED** PRIOR TO TENDERING OR CONSTRUCTION.

THIS PLAN TO BE READ IN CONJUNCTION WITH TCR BY DENDRON FORESTRY SERVICES. EXISTING TREES TO BE PRESERVED AND PROTECTED AS PER TCR.

SERVICING INFORMATION SHOWN AS REFERENCE ONLY. REFER TO CIVIL DRAWINGS.

L-01

88 boul. St-Joseph, Gatineau, QC, J8Y 3W5 Tel: 1 819-600-1555

4 Re-Issued for SPC 2023/12/21 MR Re-Issued for SPC 2023/10/05 MR Re-Issued for SPC 2023/06/27 MR Issued for SPC 2023/06/09 MR DATE: (Y/M/D) INITIALS INITIALE NUMBER/ NUMÉRO MILESTONE / FAIT SAILLANT DESIGNED BY / CONCU PAR CHECKED BY / VERIFIE PAR M. Ruhland M. Ruhland DRAWN BY / DESSINE PAR SCALE / ECHELLE

6 Re-Issued for SPC

Issued for Building Permit




2024/10/28 MR

2024/09/18 MR

Ruhland & Associates Ltd landscape architecture • urban design • site planning

ARCHITECT

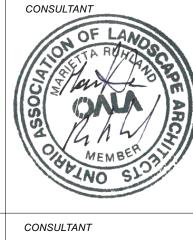

CONSULTANT


PROJECT / LOCATION


LANDRIC HOMES **SEMIS & STACKED TOWN HOMES**

6001 - 6005 RENAUD ROAD OTTAWA, ONTARIO

LANDSCAPE / PLANTING PLAN, TREE CANOPY COVERAGE / SOIL VOLUME

> PROJECT NO. 21-1660

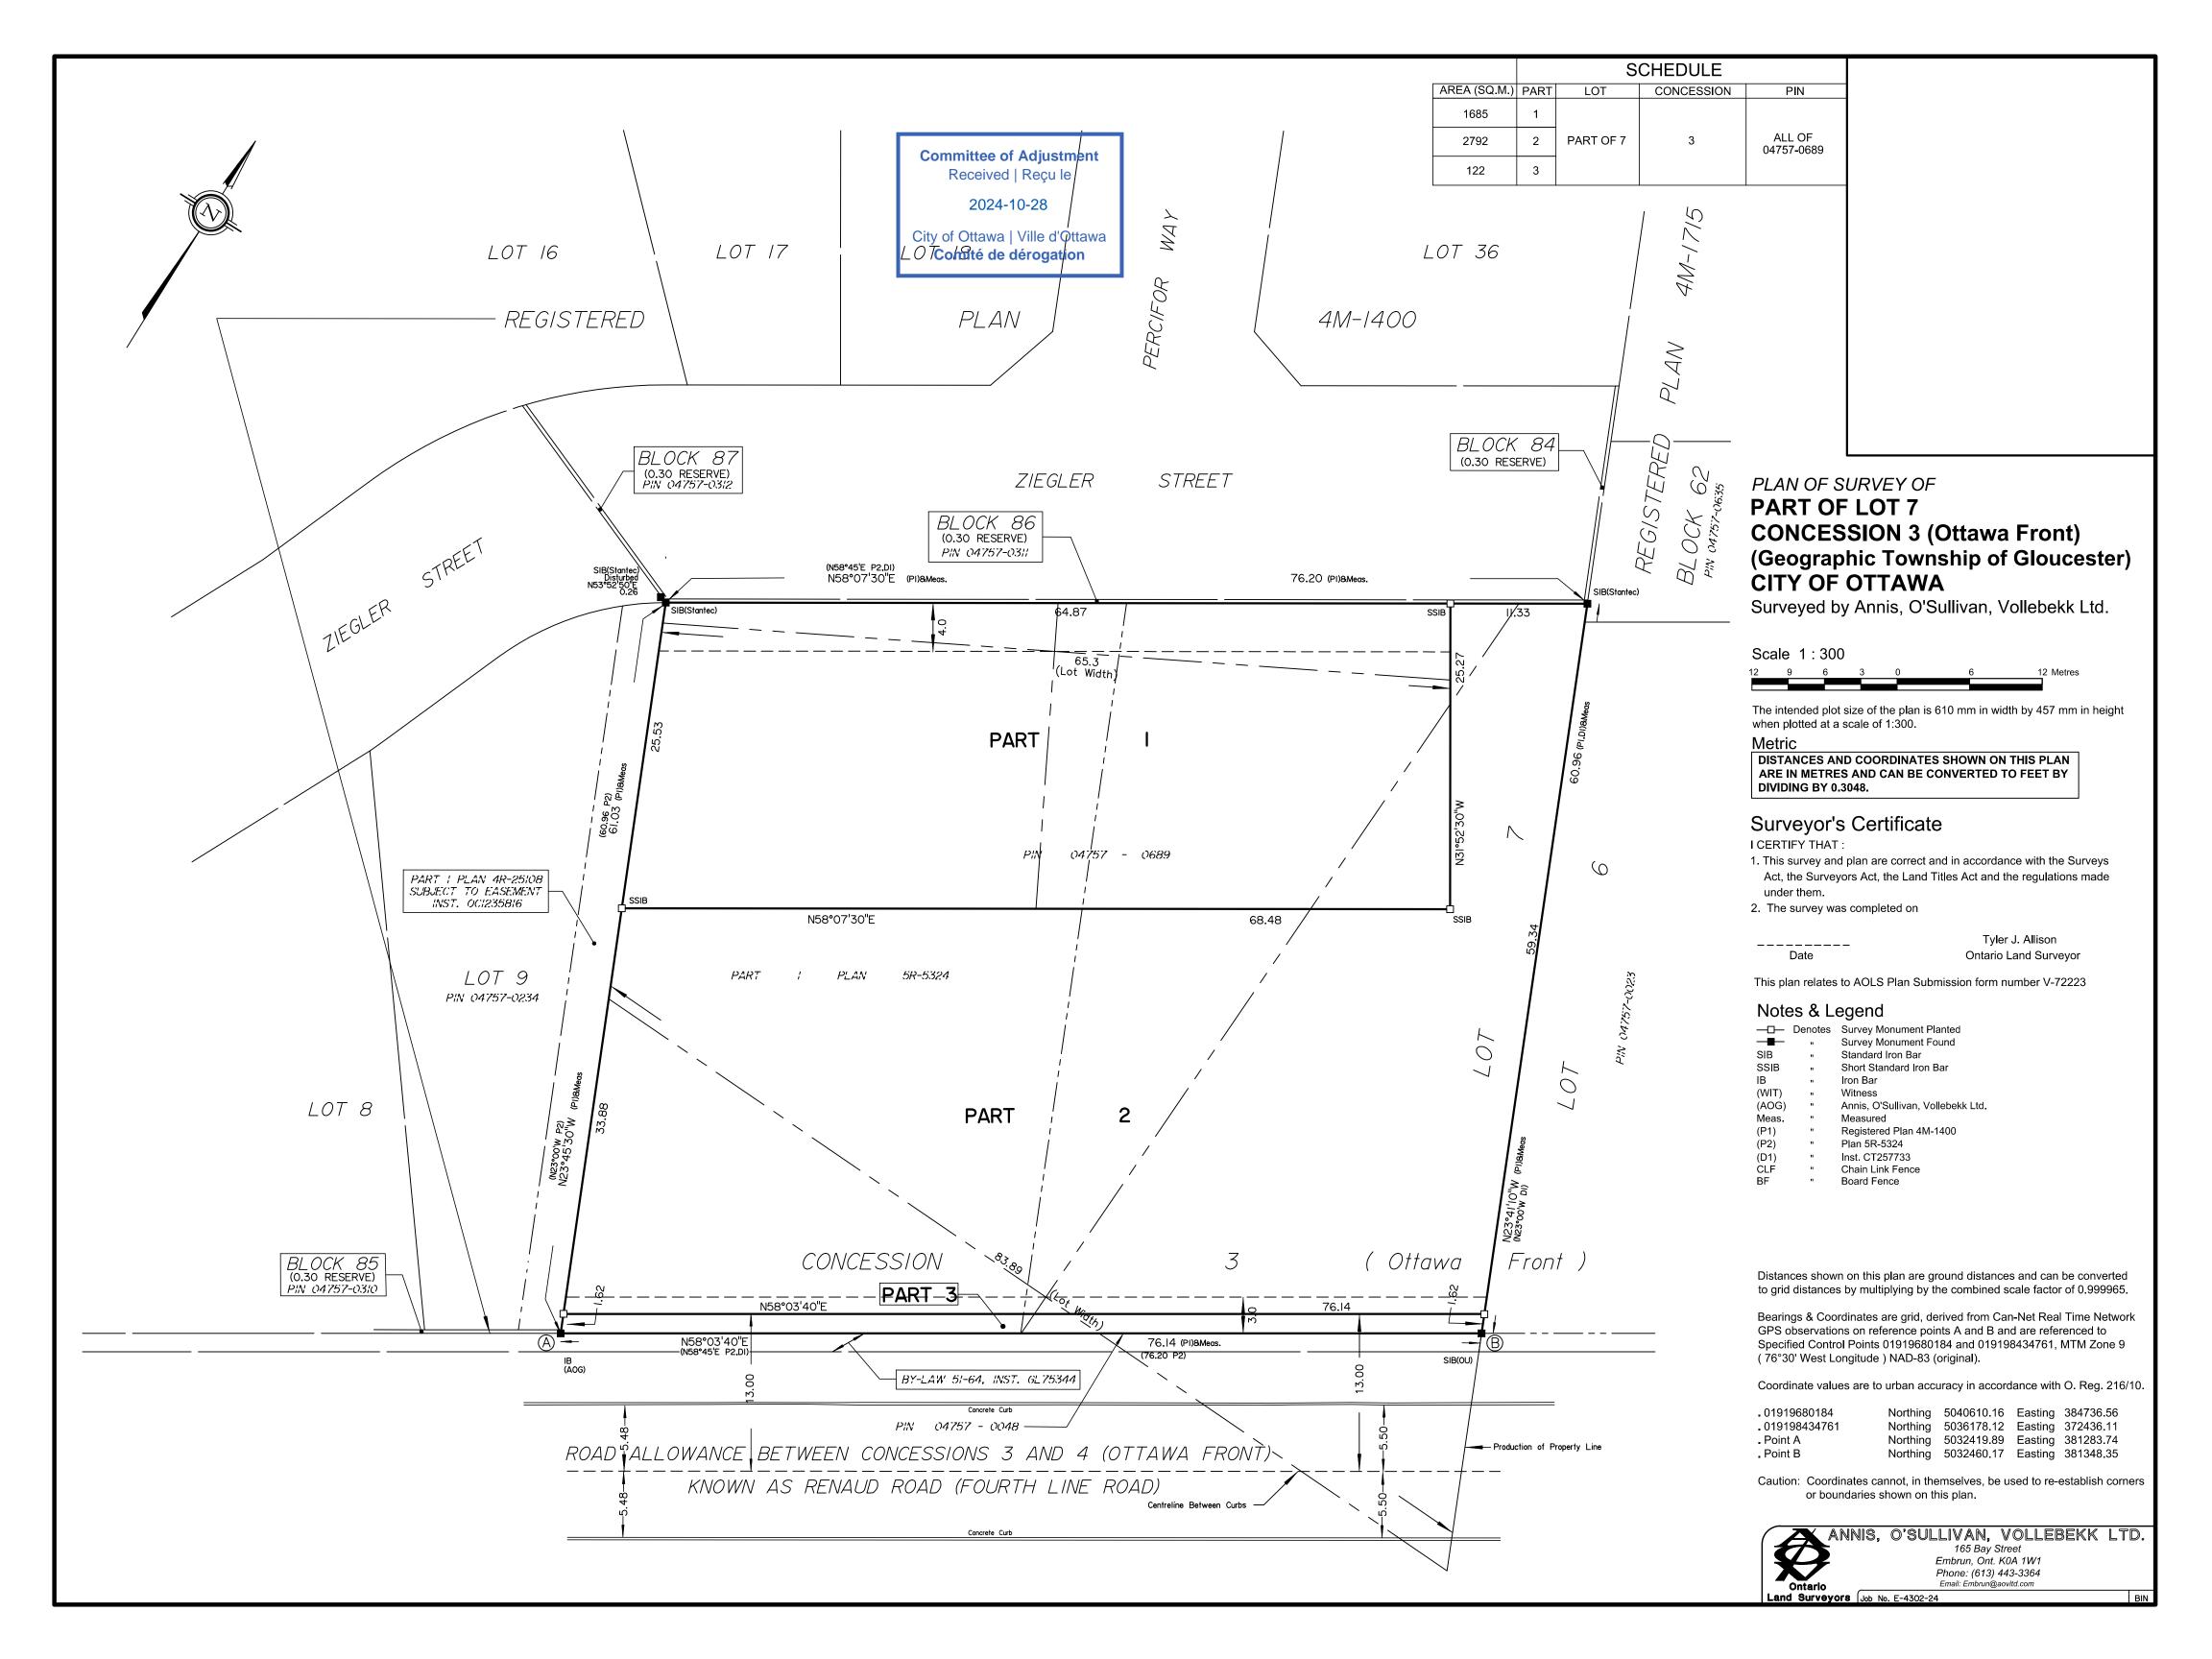

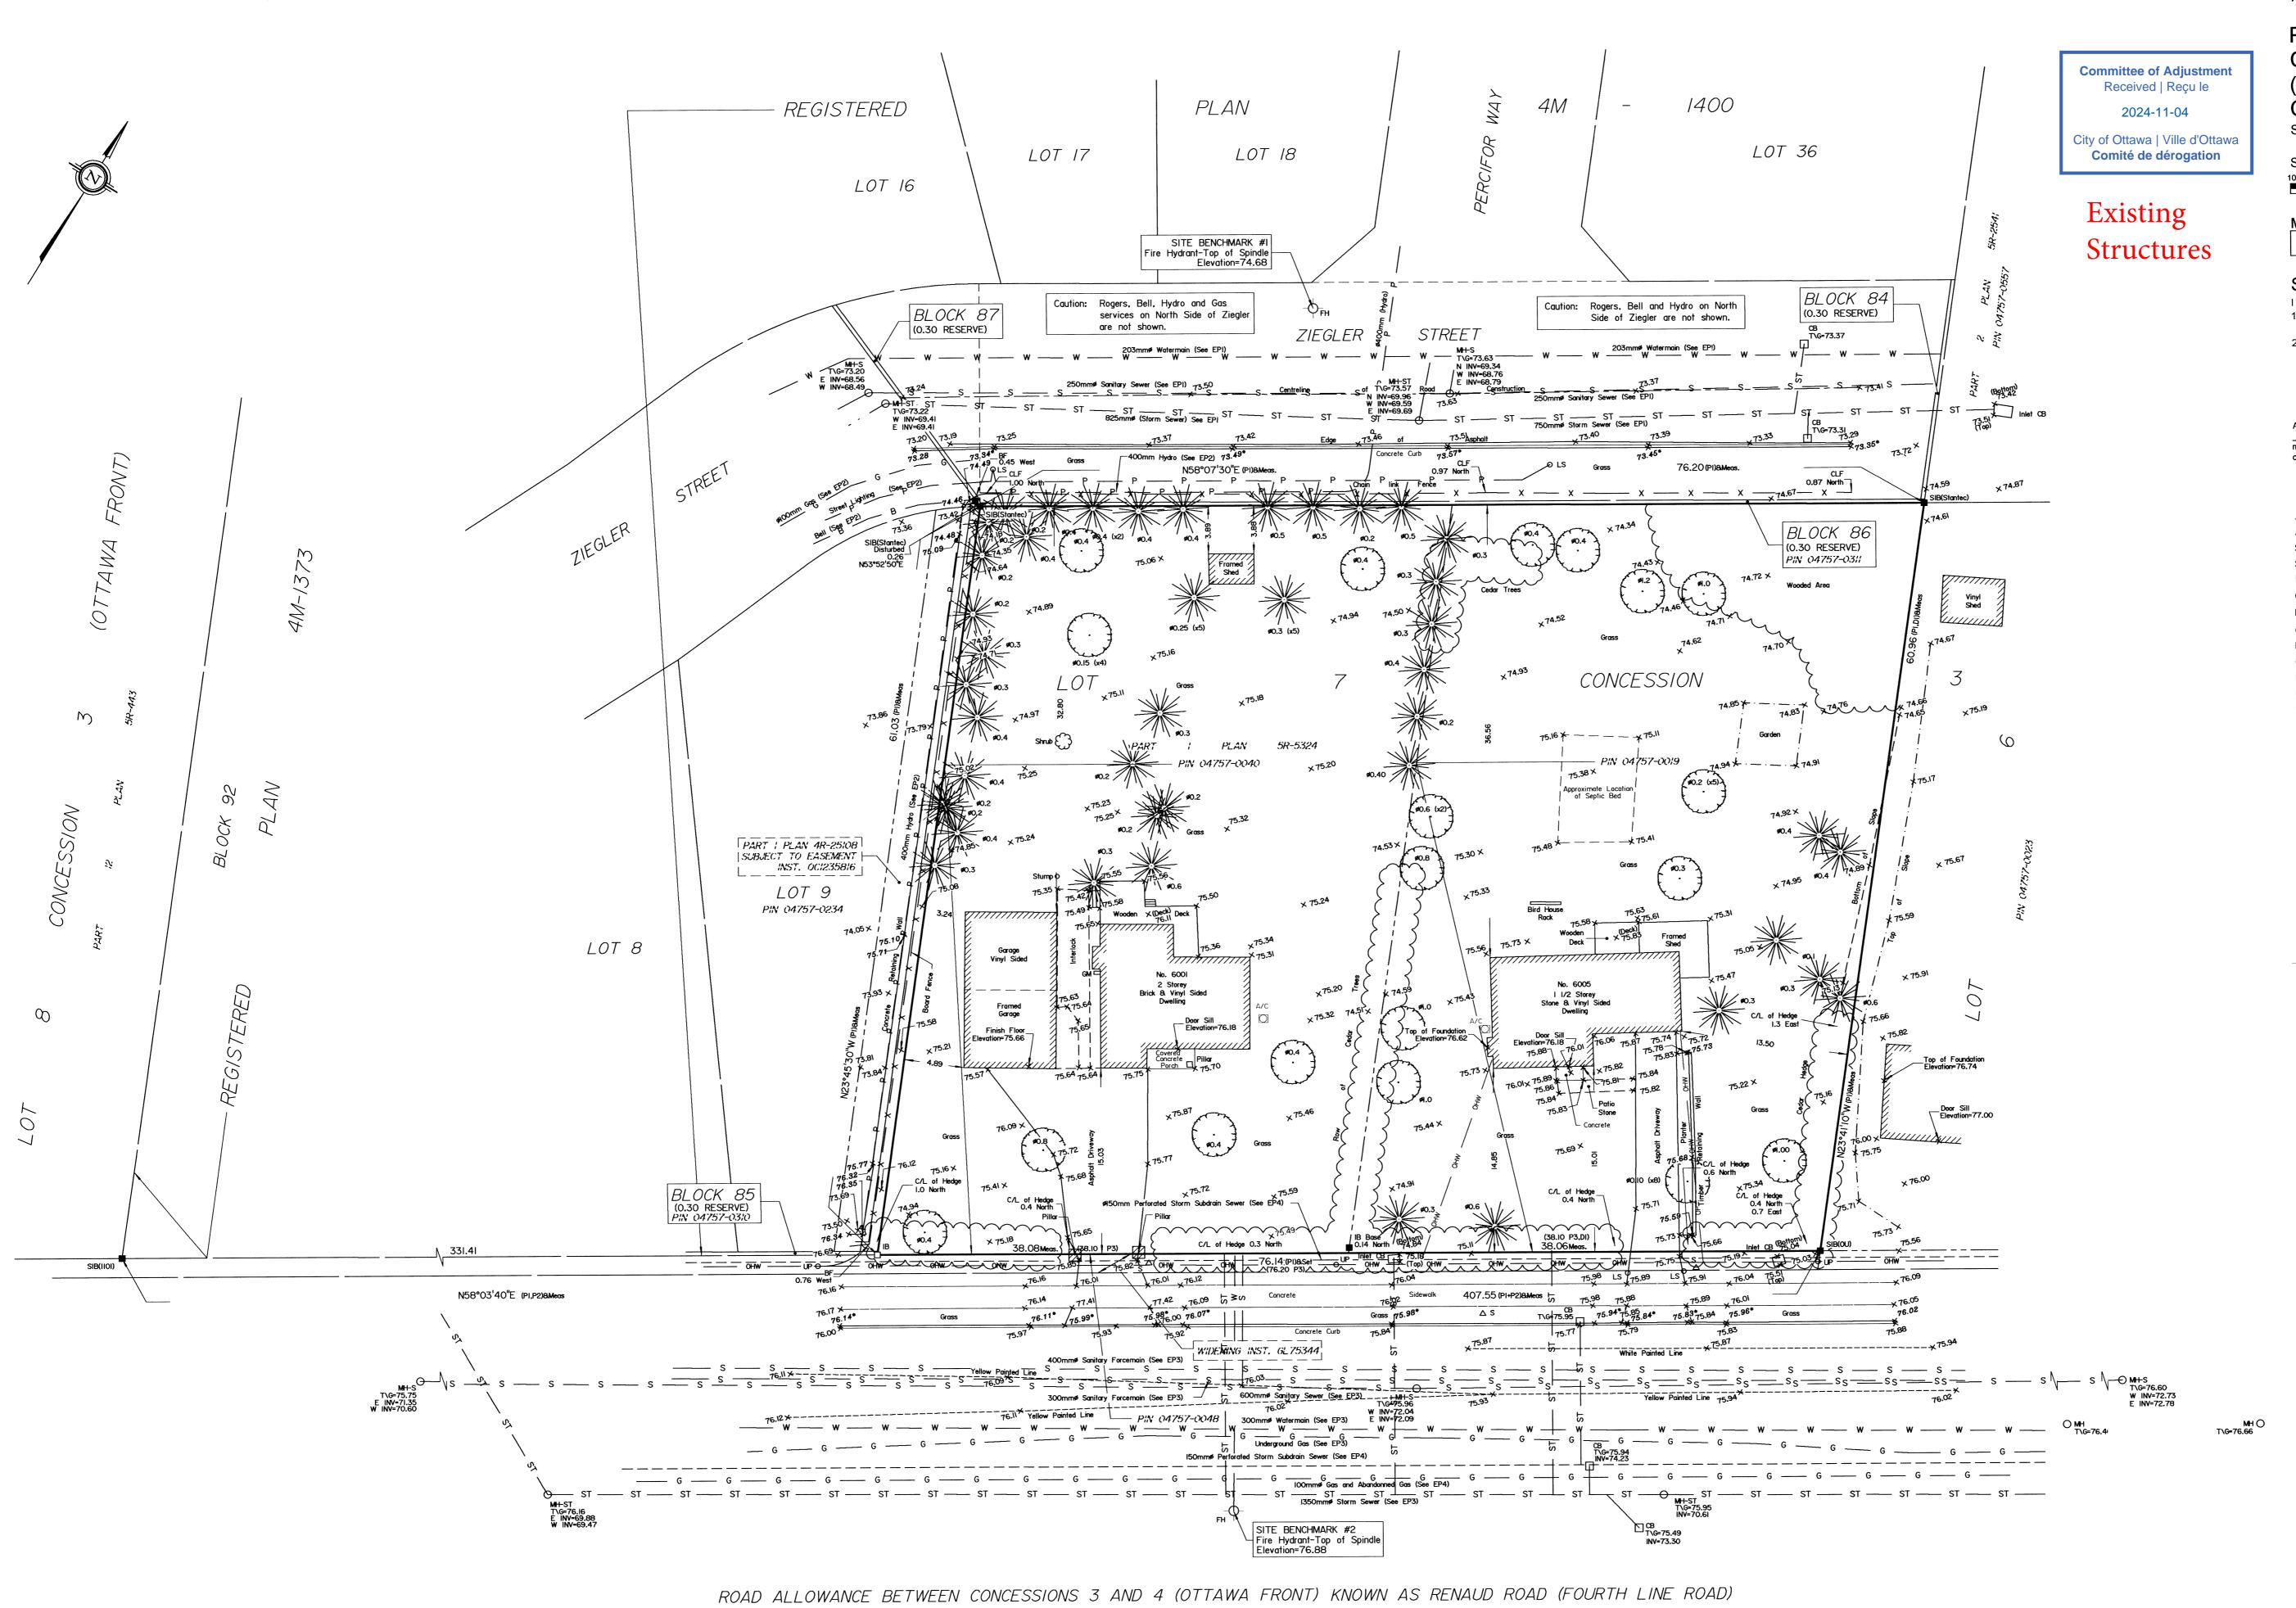

TOPOGRAPHICAL PLAN OF SURVEY OF

PART OF LOT 7 CONCESSION 3 (OTTAWA FRONT) (Geographic Township of Gloucester) CITY OF OTTAWA

Surveyed by Annis, O'Sullivan, Vollebekk Ltd.

Scale 1:250

DISTANCES SHOWN ON THIS PLAN ARE IN METRES AND CAN BE CONVERTED TO FEET BY DIVIDING BY 0.3048

Surveyor's Certificate

I CERTIFY THAT:

1. This survey and plan are correct and in accordance with the Surveys Act, the Surveyors Act and the regulations made under them 2. The survey was completed on May 7, 2021.

Ontario Land Surveyor

copies of the Topographical Plan of Survey in transactions involving The Client.

Notes & Legend

Survey Monument Planted Survey Monument Found Standard Iron Bar Short Standard Iron Bar Annis, O'Sullivan, Vollebekk Ltd. Registered Plan 4M-1400 Registered Plan 4M-1373 Plan 5R-5324 Plan by Stantec Job No. 161650000-109, Ref 4M-1400 Plan and Profile of Ziegler Street (T.L. Mak Engineer Consultants, Project 805-47) Drawing P-2 Rev. 5 "As Recorded" 07/22/14 City of Ottawa U.C.C. Central Registry Data, Sheet J-29-24 Dated August 2015 Plan and Profile of Renaud Road (Stantec Project 160400704) Drawing PP-2 Rev. 7 "As Recorded" 11/12/12 City of Ottawa U.C.C. Central Registry Data, Sheet J-29-30 Dated August 2015 Inst. CT257733 Coniferous Tree Fire Hydrant Maintenance Hole (Storm Sewer) Maintenance Hole (Sanitary) Maintenance Hole (Unitentified) Catch Basin Chain Link Fence Light Standard Air Conditioner Location of Elevations Top of Concrete Curb Elevation Top of Retaining Wall Elevation ASSOCIATION OF ONTARIO Centreline LAND SURVEYORS
PLAN SUBMISSION FORM Property Line Underground Storm Sewer Underground Sanitary Sewer THIS PLAN IS NOT VALID UNLESS IT IS AN EMBOSSED ORIGINAL COPY ISSUED BY THE SURVEYOR IN ACCORDANCE WITH Regulation 1026, Section 29 (3)

Bearings are grid, derived from Can-Net 2016 Real Time Network GPS observations and are referenced to Specified Control Points 01919680184 and 019198434761, MTM Zone 9 (76°30' West Longitude) NAD-83

Coordinate values are to urban accuracy in accordance with O. Reg. 216/10.

Northing 5040610.16 Easting 384736.56 . 01919680184 Northing 5036178.12 Easting 372436.11 . 019198434761

ELEVATION NOTES


1. Elevations shown are geodetic and are referred to the CGVD28 geodetic datum. 2. It is the responsibility of the user of this information to verify that the job benchmark has not been altered or disturbed and that it's relative elevation and description agrees with the information shown on this drawing.

UTILITY NOTES

1. This drawing cannot be accepted as acknowledging all of the utilities and it will be the responsibility of the user to contact the respective utility authorities for confirmation.

Only visible surface utilities were located. 3. A field location of underground plant by the pertinent utility authority is mandatory before any work involving breaking ground, probing, excavating etc. 4. Underground services (including invert elevations) shown are compiled from EP1,

EP2, EP3 and EP4 and are subject to field confirmation. © Annis, O'Sullivan, Vollebekk Ltd, 2021. "THIS PLAN IS PROTECTED BY COPYRIGHT"

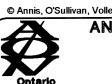

ANNIS, O'SULLIVAN, VOLLEBEKK LTD. Embrun, Ont. K0A 1W1 Phone: (613) 443-3364 Email: embrun@aovltd.com