

Committee of Adjustment Received | Reçu le

#### 2024-08-12

City of Ottawa | Ville d'Ottawa Comité de dérogation

### **Request for Minor Variance**

946 Colonel By Drive, Ottawa, ON | Zoning: R3Q[2118]H(9)

**VARIANCE 1 :** To permit a building height of 11.74 m.

- Whereas:

The Zoning by law 2008-250 Part 15 Exception 2118 states that the maximum building height permitted is 9 m.

- **VARIANCE 2 :** To permit a roof terrace that is not located on the roof of the uppermost storey.
- Whereas:

The Zoning by law 2008-250 Part 15 Exception 2118 Part 15 Exception 2118 states no roof top patios or decks are permitted.







### Context Aerial






NO CONCERNSSOME CONCERNS


OPPOSED NO RESPONSE





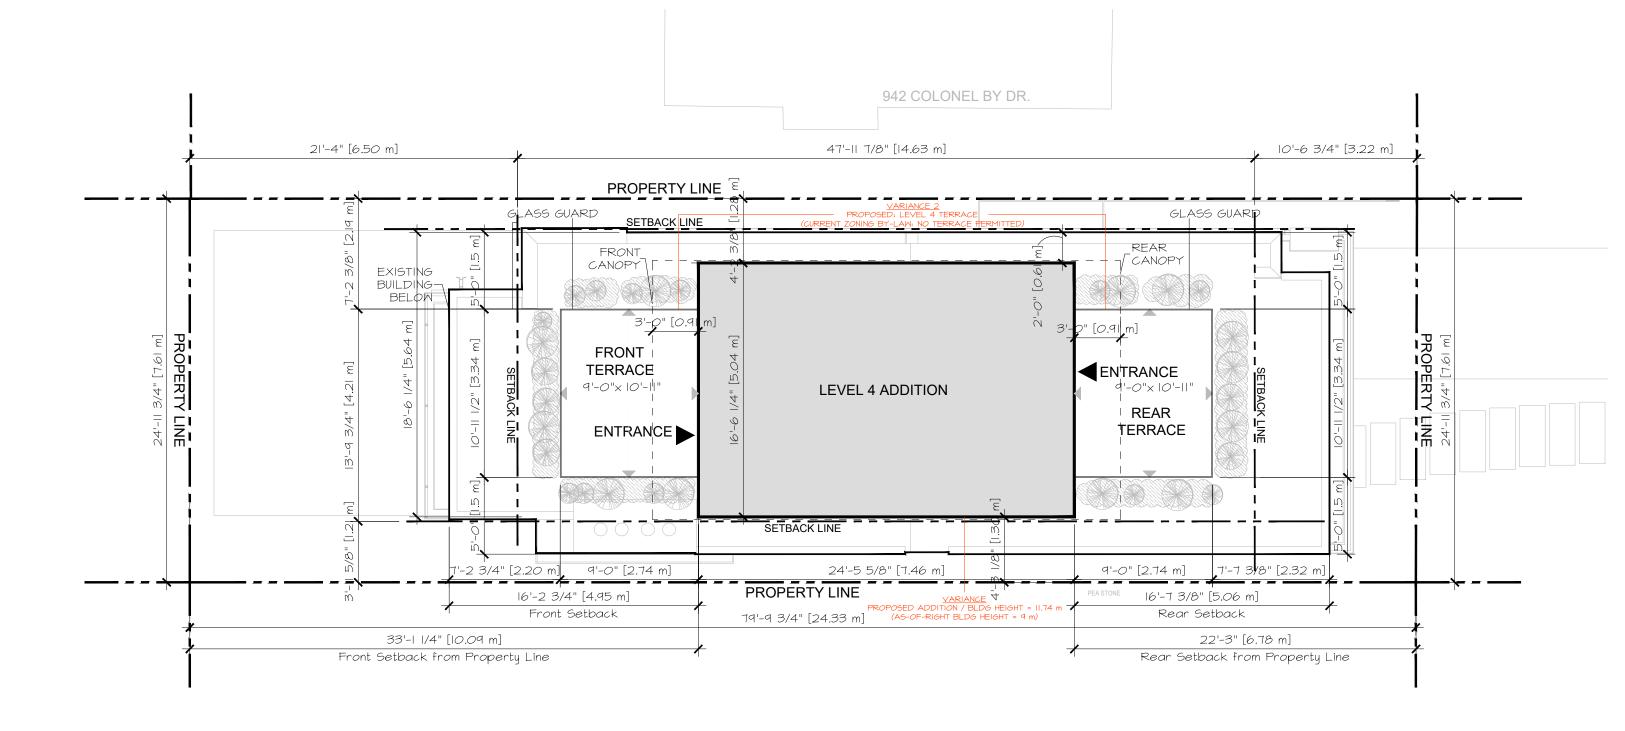

9 CARLYLE AVE.

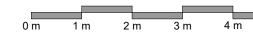


946 Colonel By Dr. New Addition - Level 4



Scale : 1:75 AUGUST 8, 2024




LEVEL 3 GFA:

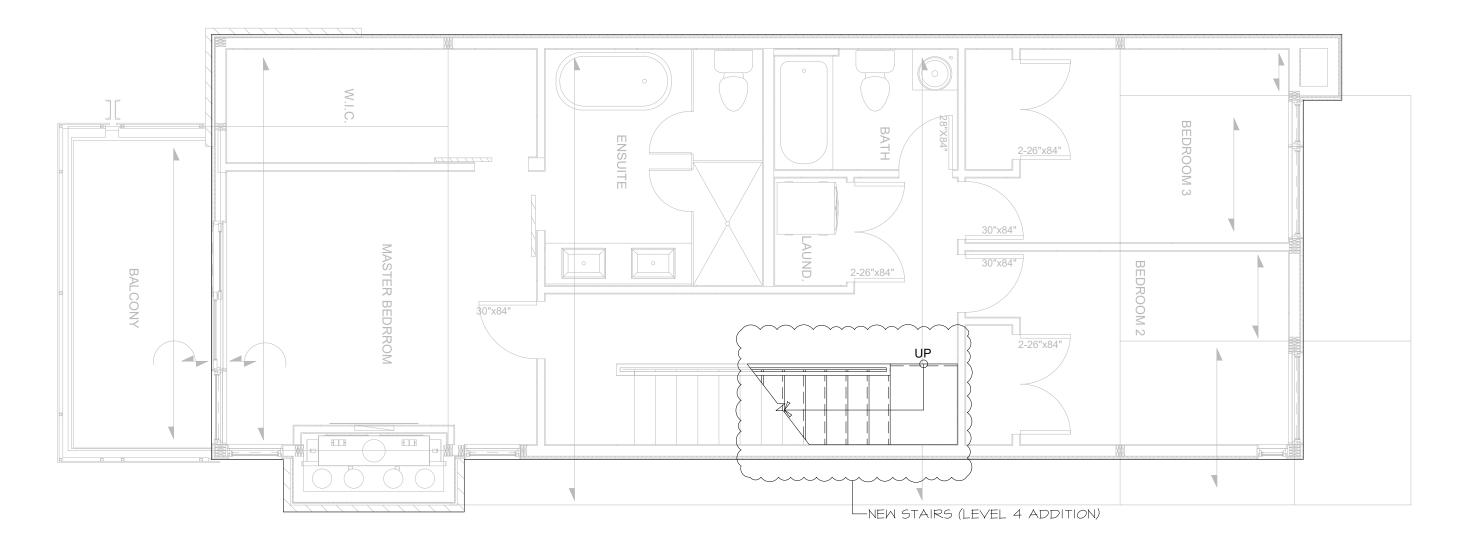




### 3 GFA: 897 ft² [83.32 m²]

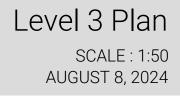



FRONT TERRACE GFA: **REAR TERRACE GFA:** 404 ft<sup>2</sup> [37.56 m<sup>2</sup>] LEVEL 4 ADDITION GFA:

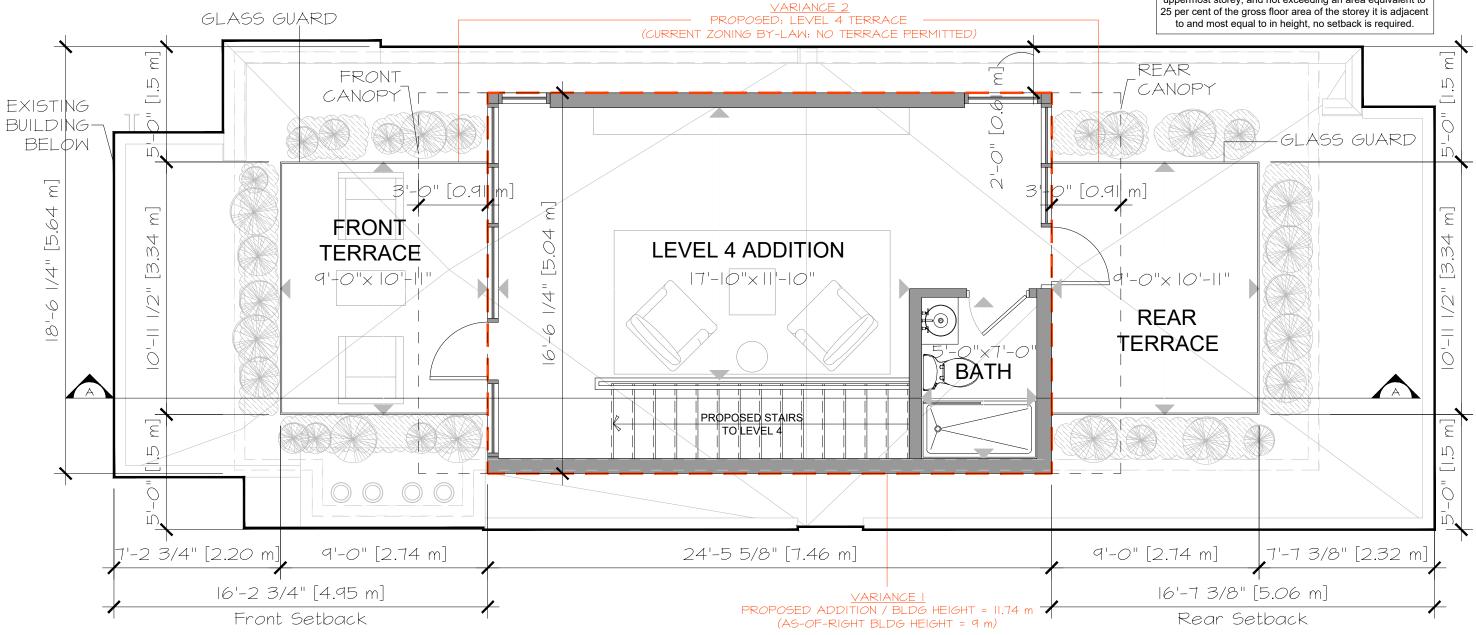




#### 99 ft<sup>2</sup> [ 9.52 m<sup>2</sup>] = < 25% OF LEVEL 4 GFA 99 ft² [11.50 m²] = < 25% OF LEVEL 4 GFA

Part 2 Section 55 Table 55 (8)(b): Where a roof-top terrace is not located on the roof of the uppermost storey, and not exceeding an area equivalent to

> Level 4 Plan SCALE : 1:50 AUGUST 8, 2024



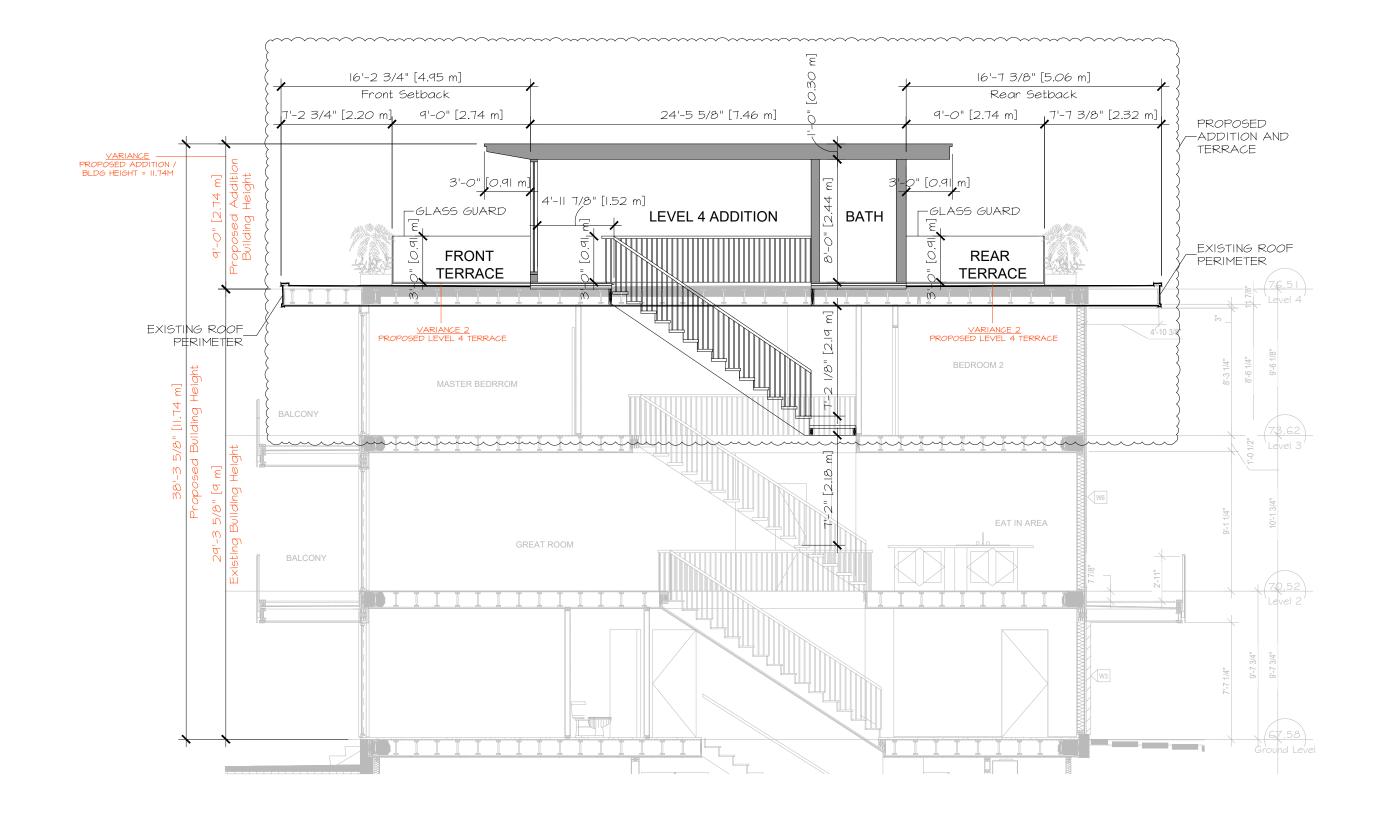



Section A - Proposed Stair Access to Level 4 Addition SCALE : 1:75 AUGUST 8, 2024





West Elevation SCALE : 1:75 AUGUST 8, 2024





### South Elevation SCALE : 1:75 AUGUST 8, 2024





East Elevation SCALE : 1:75 AUGUST 8, 2024





North Elevation SCALE : 1:75 AUGUST 8, 2024



HOBIN







## ELEVATION - North West, Colonel By Dr.



HOBIN







## ELEVATION - South East, Downing St.





# STREETVIEW - Downing St Looking West





# AERIAL VIEW - North East







# AERIAL VIEW - East








### AERIAL VIEW - South East

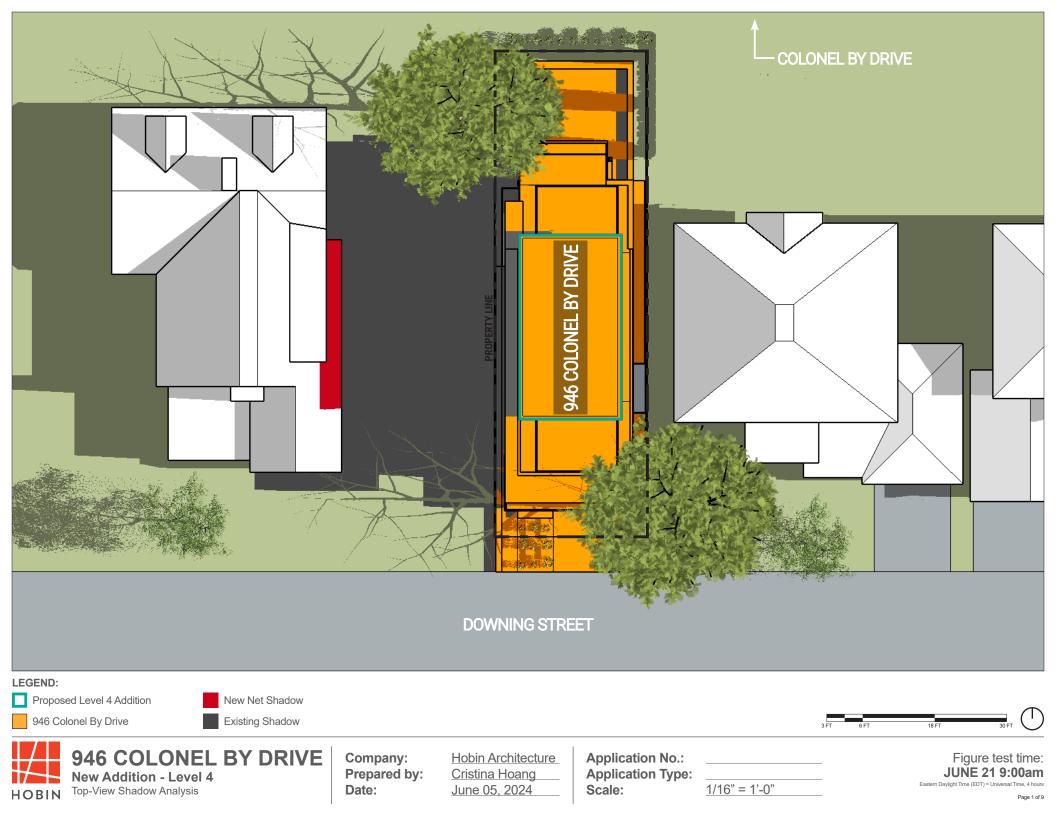


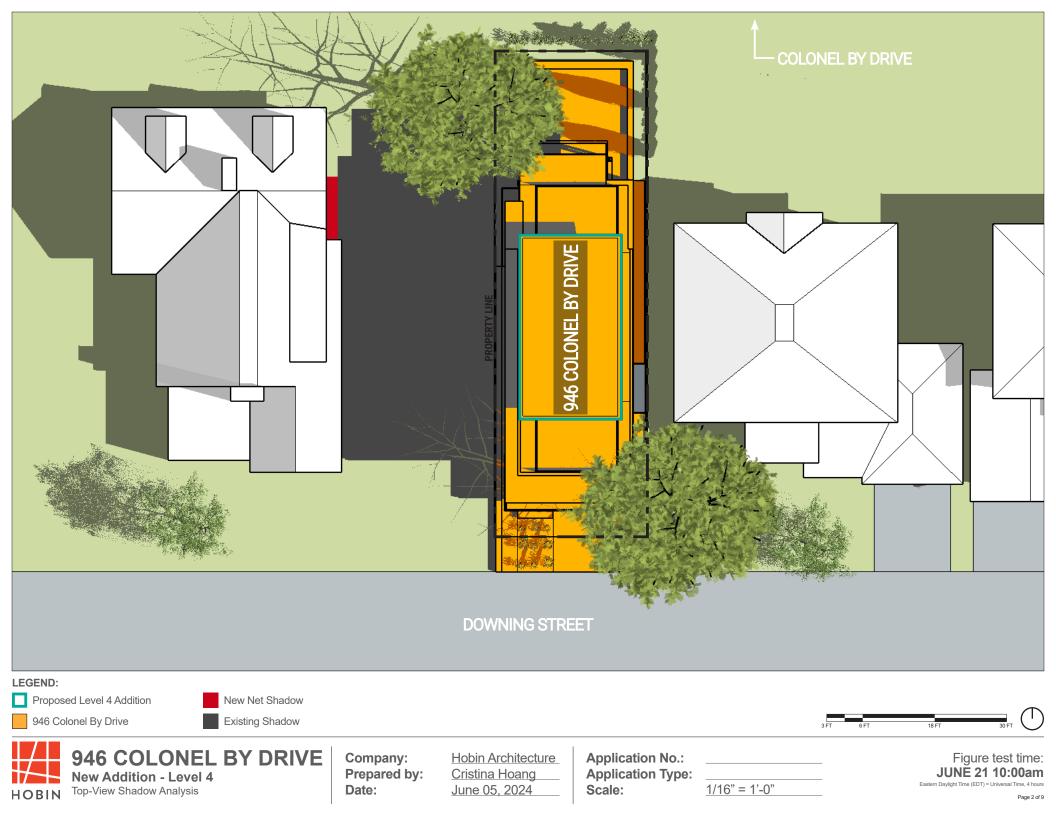


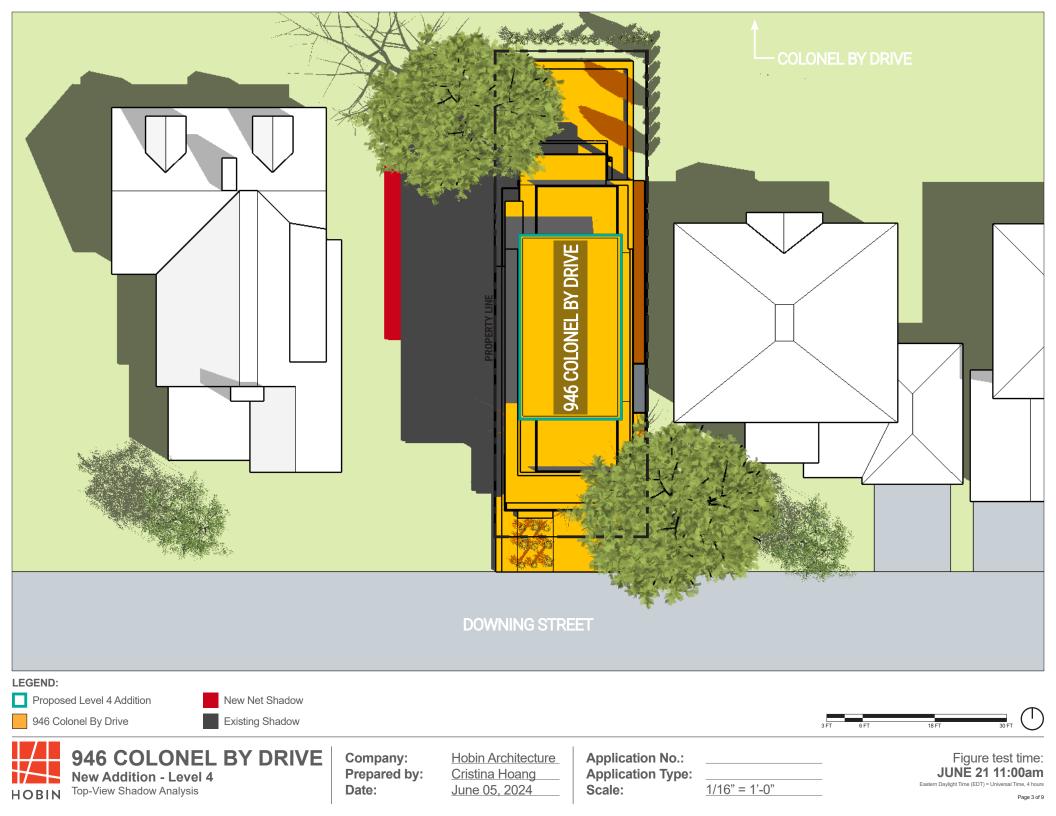


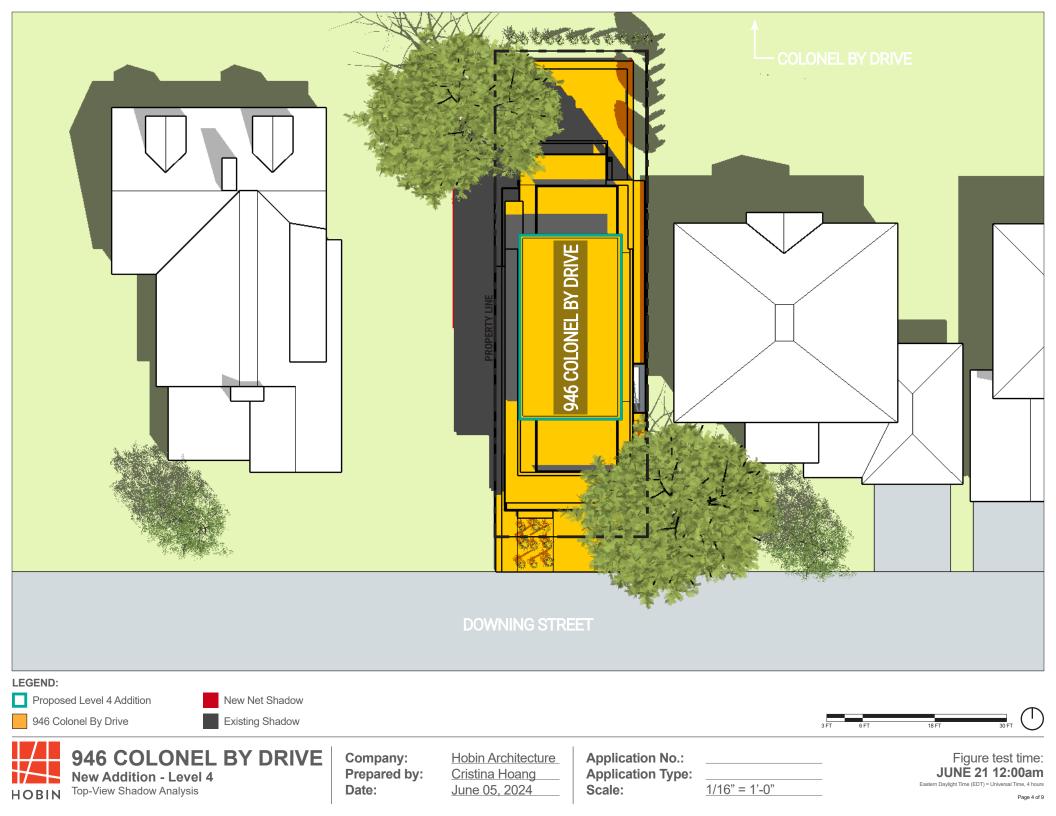


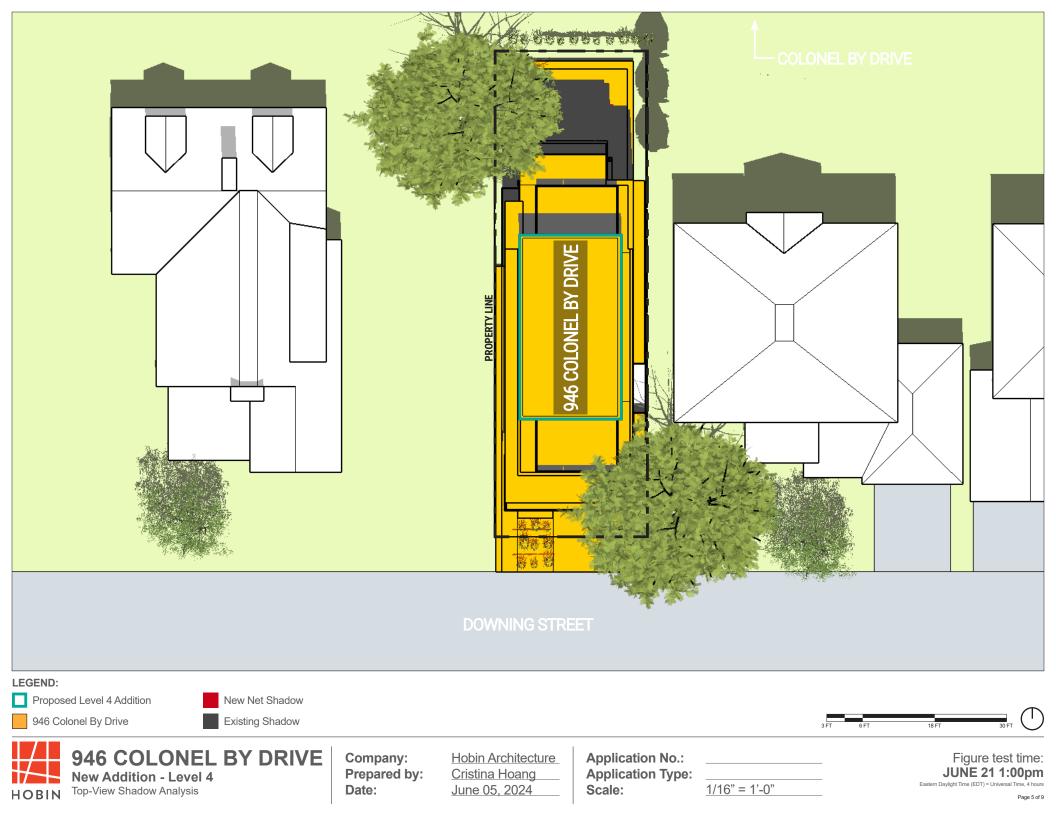


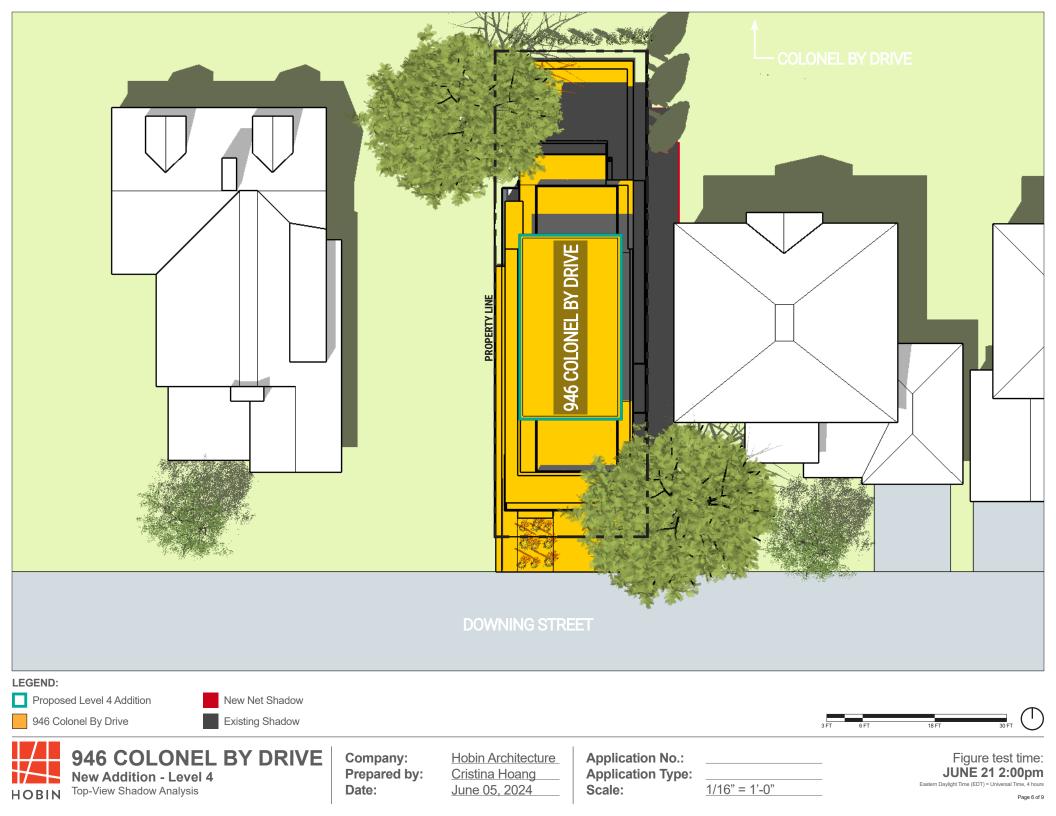

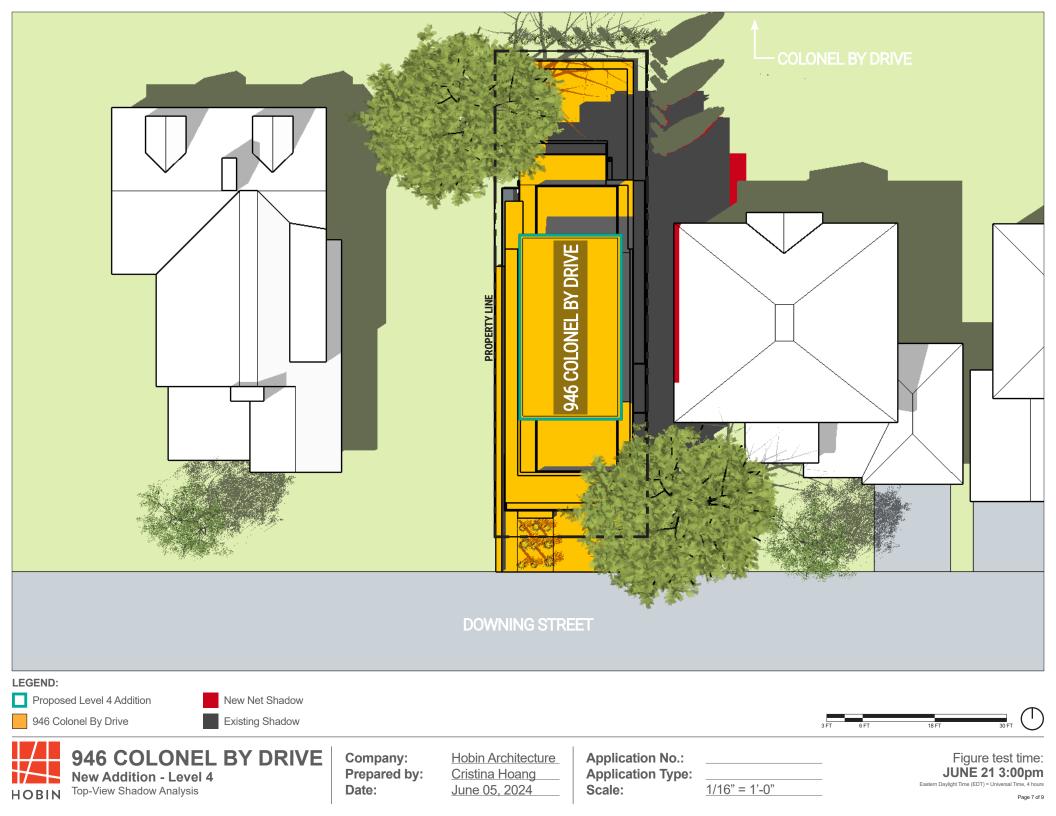

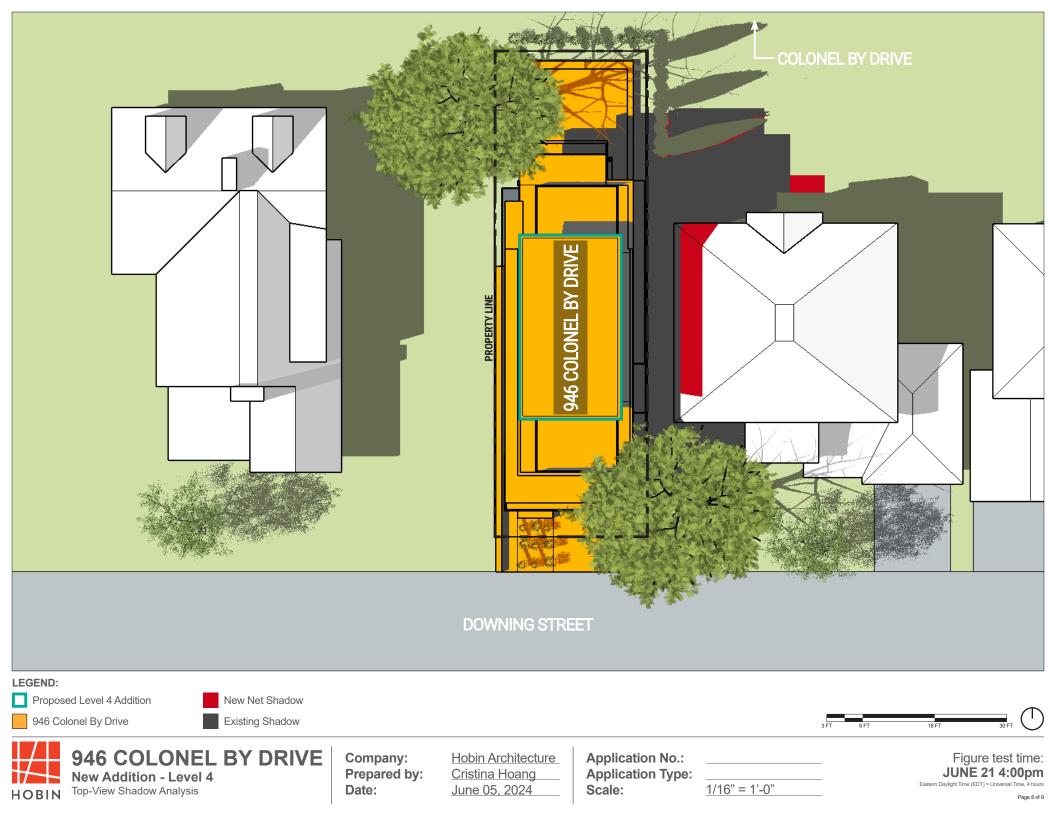

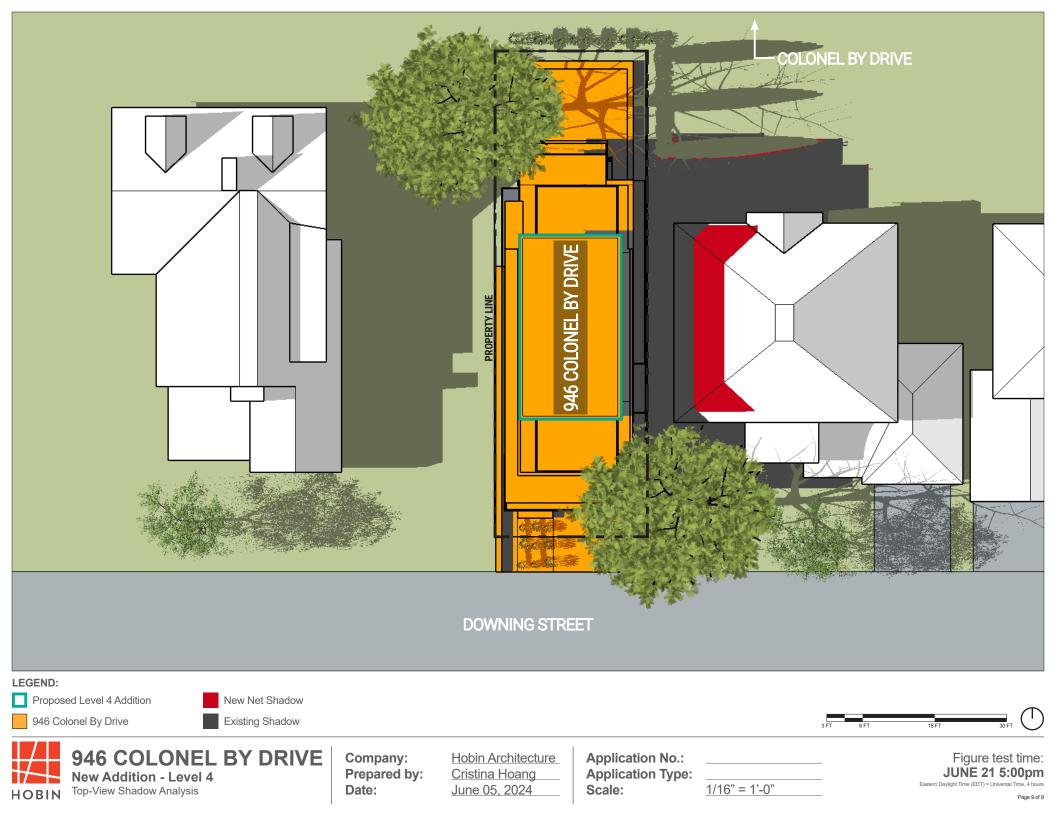

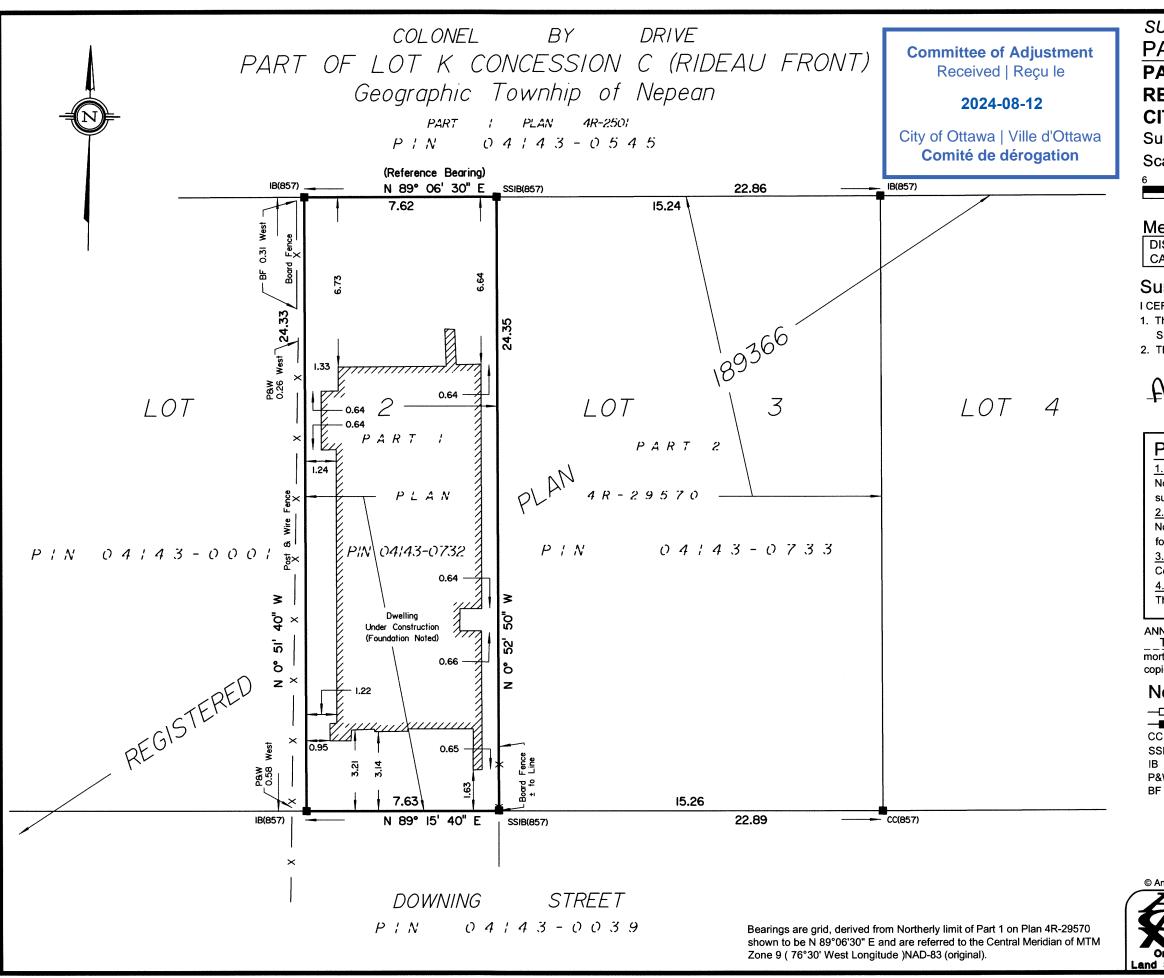

5597-16\Drawings\16597-16 TC United Ptt 2 Plan 189366 DUC D1.dwg, 17/08/20

IRVEYOR'S REAL PROPERTY	
ART Plan of	T_1  Plan of    OF LOT 2  STERED PLAN 189366    STERED PLAN 189366  STERED PLAN 189366    OF OTTAWA
ART OF LOT 2	
EGISTERED PLAN 189366	
• •	
4.5 3.0 1.5 0 3	6 Metres
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	with the Surveys Act
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Date Andre	Roy
Ontario La	nd Surveyor
subject property.	
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	indation walls.
NIS, O'SULLIVAN, VOLLEBEKK LTD, grants to	
	"), their solicitors,
pies of the Surveyor's Real Property Report in trans	actions involving The Client.
Notes & Legend	ASSOCIATION OF ONTARIO
-	
•	
•	1975303
SIB " Short Standard Iron Bar	
F " Board Fence	
	COPY ISSUED BY THE SURVEYOR
Ontario Priorie: (613) 727-08507 Fax: Email: Nepean@aovitd.c	
Surveyors Job No. 16597-16 TC United PtLt 2 Pla	

#### 1. <u>GENERAL</u>

1.1 USE BAR SCALE TO CONFIRM ACTUAL PLOT SCALE. 1.2 EXISTING AND NEW ELEVATIONS AND INVERTS SHOWN ARE GEODETIC AND ARE IN METERS.

1.3 EXISTING ELEVATIONS AND LOCATIONS, INVERTS AND SIZES OF EXISTING SERVICES ARE NOT NECESSARILY SHOWN ON PLAN AND THOSE SHOWN ARE DERIVED FROM AVAILABLE INFORMATION AND MUST BE CONFIRMED ON SITE BEFORE COMMENCING CONSTRUCTION. REPORT ANY DIFFERENCES TO

FNGINFFR. 1.4 SITE BOUNDARIES AND EXISTING GRADES AND OTHER FEATURES DERIVED FROM TOPOGRAPHIC SURVEY PREPARED BY FAIRHALL MOFFATT & WOODLAND LIMITED JOB NO. L60500.

1.5 REFER TO ARCHITECTURAL / LANDSCAPE SITE PLANS FOR EXACT LOCATIONS OF BUILDINGS, PAVED AREAS SIDEWALKS ETC. 1.6 REINSTATE ADJACENT PROPERTIES TO PRE-CONSTRUCTION CONDITIONS.

1.7 REINSTATE CITY PROPERTIES TO CITY STANDARDS AND TO CITY OF OTTAWA'S SATISFACTION. 1.8 ALL CITY PROPERTY, DAMAGED AS A RESULT OF THIS WORK, SHALL BE REINSTATED TO THE CITY'S SATISFACTION. 1.9 ALL RELEVANT WORK SHALL BE DONE IN ACCORDANCE WITH CURRENT CITY STANDARDS AND SPECIFICATIONS.

1.10 ONTARIO PROVINCIAL STANDARDS & SPECIFICATIONS WILL APPLY WHERE NO CITY STANDARDS ARE AVAILABLE. 1.11 ALL PROPOSED RETAINING WALLS SHALL BE SETBACK A MINIMUM 0.15m FROM PROPERTY LINE. ALL PROPOSED RETAINING WALLS GREATER THAN 1.0m IN HEIGHT SHALL BE DESIGN BY A PROFESSIONAL ENGINEER

2. EROSION AND SEDIMENT CONTROL

REGISTERED IN ONTARIO.

2.1 THE CONTRACTOR SHALL IMPLEMENT BEST MANAGEMENT PRACTICES TO PROVIDE FOR PROTECTION OF THE AREA DRAINAGE SYSTEM AND THE RECEIVING WATER COURSE DURING CONSTRUCTION ACTIVITIES. THIS INCLUDES LIMITING THE AMOUNT OF EXPOSED SOIL, USING FILTER CLOTH UNDER THE GRATE OF CATCH BASINS AND MANHOLES COVERS AND INSTALLING SILT FENCES AND OTHER EFFECTIVE SEDIMENT TRAPS. 2.2 PRIOR TO COMMENCEMENT OF CONSTRUCTION AT ALL MUNICIPAL CATCH BASINS ADJACENT TO THE SITE AND AT ANY MANHOLES OR CATCH BASINS HAT WILL RECEIVE DISCHARGE FROM DE-WATERING OPERATIONS AND ALL NEW CATCH BASINS AS THEY ARE INSTALLED: INSTALL SEDIMENT CAPTURE FILTER SOCK INSERTS (TERRAFIX GEOSYNTHETICS INC SILTSACK OR APPROVED EQUAL). INSPECT AT THE END OF EACH DAY AND AFTER EACH RAINFALL. REMOVE SEDIMENT AS RECOMMENDED BY THE MANUFACTURER. IMMEDIATELY REPAIR OR REPLACE ANY DAMAGED FILTER SOCK INSERTS. DO NOT REMOVE UNTIL CONSTRUCTION IS COMPLETE. 2.3 CONSTRUCTION IS CONSIDERED COMPLETE WHEN THE FOLLOWING CONDITIONS HAVE BEEN MET: a. ALL STRUCTURES HAVE BEEN BUILT.

b. ALL HARD SURFACES HAVE BEEN CONSTRUCTED. c. ALL PROPOSED GRASSED AREAS ARE EITHER SODDED OR HAVE A FULL COVERAGE OF WELL ESTABLISHED TURF AND HAVE HAD A MININMUM OF ONE FULL GROWING SEASON (MAY 15TH TO SEPTEMBER 15TH). d. THERE ARE NO AREAS OF EXPOSED EARTH. e. ALL STOCKPILED MATERIALS HAVE BEEN REMOVED. 2.4 REMOVE EROSION AND SEDIMENT CONTROL MEASURES WHEN CONSTRUCTION IS COMPLETE.

#### 3. <u>GRADING & DRAINAGE</u>

3.1 NEW GRADES TO MATCH EXISTING AT PROPERTY LINE. NO EXCESS DRAINAGE WILL BE DIRECTED TOWARDS THE NEIGHBOUR'S PROPERTY DURING AND AFTER CONSTRUCTION. THERE WILL BE NO ALTERATION TO EXISTING GRADE AND DRAINAGE PATTERNS ON PROPERTY LINE. 3.2 ALL AREAS SHALL BE GRADED TO ENSURE ADEQUATE DRAINAGE AWAY FROM BUILDINGS TO CATCH BASINS, SWALES, DITCHES AND OTHER APPROVED DISPOSAL AREAS. GRADES TO BE GRADUAL BETWEEN FINISHED SPOT ELEVATIONS SHOWN ON DRAWINGS TO PREVENT PONDING.

#### 4. <u>SITE SERVICES</u>

4.1 WATER METER SHALL BE INSTALLED AS PER CITY OF OTTAWA DWG. No. W30. ALL WATER SERVICE MATERIALS AND CONSTRUCTION METHODS TO CITY OF OTTAWA STANDARDS AND SPECIFICATIONS. 4.2 PROVIDE A MINIMUM 2.4 m COVER OVER NEW WATER SERVICE CONNECTION. WHERE THE MINIMUM COVER IS NOT POSSIBLE INSULATE AS PER CITY OF OTTAWA DWG. No. W22. PROVIDE A MINIMUM 300mm VERTICAL SEPARATION BETWEEN SEWERS AND WATER SERVICE CONNECTIONS AND BETWEEN WATERMAIN AND SEWER SERVICE CONNECTIONS. 4.3 CONNECTION TO WATERMAIN BY CITY OF OTTAWA, CONTRACTOR SHALL PROVIDE EXCAVATION, BACKFILL AND REINSTATEMENT. 4.4 WATER SEVICE CONNECTION SHALL BE COPPER ASTM B88 TYPE "K" SOFT. WATER SERVICE CONNECTIONS SHALL BE CONSTRUCTED OF A SINGLE

RUN OF PIPE WITH NO JOINTS OR FITTINGS BETWEEN THE STREET LINE OR SOURCE OF SUPPLY ON THE PROPERTY AND THE INSIDE FACE OF THE BUILDING 4.5 CONNECT PROPOSED SANITARY AND STORM SEWER SERVICE

CONNECTIONS TO EXISTING MUNICIPAL SEWERS USING A PRE-FABRICATED SADDLE CONNECTION. 4.6 SEWER MATERIAL SHALL BE PVC SDR-28 AND SHALL CONFORM TO CSA B182.2 AND SHALL HAVE BELL AND SPIGOT JOINTS WITH RUBBER GASKETS.

4.7 BEDDING AND SURROUND MATERIAL FOR SEWERS SHALL BE OPSS GRANULAR A. BEDDING AND SURROUND MATERIAL FOR WATERMAIN AND WATER SERVICE CONNECTIONS SHALL BE OPSS GRANULAR A OR OPSS GRANULAR M. RE-CYLCLED GRANULAR MATERIALS ARE NOT PERMITTED. 4.8 THE SANITARY BUILDING DRAIN SHALL BE INSTALLED WITH A FULL-PORT BACKWATER VALVE TO CITY OF OTTAWA STANDARDS AND TO CITY OF OTTAWA

DWG. NO. S14.1. 4.9 THE STORM BUILDING DRAIN SHALL BE INSTALLED WITH A BACKWATER VALVE TO CITY OF OTTAWA STANDARDS AND TO CITY OF OTTAWA DWG. NO. S14.

4.10 TRENCH DRAIN AND AREA DRAIN SUMP & PUMP:

SUBMERSIBLE EFFLUENT PUMP WITH AN IMPELLER CAPABLE OF HANDLING 3/4 INCH (19mm) SOLIDS COMPLETE WITH ON/OFF FLOAT CONTROLS; 30 USgpm @ 23 FEET HEAD (115 L/MIN @ 7.0m); F. E. MYERS ME3F 1/3 HP OR EQUAL. SUMP SHALL BE A MINIMUM 600mm IN DIAMETER AND A MINIMUM 600mm DEEP. ANCHOR SUMP TO PREVENT UPLIFT FROM HYDROSTATIC PRESSURES. PROVIDE A HIGH WATER ALARM. DISCHARGE PIPE SHALL BE SELF-DRAINING. DISCHARGE OUTSIDE ONTO A CONCRETE SPLASH PAD

4.11 FOUNDATION DRAIN SUMP & PUMP: SUBMERSIBLE SUMP PUMP WITH AN IMPELLER CAPABLE OF HANDLING 1/2 INCH (12mm) SOLIDS COMPLETE WITH ON/OFF & ALARM FLOAT CONTROLS; 20 USgpm @ 18 FEET HEAD (77 L/MIN @ 5.5m); F. E. MYERS MDC33 1/3 HP OR EQUAL. SUMP SHALL BE A MINIMUM 600mm IN DIAMETER AND A MINIMUM 600mm DEEP. ANCHOR SUMP TO PREVENT UPLIFT FROM HYDROSTATIC PRESSURES. PROVIDE A HIGH WATER ALARM. DISCHARGE PIPE SHALL BE SELF-DRAINING. DISCHARGE OUTSIDE ONTO A CONCRETE SPLASH PAD.

#### 5. <u>CONSTRUCTION:</u>

5.1 PRIOR TO COMMENCING WORK: a. OBTAIN AND PAY FOR ALL NECESSARY PERMITS AND APPROVALS

FROM THE AUTHORITIES. b. SIZE, DEPTH AND LOCATION OF EXISTING UTILITIES AND STRUCTURES AS INDICATED ARE FOR GUIDANCE ONLY. EXISTING UTILITIES AND STRUCTURES ARE NOT NECESSARILY SHOWN ON PLANS. COMPLETENESS AND ACCURACY ARE NOT GUARANTEED. NOTIFY ALL APPLICABLE OWNERS UTILITY COMPANIES AND AUTHORITIES HAVING JURISDICTION OF PROPOSED WORK AND LOCATE AND CLEARLY IDENTIFY ALL EXISTING SERVICES, UTILITIES AND STRUCTURES ON AND ADJACENT TO SITE. CONFIRM LOCATIONS OF BURIED SERVICES AND UTILITIES BY CAREFUL TEST EXCAVATIONS AND REPORT ANY DIFFERENCES TO THE ENGINEER. c. COORDINATE AND SCHEDULE WORK WITH THE AUTHORITIES AND

OTHER TRADES. 5.2 MAINTAIN AND PROTECT FROM DAMAGE, SERVICES, UTILITIES AND STRUCTURES ENCOUNTERED.

5.3 PROTECT EXISTING BUILDINGS, TREES AND OTHER PLANTS, LAWNS, FENCING, SERVICE POLES, WIRES, PAVEMENT, SURVEY BENCH MARKS AND MONUMENTS AND OTHER SURFACE FEATURES FROM DAMAGE WHILE WORK IS IN PROGRESS. DO NOT DISTURB SOIL WITHIN BRANCH SPREAD OF TREES

OR SHRUBS THAT ARE TO REMAIN. 5.4 PROVIDE TRAFFIC CONTROL AND SAFETY MEASURES INCLUDING ANY NECESSARY PERSONEL AND THE SUPPLY, INSTALLATION AND REMOVAL OF ALL NECESSARY SIGNAGE AND BARRIERS

5.5 SHORE AND BRACE EXCAVATIONS, PROTECT SLOPES AND BANKS AND PERFORM ALL WORK IN ACCORDANCE WITH OCCUPATIONAL HEALTH AND SAFETY ACT AND OTHER AUTHORITIES HAVING JURISDICTION. 5.6 CUT PAVEMENT AND / OR SIDEWALK NEATLY ALONG LIMITS OF

PROPOSED EXCAVATION IN ORDER THAT SURFACE MAY BREAK EVENLY AND CLEANLY. 5.7 MAINTAIN RECORD DRAWINGS AND RECORD ACCURATELY DEVIATIONS FROM THE ORIGINAL CONTRACT DOCUMENTS CAUSED BY SITE CONDITIONS AND CHANGES MADE BY CHANGE ORDER OR ADDITIONAL INSTRUCTION.

RECORD DRAWINGS SHALL INCLUDE BUT NOT NECESSARILY LIMITED TO CHANGES OF DIMENSION AND DETAIL; AND HORIZONTAL AND VERTICAL LOCATIONS OF UNDERGROUND UTILITIES AND APPURTENANCES REFERENCED TO A PERMANENT SURFACE STRUCTURE. 5.8 REINSTATE PAVEMENTS AND SIDEWALKS DISTURBED BY EXCAVATION TO

THICKNESS, STRUCTURE AND ELEVATION WHICH EXISTED BEFORE EXCAVATION. 5.9 CLEAN AND REINSTATE AREAS AFFECTED BY THE WORK.

