

Committee of Adjustment Received | Reçu le

2024-05-21

City of Ottawa | Ville d'Ottawa Comité de dérogation

	DESIGN A DRAFTI BAEUMLER APPROVED	NG				
	 DO NOT SCALE DRAWINGS. ALL DIMENSIONS TO BE CHECKED AND VERIFIED. DESIGN IS IN ACCORDANCE WITH LOCAL BYLAWS AND the 2012 ONTARIO BUILDING CODE. ALL FABRICATIONS AND ERECTION SHALL BE IN ACCORDANCE WITH LOCAL BYLAWS AND the 2012 ONTARIO BUILDING CODE. HOMEOWNER WILL TAKE NECESSARY PRECAUTIONS TO REMOVE OR RELOCATE ITEMS OF VALUE TO BE REUSED AND/ OR SAVED, OR IN ANY DANGER OF BEING DAMAGED DUE TO CONSTRUCTION PROCESS. TO THE BEST OF MY KNOWLEDGE THESE PLANS ARE DRAWN TO COMPLY WITH OWNER'S AND/ OR BUILDER'S SPECIFICATIONS AND ANY CHANGES MADE ON THEM AFTER PRINTS ARE MADE AT THE OWNER'S AND/ OR CONTRACTOR'S EXPENSE AND RESPONSIBILITY. THE CONTRACTOR SHALL VERIFY ALL DIMENSIONS AND CONDITIONS AT THE JOB SITE AND NOTIFY THE DESIGNER/ ARCHITECT OF ANY DIMENSIONAL ERRORS, OMISSIONS OR DISCREPANCIES BEFORE BEGINNING OR FABRICATING ANY WORK. DISCLAIMER NOTE: DUSTING NORE TO BUILD THIS BUILDING). NONE OF THESE MATERIALS OR ANY OTHER TYPE OF MATERIALS, WINDOWS & DOORS MATERIALS OR ANY OTHER TYPE OF MATERIALS, WINDOWS & DOORS MATERIALS OR ANY OTHER TYPE OF MATERIALS IN ORDER TO BUILD THIS BUILDING). NONE OF THESE MATERIALS SHOULD BE PURCHASED UNTIL THE PERMIT PLANS HAS BEEN APPROVED BY THE CLTY. THE OWNER(S) ANDOR CONTRACTORS DE THECHTY. 					
	Dustin Poole BCIN# 37560 FIRM# 100988 Duff. I with 613-795-2860 QUALIFICATION INFO: SMALL BUILDINGS The undersigned has reviewed and takes responsibility for this design, a has the qualifications and meets the requirements set out in the Ontario Building Code to be a designer.	and 2				
I PLAN PLAN	01 ISSUED FOR BUILDING PERMIT # DESCRIPTION	23/08/01 YY/MM/DD				
LAN	PROJECT 150 BILLINGS AVENUI RESIDENTIAL DRAWING PERSPECTIVES TYPE SCALE					
	ADDITION NTS DESIGNED BY DRAWN BY DATE AUG 01, 2023 OF JENT. # P(G'S IN SETI				

OF [ENT. # PG'S IN SET]



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SPECIFICATIONS 1 GENERAL

-PROTECT ALL WORK FROM DAMAGE. KEEP ALL MATERIALS SECURE. ERECT ALL HOARDING, FENCING, BARRIERS, SCAFFOLDING, AND SIGNAGE AS REQUIRED. -WORKMANSHIP SHALL BE TO THE BEST STANDARD FOR FACH RESPECTIVE TRADE. ERECT ALL WORK ACCURATELY, SQUARE, SECURE, PLUMB, STRAIGHT. TRUE AND TO ACCEPTED TOLERANCES.

-PROVIDE AND COMPLY WITH MANUFACTURER'S PRINTED INSTRUCTIONS. CARRY TO THERMAL & ACOUSTICAL INSULATION ON WORK ONLY IN WEATHER, TEMPERATURE OR ENVIRONMENTAL CONDITIONS ACCEPTABLE TO INDUSTRY STANDARDS.

-MAKE GOOD ALL EXISTING CONDITIONS AS REQUIRED FOR A COMPLETE JOB. CLEAN ALL WORK AND WORK AREAS ON AN ONGOING BASIS -WHERE FILLING AND PATCHING IS REQUIRED TO MAKE GOOD SUBSTRATE

MATERIALS. THIS WORK MUST BE AT LEAST THE SAME QUALITY AS EXISTING AND MUST PROVIDE A FULLY ACCEPTABLE BACKING FOR OVERLAYING FINISHES. -WHERE EXISTING FINISHES ARE EXTENDED OR PATCHED, THE EXISTING FINISHES SHALL BE CUT BACK OR REMOVED AS REQUIRED SO THAT THE JUNCTION BETWEEN NEW AND EXISTING WORK IS NOT APPARENT. -CO-ORDINATE WITH THE PROJECT MANAGER FOR ALL REQUIREMENTS FOR

TEMPORARY SERVICES AND FACILITIES. -ALL NEW OR RELOCATED WORK SHALL MATCH ALL EXISTING WORK IN ALL

RESPECTS INCLUDING QUALITY, MATERIALS, DETAILS, FINISHES, COLOURS, ETC. -CONTRACTORS ARE TO ENSURE THAT THE CONSTRUCTION IS NOT TO INTERFERE WITH THE NORMAL OPERATION OF THE BUILDING -TAKE PROPER CARE TO AVOID UNNECESSARY NOISE. ADVISE THE PROJECT

MANAGER OF TIME AND MAKE SUITABLE ARRANGEMENTS WHEN EXCESSIVE NOISE OR OBSTRUCTION IS UNAVOIDABLE. GENERAL NOTES:

- ANY CABINETRY FURNITURE AND FOUIPMENT SHOWN IS FOR GUIDANCE ONLY THE CLIENT/ CONTRACTOR SHALL PROVIDE ALL CABINETRY, FURNITURE AND EQUIPMENT AND ITS FINAL LAYOUT.

- 1 CO-ORDINATE THE LOCATION AND REQUIREMENTS OF ALL MECHANICAL & ELECTRICAL ITEMS WITH THE CLIENT / CONTRACTOR, SUCH AS SINKS, PLUMBING, DRAINS, VENTS, FANS, TELEPHONE, DATA LINES, RECEPTACLES, SWITCHES, SECURITY SYSTEMS, TELEVISIONS, COMPUTERS, ETC.
- 2 REPAIR ALL HOLES, ROUGH AREAS, ETC. OF ALL EXISTING GYP. WALLS.
- 3 PAINT AS SELECTED BY CLIENT / CONTRACTOR. PAINT ALL EXPOSED DRYWALL, WOOD DOORS & STEEL FRAMES - ALL SIDES & EDGES
- 4 CERAMIC TILE (CT) AND CT BASEBOARDS AS SELECTED BY THE CLIENT / CONTRACTOR
- 5 ENSURE BUILDING ENVELOPE CONTINUITY FROM EXISTING TO NEW CONSTRUCTION
- 6 ATTIC HATCH MIN SIZE 21 5/8""x35" EXCEPT THAT WHERE THE HATCH SERVERS HARDWARE SCHEDULE FOR PROJECT MANAGER APPROVAL. PROVIDE KEY A SINGLE DWELLING UNIT, THE HATCH MAY BE REDUCED TO 3.4FT2 IN AREA WITH NO DIMENSION LESS THAN 21 1/2" & SHALL BE LOCATED WITH UNOBSTRUCTED ACCESS AS PER OBC 9 19 2 1 (2)
- 7 ALL PRE-ENGINEERED JOISTS SHOP DWG'S WILL BE SUBMITTED TO BUILDING INSPECTOR UPON INSPECTION
- 8 WINDOWS ARE NUMBERED AND SIZES ARE NOTED ON PLAN DRAWINGS. 9 EXTERIOR AND INTERIOR DOORS ARE NUMBERED AND SIZES ARE NOTED ON
- PLAN DRAWINGS.

1 DEMOLITION/REPAIRS/SITEWORK

-LEGALLY DISPOSE OFF-SITE ALL ITEMS REQUIRING REMOVAL

- DO NOT COVER-UP ANY WORK UNTIL PROPERLY INSPECTED BY THE PERTINENT CONSULTANT AND/OR AUTHORITY. -REPAIR ANY FLOORS, WALLS, CEILINGS, ETC. LEFT ROUGH OR DAMAGED BY DEMOLITION. NEW FINISHES TO BE FLUSH AND SMOOTH UNLESS NOTED

OTHERWISE -INSPECT ALL INTERIOR FLOORS, BASES, WALLS AND CEILING AND REPAIR ANY DEFECTS OR DAMAGE. ENSURE ALL SURFACES ARE SMOOTH, FREE FROM

PROTRUSIONS, LEVEL, PLUMB, ETC. -EXISTING DOORS HARDWARE FURNITURE FOUIPMENT MECHANICAL 8 ELECTRICAL FIXTURES ETC. REMAIN THE PROPERTY OF THE CLIENT. CO-ORDINATE WITH THE PROJECT MANAGER ON THE DISPOSITION OF SAID

OBJECTS

-CO-ORDINATE ALL STRUCTURAL, MECHANICAL & ELECTRICAL REQUIREMENTS. PIPING, VENTS, DUCTS, WIRING, ETC. CO-ORDINATE ALL ROUTES WITH THE PROJECT MANAGER. MAKE GOOD ALL BUILDING ELEMENTS.

3. CONCRETE - N/A

4. MASONRY - MASONRY VENEER TIES ARE REQUIRED TO HAVE A MAXIMUM VERTICAL

SPACING CONFORMING TO OBC TABLE 9.20.9.5. - FLASHING ON MASONRY WALLS MUST BE INSTALLED BENEATH JOINTED MASONRY SILLS, OVER THE BACK AND TOP OF PARAPET WALLS, OVER THE HEADS OF GLASS BLOCK PANELS, BENEATH WEEP HOLES, AND OVER THE HEADS OF DOORS AND WINDOWS IF THE DISTANCE BETWEEN THE TOP OF THE OPENING AND THE BOTTOM OF THE EAVE EXCEEDS 1/4 OF THE EAVE OVERHANG (OBC 9.20.13.3.)

- THROUGH WALL FLASHING SHALL BE PROVIDED IN MASONRY VENEER WALLS IN SUCH THAT ANY MOISTURE THAT ACCUMULATES IN THE AIR SPACE WILL BE DIRECTED TO THE EXTERIOR OF THE BUILDING (OBC 9.20.13.3.(2)) - WEEP HOLES MUST NOT BE SPACED MORE THAN 2'7" APART AND BE PROVIDED

AT THE BOTTOM OF EVERY MASONRY VENEER CAVITY (OBC 9.20.13.8) 5. METALS - N/A

6. CARPENTRY

-SUPPLY & INSTALL ROUGH AND FINISHED CARPENTRY AS REQUIRED FOR A COMPLETE PROJECT, INCLUDING ALL FRAMING, PLYWOOD, SHEATHING, SETTING OF ROUGH BUCKS, CANTS, CURBS, SLEEPERS, VAPOUR BARRIER, HATCHWAYS, STRAPPING, FURRING, METER EQUIPMENT BOARDS, DOORS AND TRIM, HARDWARE FLASHING INSULATION CABINETRY & MILLWORK ETC. INSTALL NAILS, SCREWS, BOLTS AND SUNDRY ANCHORS AS REQUIRED FOR SOUND CONSTRUCTION. USE APPROVED NON-CORROSIVE FASTENERS WHEREVER THERE IS THE POSSIBILITY OF STAINING OR CORROSION. EXAMINE THE DRAWINGS TO DETERMINE THE TOTAL SCOPE OF THIS WORK -ALL FINISHED ITEMS TO THE PROJECT MANAGER'S SELECTION FOR:

CABINETS, COUNTERS, SHELVING, RECEPTION DESK, ETC. PLASTIC LAMINATES

- DOOR & CABINET HARDWARE
- PROVIDE SHOP DRAWINGS OF ALL ITEMS FOR REVIEW.

- ALL WOOD IN CONTACT WITH CONCRETE THAT IS NOT PRESSURED TREATED IS REQUIRED TO BE SEPARATED BY AT LEAST 0.002IN POLYETHYLENE FILM OR TYPE S ROLL ROOFING

- ALL WOOD WITHIN 5 7/8" OF GRADE SHALL BE TREATED FOR DECAY (TYPICAL) - ALL LINTELS TO HAVE MIN 1 1/2" END BEARING.

-ALL BEAMS TO HAVE MIN 3 1/2" END BEARING

-WHERE BRIDGING AND STRAPPING ARE SPECIFIED. MAX SPACING BETWEEN EACH SUPPORT SHALL BE 6'10" AND SHALL COMPLY WITH OBC 9.12.9.4 7. THERMAL AND MOISTURE PROTECTION

ROOFING - N/A 2 INSULATION -

-INSULATE WHERE INDICATED ON OR REASONABLY INFERABLE FROM THE DRAWINGS AS NECESSARY FOR A COMPLETE JOB, INCLUDING BUT NOT LIMITED

-ALL WALLS ABOVE GRADE TO BE MIN. R-24 (UNLESS NOTED OTHERWISE) -ALL WALLS BELOW GRADE TO BE MIN R-20 (UNLESS NOTED OTHERWISE)

-ALL CEILING CAVITIES WITH ATTIC SPACES TO BE MIN R-50

-ALL EXPOSED FLOORS AND/OR CEILING AREAS WITH ATTIC SPACES TO BE MIN R-31 (UNLESS NOTED OTHERWISE)

- USE INSULATION BAFFLES IN ATTIC TO PREVENT BLOCKED AIR FLOW 3. CAULKING & SEALING

-CAULK AND SEAL TO ENSURE A COMPLETE WEATHER AND WATERTIGHT PROJECT, INCLUDING AROUND ALL EXTERIOR DOOR AND WINDOW FRAMES, LOUVERS, VENTS, THRESHOLDS, ETC., AND BETWEEN DIFFERENT EXTERIOR MATERIALS. PACK SPACES DEEPER THAN 13 mm (1/2") AND WIDER THAN 6 mm (1/4") WITH CLOSED-CELL POLYETHYLENE ROD FILLER.

-SUPPLY AND INSTALL INTERIOR SEALANTS, WASHROOM SEALANTS AND ACOUSTICAL SEALANTS AS DETAILED AND AS REQUIRED FOR A COMPLETE JOB. -CAULK AROUND ALL BATHTUBS, SINKS, AND JUNCTIONS WITH OTHER MATERIALS OF ALL KITCHEN & BATHROOM COUNTERS AND VANITIES -CAULK PERIMETERS, BOTH SIDES OF ALL FIRE-RATED PARTITIONS.

-PRODUCTS: 1. EXTERIOR SEALANT: TWO PART POLYTREMCLYNE TERPOLYMER. EQUAL TO

'DYMERIC' BY TREMCO CANADA LTD. OR DOW CORNING 790 SILICONE BUILDING SEALANT

2. WASHROOM SEALANT: FUNGUS AND MILDEW RESISTANT SILICONE BATHTUB CAULK. 'TREMSIL 600' BY TREMCO. OR DOW CORNING 786. 3. INTERIOR SEALANTS EQUAL TO 'ACRYLIC LATEX CAULK' BY TREMCO CANADA

4. ACOUSTIC CAULKING EQUAL TO 'ACOUSTICAL SEALANT' BY TREMCO

CANADA LTD. 5. BEDDING MATERIAL: 'ETHAFOAM' CLOSED-CELL POLYETHYLENE ROPE, SIZED

TO ALLOW 25% (MIN) COMPRESSION WHEN INSERTED IN JOINT. 6. PRIMERS: AS RECOMMENDED BY THE SEALING MANUFACTURERS 7. COLOURS: TO MATCH ADJACENT MATERIALS AND TO ARCHITECTS APPROVAL.

8. DOORS AND WINDOWS -SUPPLY AND INSTALL ALL DOORS & WINDOWS AS SHOWN ON THE DRAWINGS.

-SUPPLY ALL HARDWARE AS REQUIRED FOR A COMPLETE JOB. SUBMIT SYSTEMS & KEYS AS REQUIRED BY PROJECT MANAGER.

- WINDOWS AND SLIDING GLASS DOORS SHALL CONFORM TO CAN/CSA A440-2 (OBC 12 3 1 2)

- THERMAL RÉSISTANCE OF WINDOWS SHALL CONFORM TO SB-12 (OBC 12.2.1.1

-THERMAL RESISTANCE OF DOORS SHALL CONFORM TO SB-12 (OBC 12.2.1.1.(3)) - WINDOWS TO COMPLY WITH SECTION SB-12 OF THE OBC FOR THERMAL RESISTANCE BY USING A MINIMAL LOW E, DOUBLE GLAZING. MAX U-VALUE OF 1.8 AS PER OBC SB-12 TABLE 2.1.1.10

- WHEN REQUIRED, WINDOW WELL WIDTH MIN 21 5/8" (OBC 9.9.10.1) - DRAIN WINDOW WELL IN ACCORDANCE TO 9.14.6.3

- OBC 9.7.5.2 PROVIDE EXT. DOORS WITH HINGES OR PINS SO THAT THE DOOR CANNOT BE REMOVED WHEN THEY ARE IN THE CLOSED POSITION - ENSURE UNOBSTRUCTED EXTERIOR DOOR OPENING OF MIN 30"X78" C/W

WEATHER STRIPPING - THE GLASS IN INTERIOR & EXTERIOR DOORS TO CONFORM TO 9.6.1.3 9. FINISHES

-PROVIDE UNDERLAYS SUBSTRATES ADHESIVES GROUT ETC. AS

RECOMMENDED BY THE RESPECTIVE MANUFACTURERS -ALL FINISHES AS SELECTED BY THE PROJECT MANAGER. INSTALLATION TO COMPLY WITH DIVISION 1 HEREIN

-TAPE AND FILL JOINTS IN GYPSUM WALL BOARD (GWB), WITH 3 COATS APPROVED JOINT COMPOUND. SAND IN ACCORDANCE WITH QUALITY CONTROL STANDARDS ESTABLISHED ON SITE

-PARTITIONING TO INCLUDE ALL INSULATION, CAULKING, ETC. AS SHOWN. -ALL PAINTING ONE PRIMER COAT AND TWO FINISH COATS. PAINT BRAND AS APPROVED BY THE PROJECT MANAGER ALL DOORS FRAMES TRIM CASINGS BASEBOARD SEMI-GLOSS; ALL OTHER PAINT FLAT. ACCEPTABLE PRODUCTS AS PER ONTARIO PAINTING CONTRACTORS' ASSOCIATION MANUAL, CHAPTER 5. 10. SPECIALTIES --N/A

11 STAIRS

- STAIR DIMENSIONS AS PER OBC 9.8.2.1 AND 9.8.4. - MAX, RISE 7-7/8" MIN, 4-7/8"

- MAX RUN 14" MIN 8-1/4"

- MIN. STAIR HEADROOM CLEARANCE 6'-5" (OBC 9.8.2.2.)

- STRINGERS MIN 2"X10" SPACED MAX 2'-11" APART.

GUARDRAIL CONSTRUCTION SHALL COMPLY WITH O.B.C. 9.8.8.2. AND SB-7 WHERE DIFFERENCE IN ELEVATION FROM TOP OF WALKING SURFACES TO GRADE EXCEEDS 23 5/8" A GUARDRAIL SHALL BE PROVIDED IN ACCORDANCE TO 9.8.8 AND SB-7

- HANDRAIL HEIGHT 32"AT STAIRS 36" AT LANDING

SPINDLES TO HAVE NO MORE THAN 4" SPACE BETWEEN EACH PICKET WHEN LISED AS GUARDS

- LANDING AS PER OBC 9.8.6.

- EXTERIOR STAIRS: PROVIDE A HINGED CONNECTION BETWEEN THE STAIR AND FIXED STRUCTURE TO ENSURE NO DAMAGE TO THE STRUCTURE DURING THE FROST/THAW CYCLE

-WHERE ELEVATIONS EXCEEDS 5'-11" GUARD TO BE 42" HIGH. WHERE ELEVATION IS LESS THAN 5'-11" GUARD TO BE 35"

12. ROOFS - RESERVED

13. BASEMENTS - ENSURE ONE WINDOW IN BASEMENT IS;

- OPERABLE WITHOUT USE OF TOOLS (INSIDE)

- AS PER 9.9.10.1 BEDROOM WINDOW PROVIDES AN INDIVIDUAL, UNOBSTRUCTED OPEN PORTION HAVING A MINIMUM AREA OF 3.8 FT2 WITH NO DIMENSION LESS **THAN 15**"

- FOUNDATION WALLS ENCLOSING HEATED SPACE SHALL BE INSULATED FROM UNDERSIDE OF THE SUBFLOOR TO NOT MORE THAN 200mm ABOVE FINISH FLOOR LEVEL OF BASEMENT AS PER OBC SB-12 - 2.1.1.6.(1)

15.MECHANICAL

-TAKE OUT ANY PERMITS REQUIRED -GUARANTEE ALL WORK AND MATERIAL FOR ONE YEAR FROM DATE OF COMPLETION.

-CONFORM TO ALL APPLICABLE CODES AND STANDARDS INCLUDING BUT NOT LIMITED TO PART 6 & PART 7 OF THE BUILDING CODE OF ONTARIO. CITY BYLAWS AND STANDARDS, GOVERNMENT OF ONTARIO PLUMBING CODE, ONTARIO GAS UTILIZATION CODE. NFPA 13, C.G.A. SMACNA AND ASHRAF STANDARDS

WALL ASSEMB

EW1

ÉW1.

EW2

EW3

EW4

EW5

EW6

W1

W2

W3

-MECHANICAL CONTRACTORS SHALL BE RESPONSIBLE FOR ALL ROOF PENETRATIONS, VENTS, STACKS, AND TRAPS.

HOOK-UP ALL DRAINS, SEWER AND WATER CONNECTIONS AS REQUIRED. -MAKE ALL ADJUSTMENTS TO THE EXISTING HEATING AND VENTILATING SYSTEM TO PROVIDE PROPER HEATING VENTILATION CONTROLS TO ALL AREAS. PROVIDE DAMPERING, FIRESTOPPING, ATC. AS REQ'D AT ALL FIRE SEPARATIONS

- PROVIDE WARM AIR SUPPLY GRILLE IN W.I.C. WHEN EXTERIOR WALL IS USED.

- HEATING SYSTEM TO BE DETERMINED BY HVAC INSTALLER. WALL CHASES TO BE DETERMINED PRIOR TO AND DURING DEMOLITION. ANY CHANGES TO PLAN FOR WALLS AND BULKHEADS ARE TO BE DISCUSSED WITH CONTRACTOR, R-VALUED & U-VALUED TO BE UPGRADED IF THE ADDITION IS HEATED WITH ELECTRIC AS PER OBC SB-12 TABLE 2.1.1.10. -REMOVE ALL REDUNDANT EQUIPMENT AND TURN OVER TO PROJECT MANAGER

- WATER EFFICIENCY AS PER 7.6.4

- WATER TEMP. CONTROL AS PER 7.6.5

ALL NEW PLUMBING FIXTURES TO BE CAN/CSA-B45 CERTIFIED W/ MAX FLUSH CYCLE OF 6 LITRES. TEMPERATURE CONTROL VALVE REQ'D TO MAXIMIZE HOT WATER @49C

CO-ORDINATE WITH THE ELECTRICAL CONTRACTORS AS REQUIRED 16. ELECTRICAL

TAKE OUT AND PAY FOR ANY PERMITS REQUIRED. PRESENT FINAL HYDRO INSPECTION CERTIFICATE UPON COMPLETION.

-GUARANTEE ALL WORK AND MATERIAL FOR ONE YEAR FROM DATE OF FINAL ACCEPTANCE

-THE RULES AND REGULATIONS OF THE ELECTRICAL SAFETY CODE AND THE ONTARIO BUILDING CODE (LATEST EDITION) SHALL FORM PART OF THE WORK

HOOK-UP ALL MECHANICAL EQUIPMENT, VENTILATION FANS, ETC. AS REQUIRED.

-PROVIDE ALL LIGHT FIXTURES AS REQUIRED. INCLUDE LAMPS FOR ALL LIGHT FIXTURES; LAYOUTS TO PROJECT MANAGER'S APPROVAL AN EXTERIOR LIGHTING OUTLET WITH FIXTURE CONTROLLED BY A SWITCH LOCATED WITHIN THE BUILDING SHALL BE PROVIDED AT EVERY

ENTRANCE TO BUILDING OF RESIDENTIAL OCCUPANCY (OBC 9.34.2.1) - PROVIDE 3 WAY LIGHT SWITCH IN A STAIRCASE IN ACCORDANCE TO 9.34.2.3

- ALL WIRING SHALL BE CONCEALED: COPPER, ALL SWITCHES SHALL BE SILENT; ALL COVER PLATES TO MATCH EXISTING. ALL MATERIALS TO BE CSA APPROVED.

-ALL EXISTING LIGHT FIXTURES AND DEVICES IN THIS CONTRACT AREA TO BE CHECKED, REPAIRED IF REQUIRED (INCLUDING NEW LENSES AND NEW BALLASTS IF REQUIRED.) AND RELAMP WITH NEW LAMPS WHERE MISSING OR DEFECTIVE. AT COMPLETION ALL LIGHTS TO BE OPERATING. ENSURE ALL EXISTING RECEPTACLES IN THIS CONTRACT AREA ARE OPERATIONAL. PROVIDE NEW RECEPTACLES, ELECTRICAL DEVICES AS SHOWN & AS REQUIRED FOR A COMPLETE JOB -PROVIDE ALL NECESSARY CIRCUITS AND SWITCHING FOR EACH SUBDIVIDED AREA.

RECOMMENDED THAT THE EXISTING FIRE ALARM BE INTERCONNECTED

(AC, NOT BATTERY) (9.10.19) SMOKE ALARMS SHALL BE INSTALLED SUCH

THAT THEY ARE LOCATED WITHIN 16'-5" OF ANY BEDROOM DOOR ON THE

- CARBON MONOXIDE MONITORS ARE REQUIRED ADJACENT TO SLEEPING

-NEW FINISHED SIDING (AS PER OWNER'S INSTRUCTIONS)

-NEW 1x3 VERTICAL STRAPPING @16" O.C. FASTENED TO

-NEW 5 1/2" FIBRE-GLASS BATT INSULATION - MIN R22

-NEW CEMENT PARGING TO EXTEND 6" BELOW GRADE

-NEW 8" POURED CONC, WALL (25 MPa AT 28 DAYS) (SEE

-NEW FLOOR FINISH (AS PER OWNER'S INSTRUCTION)

-NEW 4" POURED CONC. SLAB - 32 MPA W/ 5-8% AIR

RAINMENT FOR CONC. PATIO SLAB BY PENG.

-NEW 2" SM EXTRUDED RIGID INSULATION - MIN R20

-8" ±3/4? COMPACTED CRUSHED STONE TO 98% PROCTOR

SAME LEVEL AND WITHIN 49'-3" OF ANY OTHER SMOKE ALARM ON THE

AREAS (9.33.4.2) IT IS RECOMMENDED THAT MONITORS BE INSTALLED

WALL ASSEMBLY NOTES (CONT.):

NEW 2X6 SIDING EXTERIOR WALL

-NEW 2" RIGID INSULATION - MIN R5

-NEW 0.6 MIL POLY VAPOUR BARRIER

-NEW PLATON AIR GAP MEMBRANE

-NEW BITUMINOUS DAMPPROOFING

PLANS FOR THICKNESS/SCHEDULE)

-NEW 0.6 MIL POLY VAPOUR BARRIER

NEW POURED CONCRETE FOUNDATION WALL

-NEW TYVEK WEATHER BARRIER

-NEW 7/16" O S B SHEATHING

-NEW 2x6 STUDS @16" O.C.

-NEW 1/2" GYPSUM BOARD

FLOOR ASSEMBLY NOTES:

NEW SLAB ON GRADE

-UNDISTURBED SOIL

DENSITY

-REMOVE ALL REDUNDANT WIRING DEVICES. ETC.

DURING RENOVATION AND INTERCONNECTED.

- SMOKE ALARMS SHALL BE PROVIDED ON ALL LEVELS. IT IS

-REVERIEY FIRE ALARM SYSTEM


STUDS

SAME LEVEL (9.10.19.3)


W4


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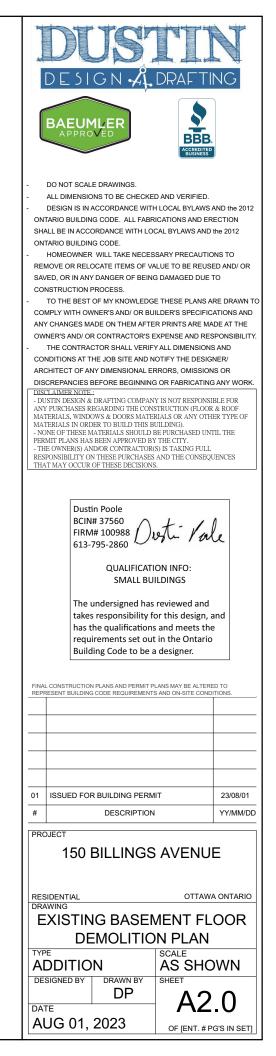
ASSEMBLY NOTES:	THEFT	T
EXIST. POURED CONC. FOUNDATION WALL W/FRAMING -EXISTING GYPSUM BOARD	- nnsttt	, Å
-EXISTING STUDS -EXISTING POURED CONC. WALL -EXISTING AIR GAP	$D \in S \mid G \mid A$, DRAFTIN	1G
-EXISTING STUDS -NEW 1/2" GYPSUM BOARD		
EXIST. POURED CONC. FOUNDATION WALL W/FRAMING -EXISTING POURED CONC. WALL	BAEUMLER APPROVED	
I -EXISTING AIR GAP -EXISTING STUDS -EXISTING INSULATION	ACCREDITED BUSINESS	
-NEW 1/2" GYPSUM BOARD EXIST. 2X4 EXTERIOR WALL W/ NEW SIDING		
-NEW FINISHED SIDING (AS PER OWNER'S INSTRUCTIONS)	 DO NOT SCALE DRAWINGS. ALL DIMENSIONS TO BE CHECKED AND VERIFIED. 	
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-NEW 2" RIGID INSULATION - MIN R5ci -NEW TYVEK WEATHER BARRIER	SHALL BE IN ACCORDANCE WITH LOCAL BYLAWS AND th ONTARIO BUILDING CODE.	e 2012
-EXISTING SHEATHING -EXISTING 2x4 STUDS	- HOMEOWNER WILL TAKE NECESSARY PRECAUTION REMOVE OR RELOCATE ITEMS OF VALUE TO BE REUSED	
-NEW FIBRE-GLASS BATT INSULATION TO MATCH EXISTING -NEW 0.6 MIL POLY VAPOUR BARRIER	SAVED, OR IN ANY DANGER OF BEING DAMAGED DUE TO CONSTRUCTION PROCESS.	
-NEW 1/2" GYPSUM BOARD EXISTING BRICK VENEER EXTERIOR WALL	- TO THE BEST OF MY KNOWLEDGE THESE PLANS ARE	
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-EXISTING GYPSUM BOARD LOWER WALL:	 DUSTIN DESIGN & DRAFTING COMPANY IS NOT RESPONSIBL ANY PURCHASES REGARDING THE CONSTRUCTION (FLOOR & MATERIALS, WINDOWS & DOORS MATERIALS OR ANY OTHER 	ROOF
-EXISTING 10" POURED CONC. WALL -EXISTING 2x4 WD STUDS	MATERIALS IN ORDER TO BUILD THIS BUILDING). - NONE OF THESE MATERIALS SHOULD BE PURCHASED UNTIL PERMIT PLANS HAS BEEN APPROVED BY THE CITY.	
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-NEW 0.6 MIL POLY VAPOUR BARRIER -NEW 1/2" GYPSUM BOARD	THAT MAY OCCUR OF THESE DECISIONS.	
EXISTING 2X4 BRICK VENEER EXTERIOR WALL W/NEW ERAMING WHERE REQ'D: -EXISTING FINISHED BRICK		_
-EXISTING AIR SPACE -EXISTING AIR BARRIER	BCIN# 37560	
-EXISTING SHEATHING -EXISTING 2x4 WD STUDS	FIRM# 100988 613-795-2860	e
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-EXISTING STRAPPING -EXISTING WEATHER BARRIER	takes responsibility for this design, an has the qualifications and meets the	
-EXISTING SHEATHING -EXISTING 2x4 STUDS	requirements set out in the Ontario Building Code to be a designer.	
-NEW FIBRE-GLASS BATT INSULATION TO MATCH EXISTING -NEW 0.6 MIL POLY VAPOUR BARRIER		
-NEW 1/2" GYPSUM BOARD EXIST. 2x4 OR 2X6 INTERIOR PARTITION	FINAL CONSTRUCTION PLANS AND PERMIT PLANS MAY BE ALTERED REPRESENT BUILDING CODE REQUIREMENTS AND ON-SITE CONDIT	
-EXISTING GYPSUM BOARD -EXISTING 2x4 OR 2x6 STUDS		
-NEW 1/2" GYPSUM BOARD WHERE REQ'D NEW 2X6 SIDING EXTERIOR WALL		
UPPER WALL: -NEW FINISHED SIDING (AS PER OWNER'S INSTRUCTIONS)		
-NEW 1x3 VERTICAL STRAPPING @16" O.C. FASTENED TO STUDS	D	
-NEW TYVEK WEATHER BARRIER -NEW 7/16" O.S.B. SHEATHING	01 ISSUED FOR BUILDING PERMIT # DESCRIPTION	23/08/01
-NEW 2x6 STUDS @16" O.C. -NEW 5 1/2" FIBRE-GLASS BATT INSULATION - MIN R22	# DESCRIPTION	YY/MM/DD
-NEW 2" RIGID INSULATION - MIN R5 -NEW 2x4 STUDS @16" O.C. -NEW 0.6 MIL POLY VAPOUR BARRIER	150 BILLINGS AVENUE	:
-NEW 1/2" GYPSUM BOARD NEW 1/2" GYPSUM BOARD NEW 2X4 SIDING EXTERIOR WALL		-
-NEW FINISHED SIDING (AS PER OWNER'S INSTRUCTIONS)	RESIDENTIAL OTTAWA	ONTARIO
-NEW 1x3 VERTICAL STRAPPING @16" O.C. FASTENED TO STUDS		
-NEW 2" RIGID INSULATION - MIN R5 -NEW TYVEK WEATHER BARRIER	ASSEMBLY	, a
-NEW 7/16" O.S.B. SHEATHING -NEW 2x4 STUDS @16" O.C. NEW INSULATION TO MATCH EXISTING	TYPE SCALE	
-NEW INSULATION TO MATCH EXISTING -NEW 0.6 MIL POLY VAPOUR BARRIER -NEW 1/2" GYPSUM BOARD	ADDITION NTS DESIGNED BY DRAWN BY SHEET	
NEW 2x4 OR 2x6 INTERIOR PARTITION WALL -NEW 1/2" GYPSUM BOARD)
-NEW 2x4 OR 2x6 STUDS @16" O.C. -NEW 1/2" GYPSUM BOARD	AUG 01, 2023 OF JENT. # PG	S IN SETI
	0. [2.11.#10	

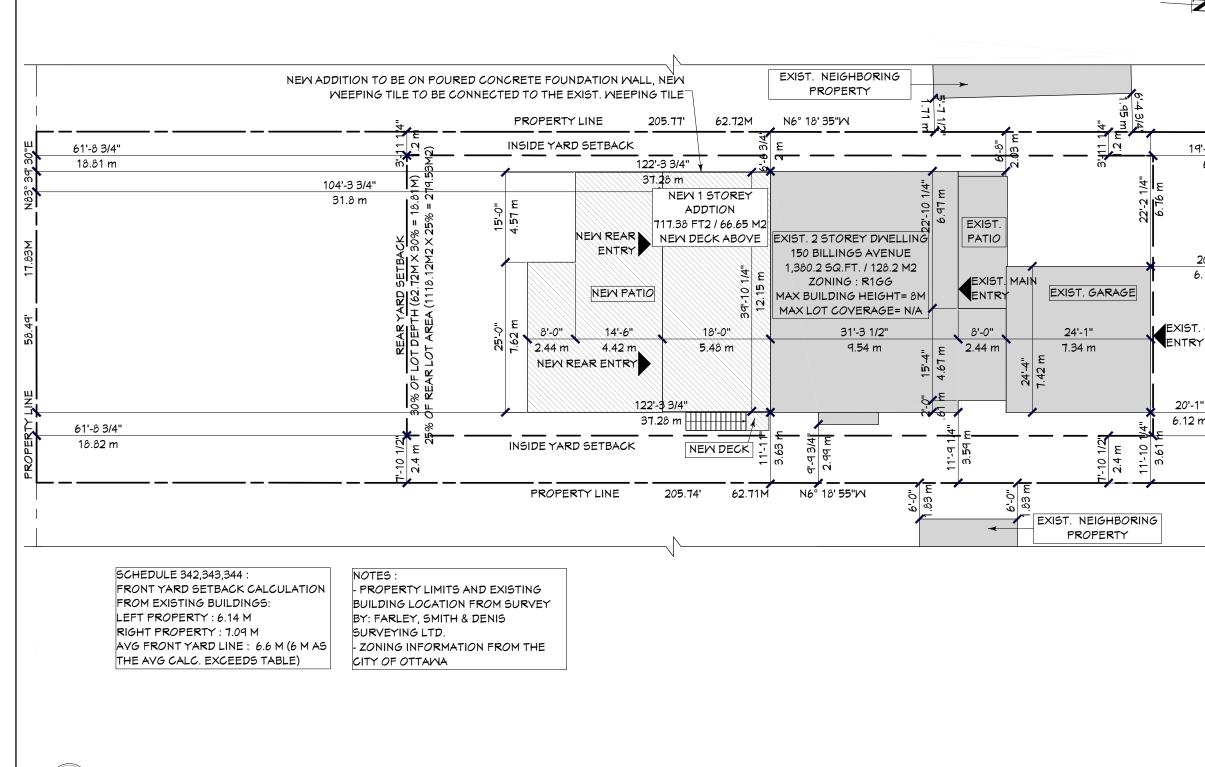



01 SITE PLAN A1.0 SCALE: 1/16"=1' 0"




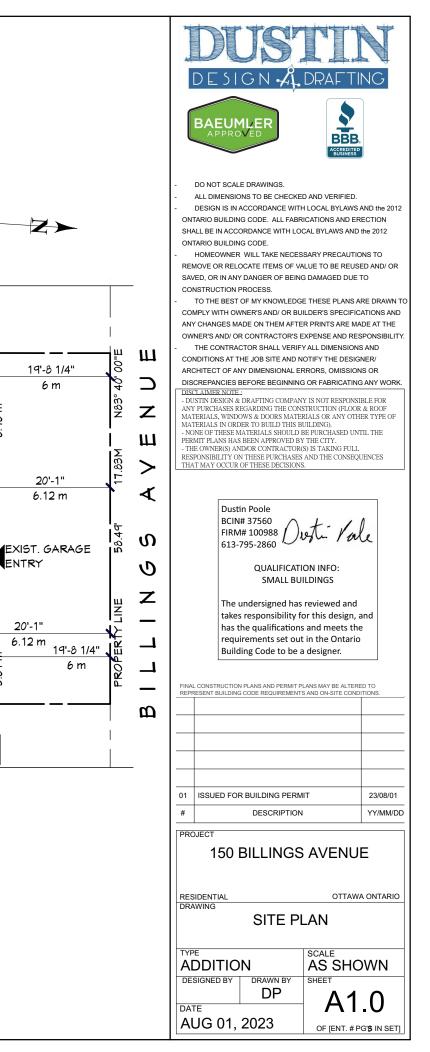

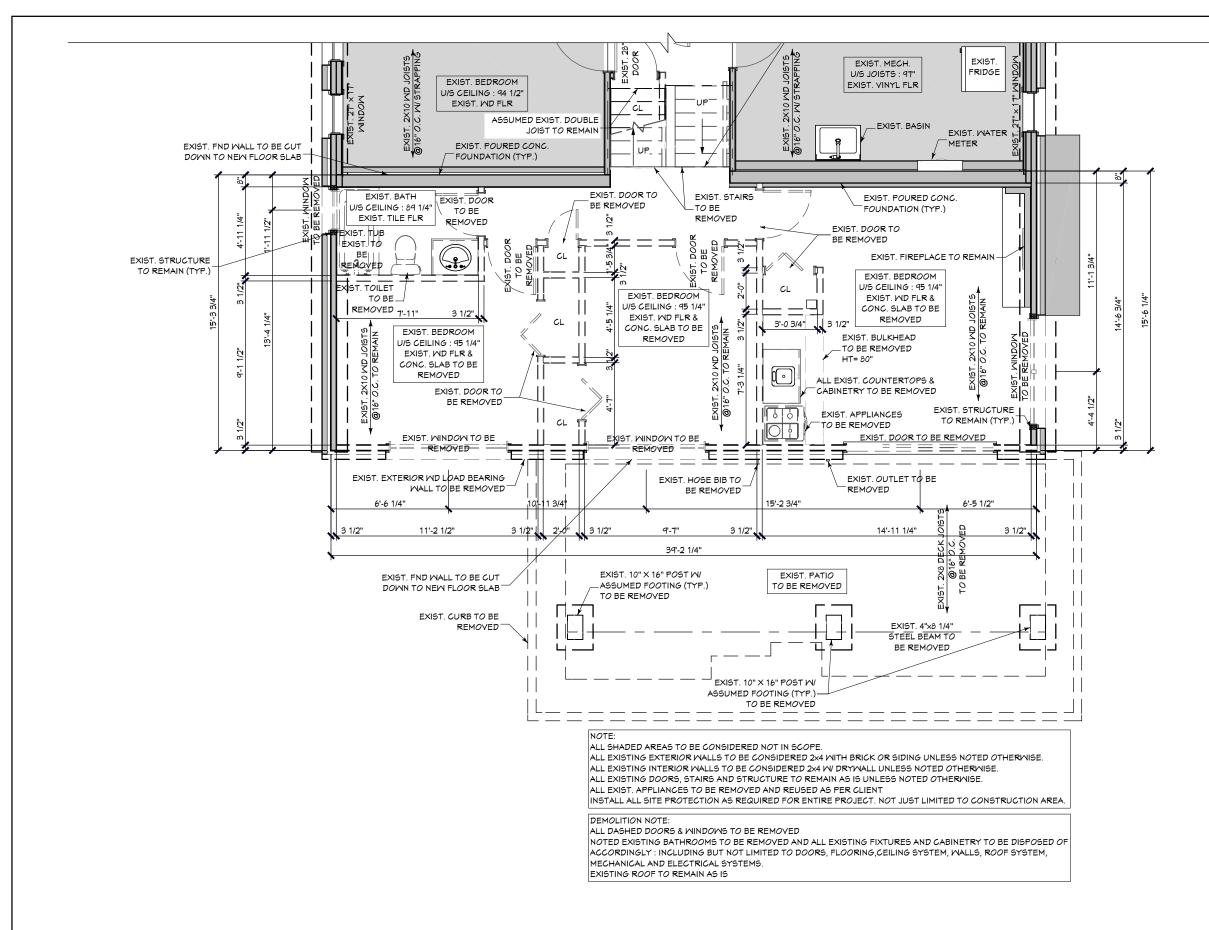

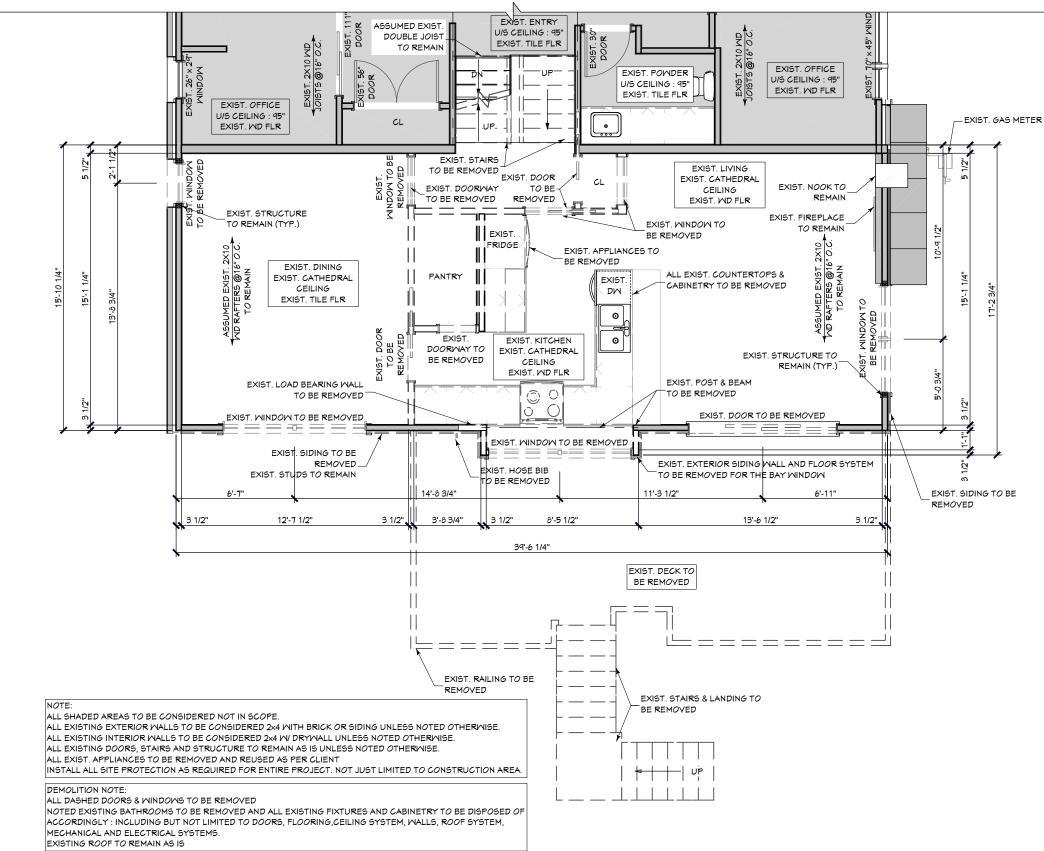

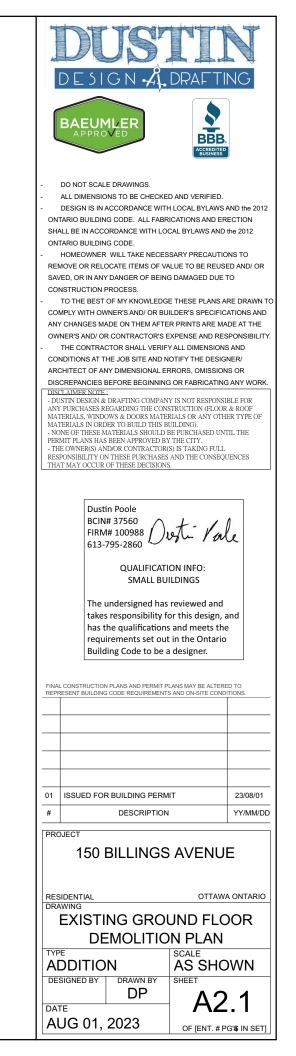

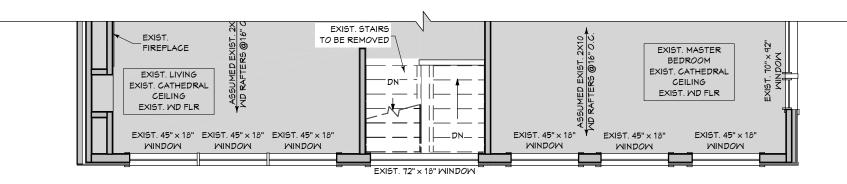

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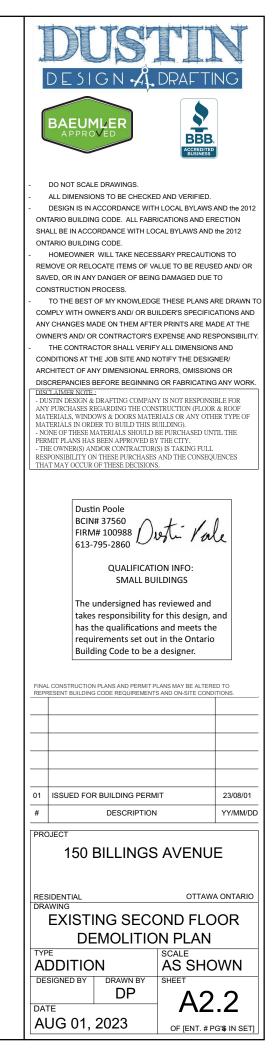
ALL SHADED AREAS TO BE CONSIDERED NOT IN SCOPE. ALL EXISTING EXTERIOR WALLS TO BE CONSIDERED 2x4 WITH BRICK OR SIDING UNLESS NOTED OTHERWISE. ALL EXISTING INTERIOR WALLS TO BE CONSIDERED 2x4 N/ DRYWALL UNLESS NOTED OTHERWISE. ALL EXISTING DOORS, STAIRS AND STRUCTURE TO REMAIN AS IS UNLESS NOTED OTHERWISE. ALL EXIST. APPLIANCES TO BE REMOVED AND REUSED AS PER CLIENT INSTALL ALL SITE PROTECTION AS REQUIRED FOR ENTIRE PROJECT. NOT JUST LIMITED TO CONSTRUCTION AREA.


DEMOLITION NOTE:

ALL DASHED DOORS & WINDOWS TO BE REMOVED


NOTED EXISTING BATHROOMS TO BE REMOVED AND ALL EXISTING FIXTURES AND CABINETRY TO BE DISPOSED OF ACCORDINGLY : INCLUDING BUT NOT LIMITED TO DOORS, FLOORING, CEILING SYSTEM, WALLS, ROOF SYSTEM, MECHANICAL AND ELECTRICAL SYSTEMS. EXISTING ROOF TO REMAIN AS IS

01 EXISTING SECOND FLOOR DEMOLITION PLAN A2.2 SCALE:3/16"=1' 0"



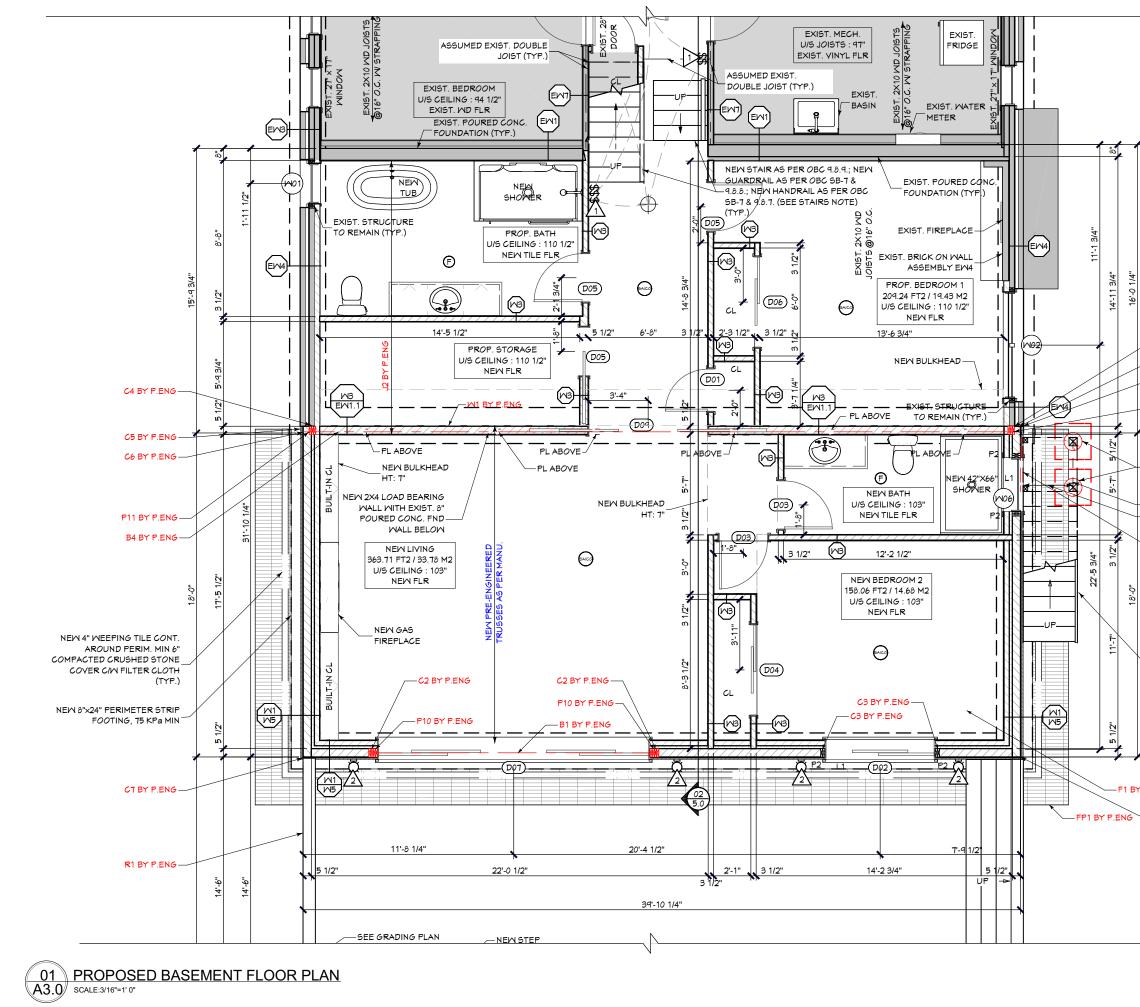

4	DUSTION A DRAFTI DE SIGN A DRAFTI BAEUMLER APPROVED	JG			
C4 BY P.ENG C6 BY P.ENG C5 BY P.ENG P11 BY P.ENG	 DO NOT SCALE DRAWINGS. ALL DIMENSIONS TO BE CHECKED AND VERIFIED. DESIGN IS IN ACCORDANCE WITH LOCAL BYLAWS AND the ONTARIO BUILDING CODE. ALL FABRICATIONS AND ERECTION SHALL BE IN ACCORDANCE WITH LOCAL BYLAWS AND the 2012 ONTARIO BUILDING CODE. HOMEOWNER WILL TAKE NECESSARY PRECAUTIONS TO REMOVE OR RELOCATE ITEMS OF VALUE TO BE REUSED AND/ SAVED, OR IN ANY DANGER OF BEING DAMAGED DUE TO CONSTRUCTION PROCESS. TO THE BEST OF MY KNOWLEDGE THESE PLANS ARE DRAI COMPLY WITH OWNER'S AND/ OR BUILDER'S SPECIFICATIONS ANY CHANGES MADE ON THEM AFTER PRINTS ARE MADE AT T OWNER'S AND/ OR CONTRACTOR'S EXPENSE AND RESPONSIE THE CONTRACTOR SHALL VERIFY ALL DIMENSIONS AND CONDITIONS AT THE JOB SITE AND NOTIFY THE DESIGNER/ ARCHITECT OF ANY DIMENSIONAL ERRORS, OMISSIONS OR DISCREPANCIES BEFORE BEGINNING OR FABRICATING ANY W DISCLAMER NOTE: DUSTIN DESIGN & DRAFTING COMPANY IS NOT RESPONSIBLE FOR ANY PURCHASES REGARDING THE CONSTRUCTION (FLOOR & ROOF MATERIALS, IN NORDER DO BUILD ERING, . NONE OF THESE MATERIALS SHOULD BE PURCHASED AND RESPONSIBLE FOR ANTERIALS IN ROBRE ON DUILD BE PURCHASED UNTIL THE PERMIT PLANS HAS BEEN APPROVED BY THE CITY. THE OWNER(S) AND/OR CONTRACTORS, SAND THE CONSEQUENCES THAT MAY DANDOR CONTRACTORY SISTAND THE CONSEQUENCES THAT MAY OCCUR OF THESE MATERIALS SHOULD BE PURCHASED AND THE CONSEQUENCES THAT MAY OCCUR OF THESE MATERIALS SHOULD BE ON SHOULD BE TOR AND FULANS HAS BEEN APPROVED BY THE CITY. THE OWNER(S) AND/OR CONTRACTORY SISTAND THE CONSEQUENCES THAT MAY OCCUR OF THESE MATERIALS SHOULD BE THE CITY. 				
P13 BY P.ENG NEW 2 PLY 2X8 PT WD BEAM J1 BY P.ENG LB1 BY P.ENG LB1 BY P.ENG NEW STAIR AS PER OBC 9.8.9.; NEW GUARDRAIL AS PER OBC SB-7 & 9.8.2.; NEW HANDRAIL AS PER OBC SB-7 & 9.8.7. (SEE STAIRS NOTE) (TYP.) NEW 2-2X12 P.T. STRINGERS @12" C.C. BY P.ENG	Dustin Poole BCIN# 37560 FIRM# 100988 Dut full G13-795-2860 QUALIFICATION INFO: SMALL BUILDINGS The undersigned has reviewed and takes responsibility for this design, a has the qualifications and meets the requirements set out in the Ontario Building Code to be a designer.	and 2			
BY P.ENG (TYP. IN DWELLING)	01 ISSUED FOR BUILDING PERMIT # DESCRIPTION PROJECT 150 BILLINGS AVENUE	23/08/01 YY/MM/DD			
	RESIDENTIAL OTTAWA DRAWING PROPOSED BASEMEN FLOOR PLAN TYPE ADDITION DESIGNED BY DRAWN BY SHEET				
	DESIGNED BY DRAWN BY DP AND	-			

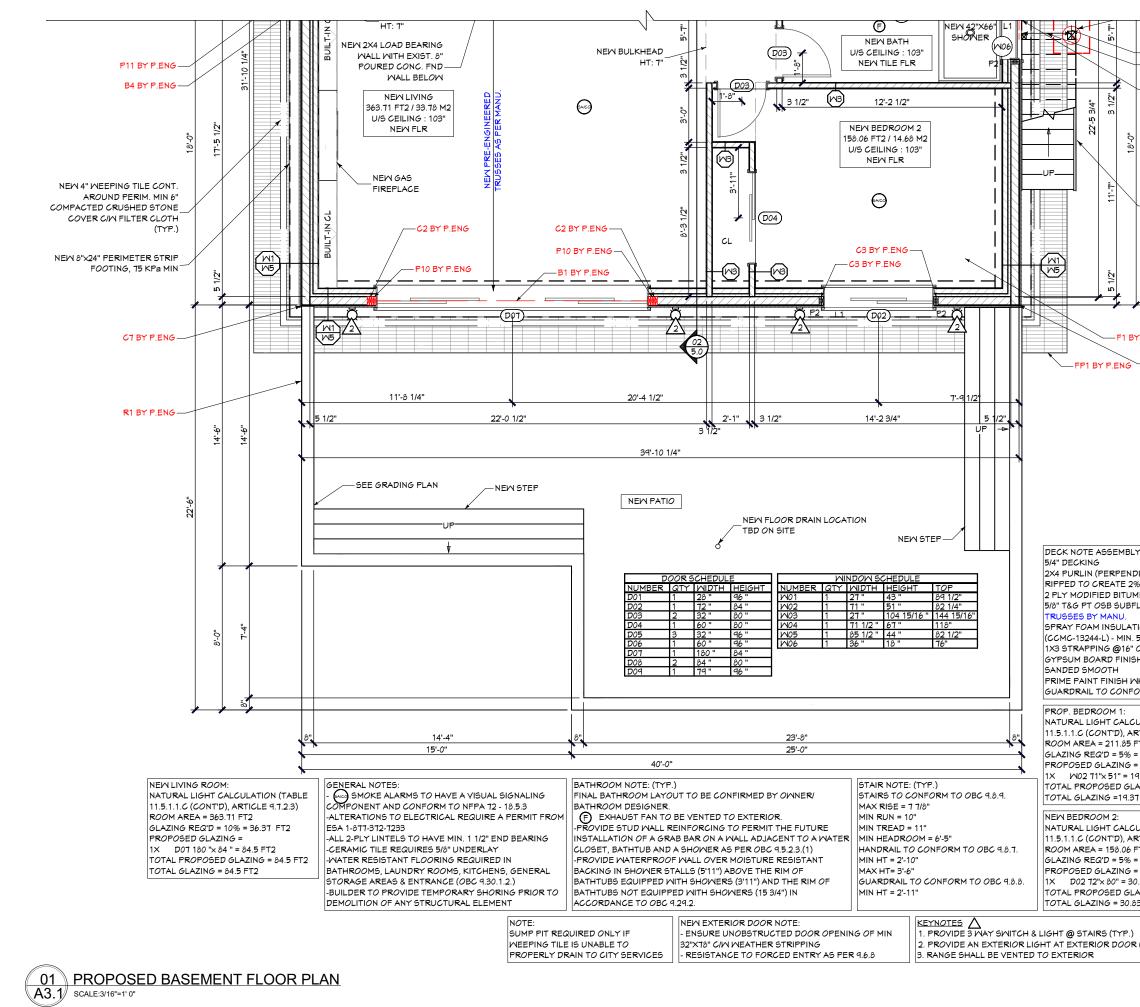


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Dustin Poole BCIN# 37560 FIRM# 100988 613-795-2860	e
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TH INDER IN A CONFORMING CODE REQUIREMENTS AND ON-SITE CONDITIONS CODE REQUIRE	
OM 1: IT CALCULATION (TABLE NT'D), ARTICLE 9.7.2.3) 211.85 FT2 D = 5% = 10.59 FT2 AZING = (51" = 19.37 FT2 G = 19.37 FT2 # DESCRIPTION	23/08/01 YY/MM/DD
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TYPE SCALE ADDITION AS SHOU DESIGNED BY DRAWN BY DATE DP A3	

A3.1


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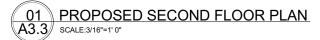
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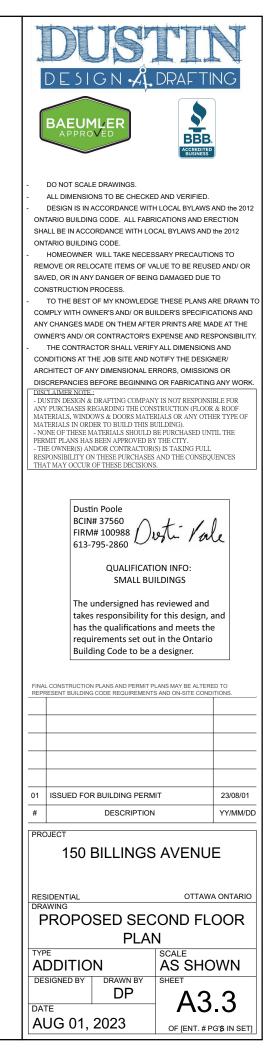
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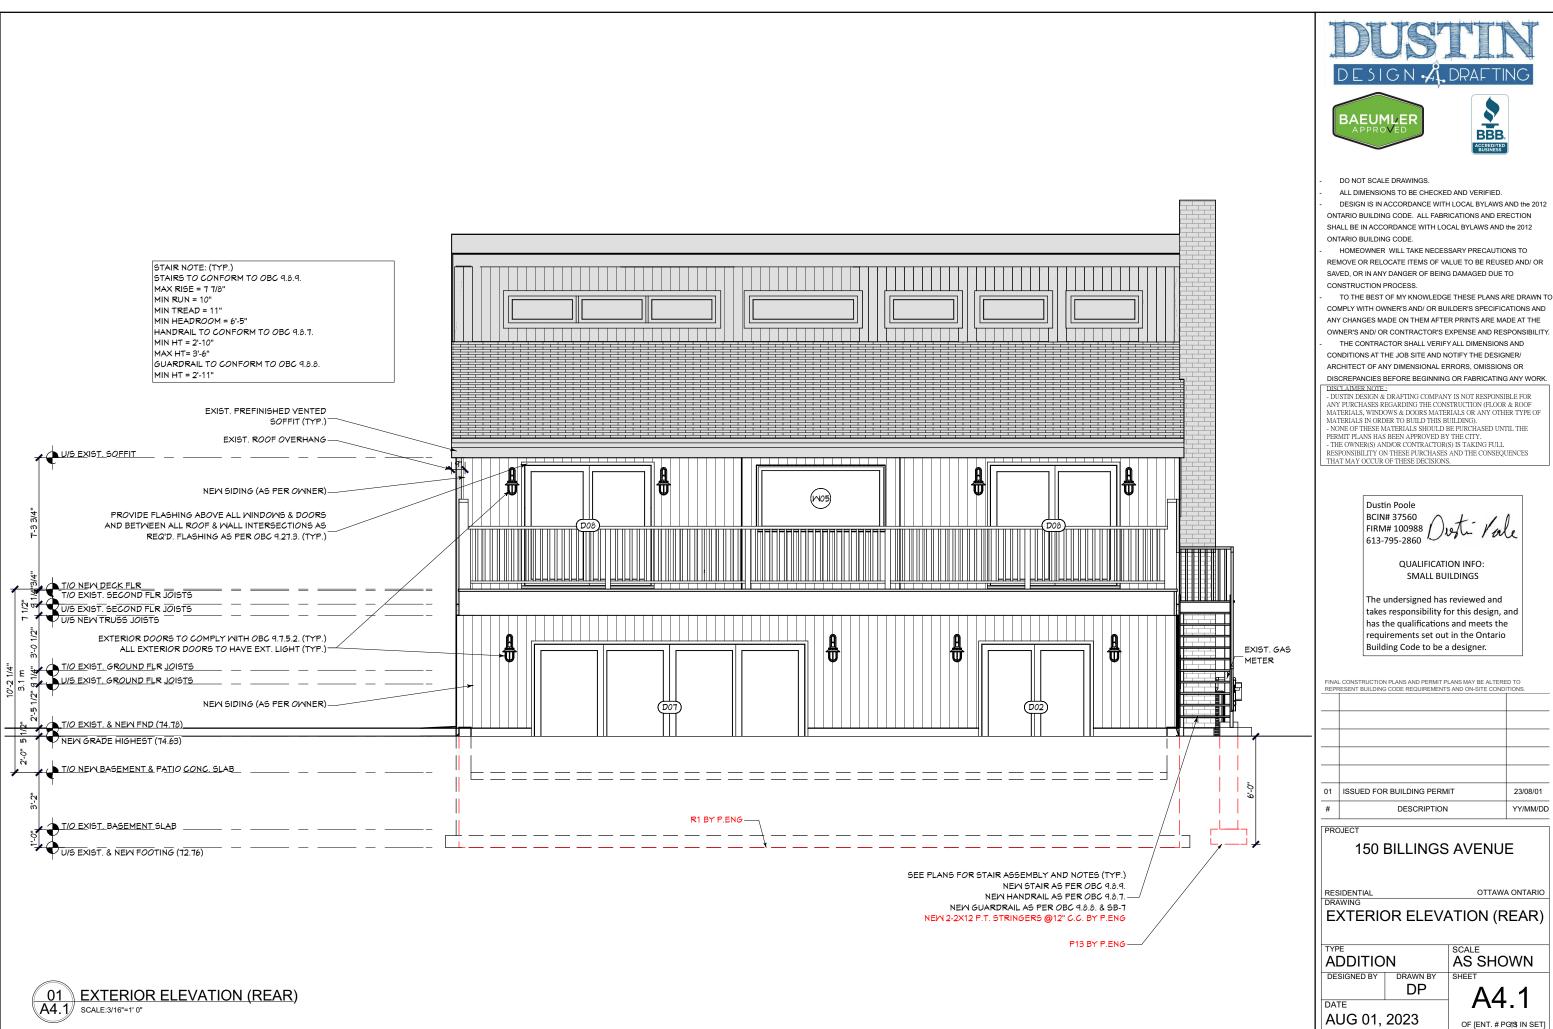
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			PLANS AND PERMIT PL CODE REQUIREMENTS			
ATION (TABLE SLE 9.7.2.3)						
6.17 FT2	01				22/00/01	
4.32 FT2 2 NG = 61.32 FT2	01 ISSUED FOR BUILDING PERM # DESCRIPTION			23/08/01 YY/MM/DD		
T2	PROJ	ECT				
SSEMBLY (TYP.): PERPENDICULAR TO EXISTING JOIST)		150 E	BILLINGS	AVENU	E	
REATE 2% SLOPE ED BITUMEN MEMBRANE SB SUBFLOOR		DENTIAL		OTTAWA	A ONTARIO	
SD SUDFLOOR MANU. INSULATION (FOLARFOAM PF-7300) L) - MIN. 5 1/2" THICK - MIN R35 KG @16" O.C.	PROPOSED GROUND FLOOR PLAN					
RD FINISHED WITH A 3 COAT	TYPE AD	DITIO	N	SCALE AS SHC	WN	
FINISH WHERE REQ'D O CONFORM TO OBC 9.8.8. AND SB-7	DESI	GNED BY	DRAWN BY	SHEET A3	.2	
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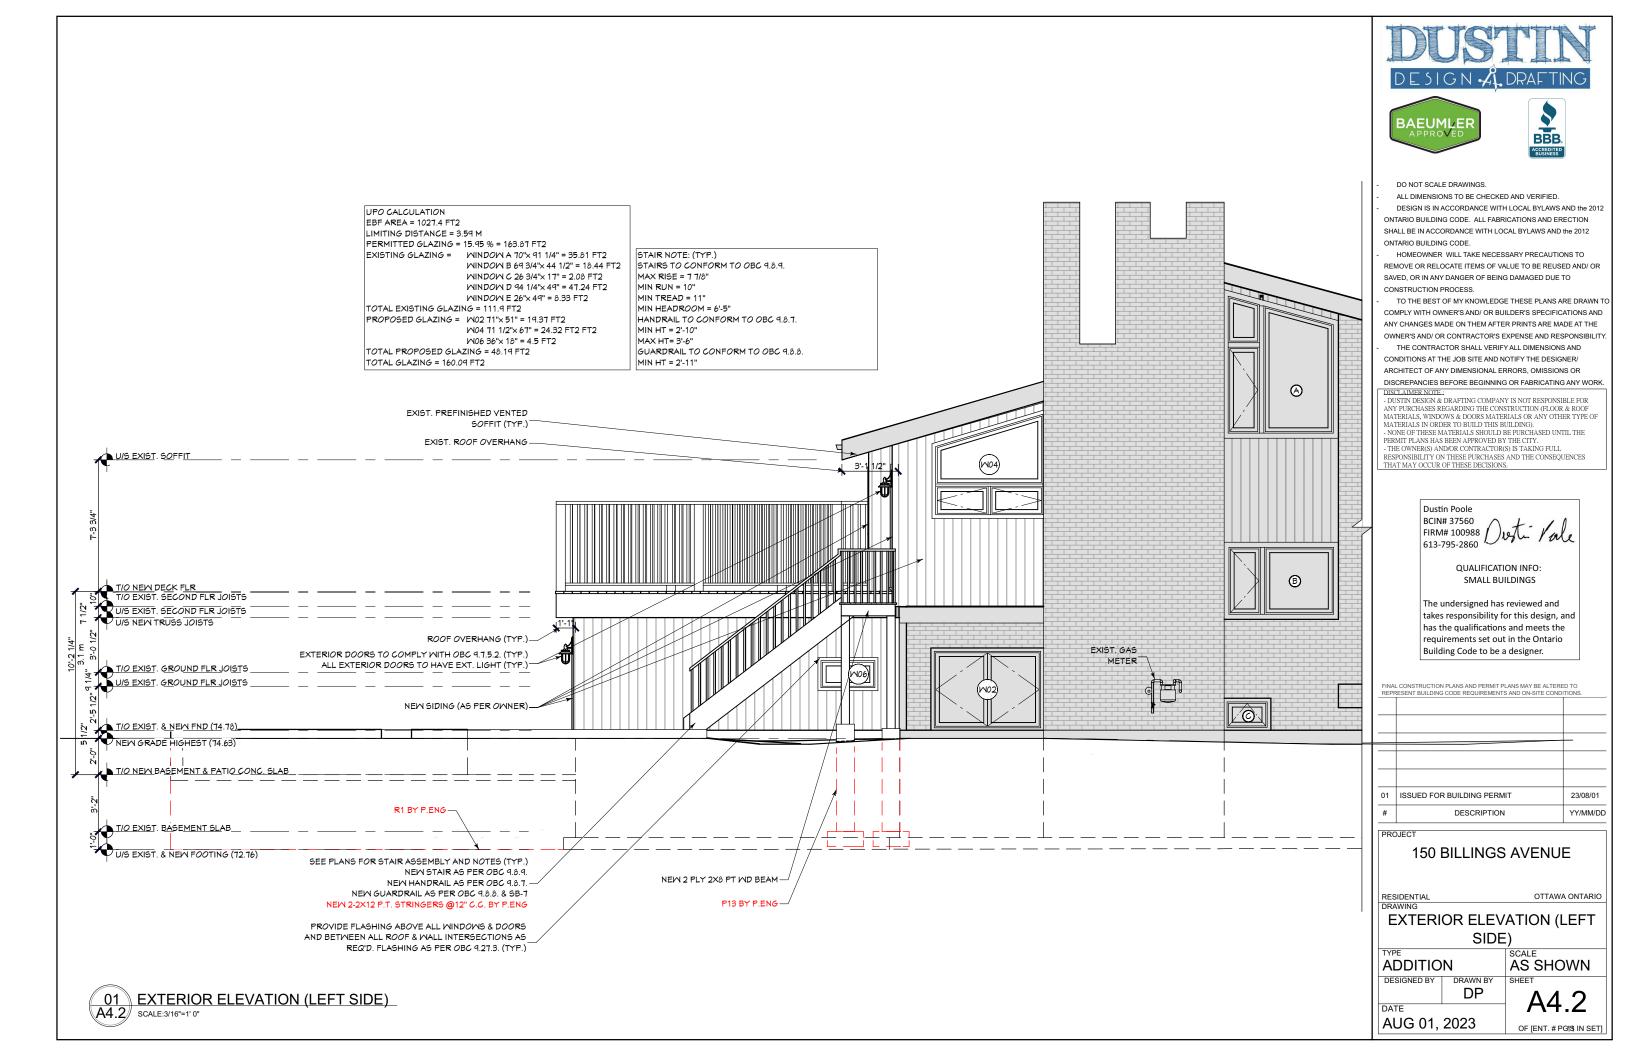








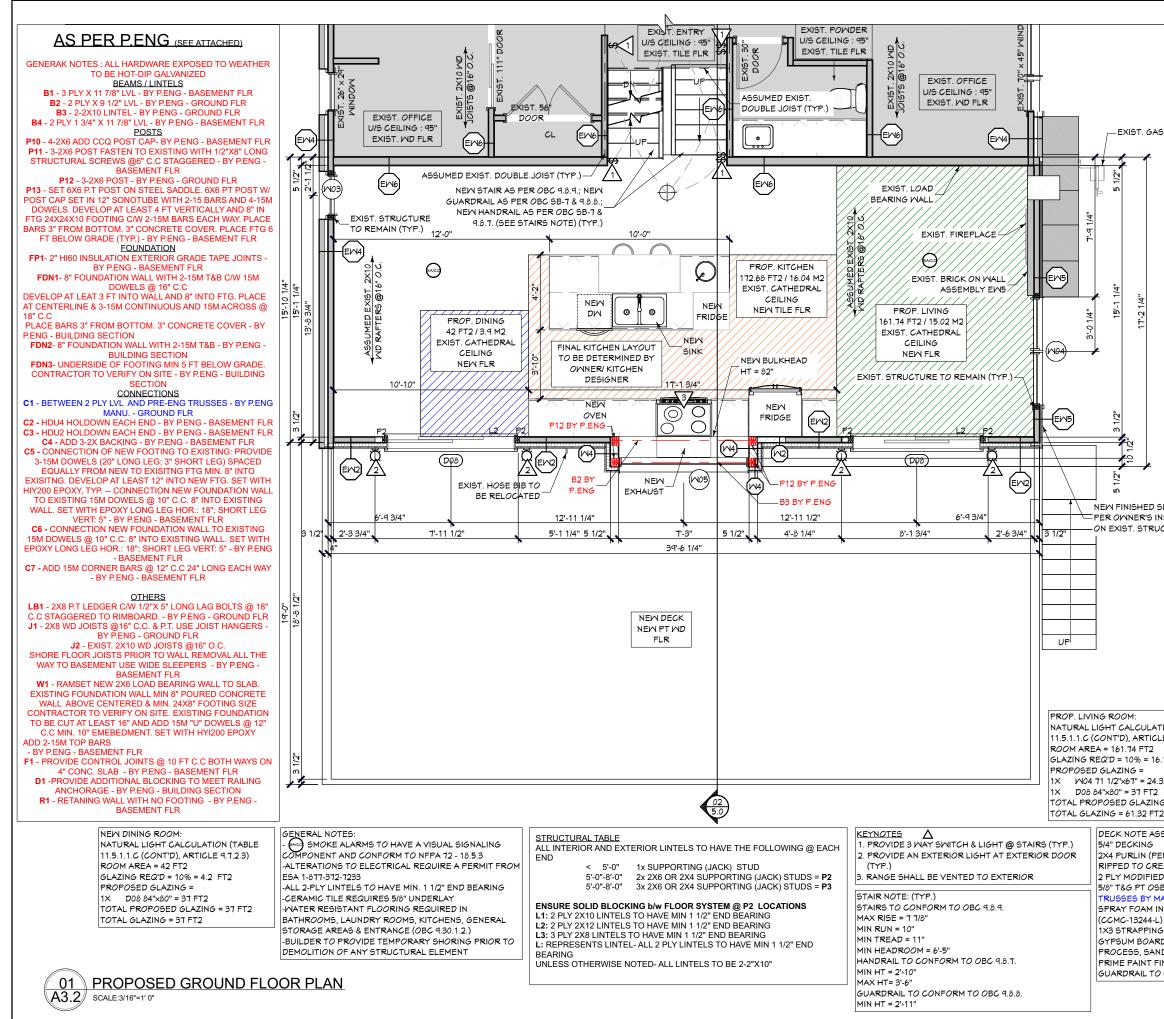




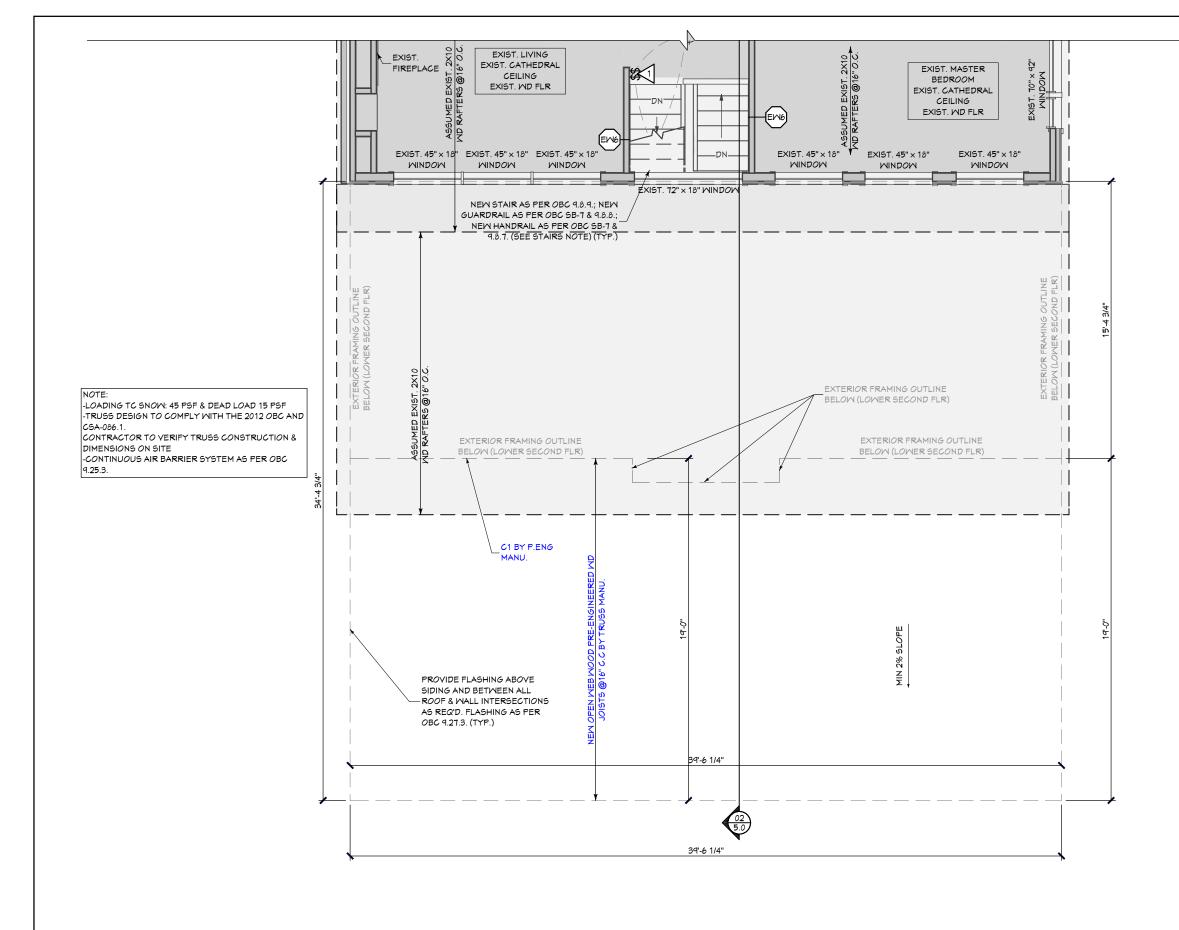

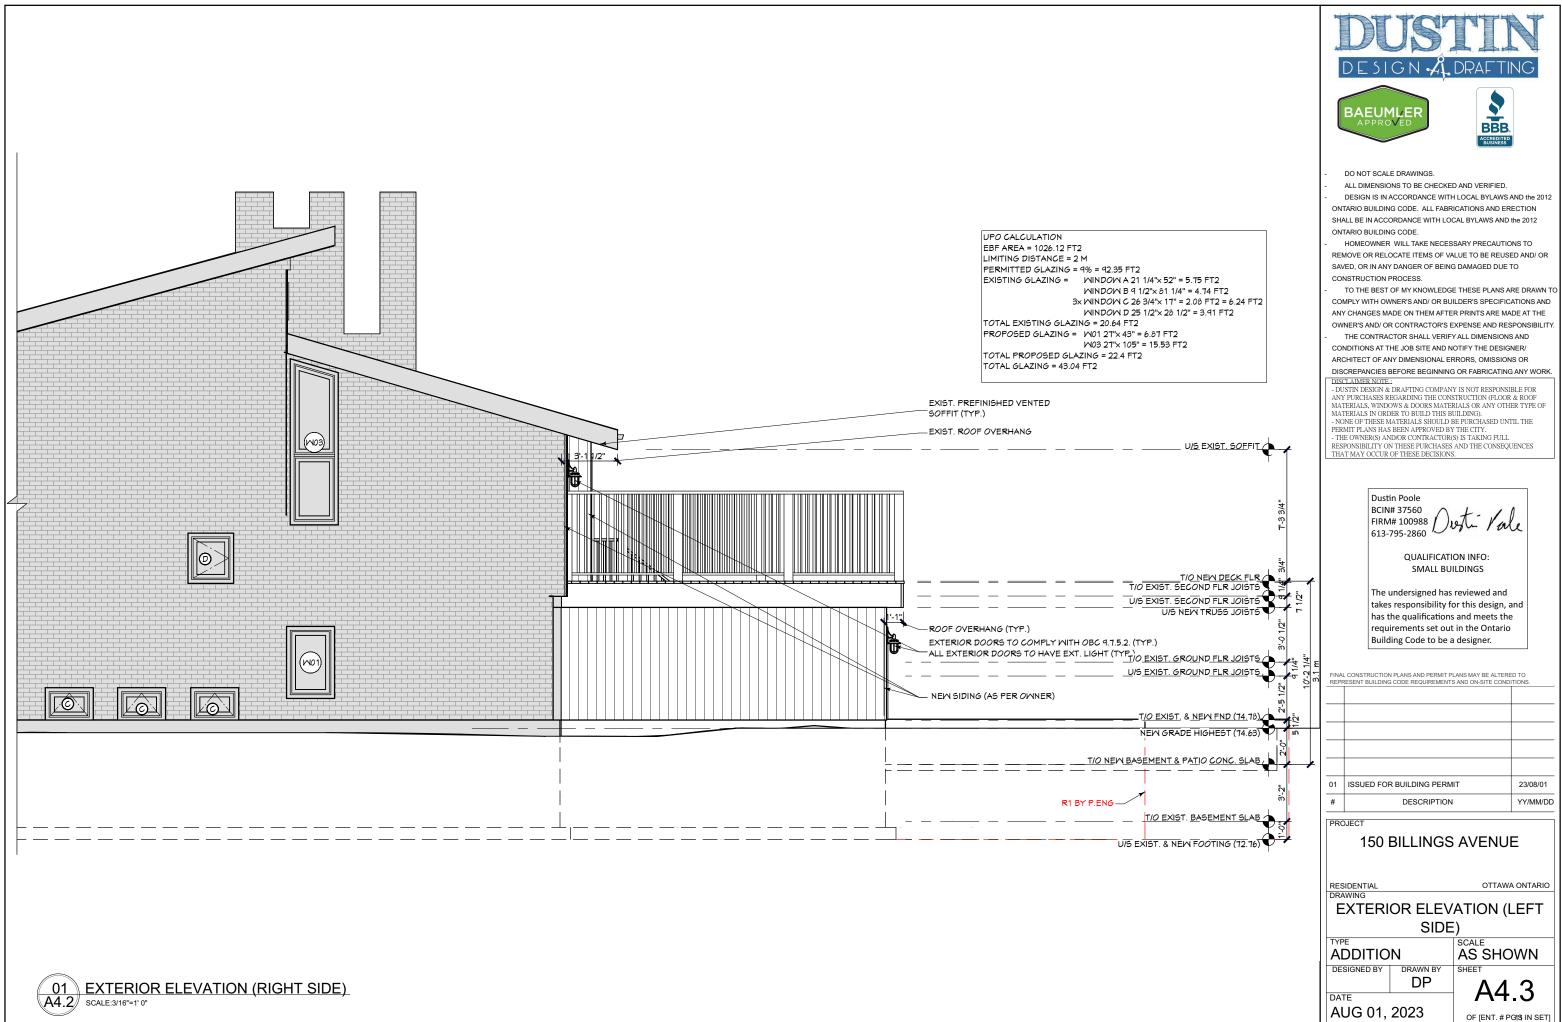

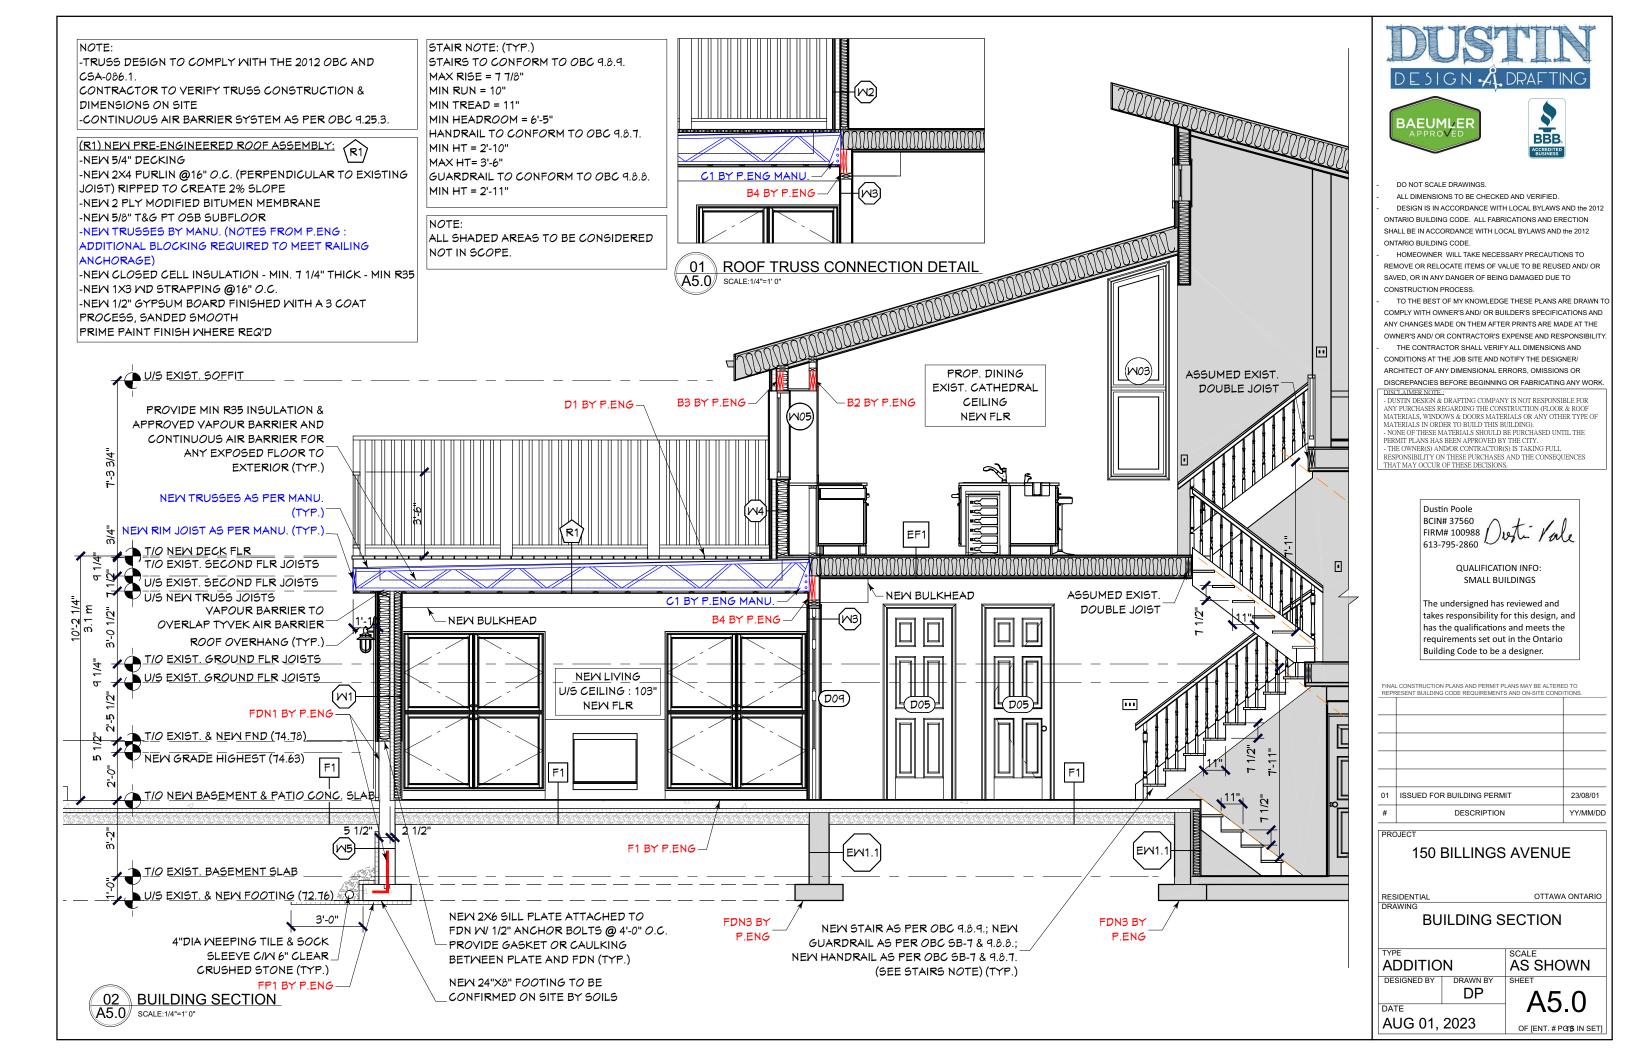

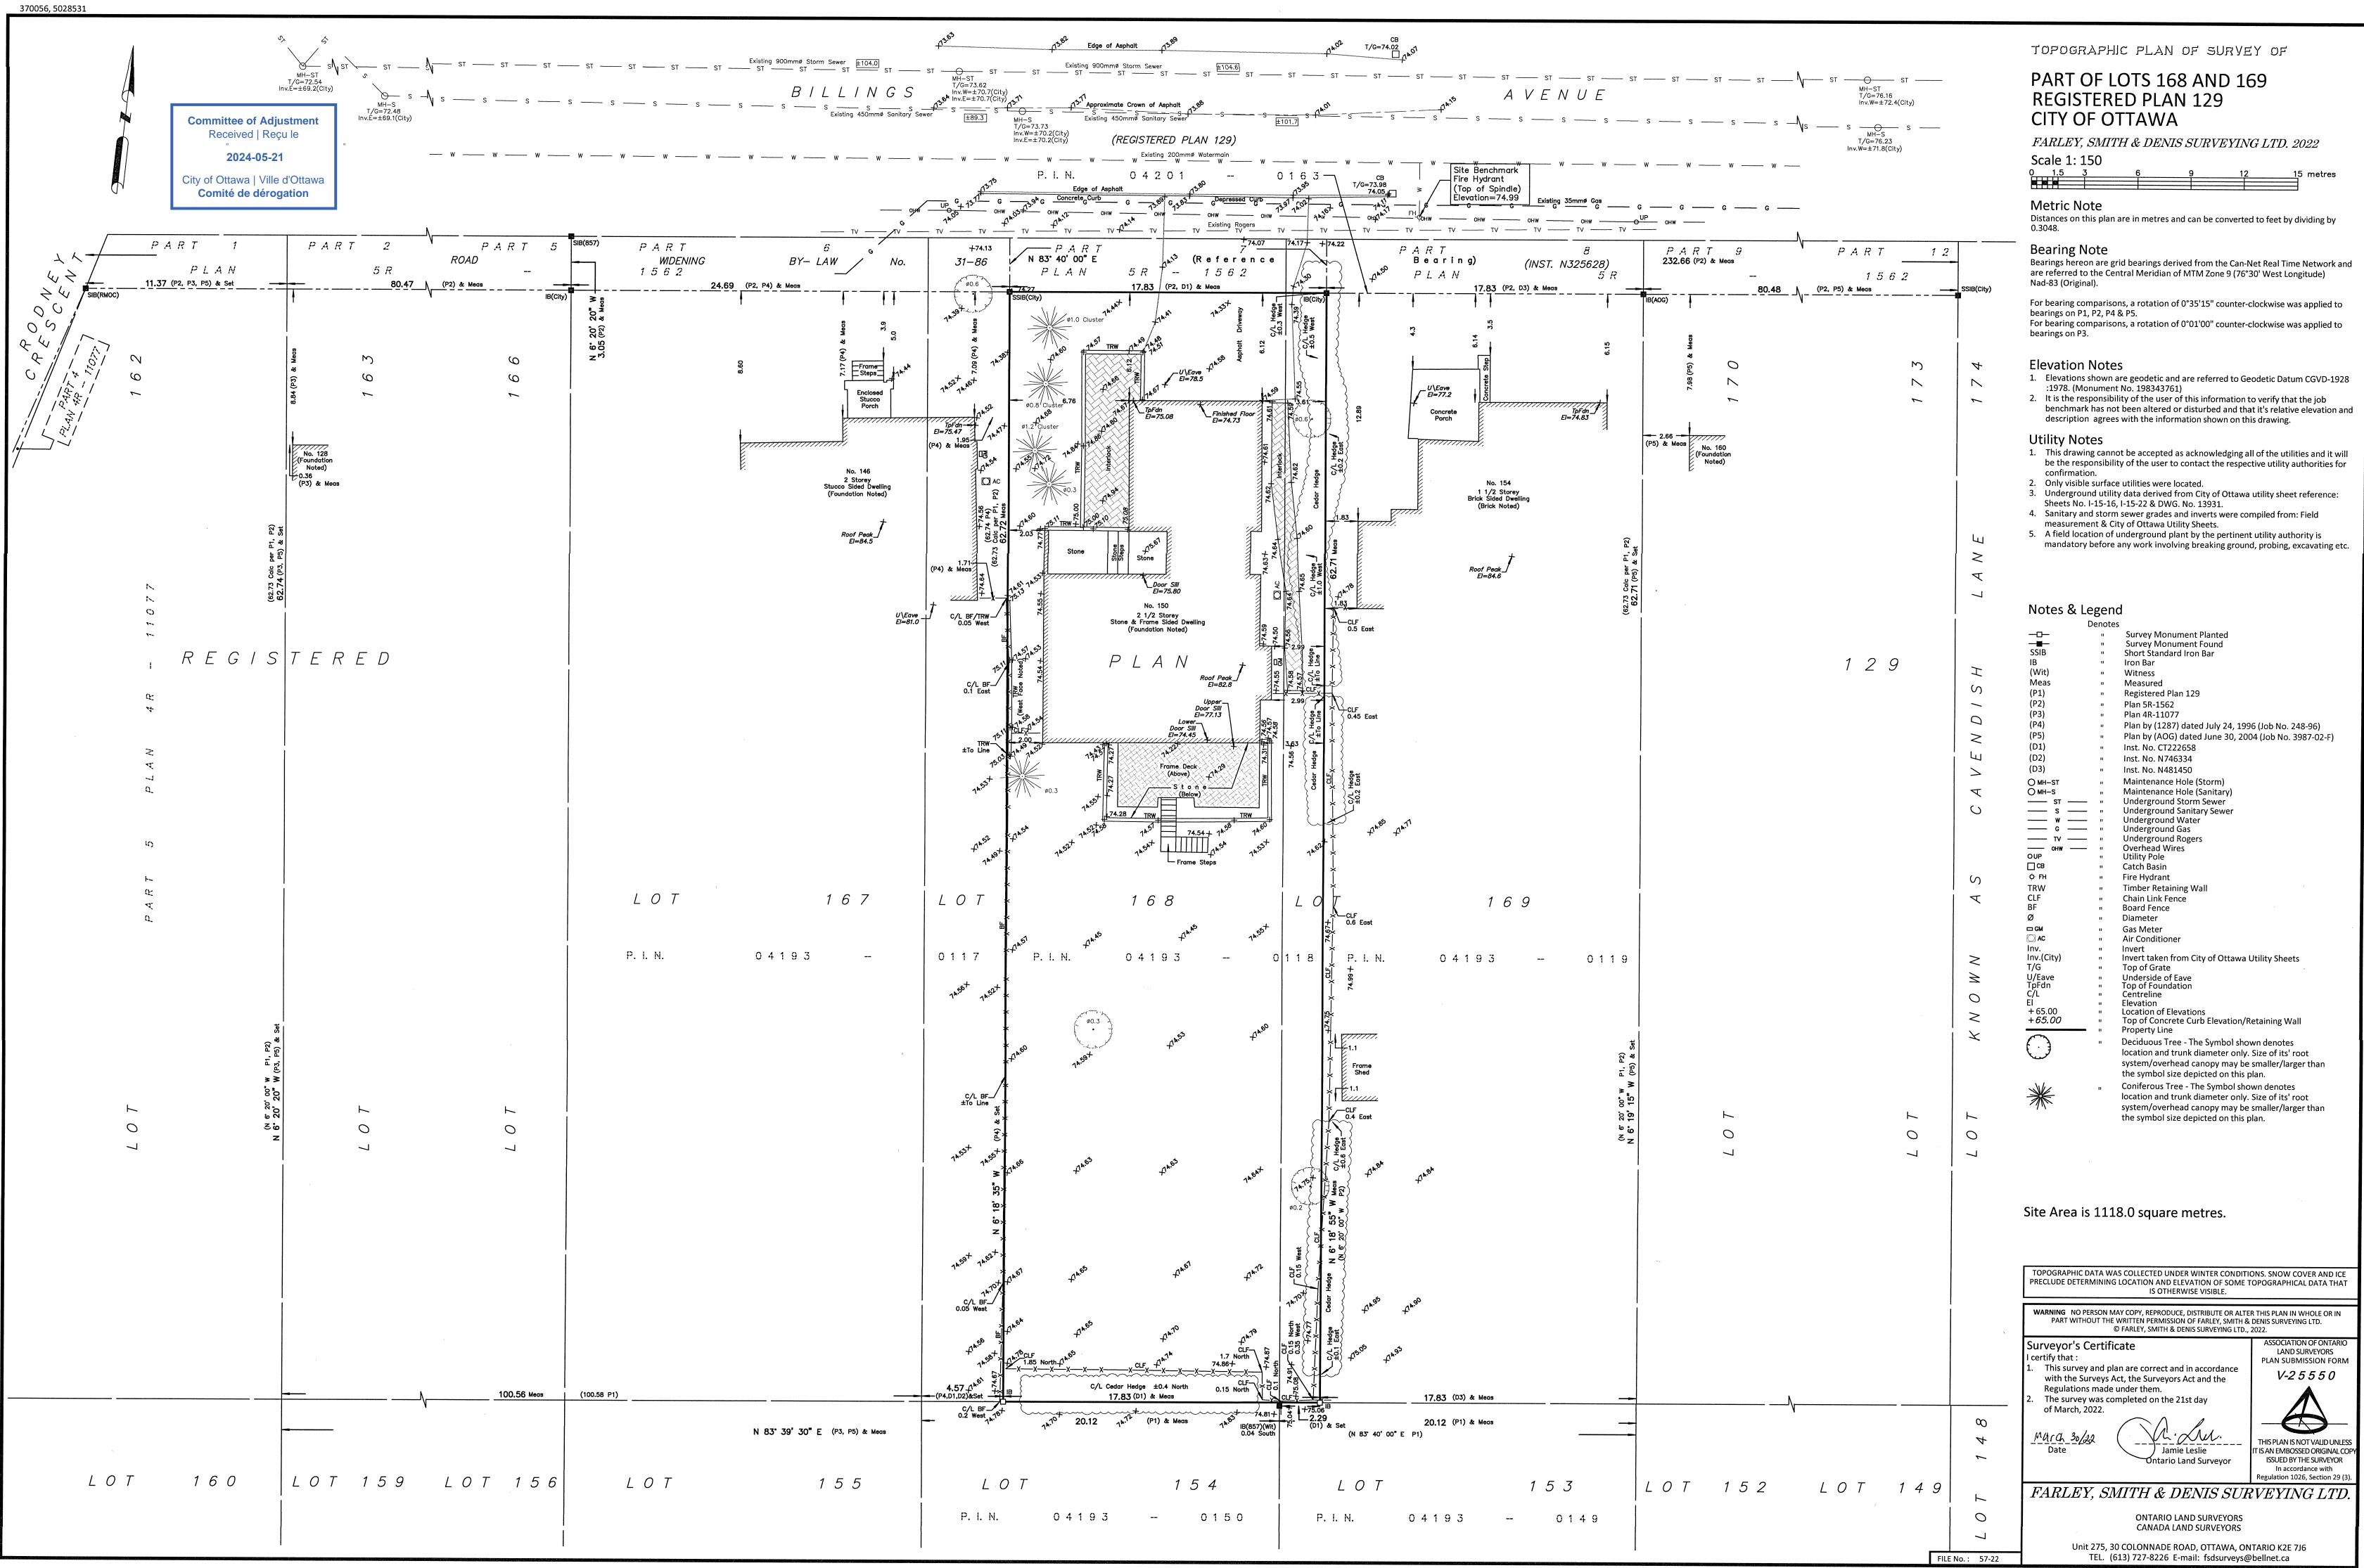

J:\2022\57-22_150 Billings Av_topo\Final\57-22 150 Billings Ave_LT168-169 RP129_Topo_F.dwg

VO	ROOM NAME	FLOOR,	FIN	WALLS	FIN	CEILING	FIN	BASE	FIN	
- <u>1</u>	RECREATION ROOM	CORLON BANAVOCE		DW	PAINE	AT	PRINT	CLDKR	OIL	
,2	BLDROOM 2 BOW	CARTER TA GUILL		DW	PAINT	DW	PAINT	CEDAR	OIL	
-3	DEDKOOM3 B.O.W			DW	PAINT	DW	PHINT	ČEDAR	011	
4	- HANDING-2-OK V	CORLON Barwird		DW:	PAINT	FW	PAINT	CEDAR	DIL	
5	BATHROOM 1 *			DW/CT	SG PAINT	,DW	SG PAINT	CEDAR	OIL	-
6	STORNGE ROOM	-GONERETE Anno	PAINT.	CONCRETE	-			· · · · · · · · · · · · · · · · · · ·		
7. 3	COLD STORAGE KOUN V	CONCRETE	PAINT	DW	PAINT	DW *	PAINT	CEDAN	OIL	-
8 /	PURNACE ROOM V	CONCRETE	PAINT	CONCRETE		y⊶cin _a a	-		-	-
9	COVERED PORCH ?	PRECAST PAVERS		Manager and the second s	****	1XB CEDAR SLATS		***		
100	- BROJECTION ROOM	-GORNON Bar will		DW	PAINT	DW	PAINT.	CEDAR	-	
11	LANDING 1	CORLON Barwood	-	DW	PAINT	ΨØ	PAINT	CLONR		
	and the second									100
1	SUNDECK, V	2X6 CEDAR	STAIN		Sprant .		-	Ninger	-	
2	FAMILY KITCHEN B. M.	QT / larpet tem		DW	SG PNNT	TEG CEDAN	-	CEDAR	OIL	
3	PANTRY	RT Frontenac		DW	PAINT	DW .	PAINT	CEDING .	OIL.	
4	DINING ROOM	QT 8x4x3/8		DW	PAINT.	TIG CEDAR	-	CEDNR	OIL.	
5	LANDING 4	QI Prean Peoney		DW	PAINE	TEGCLOAR		CEDAR	OIL	-
0	WORKROOM Byowned	CARPET		, WO	PAINT	DW	STIPPLE	CEDAR	OIL	
1	LIDRARY Byowner	CARPET *	-	DW	PAINT	PW	STIPPLE	CEDAR	OIL	-
3	STUDY Byowner	CARPET		DW	PAINT	* DW	STIPPLE	CEDAR	OIL	-
9	LANDING 3	QT) Frontchares		DW	PAINT	TIG CLOKE		CEDAR	OIL	
10	VESTIBULE -	QT 8×4×3/8		DW	PAINE	TAG CEDAR		GEDAR	, QĨL	
1	HALL -	QT Pionue Pecan	• • •	WG.	PAINT	TEGCLOAR		CEDAR	OIL	-
12	POWDER ROOM *	CORLON	- 14	DW.	SGPAINT	WC	SG PAINT	CEDAR	OIL	~
13	HOBBY ROOM +	CORVON	-	DW	PAINT	DW	Stipple	CEDAR	OIL	-
14	GARAGE	CONCRETE	EPOXY	DW/CB					· · ·	
15	PURCH / PATIO	QT Pinner lecan	·	CEDNK SIDING	STAIN	1X3 CEDAR SLATS	2	Yen .		2
			8 1					je i	1	
							-	·····	·	-
							4.7	J	1	-
1	MASTER, BEDROOMBy Hame	CARPET	1.99° 1	DW	PMNT	TAG CLDAR	÷	CEDAR	OIL	-
2	LANDING 5 Browner	CARPET		DW	PAINT"	TE G CEDAR	-	CEPAR	OIL	
3	LIVING ROOM By annu	CARPET		DW	PAINT *	T& G CLDAR.	-	CEDEAR	OIL	
4	peck 2	AF metal &		OCEDAR SIDING	STRIN	TEGCEDAR	-	-		-
Ę.	SAUNA :	Corlon & wood						***		-
2	BATHKOOM, 2 Byowner	OT larget		CLOAR/CT	-	T & G CEDAR	-	CEDAR.	UIL	~
	e,		:		1. N.		~	<u>.</u>		~
	STAIR 1 Bycwner	CARFET	- 	DW	PAINT	TEGCEDAR	194 194	2 × 12 KED OAK STRING.	OIL	
	STAIR, 2	CONCRETE STAIR	epoxy	CONC.	EPOXY		-		-	
	STAIR 3	2 × 12 CLDAR TREADS		2+2 CEDAR DALUSTRIND	E -	-	-		-	-
	· · ·							· · · · · · · · · · · · · · · · · · ·		1

- KEY TO ADDREVIATIONS :

AT ACOUSTIC TILE

CB CONCRETE BLOCK


CT CERAMIC TILE

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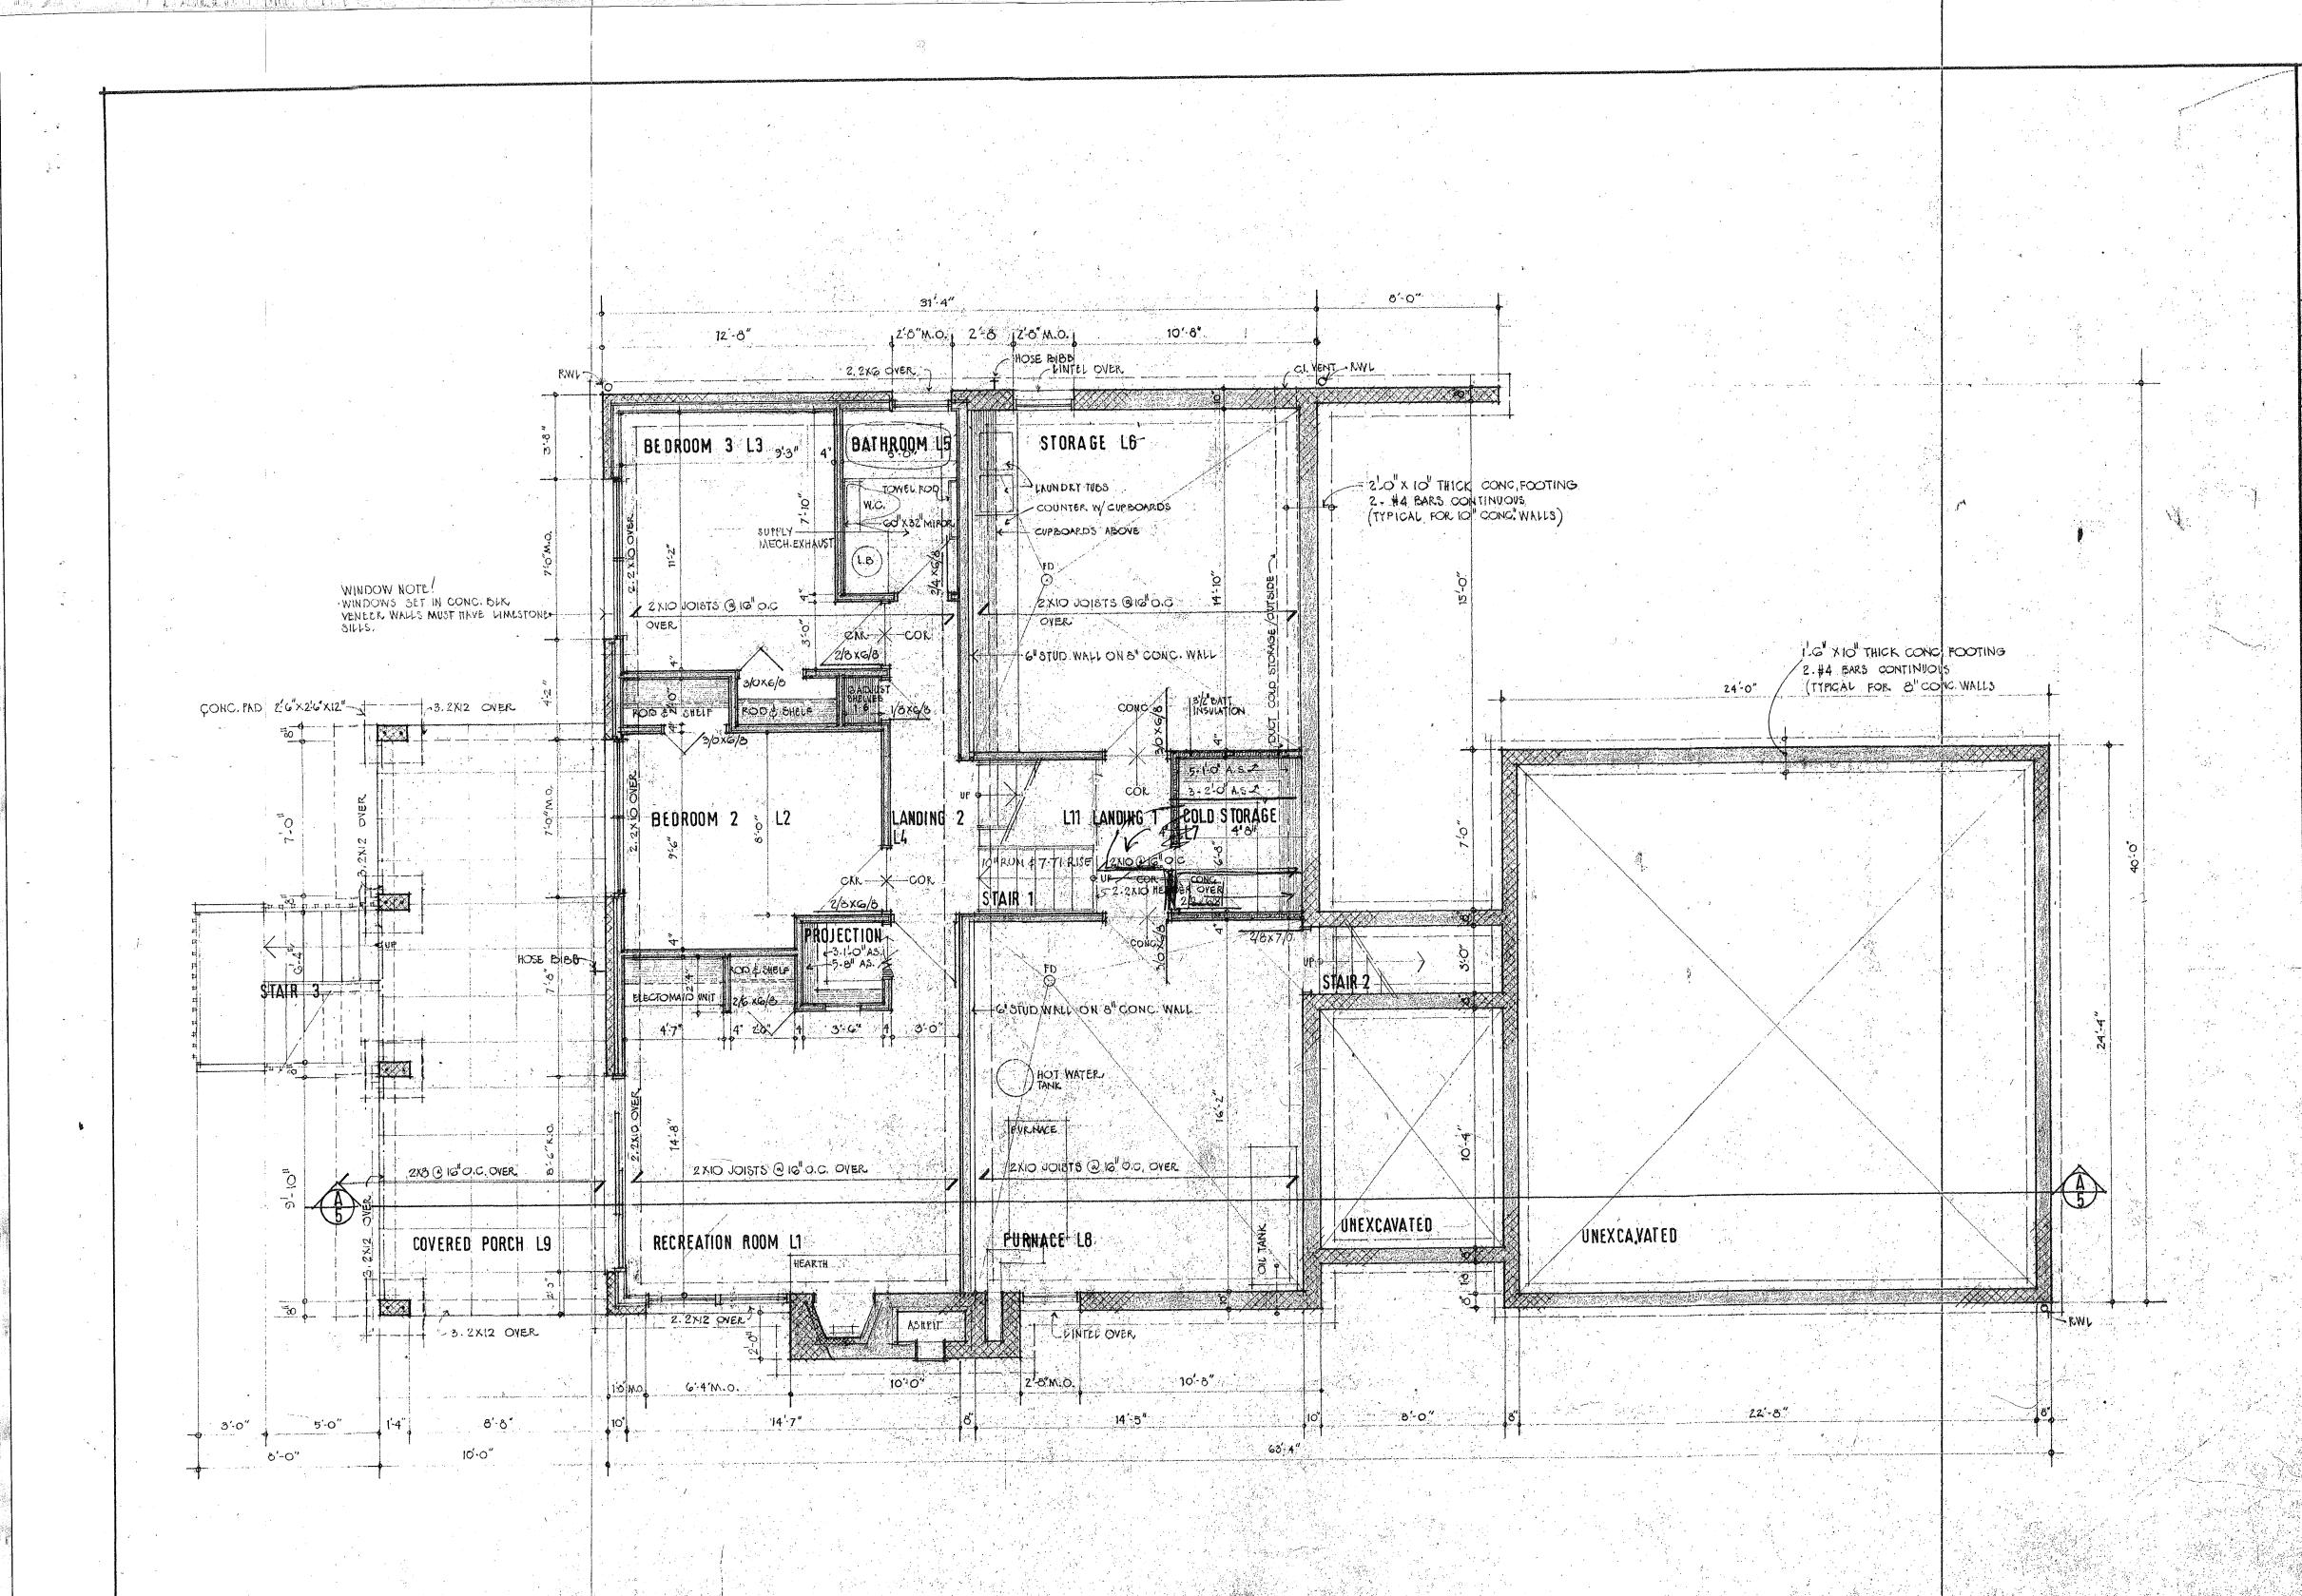
DW DRYWALL


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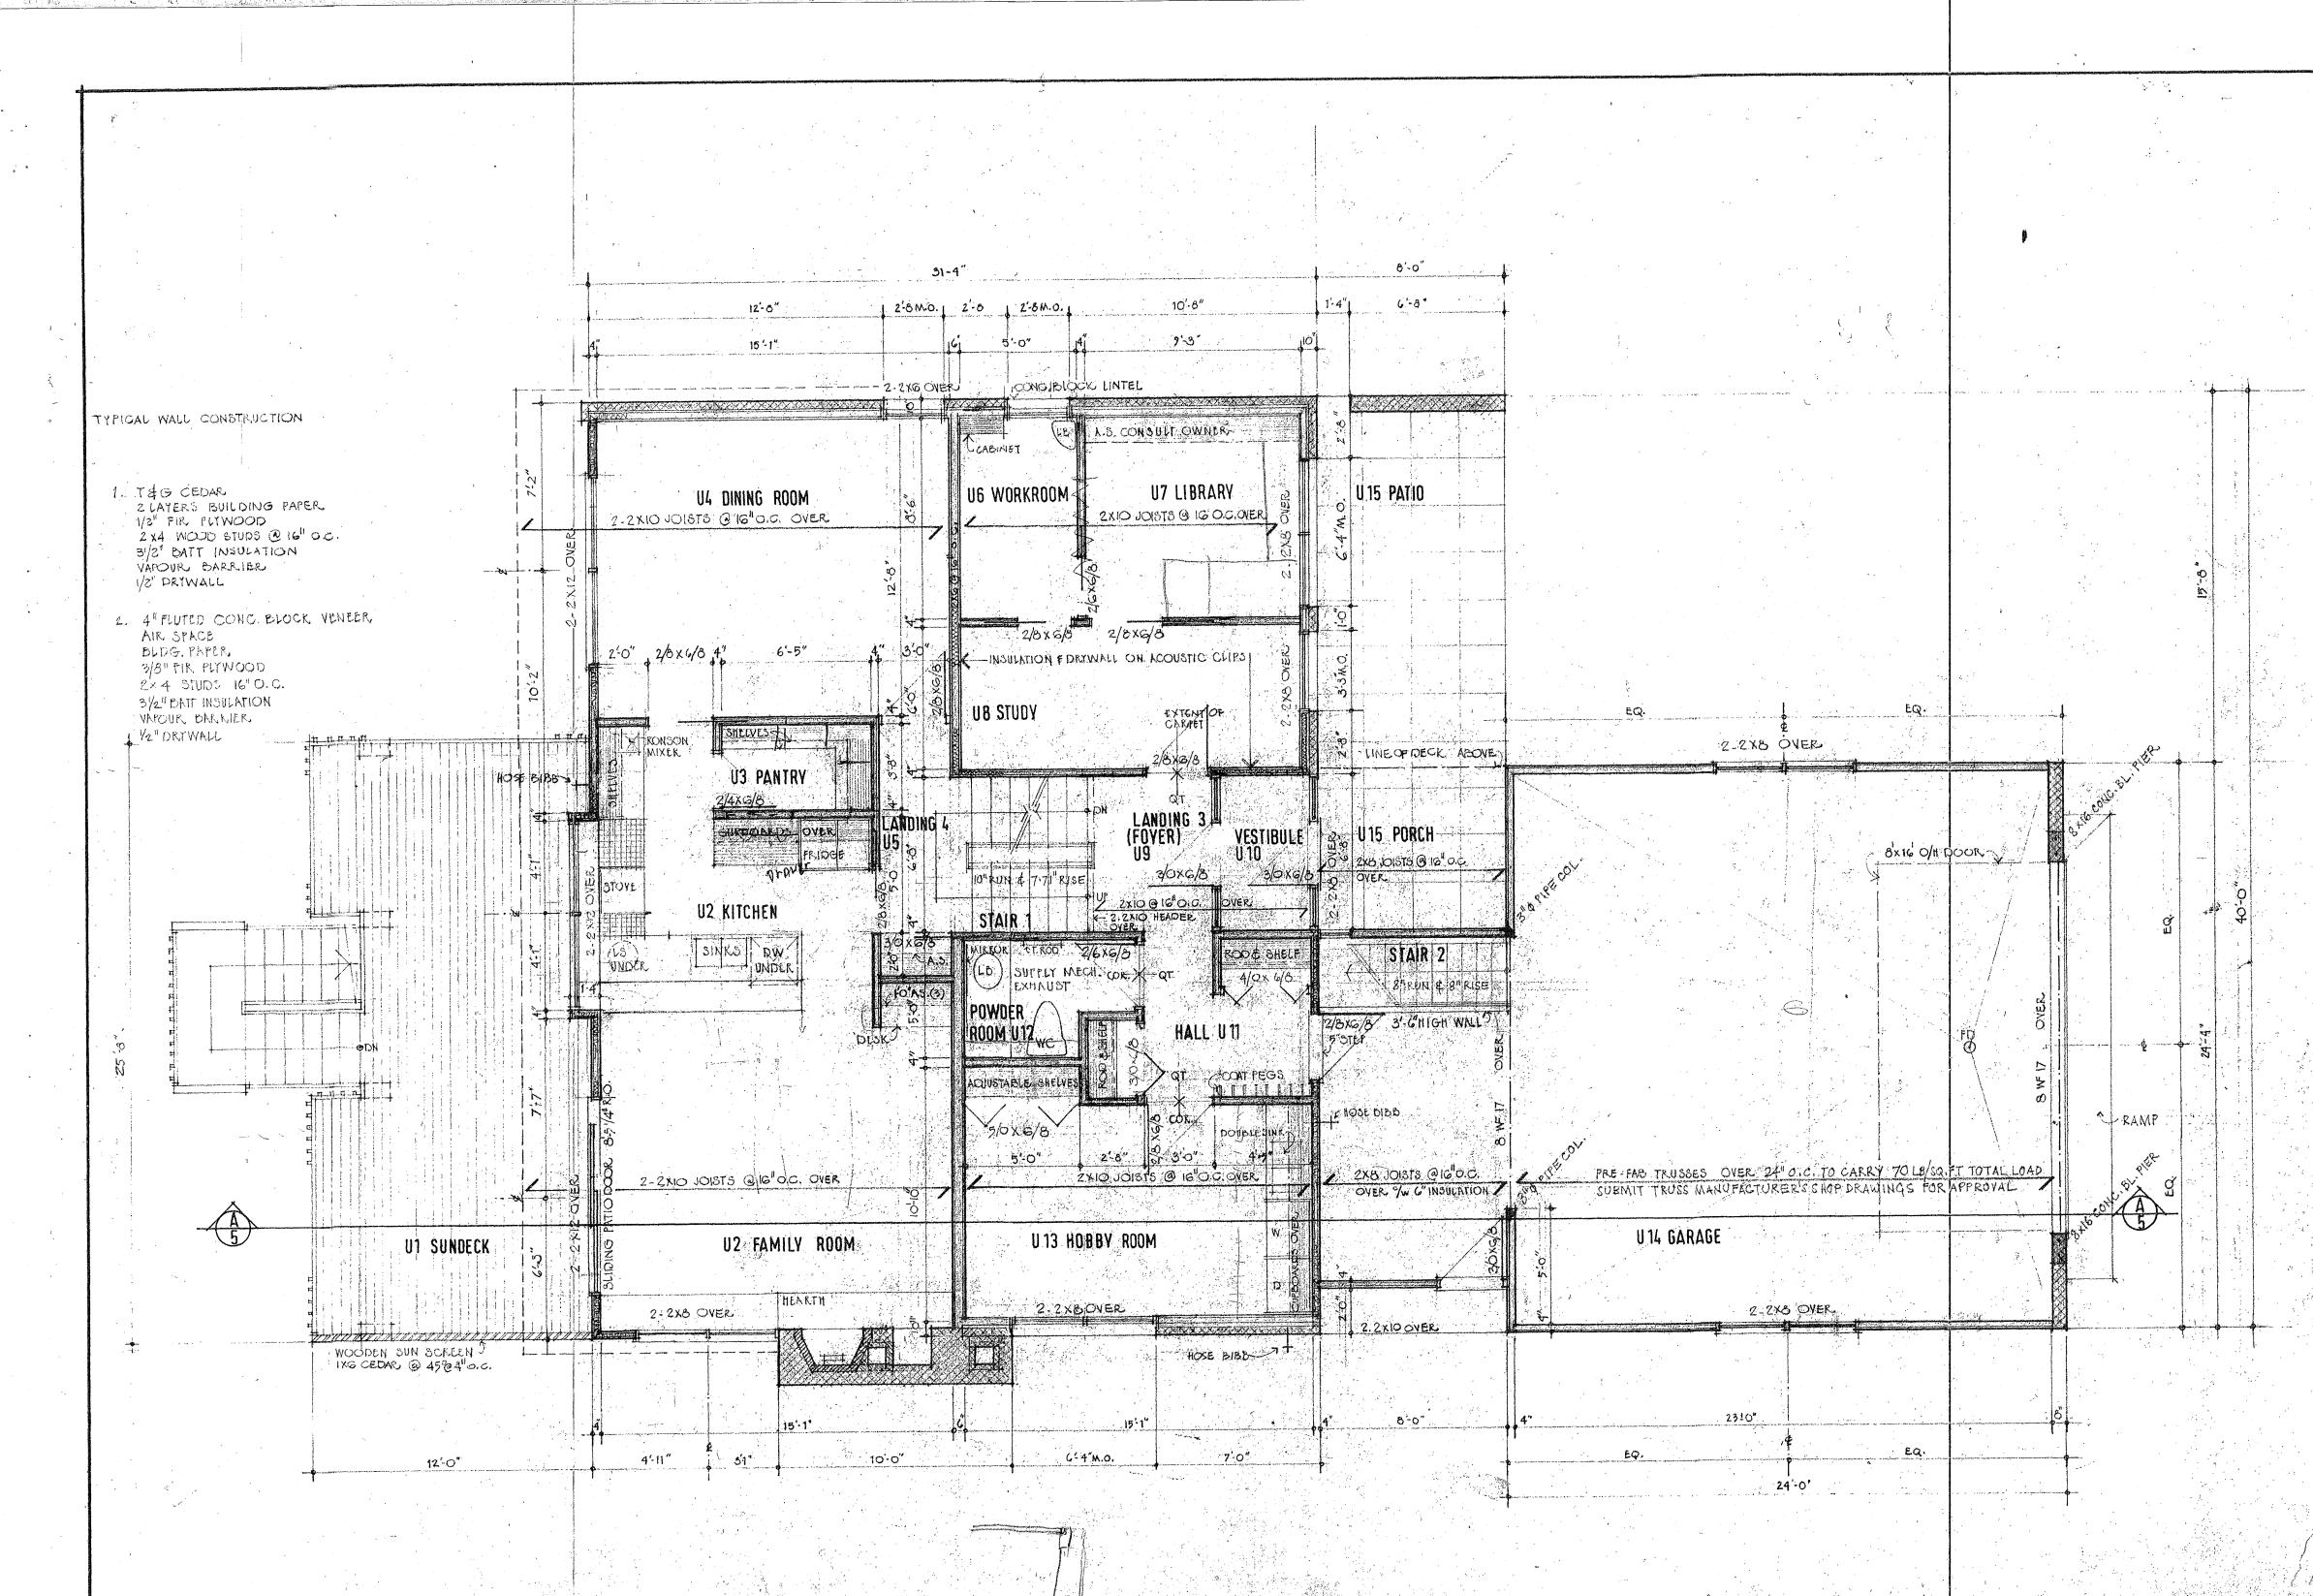
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4 3 2 ب ر 26/8/15 1 REVISED FOR CONSTRUCTION date no revision * 0 CONTRACTOR SHALL CHECK AND VERIFY ALL DIMENSIONS ON SITE AT HIS OWN RESPONSIBILITY CONSTRUCTION SĘT . MEMBER CHIT Z. MATTHEW STANKIEWICZ architect 126 york street ottawa k1n 5t5 tel. 235-3162 checked W drawn G.N. scale AS SHOWN date 23 JULY 1975 1.20 7419 job no. 0 وسيافي مراجع RAGAN HOUSE BILLINGS AVE. OTTAWA ONTARIO title FINISH SCHEDULE SITE PLAN rev. no. dwg no. ·A:1 /FX






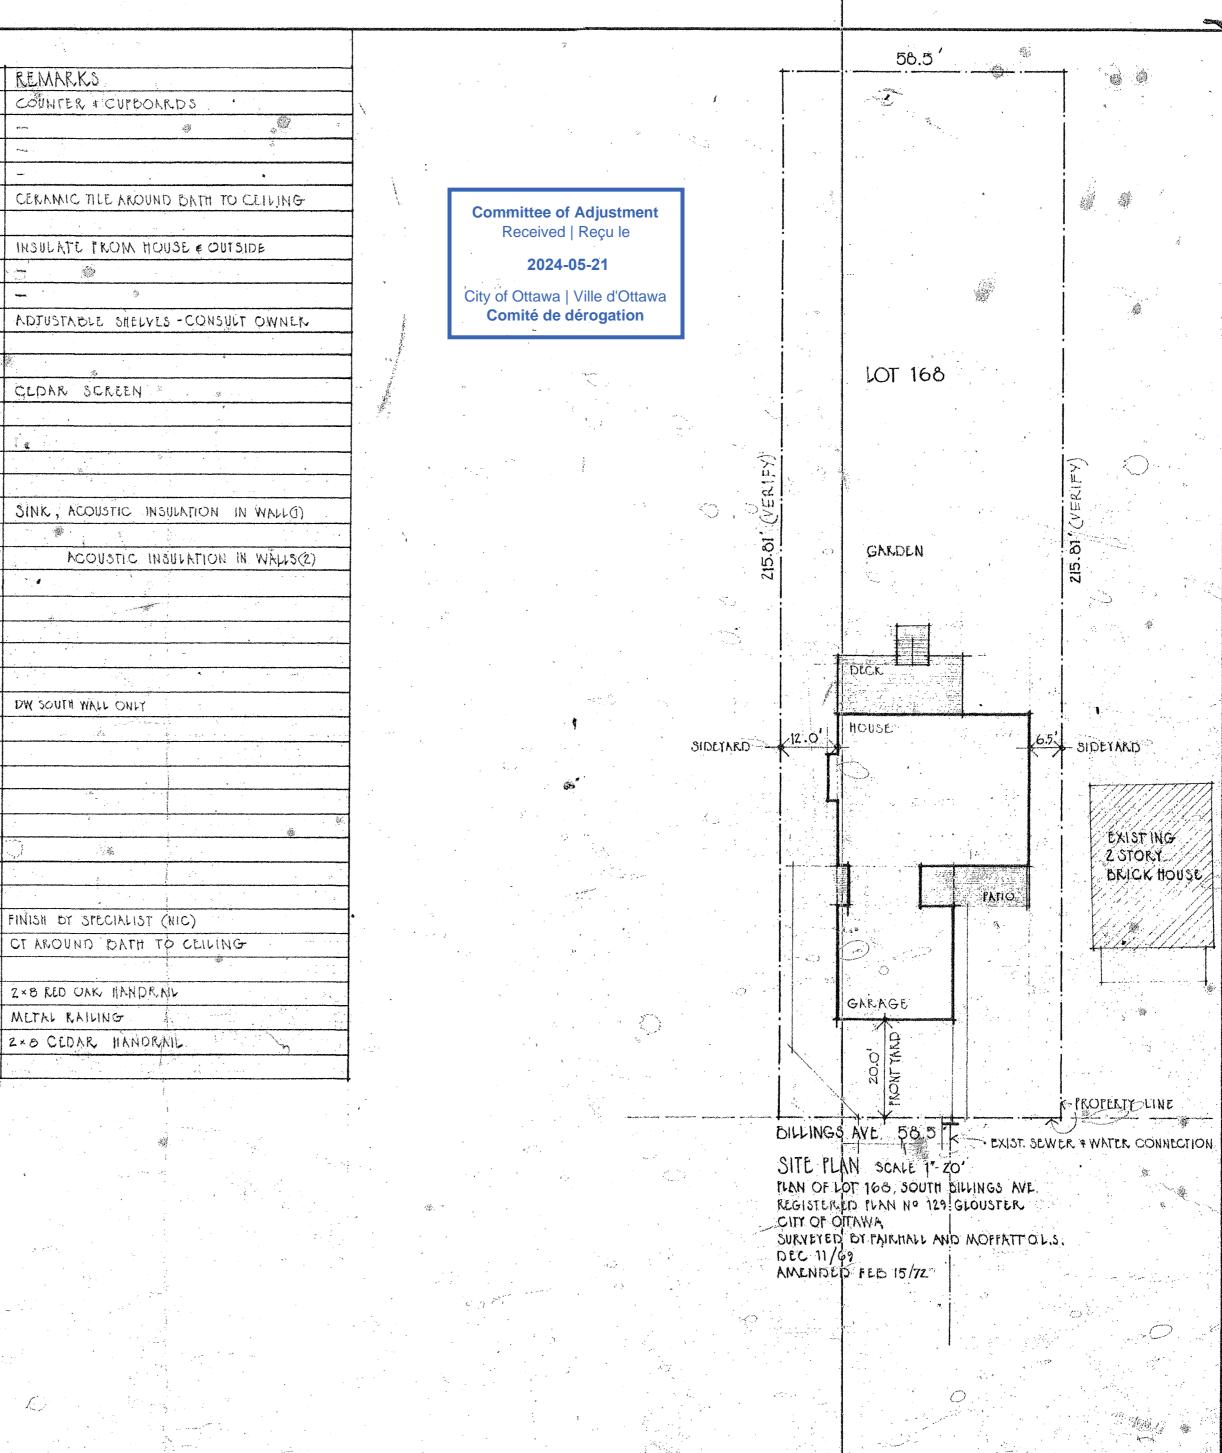


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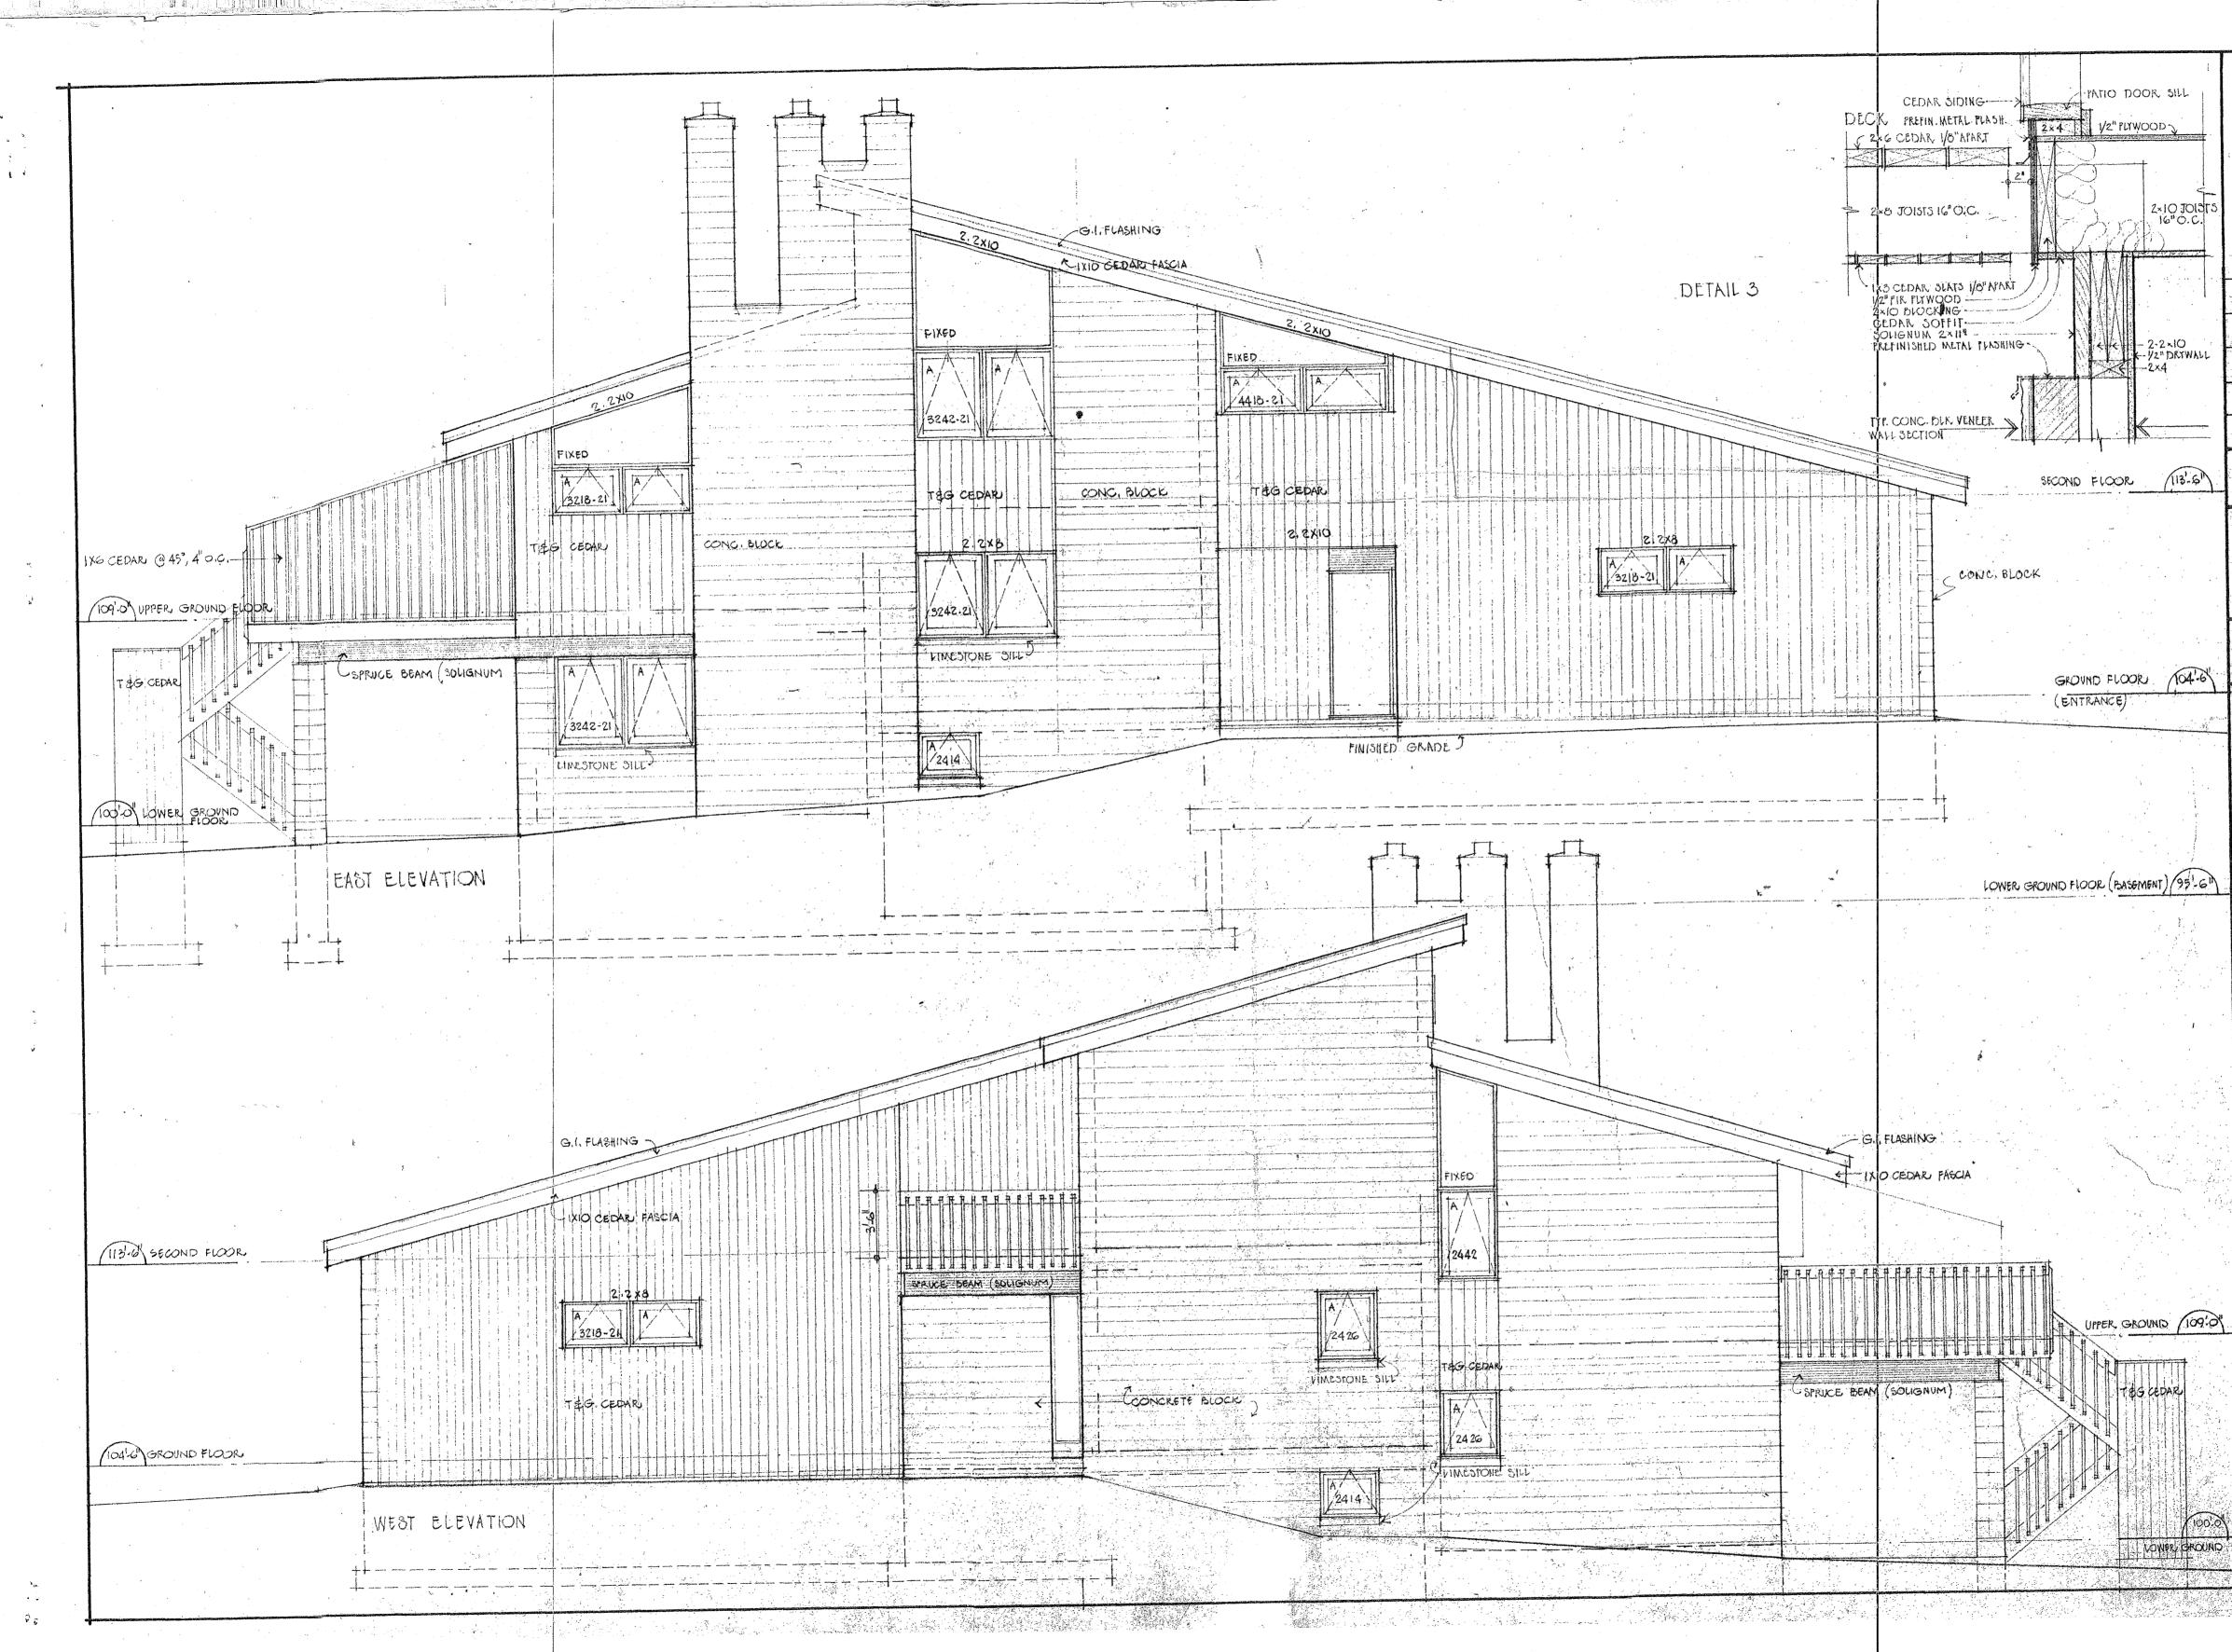
٠A 3 2 26/0/75 REVISED FOR CONSTRUCTION 1 date no revision CONTRACTOR SHALL CHECK AND VERIFY ALL DIMENSIONS ON SITE AT HIS OWN RESPONSIBILITY CONSTRUCTION SET MARMA Z. MATTHEW STANKIEWICZ architect 126 york street ottawa k1n 5t5 tel. 235-3162 checked Wy drawn GN/FSt scale 1/4"-1-0" date 23 JULY, 1975 -7419 job no. RAGAN HOUSE BILLINGS AVE. OTTAWA ONTARIO and filling title UPPER GROUND FLOOR dwg no. A·3 rev. no. ALX:

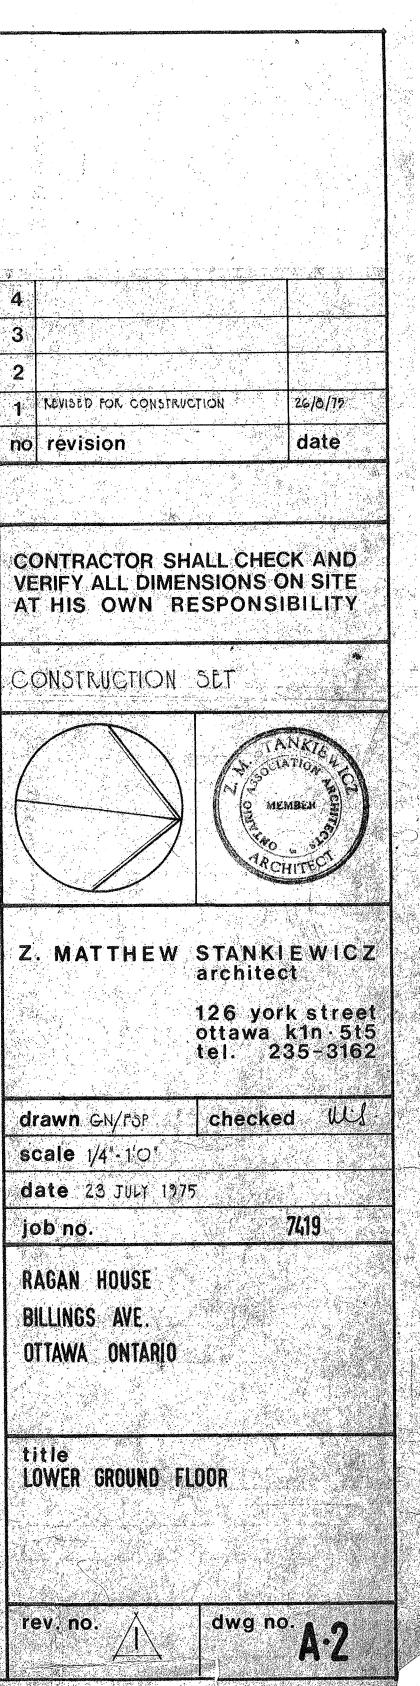

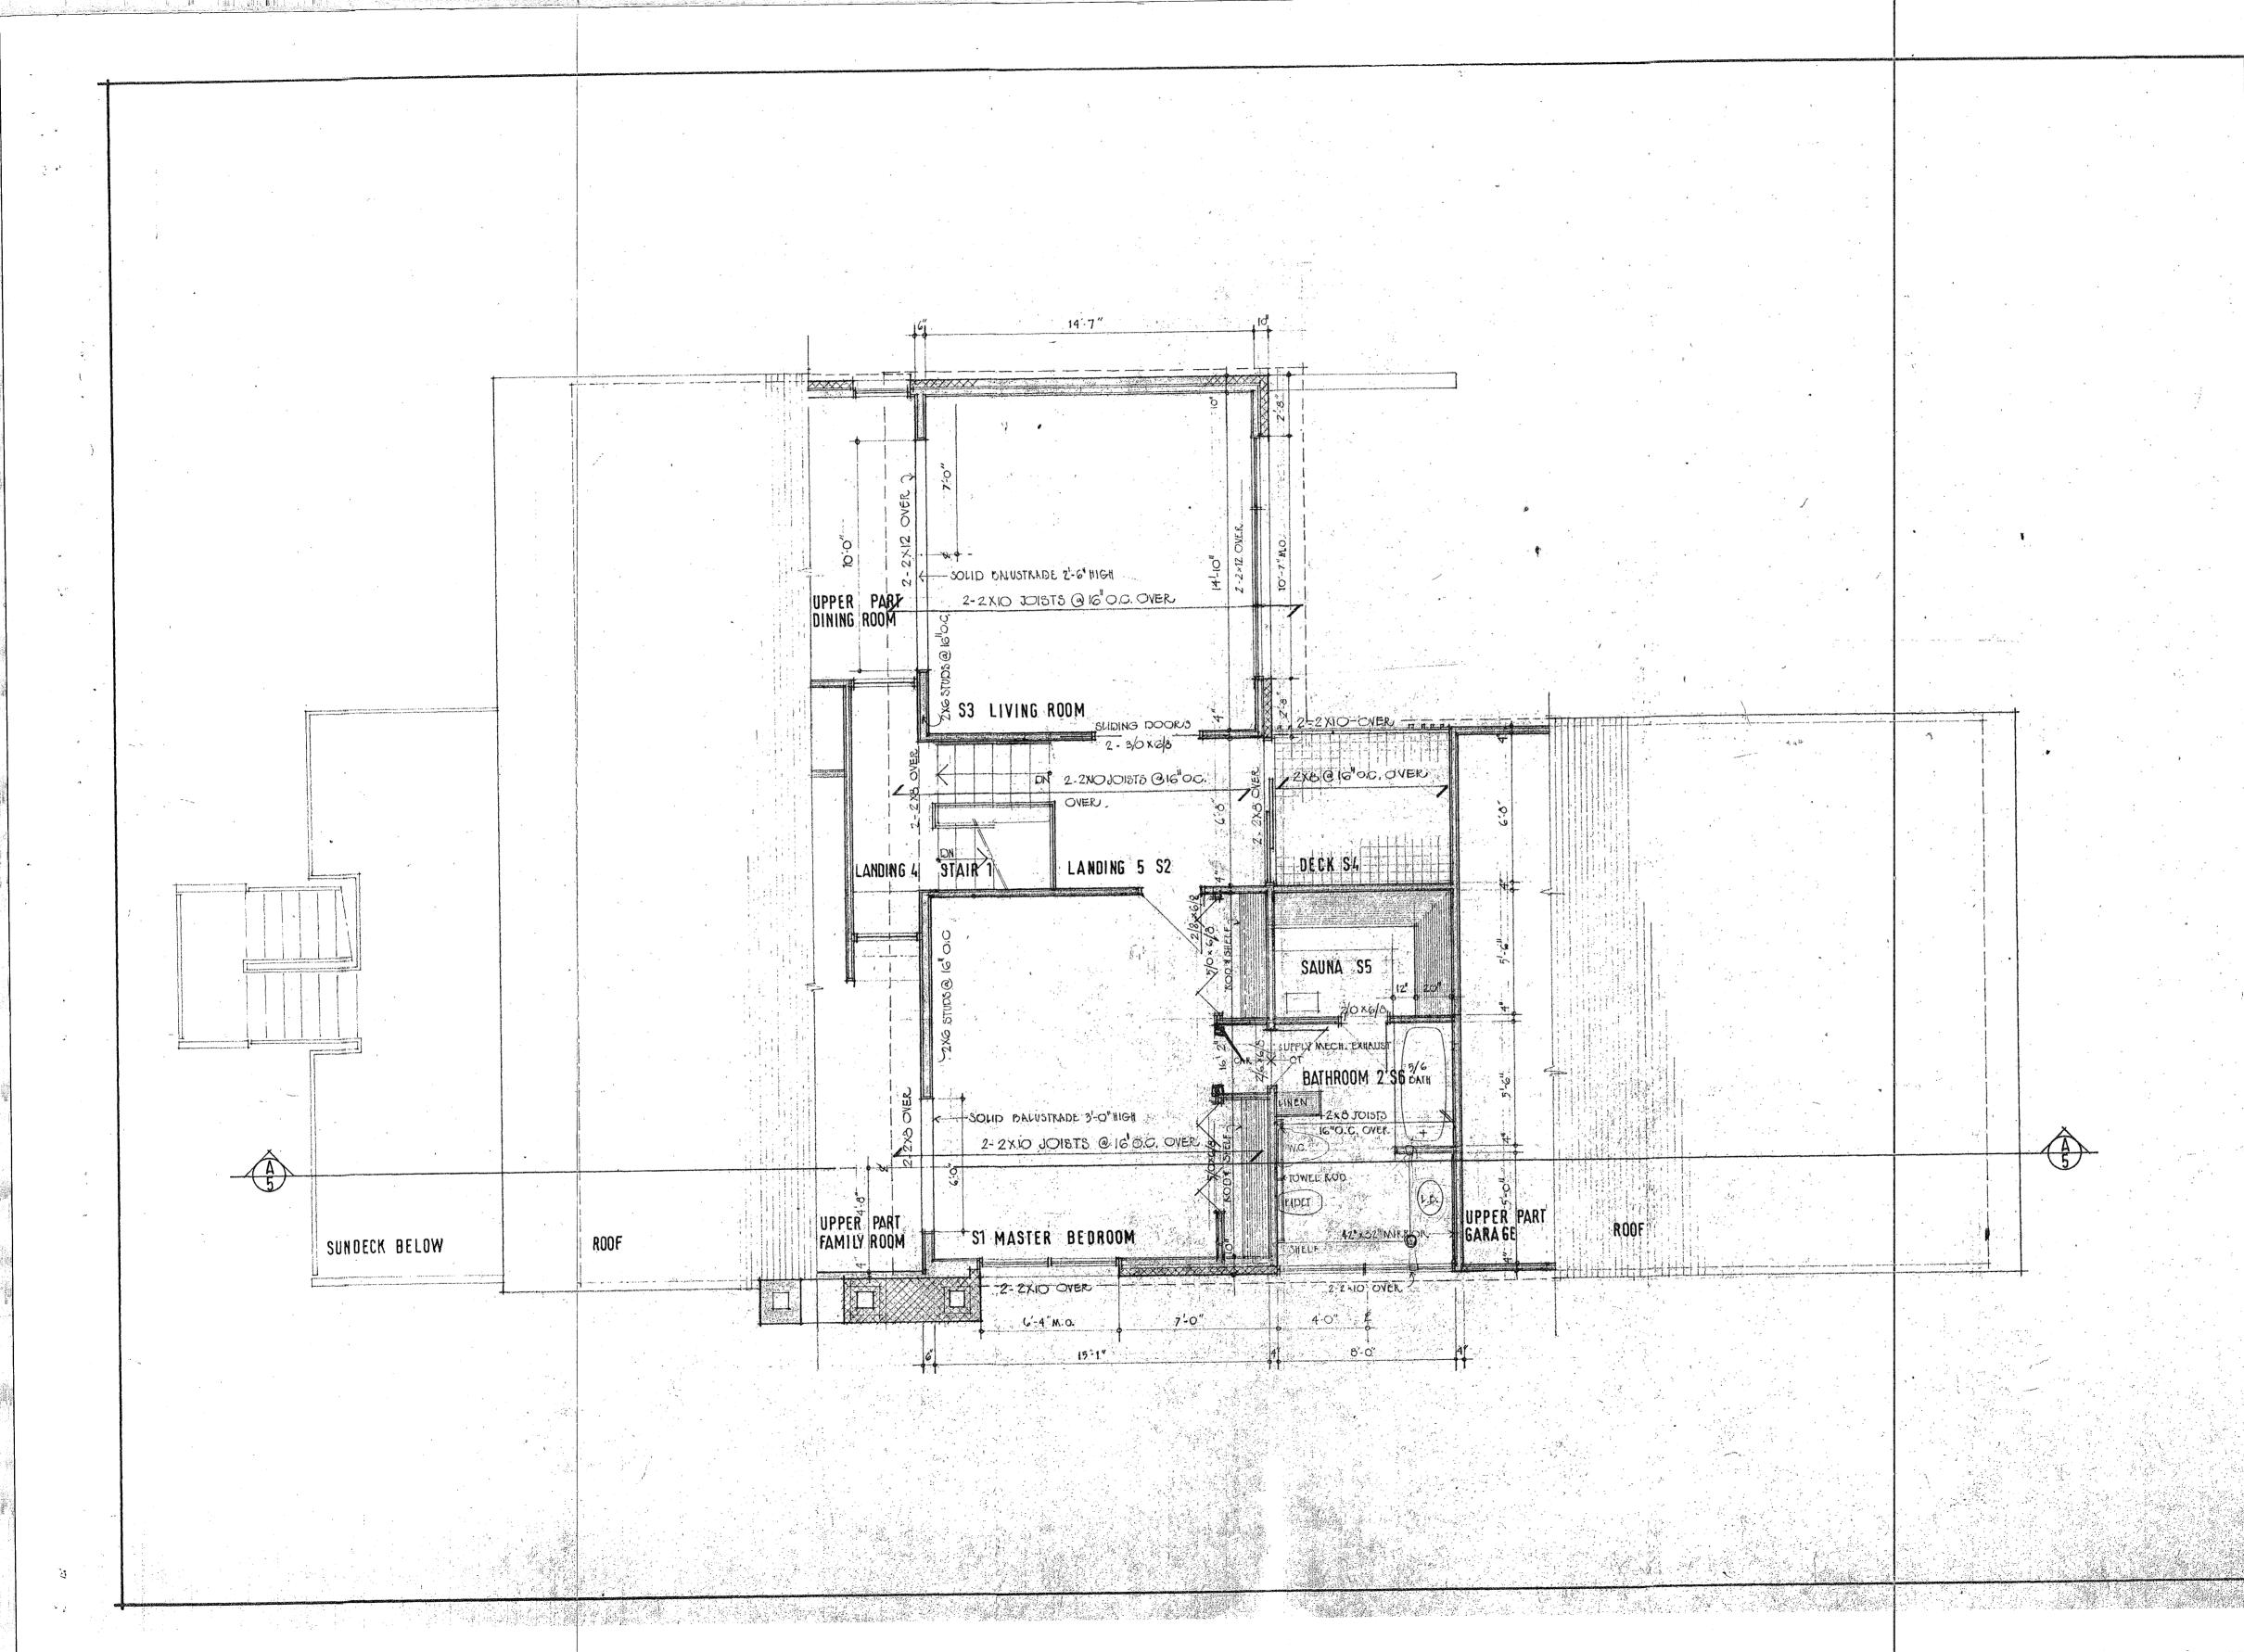4 3 2 REVISED FOR CONSTRUCTION 26/8/75 1 date no revision CONTRACTOR SHALL CHECK AND VERIFY ALL DIMENSIONS ON SITE AT HIS OWN RESPONSIBILITY CONSTRUCTION SET MEMBE Z. MATTHEW STANKIEWICZ architect 126 york street ottawa k1n · 5t5 tel. 235-3162 checked W.J. drawn GN/FSP scale 1/4 "-1'o" date 23 JULY 1975 7419 job no. RAGAN HOUSE BILLINGS AVE. OTTAWA ONTARIO title Second Floor rev. no. dwg no. 🔒 · A.4

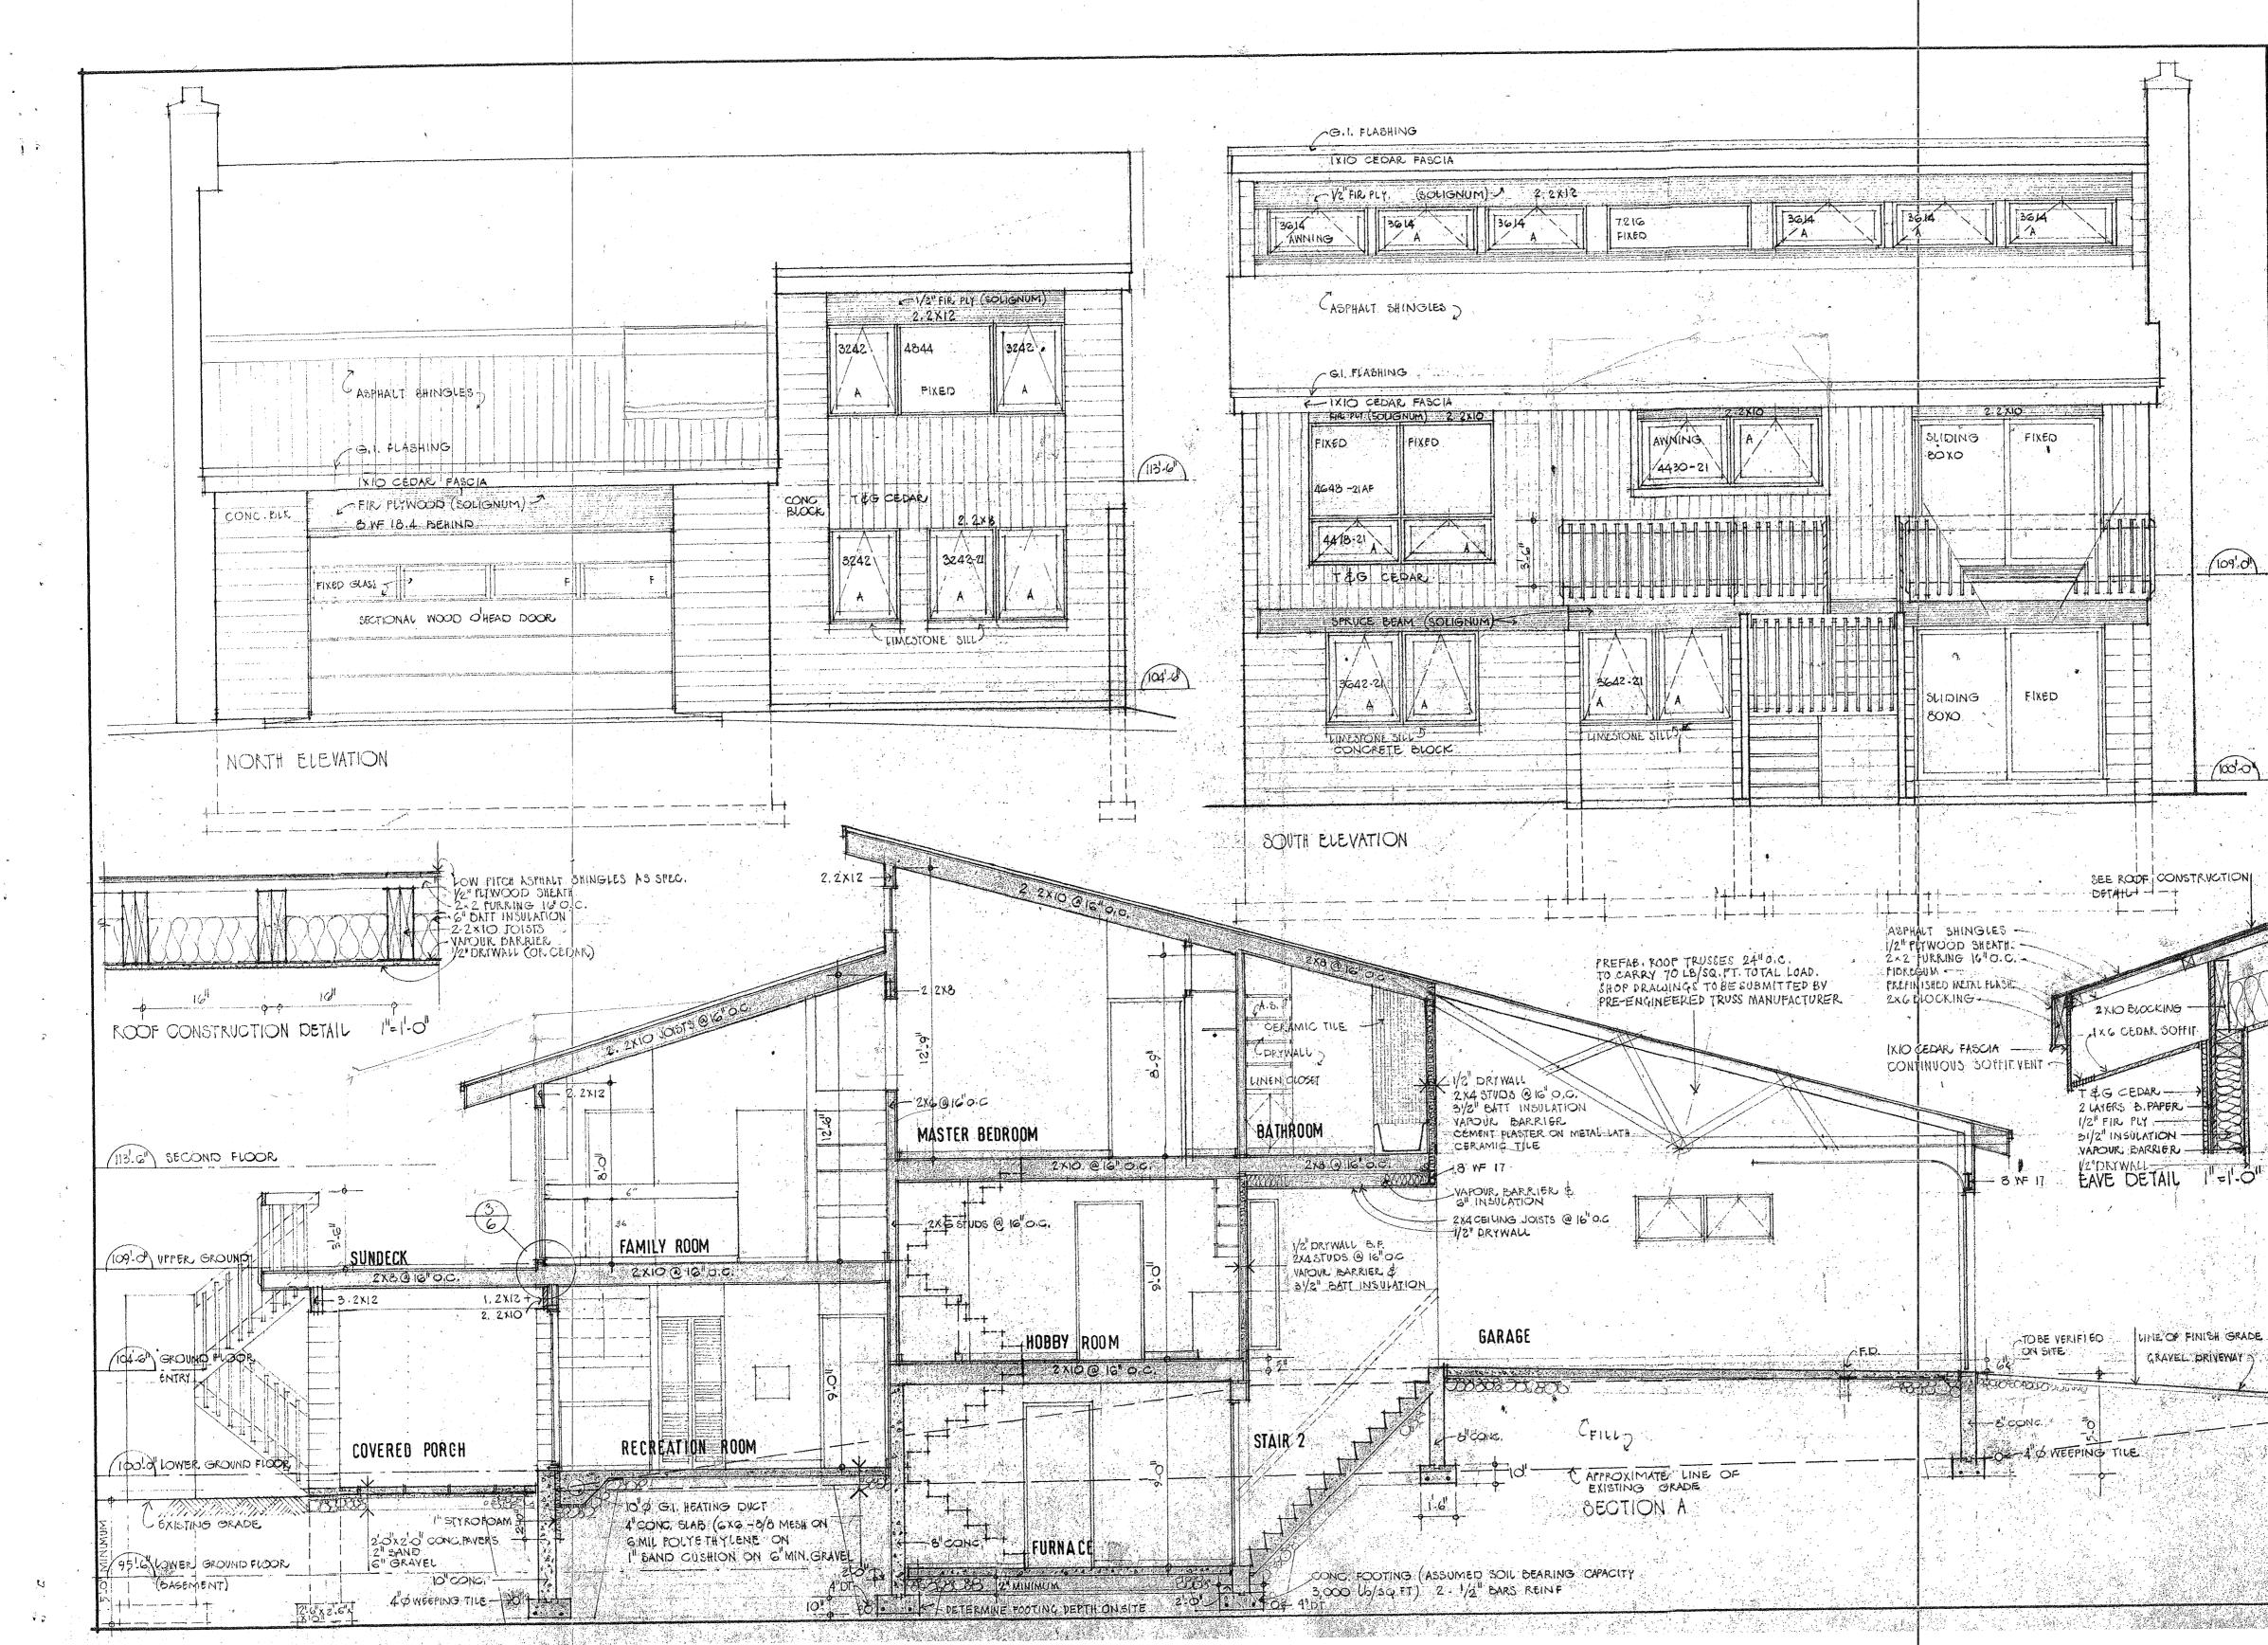

3 2 26/8/73 REVISED FOR CONSTRUCTION. date no revision CONTRACTOR SHALL CHECK AND VERIFY ALL DIMENSIONS ON SITE AT HIS OWN RESPONSIBILITY CONSTRUCTION SET Z. MATTHEW STANKIEWICZ architect 126 york street ottawa k1n·5t5 tel. 235-3162 checked WU drawn Far scale 1/4"-1-0" date 23 JULY 1975 1.5 7419 job no. RAGAN HOUSE BILLINGS AVE. OTTAWA ONTARIO title ELEVATIONS SECTION dwg no. rev. no. `A·5



a the state of the second s 3 2 KLYISED FOR CONSTRUCTION 26/8/15 date no revision CONTRACTOR SHALL CHECK AND VERIFY ALL DIMENSIONS ON SITE AT HIS OWN RESPONSIBILITY CONSTRUCTION SET MEMBE Z. MATTHEW STANKIEWICZ architect 126 york street ottawa k1n·5t5 tel. 235-3162 checked drawn GN/TSP scale 1/4".1'.0" + 11/2"-1-0" date 23 JULY 1975 7419 job no. RAGAN HOUSE BILLINGS AVE OTTAWA ONTARIO title Elevations dwg no. A·6 rev, no. Δ