

tm	ent	
le		

Notes & Legend

	Denotes	
-0	н	Survey Monument Planted
	н	Survey Monument Found
SIB		Standard Iron Bar
SSIB	н	Short Standard Iron Bar
IB	11	Iron Bar
(WIT)	н	Witness
Meas.		Measured
(AOG)		Annis, O'Sullivan, Vollebekk Ltd.
Prop.	^а н 2,	Proportioned
Acc.		Accepted
N/S		North-South
(PI)		Registered Plan 43586
(P2)	U	Plan 4R-31826
(P3)	u	Plan 4R-19675
(P4)		Plan 5R-14111
(P5)		Plan 5R-14860
(P6)		Plan 5R-7224
(P7)		(857) Plan Dated May 10, 1990
(P8)		(647) Plan Dated October 10, 1979
(DI)	<u>e</u> .	Instrument No. CR413616
O MH-S		Maintenance Hole (Sanitary)
O MH-H		Maintenance Hole (Hydro)
OMH		Maintenance Hole (Unidentified)
O LS		Light Standard
СВ	u ~ ~	Catch Basin
- $\dot{\mathbf{Q}}_{\mathbf{FH}}$	н о	Fire Hydrant
Ø WV		Water Valve
• SP		Water Stand Post
T/G	а — — — — — — — — — — — — — — — — — — —	Top of Grate
品		Gas Meter
o TB	- u	Unidentified Terminal Box
ΔS	U	Sign
BF		Board Fence
CPB		Concrete Planter Border
WPB		Wooden Planter Border
EF		East Face
RWS		Stone Retaining Wall
RWC		Concrete Retaining Wall
EOC		Edge of Concrete
O PO-M		Metal Pole
Ø		Diameter
+ 65.00		Location of Elevations
+ 65.00		Top of Concrete Curb Elevation
~		and Retaining Wall Elevation
(·)		Deciduous Tree
N/L		
*	н.	Coniferous Tree
Fdn.		
		Foundation
Bdg. R/W		Building
		Right-Of-Way

Bearings are grid, derived from Can-Net 2016 Real Time Network GPS observations and are referenced to Specified Control Points 01919680005 and 01919680105, MTM Zone 9 (76°30' West Longitude) NAD-83 (original).

For bearing comparisons, a rotation of 0°34'50" counter-clockwise was applied to bearings on plan P1. A rotation of 0°49'20" counter-clockwise was applied to bearings on plans P4, P5 and P6.

ASSOCIATION OF ONTARIO

LAND SURVEYORS

PLAN SUBMISSION FORM

V-90465

THIS PLAN IS NOT VALID UNLESS

IT IS AN EMBOSSED ORIGINAL

COPY ISSUED BY THE SURVEYOR

In accordance with

Regulation 1026, Section 29 (3).

SURVEYOR'S REAL PROPERTY REPORT PART 1 Plan of

PART OF LOT 9 SOUTH CLARENCE STREET **REGISTERED PLAN 43586 CITY OF OTTAWA**

Surveyed by Annis, O'Sullivan, Vollebekk Ltd. Scale 1:150

DISTANCES SHOWN ON THIS PLAN ARE IN METRES AND CAN BE CONVERTED TO FEET BY DIVIDING BY 0.3048

Surveyor's Certificate


I CERTIFY THAT :


1. This survey and plan are correct and in accordance with the Surveys Act, the Surveyors Act and the regulations made under them. 2. The survey was completed on the 22nd day of October, 2024.

Oct. 31, 2024

T. Hartwick Ontario Land Surveyor

PART 2 THIS PLAN MUST BE READ IN CONJUNCTION WITH SURVEY REPORT DATED: October 31, 2024

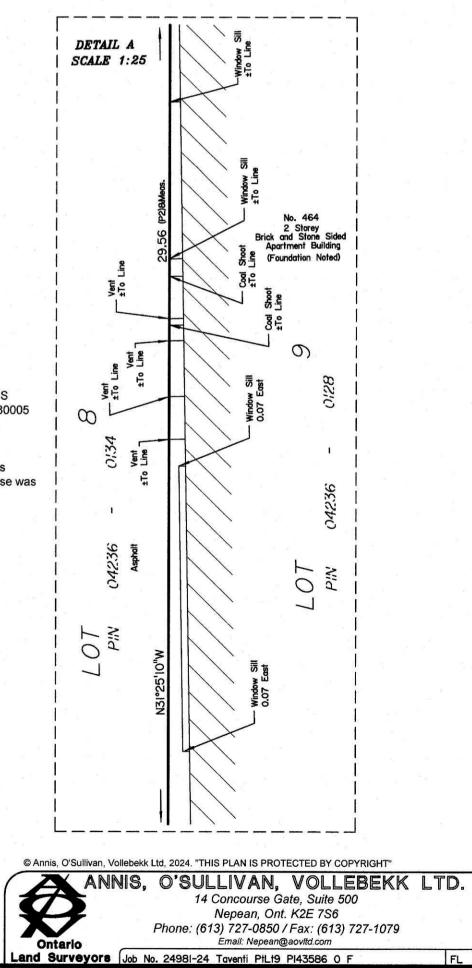

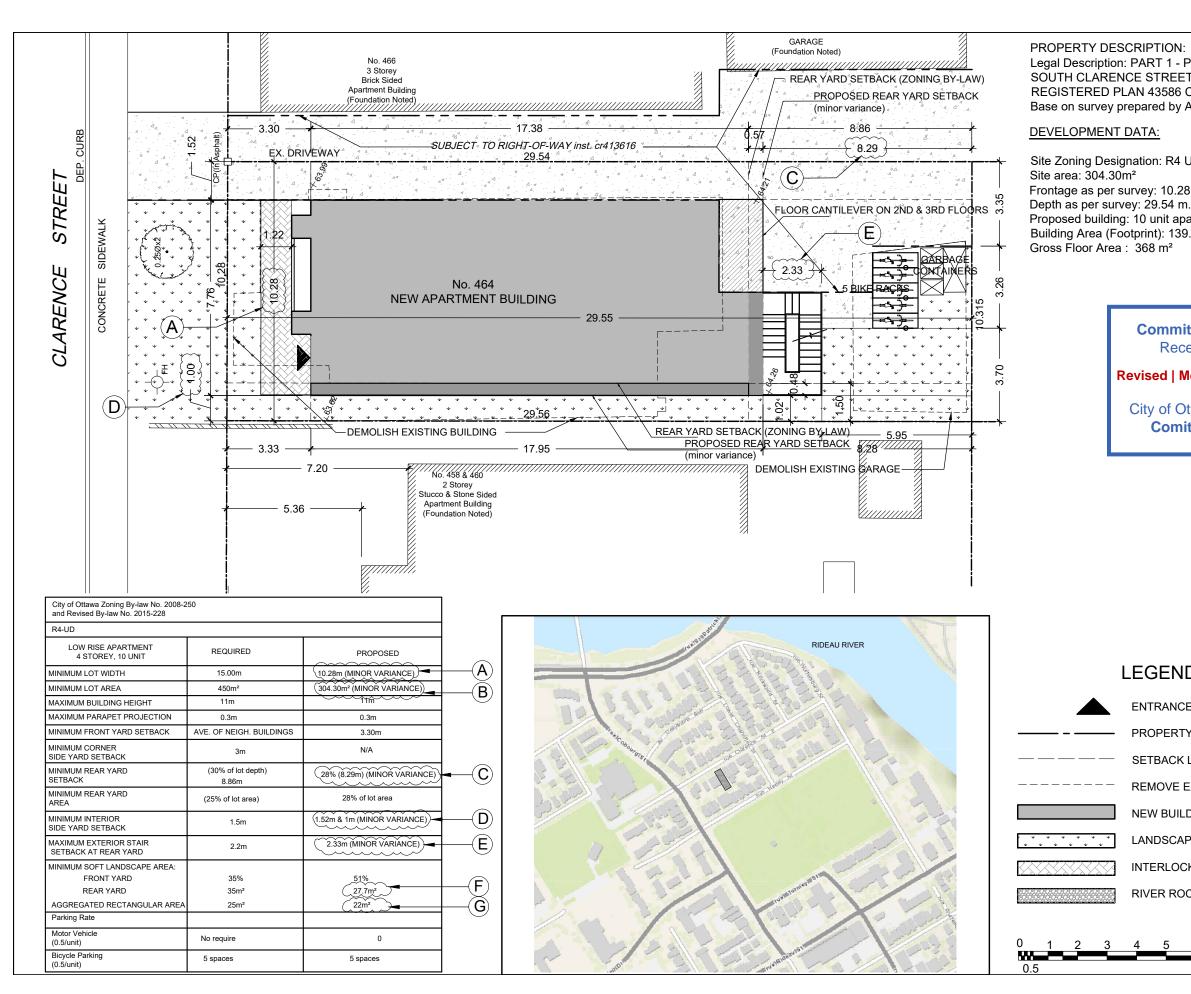

: Plan of PART OF LOT 9 :T CITY OF OTTAWA Annis, O'Sullivan, Vollebekk Ltd.	NEW APARTMENT BUILDING 464 CLARENCE ST. OTTAWA, ON	
UD 8 m. n. partment 9.2 m² (46% lot coverage)	CLIENT:	
ittee of Adjustment eived Reçu le Modifié le : 2025-03-14	PROJECT NORTH	
ottawa Ville d'Ottawa ité de dérogation		
	SUSAN D. SMITH ARCHITECT 941 MERIVALE RD Ottawa, Ontario 613-722-5327 S.SMITH@SDSARCH.CA	
D: E	3	
Y LINE LINE EXISTING WALL DING	No. REVISION DATE NOTES: 1. All dimensions are to be checked on site. Discrepancies or ambiguities should be reported prior to work on site or ordering of materials. 2. All work to be in accordance with the Ontario Building Code, latest edition.	
PE AREA CKING WALKWAY ICK	SITE PLAN	
6 7 8 9 10	Drawn TD Checked SDS Date JUL/2024 Job # 2435	

