



DO NOT SCALE THESE DRAWINGS.

DRAWINGS NOT TO BE USED FOR CONSTRUCTION UNTIL APPROVED BY IN WRITING FROM THE APPOINTED DESIGNER.

CONDITIONS PRIOR TO THE COMMENCEMENT OF ANY WORK. ALL ERRORS, OMISSIONS AND DISCREPANCIES ARE TO BE FORWARDED IN WRITING WITHIN TWO (2) BUSINESS DAYS, UPON DISCOVERY. THE ABOVE MAY PROCEED CONTINGENT UPON MUTUAL AGREEMENT BETWEEN APPOINTED DESIGNER AND CONTRACTOR.

CONTRACTOR(S) RESPONSIBLE FOR THE CORRECT APPLICATION OF SPECIFIED MATERIALS AND SYSTEMS (ONLY TO BE SUPERCEDED BY THESE DRAWINGS, IF

THE APPOINTED DESIGNER DOES NOT ASSUME ANY RESPONSIBILITY AND / OR LIABILITY IF THE ABOVE CONDITIONS ARE NOT MET.


| NO. | DESCRIPTION | DATE |
|-----|----------------------------|-------------|
| 1 | ISSUED FOR INTERNAL REVIEW | JAN/07/2025 |
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10-UNIT LOW-RISE APARTMENT DWELLING: 287 SHAKESPEARE STREET, VANIER, ON, K1L 5M3

LEFT (WEST) ELEVATION

SCALE: 3/8" = 1'-0" SHEET NO.: PROJECT NO.: 0038 A404






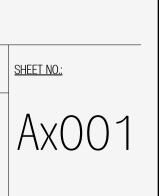



CAM - NORTHEAST FRONT VIEW @ WALKWAY



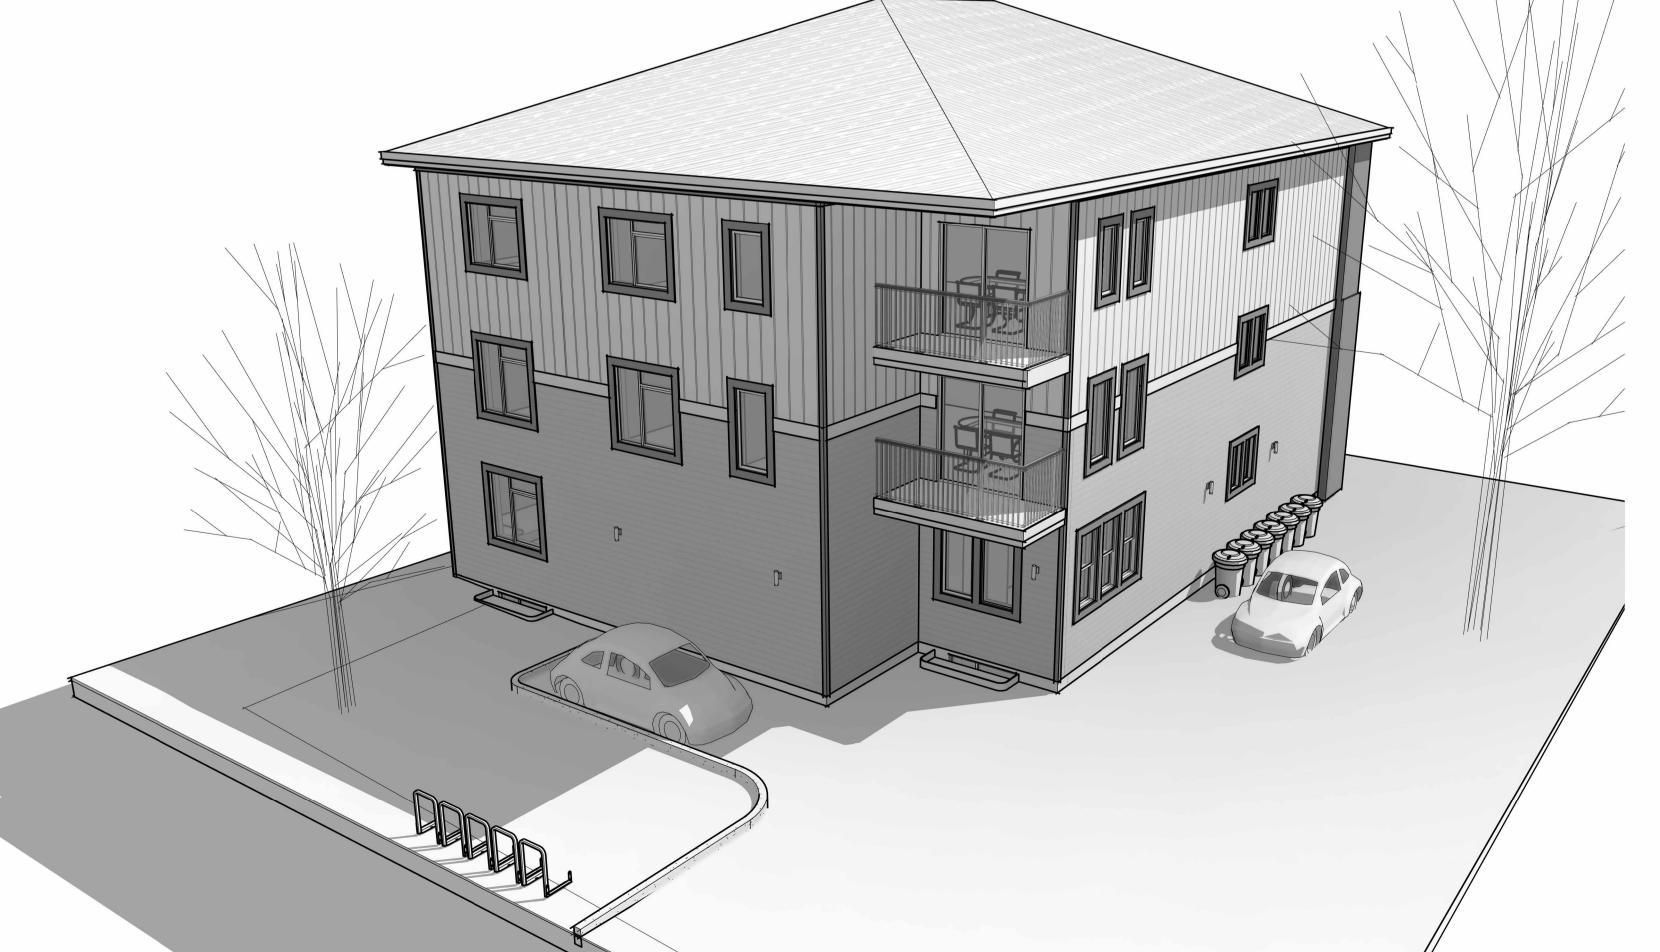



GENERAL NOTES:

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| NO. | DESCRIPTION | DATE |
|-----|----------------------------|------------|
| 1 | ISSUED FOR INTERNAL REVIEW | JAN/07/202 |
| 2 | ISSUED TO CofA | MAR/07/202 |
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| | | |

NORTH ARROW:

PROJECT TITLE: 10-UNIT LOW-RISE APARTMENT DWELLING: 287 SHAKESPEARE STREET, VANIER, ON, K1L 5M3

DRAWING NAME: VARIOUS PERSPECTIVE


DRAWN BY: CORY DUBEAU

REVIEWED BY:

VIEWS

PROJECT NO.: 0038

5 CAM - NORTHEAST REAR VIEW @ PARKING

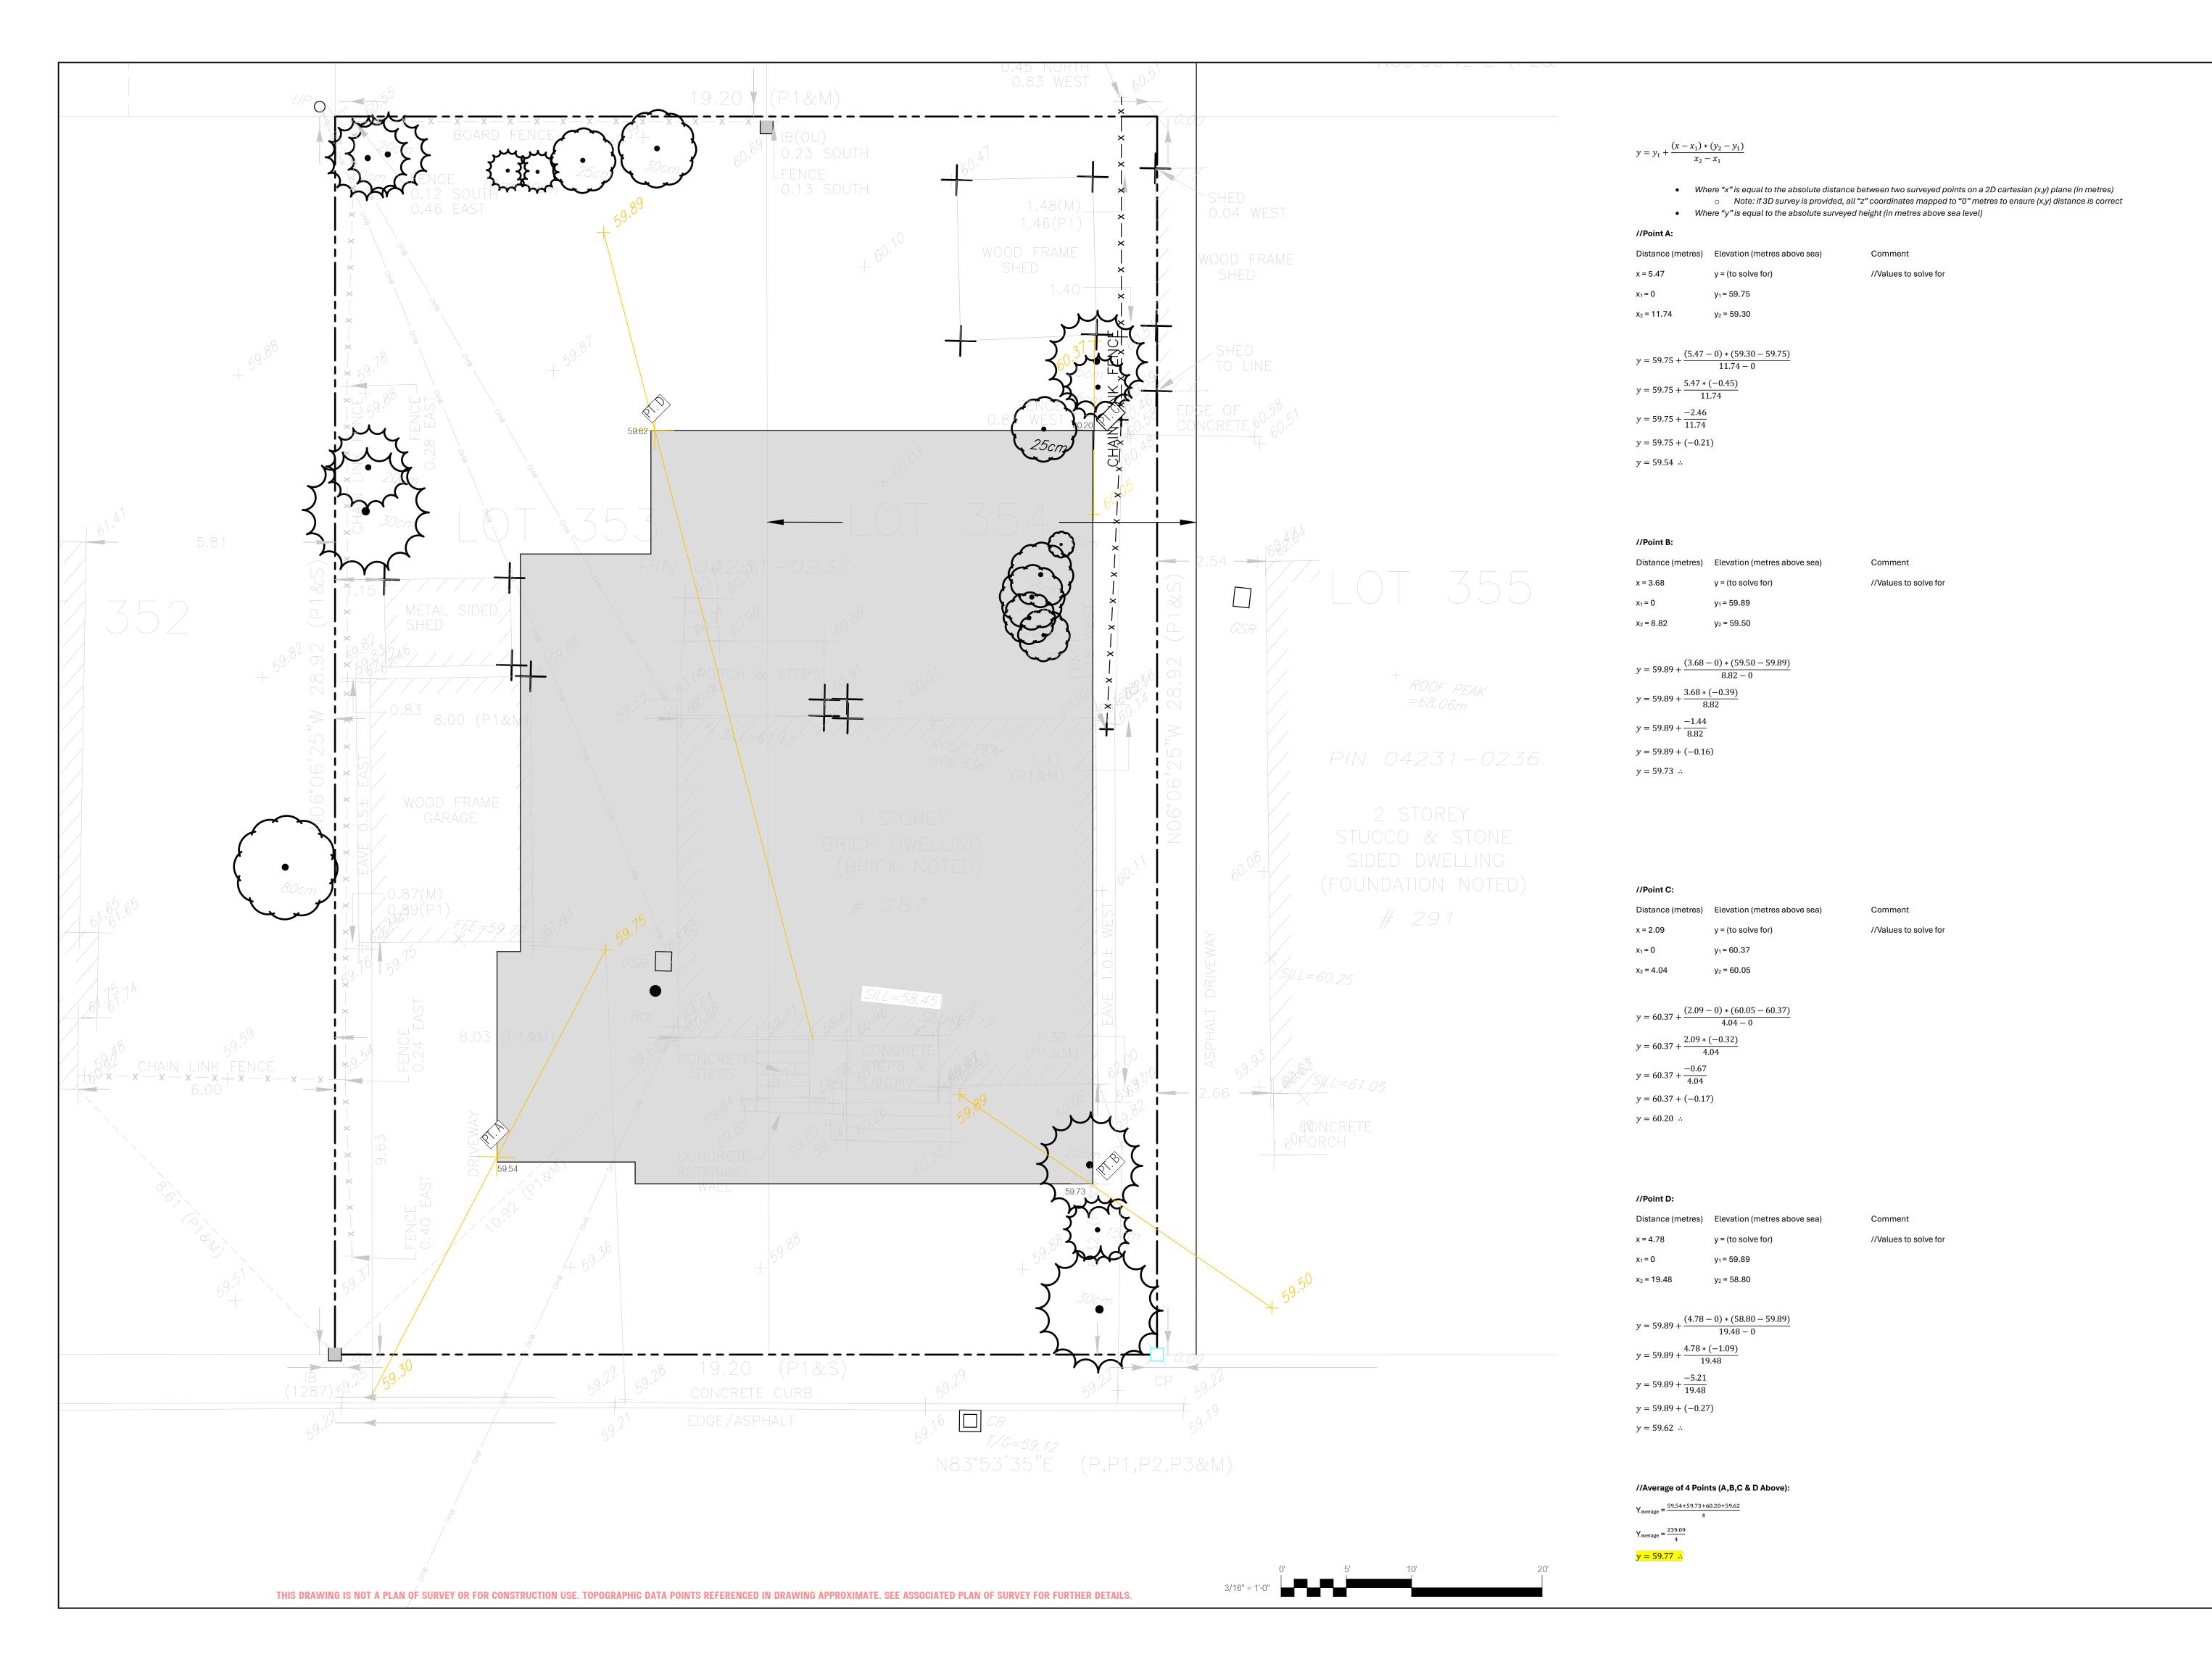

DRAWN BY: CORY DUBEAU CHECKED BY: P. HUME

SCALE: 3/16" = 1'-0" SHEET NUMBER:

PROJECT NO.: 0038

Committee of Adjustment
Received | Reçu le
2025-03-18

City of Ottawa | Ville d'Ottawa
Comité de dérogation

Replacement Tree Specifications

Note: Proposed tree locations are suggestions only and should be finalized only once construction is complete and should adhere to City of Ottawa Tree Planting Guidelines.

Trees 1-3 should be large trees at maturity. Site conditions are expected to full light exposure and moderate moisture availability. Species suggestions include:

White oak - *Quercus alba**

Red oak - *Quercus rubra**Freeman maple - *Acer x freemanii*

Tulip tree - *Liriodendron tulipifera*

Ginkgo - *Ginkgo biloba*

Liberty elm - *Ulmus americana* 'Libertas'*

Northern catalpa - Catalpa speciosa

Black walnut - Juglans nigra*

Kentucky coffee tree - *Gymnocladus dioicus*

Basswood - Tilia americana*

Hackberry - Celtis occidentalis*

Horsechestnut - Aesculus hippocastanum

Tree 2 and 3 could also be coniferous species. Suggestions include:

Colorado spruce - Picea pungens

White spruce - *Picea glauca**


Norway spruce - Picea abies


*Native to Ottawa region: Planting species native to a region can help maintain and enhance biodiversity.

Note: Norway maple (*Acer platanoides*) is *not* recommended as it is highly invasive and not a suitable tree for urban planting.

The species recommended herein are the most suitable species based on the existing plans. For best success, tree species should be matched to site conditions.


All deciduous trees must be a minimum of 50 mm in diameter measured no less than 15 cm above ground level. Coniferous trees must be no less than 200 cm in height.

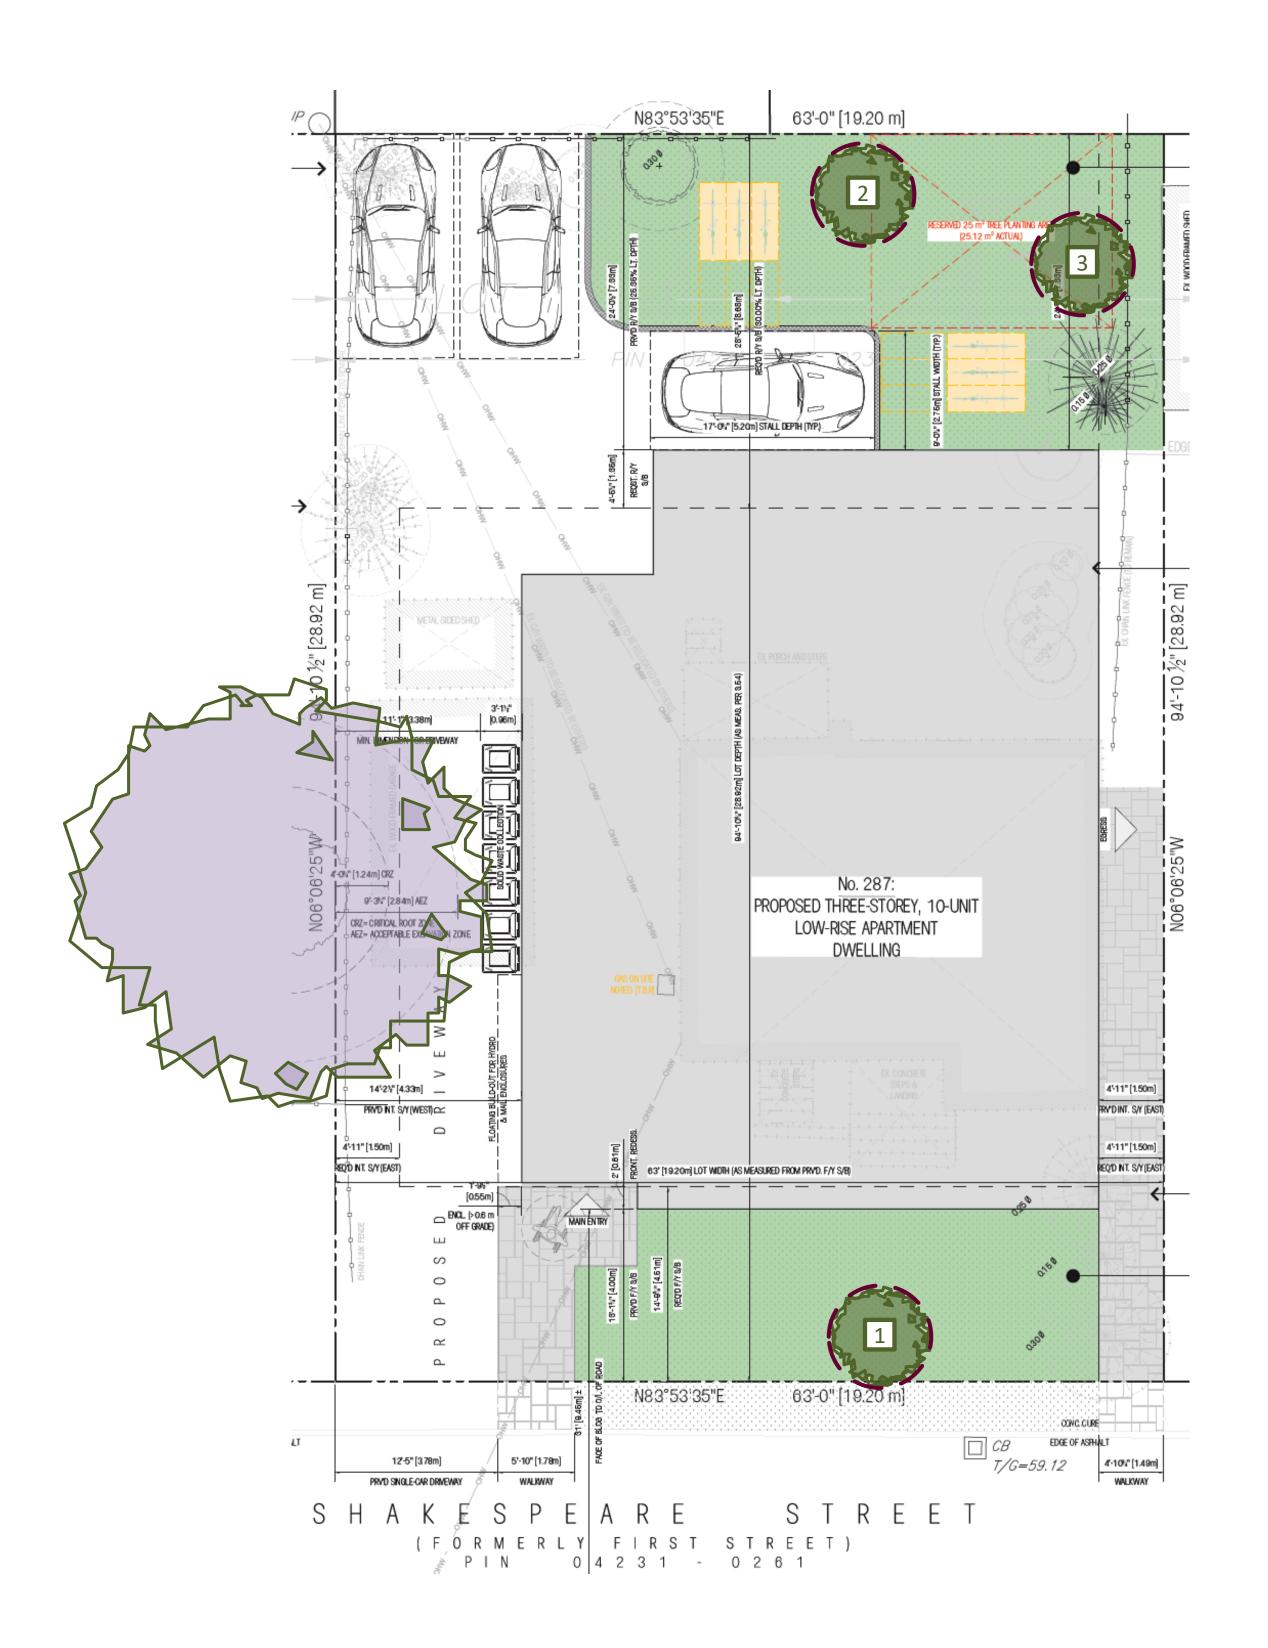

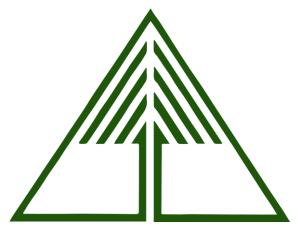

Tree Planting Plan – 287 Shakespeare Street
Prepared by Dendron Forestry Services
Version 1.0, December 2, 2024
For more information, please contact:
info@dendronforestry.ca

Note: the tree layer has been added to the original site plan supplied by the client in pdf format. This layer refers to the trees only, and the original site plan has not been altered in the process. Refer to the original plan for details as quality is lost when importing the plan into the mapping software used to create the tree layer.

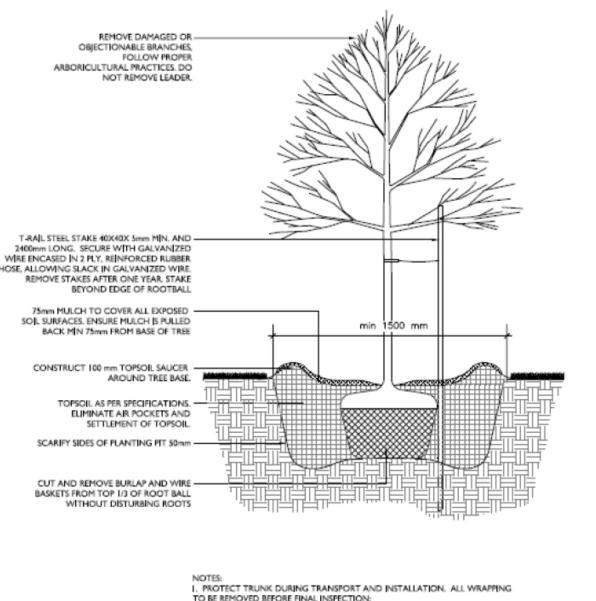

NOTES:

1. PROTECT TRUNK DURING TRANSPORT AND INSTALLATION. ALL WRAPPIN TO BE REMOVED BEFORE FINAL INSPECTION;

2. ALL PROTECTIVE WRAPPING SHALL BE REMOVED AFTER INSTALLATION;

3. STAKING OF TREES SHALL BE PERFORMED ONLY IF DEEMED NECESSARY;

4. ALL DIMENSION IN MILLIMETERS UNLESS OTHERWISE NOTED.

KEY SPACING GUIDELINES

For Deciduous Trees:

- Minimum 50mm caliper stock
- 1.5m from sidewalks, driveways, walkways, fences, sound walls, and old stumps.
- 2.5m from curbs, hydro transformers, or behind fire hydrants
- 4-7m from any part of an existing tree, depending on canopy width
- 10m from bus shelters and community mailboxes

For Coniferous Trees:

- Follow same setbacks as deciduous, but due to the widest branching being at the base of the tree, conifers need greater setbacks for ground-level obstacles.
- Minimum 200cm height stock
- 4.5m setbacks from sidewalks, walkways, driveways, and curbs.
- Do not plant on corners where sight lines will be compromised.

TREES MUST BE WATERED REGULARLY FOLLOWING PLANTING TO ENSURE PROPER ESTABLISHMENT.

On average, a young tree needs 6 gallons (24 liters) of water twice per week. (Do not water using a sprinkler as water on the foliage can lead to fungal infection)


Placing a ring of mulch around the planting hole will help reduce water loss.

Ensure no mulch is touching the base of the tree.

Legend



New Private Tree

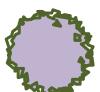

Existing Tree to be retained

VARIA: DRAFTING & DESIGN

GENERAL NOTES:

APPLICABLE).

REVISIONS:

NORTH ARROW:

CONDITIONS ARE NOT MET.

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DESCRIPTION


1 FORMALIZED PER SITE PLAN


RESPONSIBILITY AND / OR LIABILITY IF THE ABOVE

CHECKED BY: P. HUME

PROJECT NO.: 0038

SCALE: 1/4" = 1'-0" SHEET NUMBER:

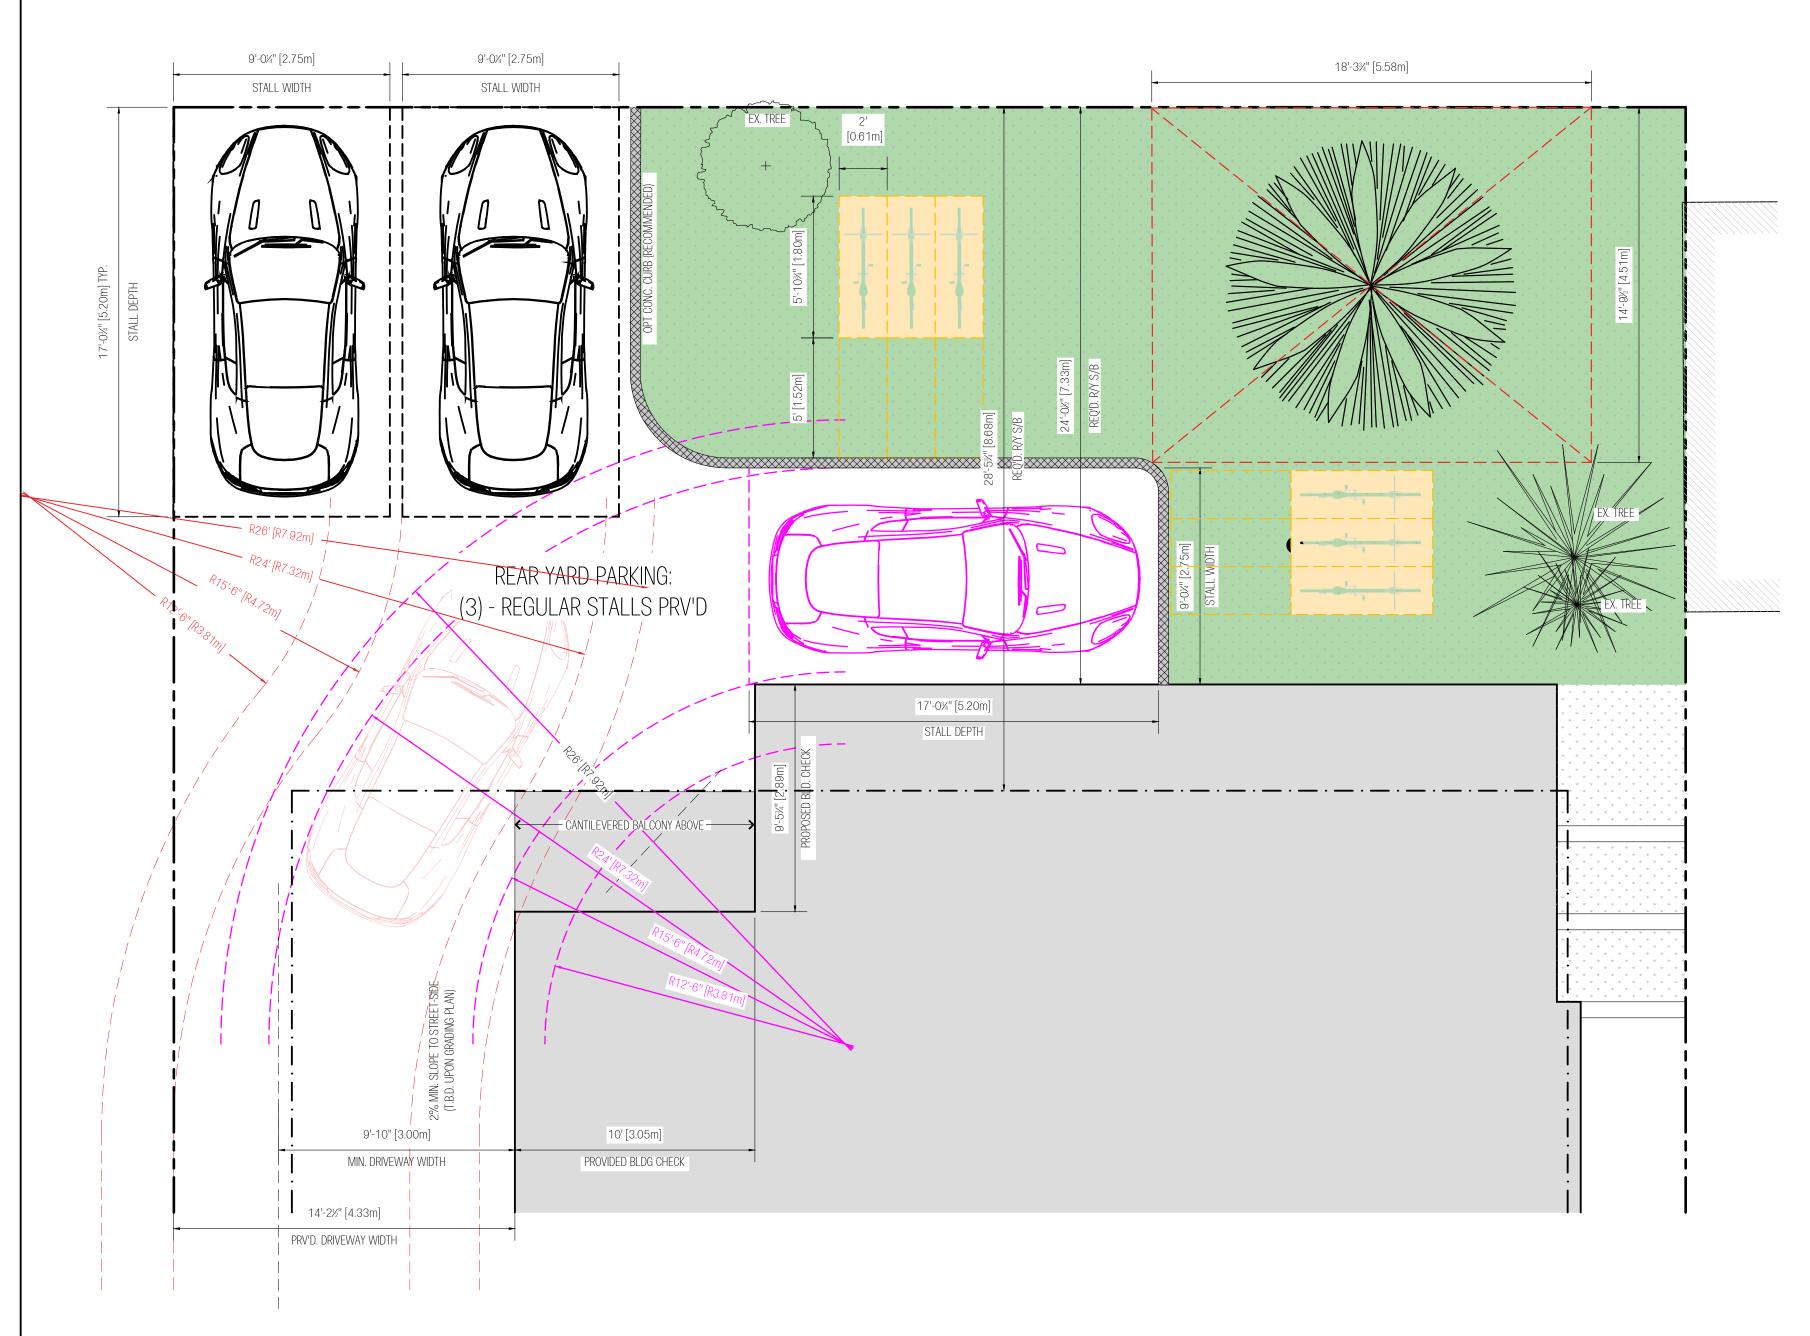

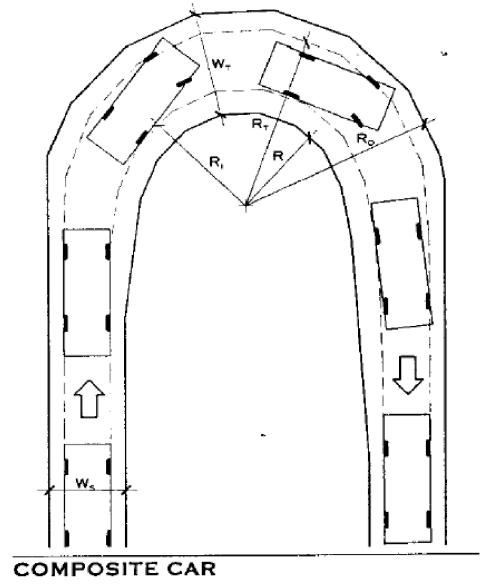

MINIMUM TURNING RADIUS FOR DESIGN VEHICLES (FT-IN.) MIN. TURNING RADIUS (R_T) OUTSIDE FRONT RADIUS (R_I) INSIDE REAR RADIUS (R_I) WIDTH (W_S) WIDTH (W_T) INSIDE CURB RADIUS (R) TANGENT LENGTH (T)

24-0 26-0 15-6 10-0 13-6 12-6 24-7

DESIGN VEHICLE DIMENSIONS

| VEHICLE | LENGTH (L) | WIDTH (W) | HEIGHT (H) | WHEELBASE (WB) | OVERHANG FRONT (OF) | OVERHANG REAR (OR) | GROSS WEIGHT |
|--|---------------|--------------|---------------|-------------------|------------------------|-----------------------|--------------|
| | (FT-IN.) | | | | | | |
| Small car ¹ | 15-0 | 5-7 | 4-8 | 8-6 | 2-0 | 4-6 | 2850 |
| Composite passenger vehicle ² | 16-9 | 6-4 | 6-10 | 9-5 | 3-0 | 4-4 | 6000 |
| Light truck | 17-9 | 6-6 | 6-0 | 11-0 | 2-9 | 4-0 | 8600 |
| Van | 16-9 | 6-3 | 6-10 | 10-0 | 2-9 | 4-0 | 4600 |
| Sport/utility vehicle | 16-0 | 6-4 | 6-2 | 9-4 | 3-0 | 3-8 | 6000 |
| Wheelchair lift van (personal use) | 17-8 | 6-8 | 8-0 | 11-6 | 2-6 | 3-8 | 6000 |
| Boat trailer | 20-0 | 8-0 | 6-0 | See detail | 3-0 | 8-0 | 4000 |
| RV-conventional trailer | 27-0 | 7-0 | 9-0 | See detail | 3-0 | 12-0 | 5000 |
| RV-fifth wheel (pickup-based) | 34-0 | 8-6 | 12-0 | 8-0 | 22-0 | 12-2 | 3500 |
| RV-folding trailer | 16-0 | 7-6 | 5-0 | _ | 8-6 | 7-6 | 1500 |
| Slide-in pickup camper | 18-11 | 10-0 | 7-3 | - | _ | - | 2900 |
| Stretch limousine | 24-6 | 6-0 | 5-0 | 15-6 | 4-0 | 5-0 | 9000 |
| Shuttle van (11 passengers) | 20-0 | 6-6 | 6-10 | 11-6 | 3-0 | 5-6 | 11,000 |

Small car classes 5 through 7 per Parking Consultants Council (PCC).

² A composite passenger vehicle is a design vehicle that encompasses passenger cars, light trucks, vans, and sport/

utility vehicles. It is the vehicle for which a parking facility should be designed.

*Generally in conformance with standards of the American Association of State Highway and Transportation Officials (AASHTO).

Mary S. Smith, P.E.; Walker Parking Consultants/Engineers, Inc.; Indianapolis, Indiana

