

600mm%%C STORM SEIVER 7. Jon 25000 Jon 1. Jon 25000 Jon 1. Jon 1
Altista Trissa Altista Trissa Boo Boo Altista Trissa Boo Boo Altista Trissa Boo Boo Boo Boo Boo Boo Boo Bo

#	DESCRIPTION mm/dd/y			mm/dd/yy
PROJECT				
870-872 RIDDELL AVE. N				
	NBUILD		OTTAN	A ONTARIO
DRA	WING			
SITE PLAN				
		0	_, ., .	
TYP	E		SCALE	
DEVELOPMENT				
DES	SIGNED BY	DRAWN BY	SHEET	
		TM		1 1
DAT	ΓE		SP-C	/ .
FEB 21, 2024				
1 LD 21, 2024				2 OF 8

06	SENT FOR SEVERANCE	03/24/25
05	SENT FOR REFERENCE PLAN	03/07/25
04	SENT FOR COMMENTS	03/05/25
03	SENT FOR COMMENTS	02/25/25
02	SENT FOR COMMENTS	02/21/25
01	ISSUED FOR PROFORMA	02/20/25
#	DESCRIPTION	mm/dd/yy

City of Ottawa | Ville d'Ottaw


Comité de dérogation

Committee of Adjustmen

ROCAHOMES

Received | Reçu le

2025-03-27

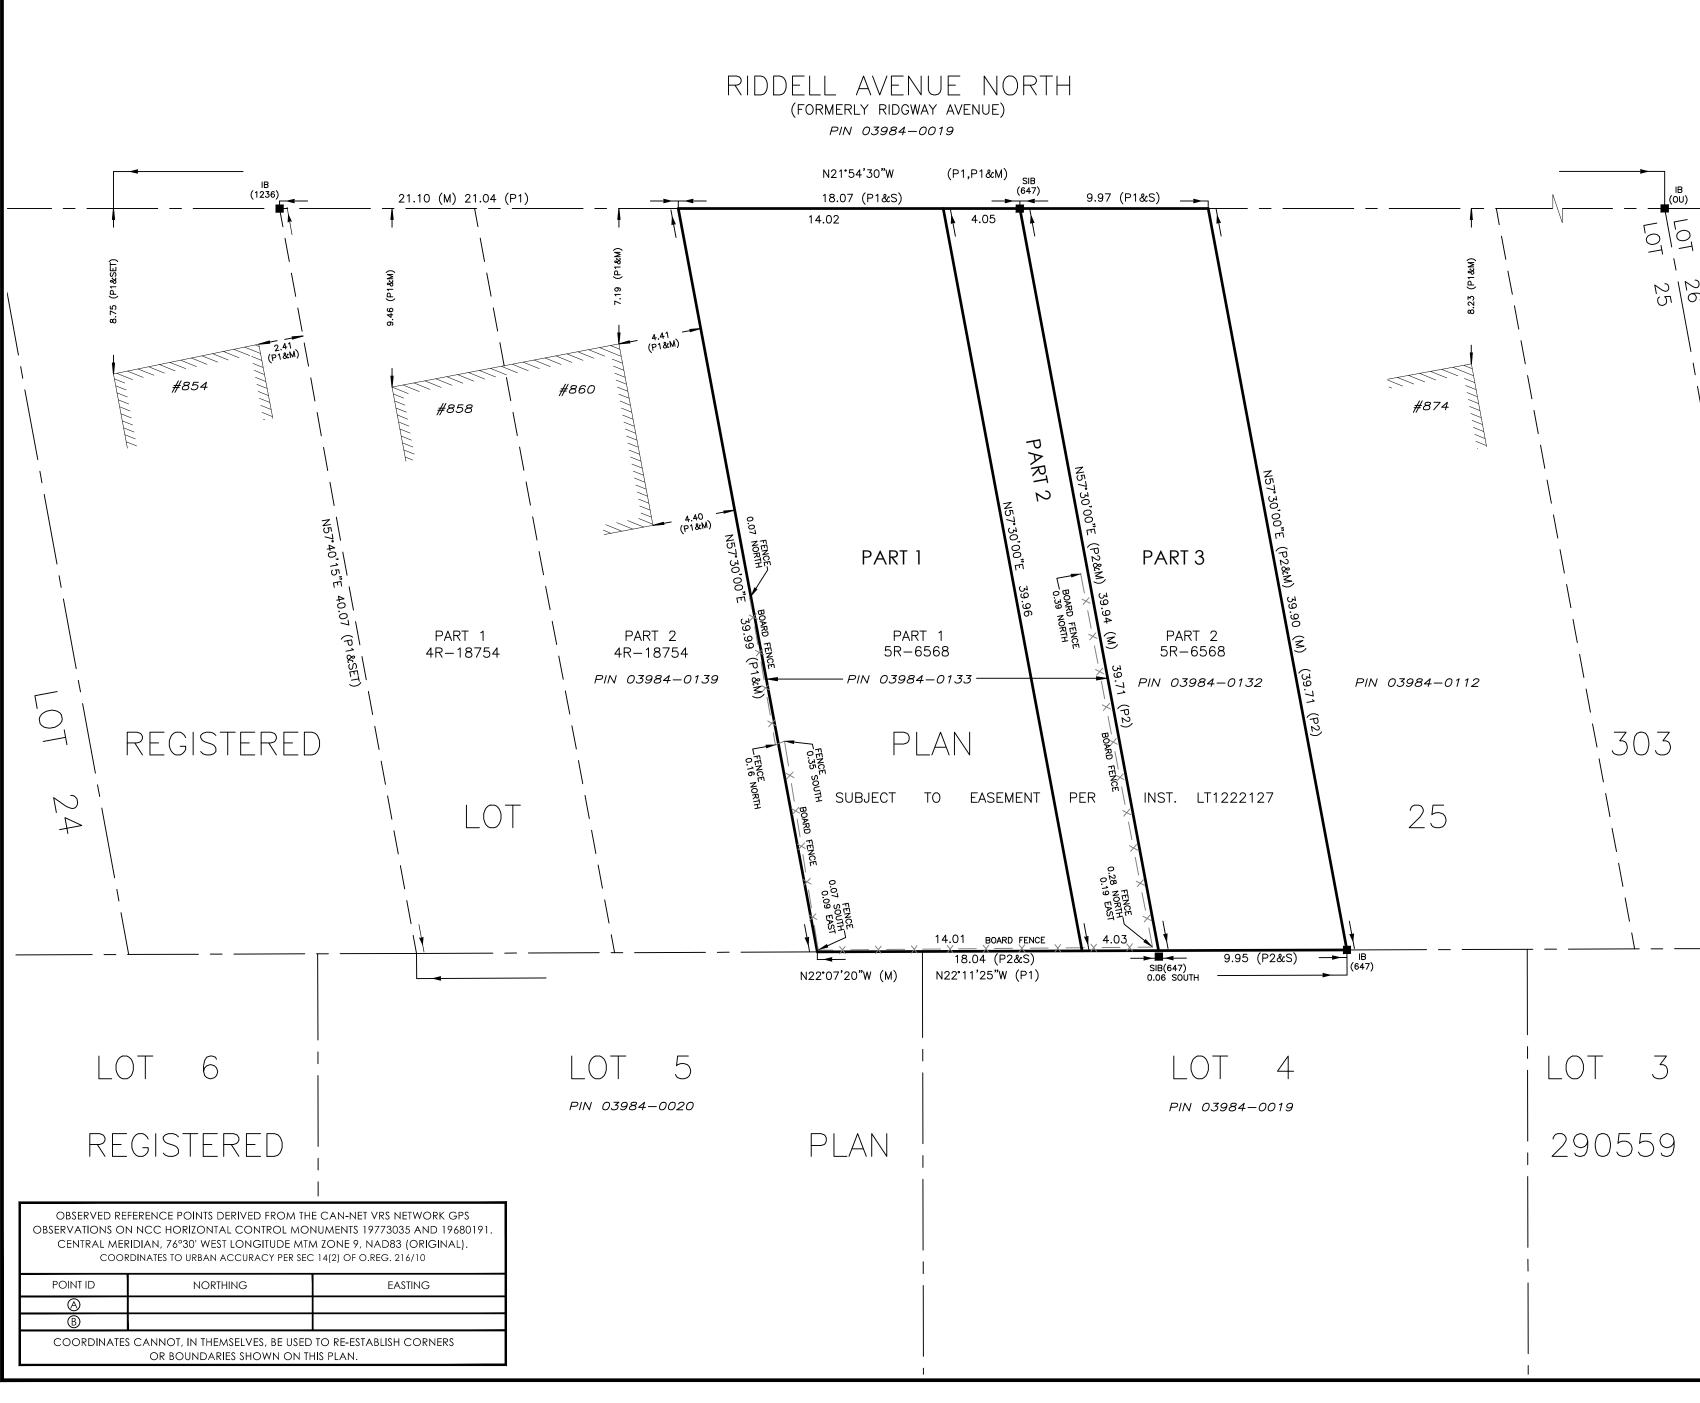

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SCHEDULE				
PART	LOT	PLAN	PIN	AREA (m2)
1	PART OF 25	303	ALL OF 03984-0133	551.1
2				158.9
3			ALL OF 03984-0132	391.5

PARTS 1, 2 & 3 ARE SUBJECT TO EASEMENT PER INST. LT1222127.

Committee of Adjustment Received | Reçu le

2025-03-27

City of Ottawa | Ville d'Ottawa Comité de dérogation

PLAN OF SURVEY OF

PART OF LOT 25 REGISTERED PLAN 303 CITY OF OTTAWA

Scale 1:200

0 5 10 METRES

THE INTENDED PLOT SIZE OF THIS PLAN IS 610 mm IN WIDTH BY 457 mm IN HEIGHT WHEN PLOTTED AT A SCALE OF 1: 200 m.

METRIC CONVERSION

DISTANCES AND COORDINATES SHOWN ON THIS PLAN ARE IN METRES AND CAN BE CONVERTED TO FEET BY DIVIDING BY 0.3048

GRID SCALE CONVERSION

DISTANCES ARE GROUND AND CAN BE CONVERTED TO GRID BY MULTIPLYING BY THE COMBINED SCALE FACTOR OF 0.99994

BEARING NOTE

BEARINGS ARE GRID, DERIVED FROM THE CAN-NET VRS NETWORK OBSERVATIONS ON NCC HORIZONTAL CONTROL MONUMENTS 19773035 AND 19680191, CENTRAL MERIDIAN, 76°30' WEST LONGITUDE MTM ZONE 9. NAD83 (ORIGINAL).

19773035 N:5006060.42 E:324888.04

19680191 N:5033564.26 E:388064.94

FOR COMPARISON PURPOSES A ROTATION OF 0° 27' 00" COUNTER-CLOCKWISE WAS APPLIED TO BEARINGS SHOWN ON P1 & P2.

<u>LEGEND</u>

_		
	DENOTES	Found monuments
		set monuments
IB		IRON BAR
IBø		ROUND IRON BAR
SIB		STANDARD IRON BAR
SSIB		SHORT STANDARD IRON BAR
CC		CUT CROSS
CP		CONCRETE PIN
WIT		WITNESS
PIN		PROPERTY IDENTIFICATION NUMBER
M/MEAS		MEASURED
SÉT		SET
OU		ORIGIN UNKNOWN
SG		STANTEC GEOMATICS LTD.
P1		PLAN 4R-18754
P2		PLAN 5R-6568
ORP		OBSERVED REFERENCE POINT

SURVEYOR'S CERTIFICATE

I CERTIFY THAT :

- 1. THIS SURVEY AND PLAN ARE CORRECT AND IN ACCORDANCE WITH THE SURVEYS ACT, THE SURVEYORS ACT AND THE LAND TITLES ACT AND THE REGULATIONS MADE UNDER THEM.
- 2. THE SURVEY WAS COMPLETED ON THE DAY OF , 2025.

DATE

FRANCIS LAU ONTARIO LAND SURVEYOR

THIS PLAN OF SURVEY RELATES TO AOLS PLAN SUBMISSION FORM NUMBER V-

 Stantec Geomatics Ltd.

 Stantec Geomatics Ltd.

 CANADA LANDS SURVEYORS

 ONTARIO LAND SURVEYORS

 ONTARIO LAND SURVEYORS

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 OTTAWA, ONTARIO, K2C 3G4

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