

PROJECT INFORMATION R5B[2459] (H)18 LOT AREA 13.808 acres DEVELOPMENT TYPE PLANNED UNIT DEVELOPMEN BUILDING HEIGHT FRONT YARD SETBACK

BUILDING STATISTICS - EXISTING

PAVED SURFACE = 23 990.0 sq. m. 42.93% BUILDING FOOTPRINT = 14 250.0 sq. m. 25.50% LANDSCAPE OPEN SPACE = 17 640.0 sq. m. 31.57% TOTAL = 55 880.0 sq. m. 100.0%

BUILDING HEIGHTS

40 SPRINGLAND 18.0 M - 6 STOREYS 790 SPRINGLAND 18.0 M - 6 STOREYS 18.0 M - 6 STOREYS 30.0 M - 10 STOREYS

UNIT COUNT - PER BUILDING

740 SPRINGLAND **168 UNITS** 790 SPRINGLAND **171 UNITS** 840 SPRINGLAND **171 UNITS** 2660 NORBERRY 251 UNITS **761 UNITS**

CAR PARKING - OVERALL SITE EXISTING

OANT ANNING - OVERALL OTTE EXISTING		
COVERED	145 SPACES	
ABOVE GRADE SURFACE	88 SPACES	
	526 SPACES	
TOTAL	759 SPACES	
RESIDENTIAL:	741 SPACES (0.97/UNIT	
VISITOR:	18 SPACES (0.02/UNIT	

BUILDING STATISTICS - PROPOSED

FRONT YARD SETBACK REQUIRED: 3.0 M MIN PROPOSED: VARIES - 6.0 M MIN

CORNER SIDE YARDS SETBACK REQUIRED: 3.0 M MIN. PROPOSED: VARIES - 6.0 M MIN.

BUILDING HEIGHTS 18.5 M - 6 STOREYS 18.6 M - 6 STOREYS 17.2 M - 5 STOREYS

BUILDING FOOTPRINT 1 225.0 m2 [13 186 sq. ft.]

1 096.2 m2 [11 799 sq. ft.] 3 936.5 m2 [42 370 sq. ft.] 6 257.7 m2 [67 357 sq. ft.]

JNIT COUNT - PER BUILDING

BUILDING 'A'	103 UNITS
BUILDING 'B'	94 UNITS
BUILDING 'C'	90 UNITS
TOTAL NEW:	287 UNITS
AMENITY SPACE - PER BUILDING	
BUILDING 'A' - REQUIRED (6M2/UNIT 3M2	618 M2

BUILDING 'A' - REQUIRED (6M2/UNIT, 3M2 COMMON MINIMUM) 618 M2 BUILDING 'A' - PROVIDED, PRIVATE: 0 M2

BUILDING 'B' - REQUIRED (6M2/UNIT, 3M2 564 M2 (MUMINIM NOMMC BUILDING 'B' - PROVIDED, PRIVATE: BUILDING 'B' - PROVIDED, COMMON: 564 M2 BUILDING 'B' - PROVIDED, TOTAL: 564 M2 BUILDING 'C' - REQUIRED (6M2/UNIT, 3M2 540 M2 COMMON MINIMUM)

742 M2

BUILDING 'C' - PROVIDED, PRIVATE: BUILDING 'C' - PROVIDED, COMMON: 715 M2 BUILDING 'C' - PROVIDED, TOTAL: 715 M2 BUILDING STATISTICS - TOTAL SITE

PAVED SURFACE = 14 220.0 sq. m. 25.45% BUILDING FOOTPRINT = 20 507.7 sq. m. 36.70% LANDSCAPE OPEN SPACE = 21 152.3 sq. m. 37.85% TOTAL = 55 880.0 sq. m. JNIT COUNT - OVERALL

761 UNITS **287 UNITS 1048 UNITS** CAR PARKING - OVERALL PROVIDED 248 SPACES

115 SPACES 486 SPACES TOTAL (INCLUDES 104 VISITOR SPACES) 849 SPACES REDUCED SIZE PARKING SPACES:

2.4 x 4.6m MIN. 369 SPACES (MAX 50% SPACES [425])

692 SPACES (0.66/UNIT 104 SPACES (0.1/UNIT AFTER 12

28 SPACES 32 SPACES 60 SPACES 52 SPACES 14 SPACES 34 SPACES 48 SPACES 47 SPACES 20 SPACES 16 SPACES 36 SPACES 45 SPACES

LEGAL DESCRIPTION

TOPOGRAPHICAL PLAN OF

BLOCK A REGISTERED PLAN 749 and BLOCK D REGISTERED PLAN 775 CITY OF OTTAWA

Prepared by Annis, O'Sullivan, Vollebekk Ltd.

DRAWING NOTES:

PROPERTY LINE

3.0m FRONTYARD SETBACK LINE

NEW VISITOR PARKING IN EXISTING ENTRANCE DRIVEWAY

PROPOSED PAD-MOUNT TRANSFORMER

EXISTING VEHICLE RAMP (TO BE REPLACED)

SEE LANDSCAPE PLAN FOR NEW LANDSCAPING

EXTERIOR BIKE STORAGE ON CONCRETE PAD. SEE

LINE OF EXISTING GARAGE TO BE REMOVED

1:12 SLOPE MAX. B/F RAMP C/W 920mm HIGH HANDRAIL

NEW ENTRANCE TO COVERED PARKING GARAGE - SEE FLOOR PLANS

2.0M WIDE CONCRETE SIDEWALK AS PER CITY STANDARDS. DEPRESSED CURBS & TWSI AT ALL INTERSECTIONS AS PER

LINE OF LIMITING DISTANCE FROM EXISTING BUILDING, UNLIMITED PERMITTED OPENINGS (7.5M)

HATCH INDICATES LOCATION OF TEMPORARY SNOW

ENCLOSED BIKE STORAGE C/W 1.8M H. CHAIN-LINK FENCE ON

CONCRETE PAD, HORIZONTAL SPACES AS PER CITY BYLAWS (1.8MdX0.6Mw). SEE LANDSCAPE

PATCH/REPAIR EXISTING ASPHALT SURFACES AS REQUIRED. SEE CIVIL FOR GRADING

B/F PARKING SPACES, TYPE A & B AS PER CITY STANDARDS.

SIDEWALKS / WALKING SURFACE

CONCRETE PAVERS, SEE LANDSCAPE

NEW/REPAIRED ASPHALT PARKING SURFACE AND CURBS. SEE CIVIL

OPEN LANDSCAPE AREA FOR AMENITY

TEMPORARY SNOW STORAGE

- 3.0 M FRONT & CORNER SETBACK LINE

SPACE CALCULATIONS

- 6.0 M PROP. MIN. BLG. SETBACK LINE

SEE LANDSCAPE DRAWINGS FOR SIDEWALK DETAIL

LINE OF NEW BELOW-GRADE GARAGE

32) 1.83 x 3.05m PATIO, TYP.

SITE PLAN SYMBOLS:

STEPS UP TO NEW DECK. SEE GRADING PLAN

EXIT STAIRS, C/W PRE-FINISHED METAL HANDRAIL

NOT USED

LOCATION

---- LINE OF SIGHT TRIANGLE

EXISTING U/G HYDRO LINE

EXISTING U/G BELL LINE

- W - W - EXISTING WATER LINE

0

PROJECT DEVELOPER

333 Wilson Avenue, Suite 200

E-Mail: natan@gsregalgroup.com

Toronto, ON, M3H 1T2 Tel: (416) 630 6767

URBAN PLANNER

43 Eccles Street, Unit C

E-Mail: jessica@jdplan.ca

Stantec Consulting Ltd.

LANDSCAPE ARCHITECT

Osgoode, ON Canada, K0A 2W0

E-Mail: rlevstek@larocquelevstek.com

Annis O'Sullivan Vollebekk Ltd.

400 - 1331 Clyde Avenue Ottawa, ON Canada, K2C 3G4

Tel.:(613) 812-1726

CIVIL ENGINEER

Tel: (613) 722-4420

Laroque Levstek

5871 Hugh Crescent

Tel.:(613) 826-0518

Ontario Land Surveyors 14 Concourse Gate, Suite 500,

Nepean, Ontario K2E 7S6

E-Mail: EdH@aovltd.com

Tel: (613) 727-0850

Fax: (613) 727-1079

SURVEYOR

www.stantec.com

144 SPACES

144 SPACES

Ottawa, ON Canada, K1R 6S3

JD Planning

GREATWISE DEVELOPMENT Inc.

1.8M H. CHAINLINK FENCE

BIKE RACK

FIRE HYDRANT

STREET LIGHT

TO BE REMOVED

ENTRANCE / EXIT DOOR

SIAMESE CONNECTION

VEHICULAR DIRECTION

EXISTING TREE TO BE REMOVED -SEE LANDSCAPE PLANS EXISTING TREE TO REMAIN

EXISTING PARKING SPACE

EXISTING 2.6M x 5.2M PARKING SPACE

NEW 2.6M x 5.2M PARKING SPACE

NEW 2.4M x 5.2M PARKING SPACE,

COMPLETE WITH IDENTIFICATION

SIGNAGE FOR COMPACT CARS

NEW 2.4M x 4.6M PARKING SPACE,

SIGNAGE FOR COMPACT CARS

NEW PAD-MOUNT TRANSFORMER

SEE LANDSCAPE FOR ALL SURFACE MATERIAL AND PATTERN

COMPLETE WITH IDENTIFICATION

— G — EXISTING GAS LINE

PROPERTY LINE

FIRE HYDRANT - EXISTING

SIAMESE CONNECTION

LANDSCAPE PLANS

EXISTING GAS METERS

NEW RETAINING WALL - SEE CIVIL

LINE OF 5x5M SITE TRIANGLE

LINE OF 3x3M SITE TRIANGLE

EXISTING SIDEWALK TO BE REMOVED

EXTEND EXISTING ASPHALT SIDEWALK

LINE OF EXISTING ENTRANCE CANOPY ABOVE EXISTING LOADING/GARBAGE STORAGE BAY

8 6.0 METRE WIDE FIRE ACCESS ROUTE

DRAWINGS NOT TO BE USED FOR CONSTRUCTION UNLESS STAMPED AND SIGNED BY THE

DO NOT SCALE DRAWINGS

PROCEEDING WITH THE WORK.

CONSULTANT. THESE DRAWINGS HAVE BEEN DESIGNED IN

CHECK AND VERIFY ALL DIMENSIONS BEFORE

COMFORMANCE WITH THE ONTARIO BUILDING

Revisions					
Revision Number	Revision Date	Revision Description			
1	2021-10-07	REVISED SITE PLAN CONTROL			
2	2022-05-16	REVISED SITE PLAN CONTROL			
3	2022-08-17	ISSUED FOR BUILDING PERMIT			
4	2022-08-19	REVISED SITE PLAN CONTROL			
6	2022-11-15	SPC: CLARIFIED PARKING			


2025-04-15 REVISED SITE PLAN CONTROL

Committee of Adjustmer Received | Reçu le 2025-04-30

City of Ottawa | Ville d'Ottav Comité de dérogation



Alexander Wilson Architect Inc Admiralty Place 103-20 Gore Street Kingston Ontario, K7L 2L1 t: 613.545.3744 ext 213 f: 613.545.1411

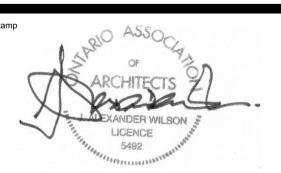

NORBERRY RESIDENCES

2640, 2710, 2730 NORBERRY CRESCENT, OTTAWA, ONTARIO

SITE PLAN

Drawn By	Checked By
Scale	Date 2025-04-15 1:32:34 PM
Project No. 2061	Revision 7
Drawing No. A011	



DO NOT SCALE DRAWINGS

CHECK AND VERIFY ALL DIMENSIONS BEFORE PROCEEDING WITH THE WORK.

DRAWINGS NOT TO BE USED FOR CONSTRUCTION UNLESS STAMPED AND SIGNED BY THE CONSULTANT.

THESE DRAWINGS HAVE BEEN DESIGNED IN COMFORMANCE WITH THE ONTARIO BUILDING

	Revisions		
	Revision Number	Revision Date	Revision Description
·			
	1	2021-10-07	REVISED SITE PLAN CONTRO
	2	2022-05-16	REVISED SITE PLAN CONTRO
	3	2022-08-17	ISSUED FOR BUILDING PERM
	4	2022-08-19	REVISED SITE PLAN CONTRO

2025-04-11 REVISED SITE PLAN CONTROL



Alexander Wilson Architect Inc Admiralty Place 103-20 Gore Street Kingston Ontario, K7L 2L1 t: 613.545.3744 ext 213 f: 613.545.1411





- BUILDING A


2640 NORBERRY CRESCENT, OTTAWA, ONTARIO

ELEVATIONS - EAST & WEST

Drawn By		Checked By
Scale	1 : 100	Date 2025-04-11 10:57:32 AM
Project No.	2061	Revision 7
Drawing No.	A300	

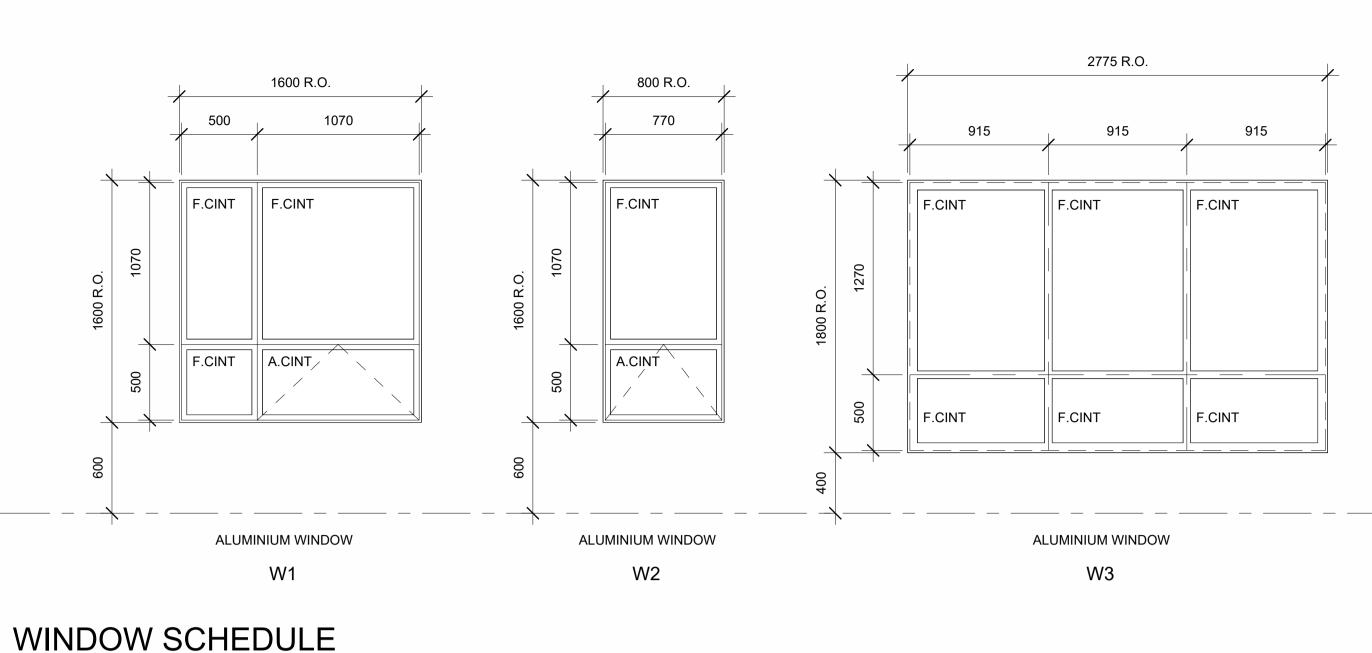

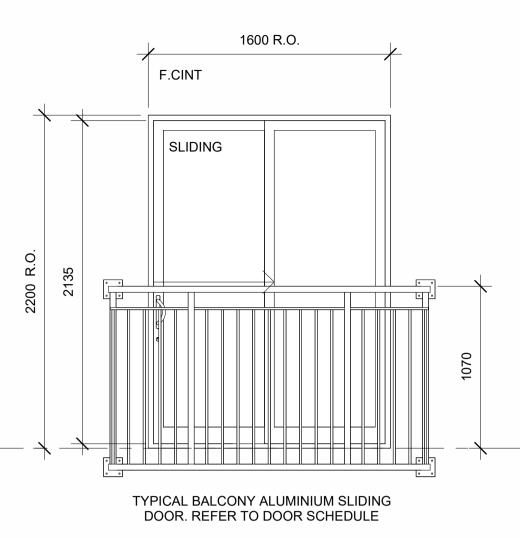

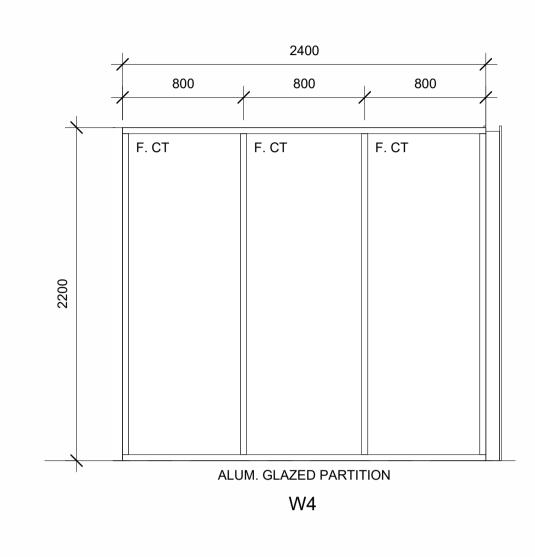

AWNING WINDOW ALUM ALUMINIUM ANOD ANODIZED CINT CLEAR INSULATED TEMPERED GLASS EQ EQUAL **EXISTING** EX FIXED GLAZING FROSTED CLEAR GLASS GALV GALVANIZED STEEL GW GEORGIAN WIRE GLASS **HOLLOW CORE** НМ **HOLLOW METAL** INSUL INSULATED R.O. ROUGH OPENING OVERHEAD DOOR ОН

SOLID CORE WOOD

CLEAR TEMPERED GLASS

TO BE DETERMINED (SITE MEASURED)

STEEL

STAIN

WINDOW NOTES:


ST


STA

CT

TBD

- 1. CONTRACTOR SHALL PROVIDE SIGNED AND SEALED DRAWINGS FOR THE SUPPORT OF GLAZING IN INTERIOR PARTITIONS.
- 2. JULIETTE BALCONY GUARDRAILS TO EXTEND TO MIN. 1070 AFF, AND SECURED TO ADJACENT WALL STRUCTURE. EXACT ATTACHMENT AS RECOMMENDED AND STAMPED BY MANUFACTURER ENGINEER. POSTS, PICKETS, AND RAILS TO BE PREFINISHED ALUMINIUM. GUARDRAIL TO BE ENGINEERED TO MEET LOAD REQUIREMENTS AS PER OBC 4.15.5.15.

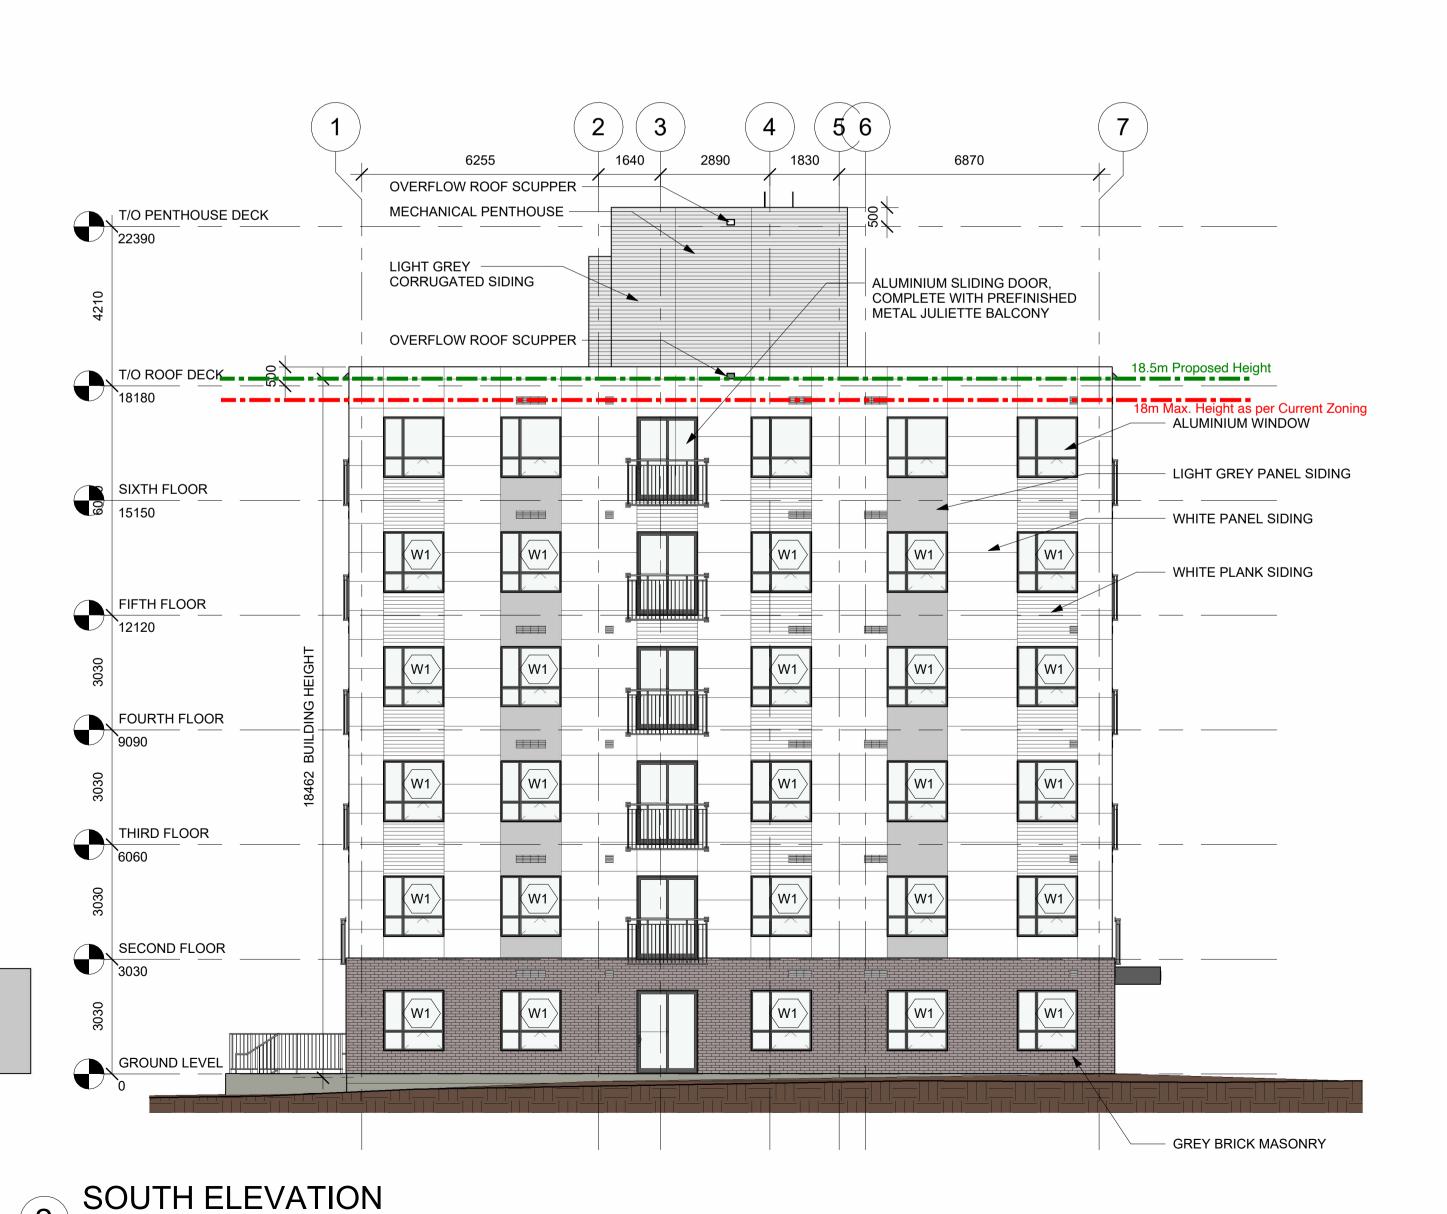

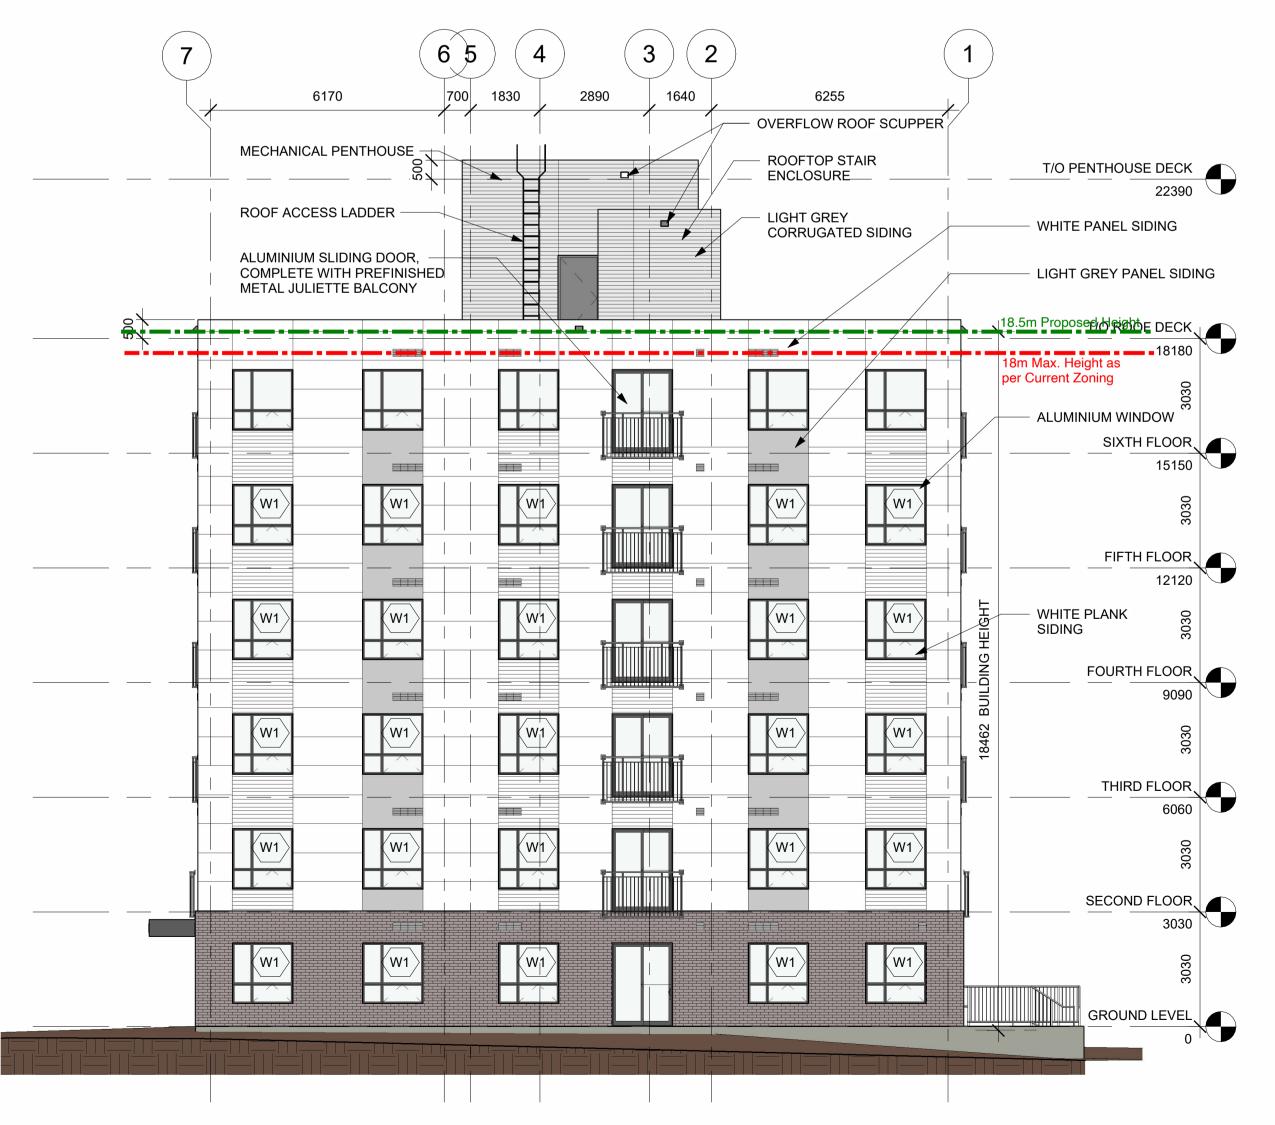

2640 NORBERRY CRESCENT,

OTTAWA, ONTARIO

- BUILDING A

DO NOT SCALE DRAWINGS

CONSULTANT.

CODE.

Revision

Number

PROCEEDING WITH THE WORK.

UNLESS STAMPED AND SIGNED BY THE

Revision

Date

CHECK AND VERIFY ALL DIMENSIONS BEFORE

THESE DRAWINGS HAVE BEEN DESIGNED IN

COMFORMANCE WITH THE ONTARIO BUILDING

DRAWINGS NOT TO BE USED FOR CONSTRUCTION

Revisions

2021-10-07 REVISED SITE PLAN CONTROL

2022-05-16 REVISED SITE PLAN CONTROL

2022-08-17 ISSUED FOR BUILDING PERMIT

2022-08-19 REVISED SITE PLAN CONTROL

2025-04-11 REVISED SITE PLAN CONTROL

Revision Description

ELEVATIONS - NORTH & SOUTH & WINDOW SCHEDULE

Alexander Wilson Architect Inc

Admiralty Place 103-20 Gore Street

f: 613.545.1411


NORBERRY RESIDENCES

Kingston Ontario, K7L 2L1 t: 613.545.3744 ext 213

Drawn By	Checked By
Scale As indicated	- Date 2025-04-11 10:57:48 AM
Project No. 2061	Revision 7
Drawing No. A301	

NORTH ELEVATION



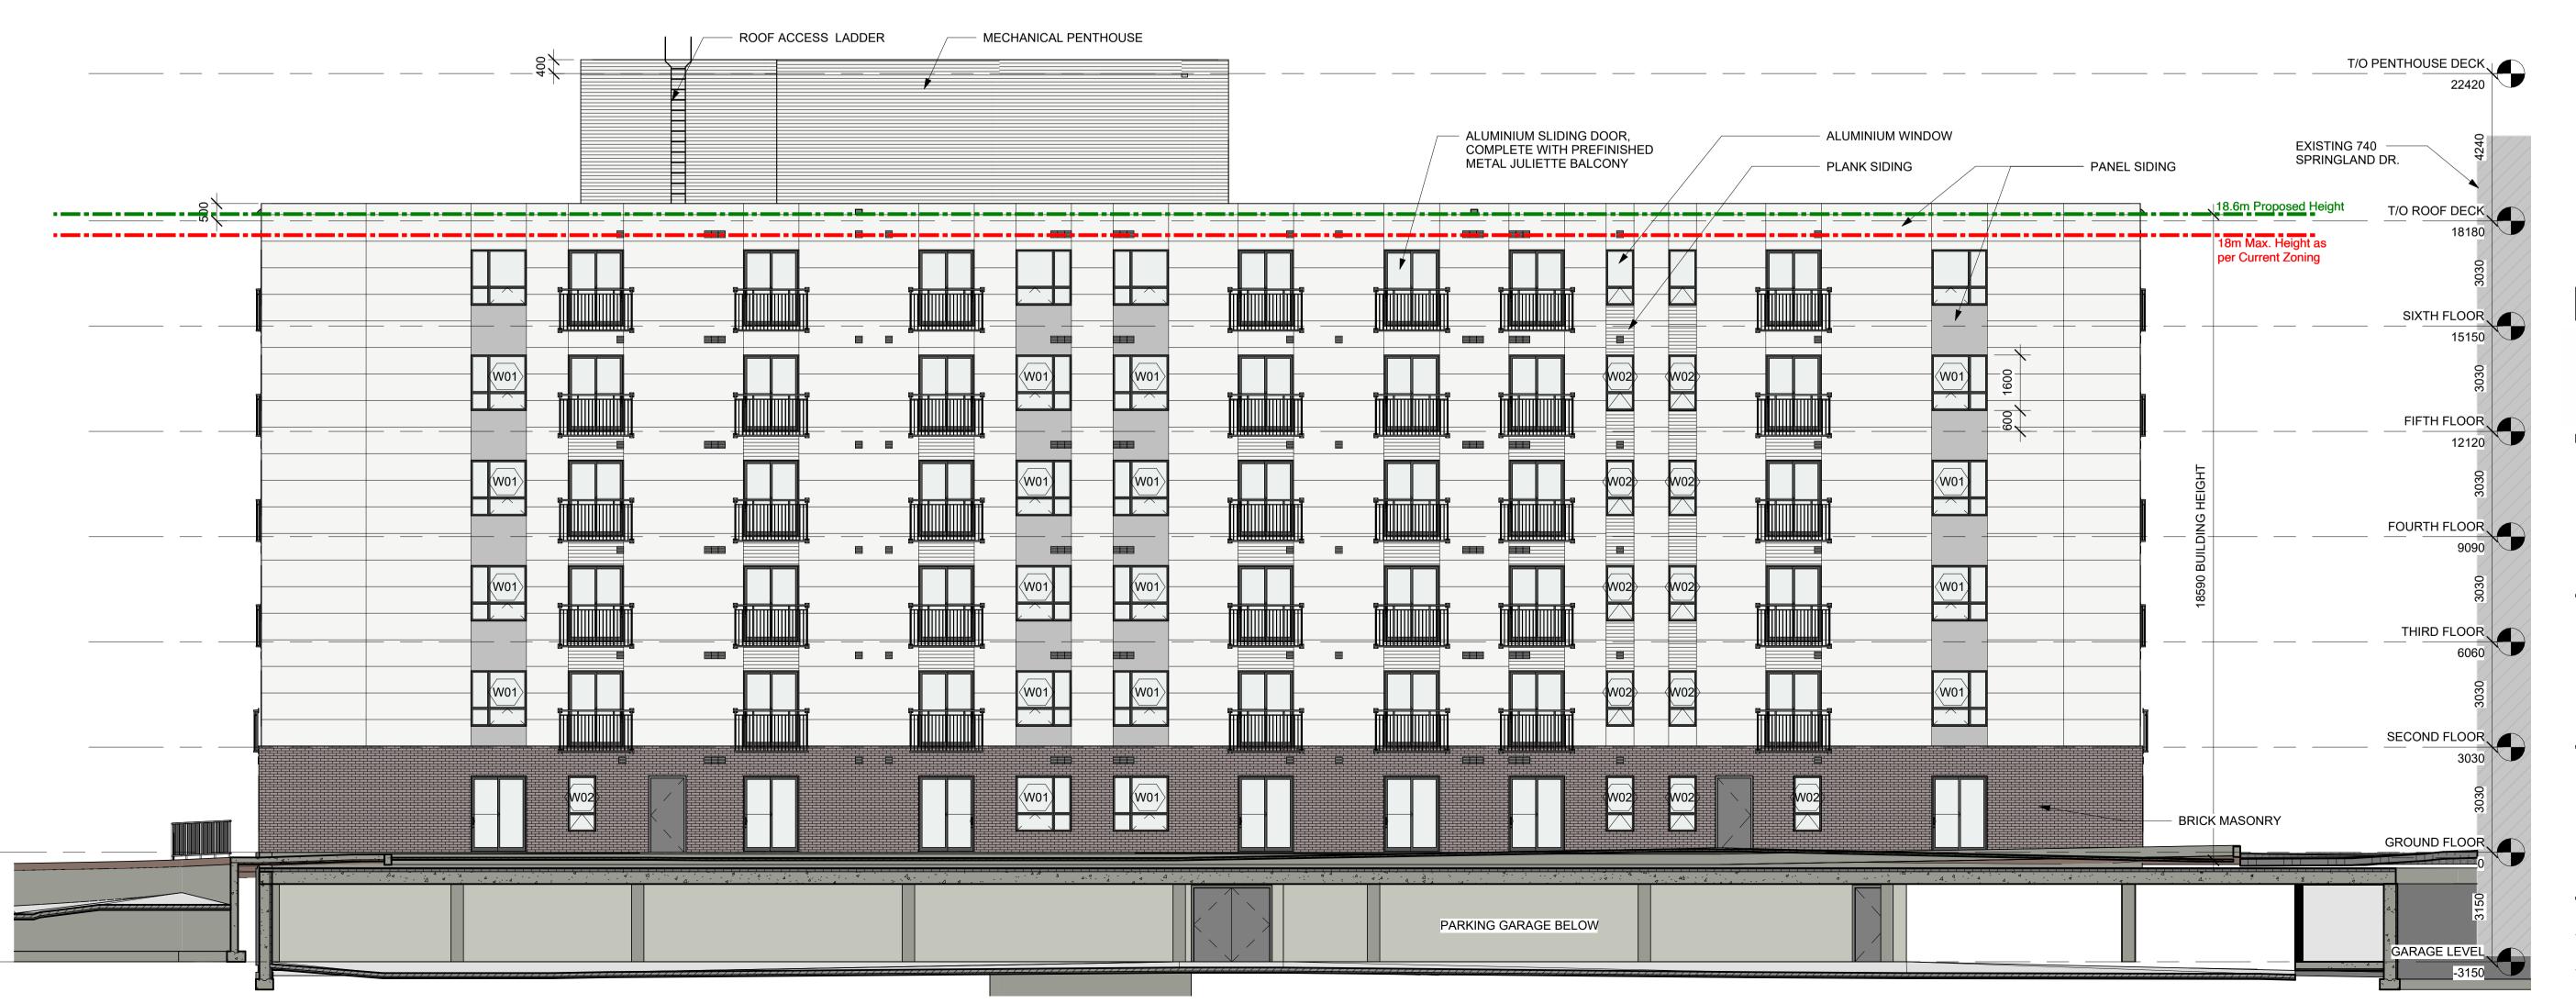

NORTH ELEVATION

DO NOT SCALE DRAWINGS

CHECK AND VERIFY ALL DIMENSIONS BEFORE PROCEEDING WITH THE WORK.

DRAWINGS NOT TO BE USED FOR CONSTRUCTION UNLESS STAMPED AND SIGNED BY THE CONSULTANT.

THESE DRAWINGS HAVE BEEN DESIGNED IN COMFORMANCE WITH THE ONTARIO BUILDING

	R	evisions
Revision Number	Revision Date	Revision Description
 1	2021-09-27	REVISED SITE PLAN CONTRO
2	2022-05-16	REVISED SITE PLAN CONTRO
3	2022-08-19	REVISED SITE PLAN CONTRO

2025-04-11 REVISED SITE PLAN CONTROL



Alexander Wilson Architect Inc Admiralty Place 103-20 Gore Street Kingston Ontario, K7L 2L1 t: 613.545.3744 ext 213 f: 613.545.1411




NORBERRY RESIDENCES
- BUILDING B


2730 NORBERRY CRESCENT, OTTAWA, ONTARIO

ELEVATIONS - NORTH & SOUTH


Drawn By		Checked By
Scale	1 : 100	Date 2025-04-11 10:50:25 AM
Project No.	2062	Revision 5
Drawing No.	A300	
	1	1

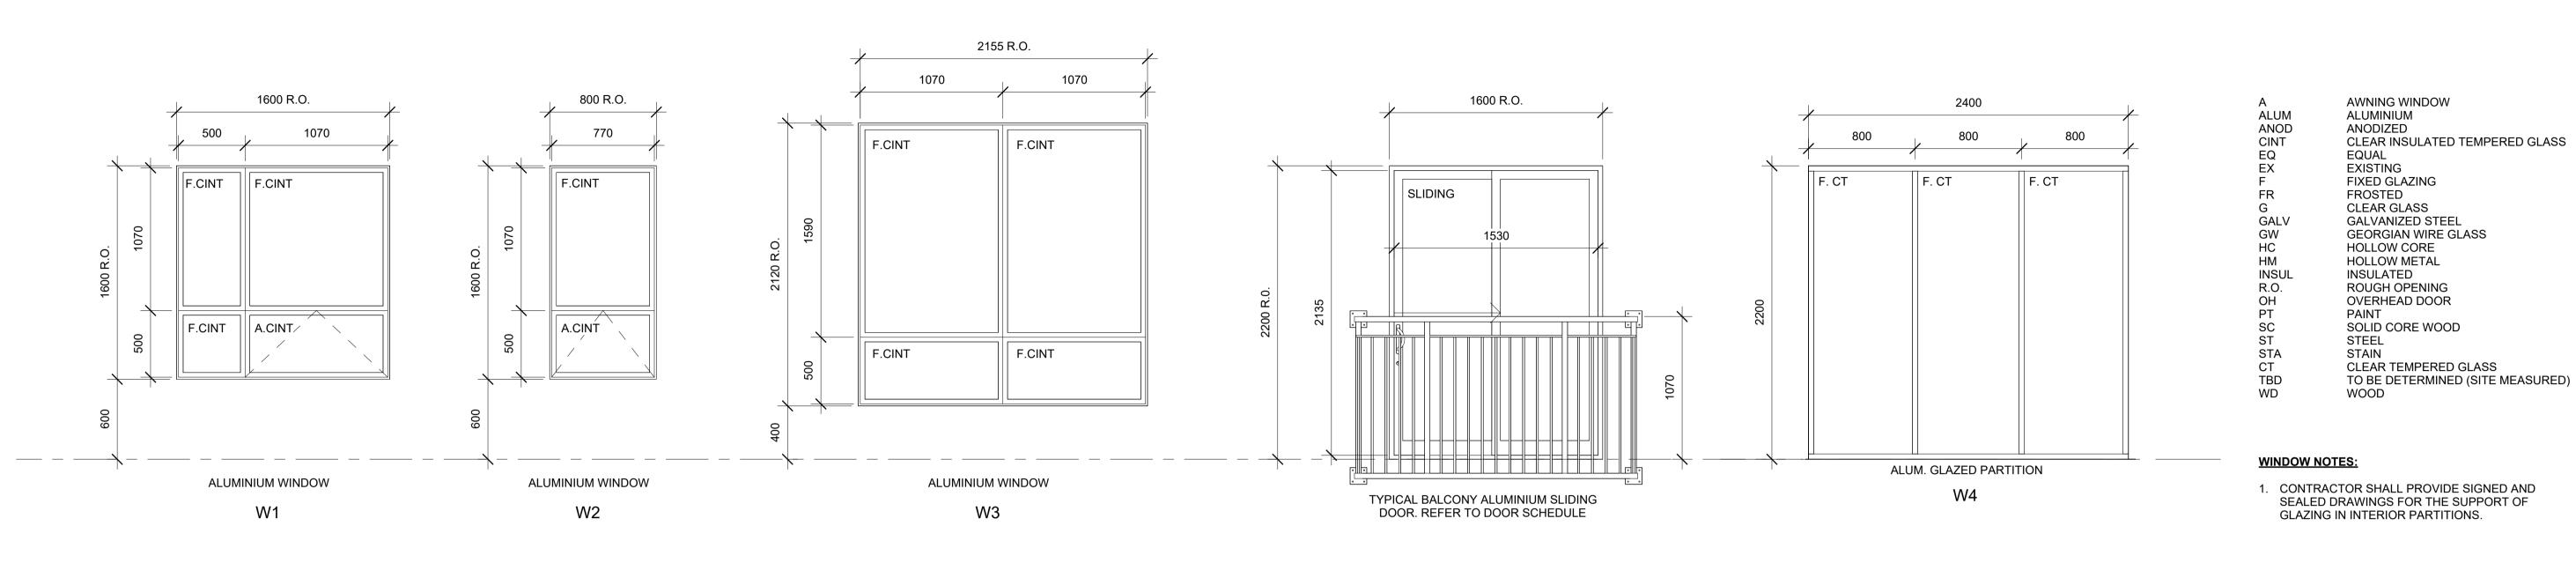

WINDOW SCHEDULE

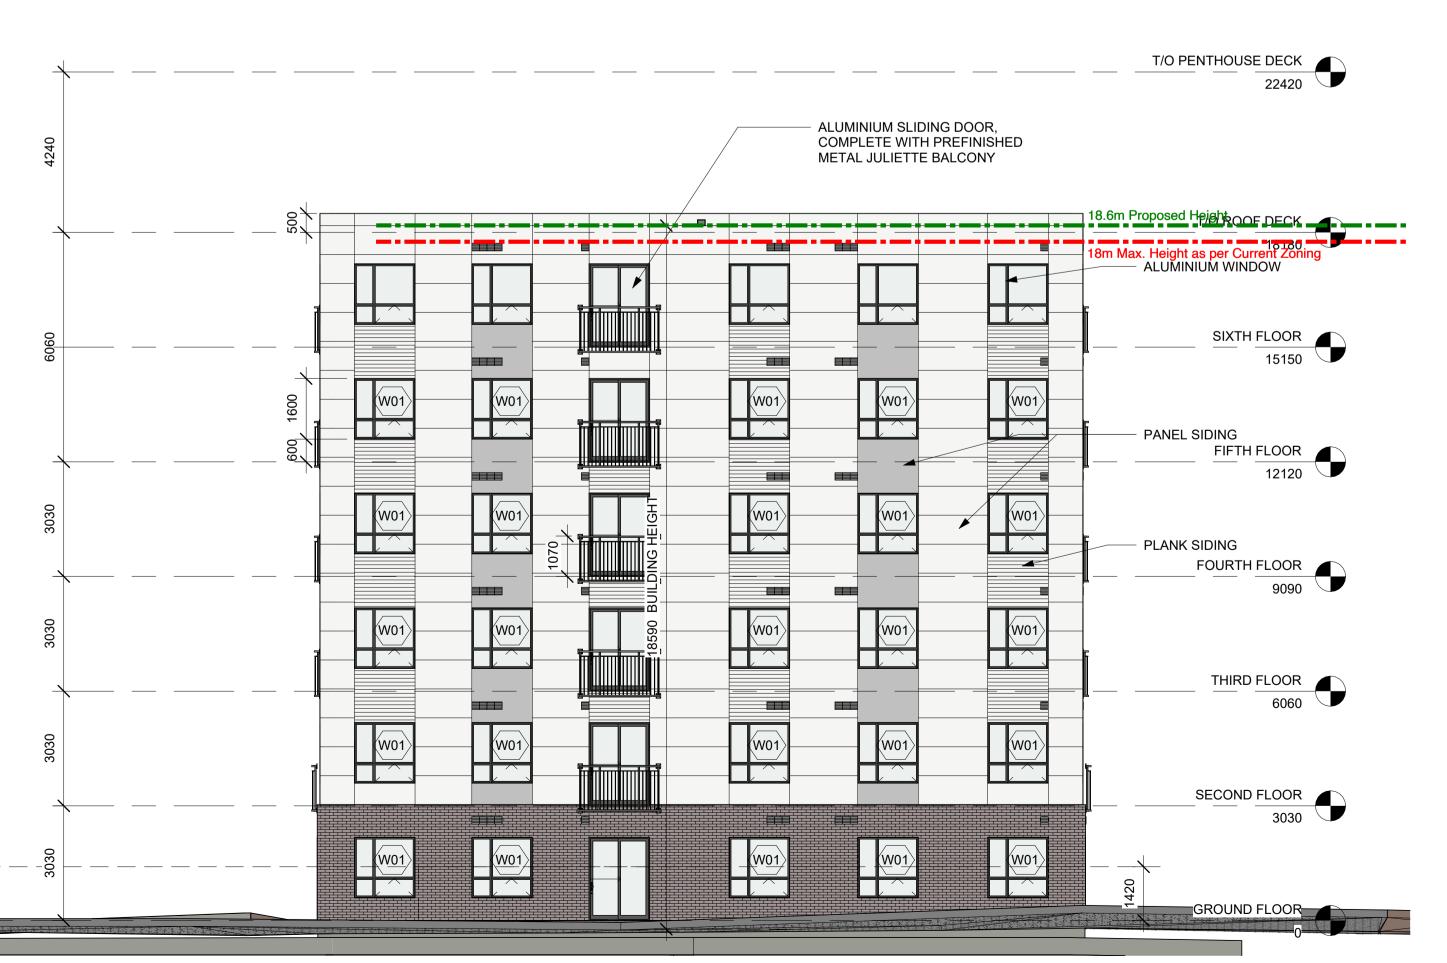



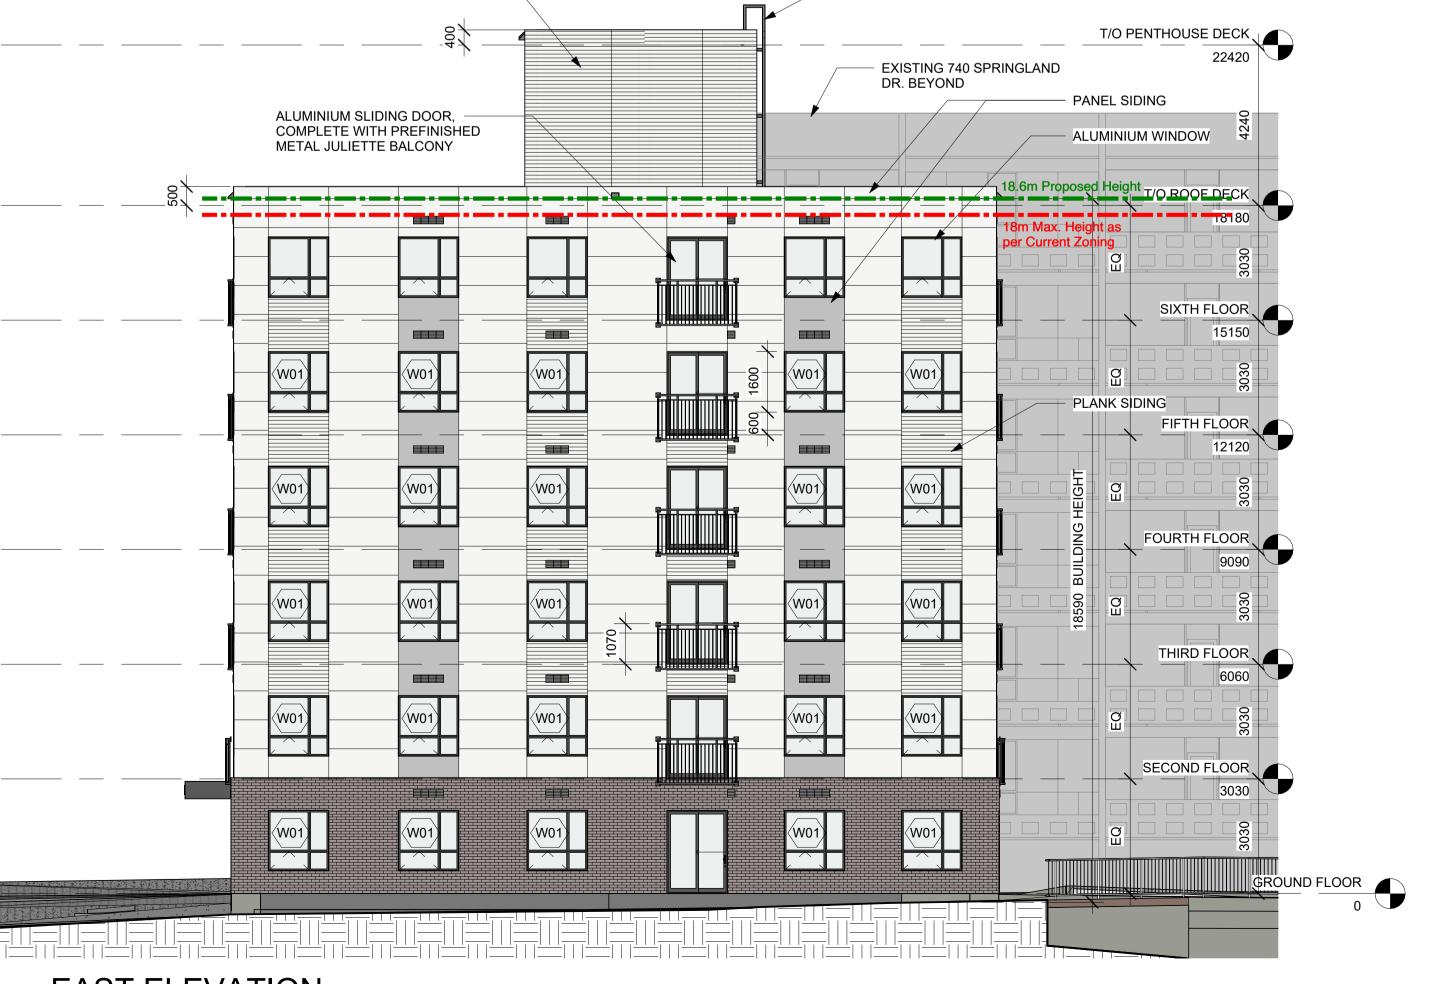

- ROOF ACCESS LADDER

MECHANICAL PENTHOUSE —

EAST ELEVATION

DO NOT SCALE DRAWINGS

CHECK AND VERIFY ALL DIMENSIONS BEFORE PROCEEDING WITH THE WORK.

DRAWINGS NOT TO BE USED FOR CONSTRUCTION UNLESS STAMPED AND SIGNED BY THE CONSULTANT.

THESE DRAWINGS HAVE BEEN DESIGNED IN COMFORMANCE WITH THE ONTARIO BUILDING CODE.

R	evisions
Revision Date	Revision Description
2021-09-27	REVISED SITE PLAN CONTRO
	Revision Date

2022-05-16 REVISED SITE PLAN CONTROL 2022-08-19 REVISED SITE PLAN CONTROL 2025-04-11 REVISED SITE PLAN CONTROL

Alexander Wilson Architect Inc Admiralty Place 103-20 Gore Street Kingston Ontario, K7L 2L1 t: 613.545.3744 ext 213 f: 613.545.1411



2730 NORBERRY CRESCENT, OTTAWA, ONTARIO

ELEVATIONS - EAST & WEST

Drawn By	Checked By
Scale As indicated	Date 2025-04-11 10:50:36 AM
Project No. 2062	Revision 5
Drawing No. A301	



DO NOT SCALE DRAWINGS

CONSULTANT.

CHECK AND VERIFY ALL DIMENSIONS BEFORE

PROCEEDING WITH THE WORK.


DRAWINGS NOT TO BE USED FOR CONSTRUCTION UNLESS STAMPED AND SIGNED BY THE

THESE DRAWINGS HAVE BEEN DESIGNED IN COMFORMANCE WITH THE ONTARIO BUILDING

Revisions				
Revision Number	Revision Date	Revision Description		
1	2022-05-16	REVISED SITE PLAN CONTROL		
2	2022-08-19	REVISED SITE PLAN CONTROL		
3	2025-05-11	REVISED SITE PLAN CONTROL		



Alexander Wilson Architect Inc Admiralty Place 103-20 Gore Street Kingston Ontario, K7L 2L1 t: 613.545.3744 ext 213 f: 613.545.1411

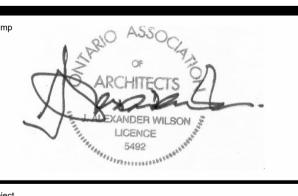

NORBERRY RESIDENCES
- BUILDING C

2710 NORBERRY CRESCENT, OTTAWA, ONTARIO

Drawing

ELEVATIONS - EAST & WEST

Scale 1:100	Date
	2025-04-11 11:37:04 AM
Project No. 2063	Revision 3
Drawing No. A300	



DO NOT SCALE DRAWINGS

CHECK AND VERIFY ALL DIMENSIONS BEFORE PROCEEDING WITH THE WORK.

DRAWINGS NOT TO BE USED FOR CONSTRUCTION UNLESS STAMPED AND SIGNED BY THE CONSULTANT.

THESE DRAWINGS HAVE BEEN DESIGNED IN COMFORMANCE WITH THE ONTARIO BUILDING CODE.

	Revisions		
Revision Number	Revision Date	Revision Description	
1	2022-05-16	REVISED SITE PLAN CONTROL	
2	2022-08-19	REVISED SITE PLAN CONTROL	
3	2025-05-11	REVISED SITE PLAN CONTROL	



Project
NORBERRY RESIDENCES

2710 NORBERRY CRESCENT,

- BUILDING C

OTTAWA, ONTARIO

ELEVATIONS - NORTH & SOUTH & WINDOW SCHEDULE

Drawn By	Checked By
Scale As indicated	Date 2025-04-11 11:03:34 AM
Project No. 2063	Revision 3
Drawing No. A301	

LOT 223 LOT 221 LOT 220 BLOCK A REGISTERED PLAN 775 l' Reserve Registered Plan 749 LOT 329 LOT 330 No. 840

No. 840

6 STOREY APARTMENT BUILDING

Door Sill —
Elev=76.06 LOT 331 (Foundation Noted) LOT 332 6 STOREY APARTMENT BUILDING I' Reserve (Foundation Noted) 04072 0001 EASEMENT LTI267635 RIDGEWOOD AVENUE 79.64* Concrete Curb (Roof Parking) ×79.51(Roof Parking)
(Roof Parking) CONCRETE GARAGE WITH ROOF PARKING (Elevation Noted at Grade) ×^{76.39} ×76.47 LOT 365 LOT 341 LOT 342 LOT 343 LOT 363 NORBERRY CB 76.59 T\G=76.59 76.65* JOB BENCHMARK TOP OF SPINDLE Elev.=78.3I 0/67 LOT 362 LOT 344 LOT 356 LOT 354 LOT 353 LOT 352 LOT 349 LOT 345

Committee of Adjustment Received | Reçu le 2025-04-30 City of Ottawa | Ville d'Ottawa Comité de dérogation

TOPOGRAPHICAL PLAN OF SURVEY

BLOCK A REGISTERED PLAN 749 and BLOCK D REGISTERED PLAN 775 CITY OF OTTAWA


Surveyed by Annis, O'Sullivan, Vollebekk Ltd. REVISION NOTE: Plan amended May 22, 2019

DISTANCES SHOWN ON THIS PLAN ARE IN METRES AND CAN BE CONVERTED TO FEET BY DIVIDING BY 0.3048

Surveyor's Certificate

 This survey and plan are correct and in accordance with the Surveys Act, the Surveyors Act and the Land Titles Act and the regulations 2. The survey was completed on the 30th day of April, 2019.

Notes &	Legen	d
De	enotes	
		Survey Monument Planted
		Survey Monument Found
SIB		Standard Iron Bar
SSIB		Short Standard Iron Bar
IB	n.	Iron Bar
CC	"	Cut Cross
CP	n ^N ,	Concrete Pin
(WIT)	H ×	Witness
Meas.	30 × 1	Measured
(AOG)	u	Annis, O'Sullivan, Vollebekk
(PI)	Ü	Registered Plan 749
(P2)	M .	Registered Plan 775
(P3)	a	Plan 4R-16358
(P4)	W	(1236) Plan November 11, 1
O _{FH}	u	Fire Hydrant
⊗ wv	н	Water Valve
o SP	"	Water Stand Post
O MH-ST	311	Maintenance Hole (Storm Se
O MH-S	m.	Maintenance Hole (Sanitary)
O MH	н	Maintenance Hole (Unidentif
T/G	n .	Top of Grate
⊖ ∨c		Valve Chamber (Watermain)
st	n.	Underground Storm Sewer
s	ж	Underground Sanitary Sewe
— w ——	W	Underground Water
—— Р ——		Underground Power
— G —	n .	Underground Gas
тv		Underground Cable
— в —		Underground Bell
c		Underground Rogers
□ св		Catch Basin
CRW		Concrete Retaining Wall
WRW	W 2	Wooden Retaining Wall
BRW	110	Brick Retaining Wall
SRW	H.	Stone Retaining Wall
CBRW		Concrete Block Retaining Wa
IRW	•	Interlock Retaining Wall
□ TB-B	ũ	Bell Terminal Box
□ TB-C	ii -	Cable Terminal Box
□ TB	ii	Unidentified Terminal Box
ов		Bollard
ΔS		Sign
Ø		Diameter
+65.00		Location of Elevations
+ 65.00*	u.	Top of Curb / Wall Elevation
C/L		Centreline
(
		Deciduous Tree
**	п	Coniferous Tree
1 1		

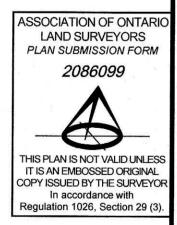

Bearings are grid, derived from Can-Net 2016 Real Time Network GPS observations and are referenced to Specified Control Points 01919680005 and 01919680105, MTM Zone 9 (76°30' West Longitude) NAD-83 (original). For bearing comparisons, a rotation of 0°33'10" counter-clockwise was applied to bearings on plans P1, P2, P3 & P4.

SITE AREA =5.5886 Hectares

ELEVATION NOTES

1. Elevations shown are geodetic and are referred to the CGVD28 geodetic datum. 2. It is the responsibility of the user of this information to verify that the job benchmark has not been altered or disturbed and that it's relative elevation and description agrees with the information shown on this drawing.

UTILITY NOTES

1. This drawing cannot be accepted as acknowledging all of the utilities and it will be the responsibility of the user to contact the respective utility authorities for confirmation. Only visible surface utilities were located.

3. A field location of underground plant by the pertinent utility authority is mandatory before any work involving breaking ground, probing, excavating etc. 4. Underground services on subject land are shown as marked on ground by MARK IT Locates Inc.

