


SITE PLAN GENERAL NOTES:

- 1. ALL GENERAL SITE INFORMATION AND CONDITIONS COMPILED FROM EXISTING PLANS AND SURVEYS 2. DO NOT SCALE THIS DRAWING
 - . REPORT ANY DISCREPANCIES PRIOR TO COMMENCING WORK. NO RESPONSIBILITY IS BORN BY THE CONSULTANT FOR UNKNOWN SUBSURFACE CONDITIONS
 - I. CONTRACTOR TO CHECK AND VERIFY ALL DIMENSIONS ON SITE AND REPORT ANY ERRORS AND/OR OMISSIONS TO THE
 - REINSTATE ALL AREAS AND ITEMS DAMAGED AS A RESULT OF CONSTRUCTION ACTIVITIES TO THE SATISFACTION OF THE CONSULTANT
 - 6. CONTRACTOR TO LAYOUT PLANTING BEDS, PATHWAYS ETC. TO APPROVAL OF CONSULTANT PRIOR TO ANY JOB EXCAVATION 7. THE ACCURACY OF THE POSITION OF UTILITIES IS NOT
- GUARANTEED CONTRACTOR TO VERIFY PRIOR TO EXCAVATION 8. INDIVIDUAL UTILITY COMPANY MUST BE CONTACTED FOR CONFIRMATION OF UTILITY EXISTENCE AND LOCATION PRIOR TO
- 9. ALL DISTURBED AREAS TO BE RESTORED TO ORIGINAL CONDITION OR BETTER UNLESS OTHERWISE NOTED

SITE PLAN LEGEND:

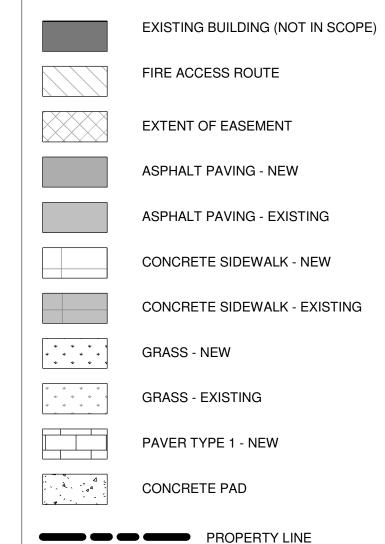

CSV ARCHITECTS

sustainable design · conception écologique

613.564.8118 190 O'Connor Street, Suite 100 Ottawa, Ontario,K2P 2R3 www.csv.ca

STRUCTURAL ENGINEER Cunliffe & Associates 200, 1550 Carling Avenue Ottawa, Ontario K1Z 8S8 613-729-7242 cunliffe@cunliffe.ca

MECHANICAL AND ELECTRICAL **ENGINEER** Chorley + Bisset Consulting Engineers 250 City Centre Avenue Ottawa, Ontario K1R 6K7 613-241-0030 email@chorley.com

LANDSCAPE ARCHITECT James B. Lennox & Associates 3332 Carling Avenue Ottawa, Ontario K2H 5A8 613-722-5168

STAMP

- 6 2025-03-17 Reissued for SPC 2025-02-19 Issued for Permit
- 4 2024-11-08 Issued for 80% Review 3 2024-10-08 Issued for SPC 2 2024-07-15 Issued for SPC

1 2024-07-19 Issued for 66% REV DATE ISSUE

NOTES 1. OWNERSHIP OF THE COPYRIGHT OF THE DESIGN AND THE WORKS EXECUTED FROM THE DESIGN REMAINS WITH CSV ARCHITECTS, AND MAY NOT BE REPRODUCED IN ANY FORM WITHOUT THE WRITTEN CONSENT OF CSV ARCHITECTS.

2. THE DRAWINGS, PRESENTATIONS AND SPECIFICATIONS AS INSTRUMENTS OF SERVICE ARE AND SHALL REMAIN THE PROPERTY OF CSV ARCHITECTS. THEY ARE NOT TO BE USED BY THE CLIENT ON OTHER PROJECTS OR ON EXTENSIONS TO THIS PROJECT WITHOUT THE WRITTEN CONSENT OF CSV ARCHITECTS.

3. THIS DRAWING IS TO BE READ IN CONJUNCTION WITH ALL OTHER PROJECT DRAWINGS AND SPECIFICATIONS. 4. DO NOT SCALE DRAWINGS. CONTRACTOR SHALL BE RESPONSIBLE TO VERIFY DIMENSIONS ON SITE. 5. ALL WORK SHALL BE IN ACCORDANCE WITH THE

ONTARIO BUILDING CODE AND ALL SUPPLEMENTS
AND APPLICABLE MUNICIPAL REGULATIONS.

CLIENT

BETTER LIVING CO-OPERATIVE

OTTAWA ONTARIO, CANADA

PROJECT

TITLE

BLOCK 3 **REDEVELOPMENT**

1360 OGILVIE ROAD GLOUCESTER, ON K1J 9M6


OVERALL SITE PLAN

PROJECT NO: 2022-2040 DRAWN: KM APPROVED: PM As indicated DATE PRINTED: 2025-05-16 9:23:44 AM

REV

DRAWING NO.

A100

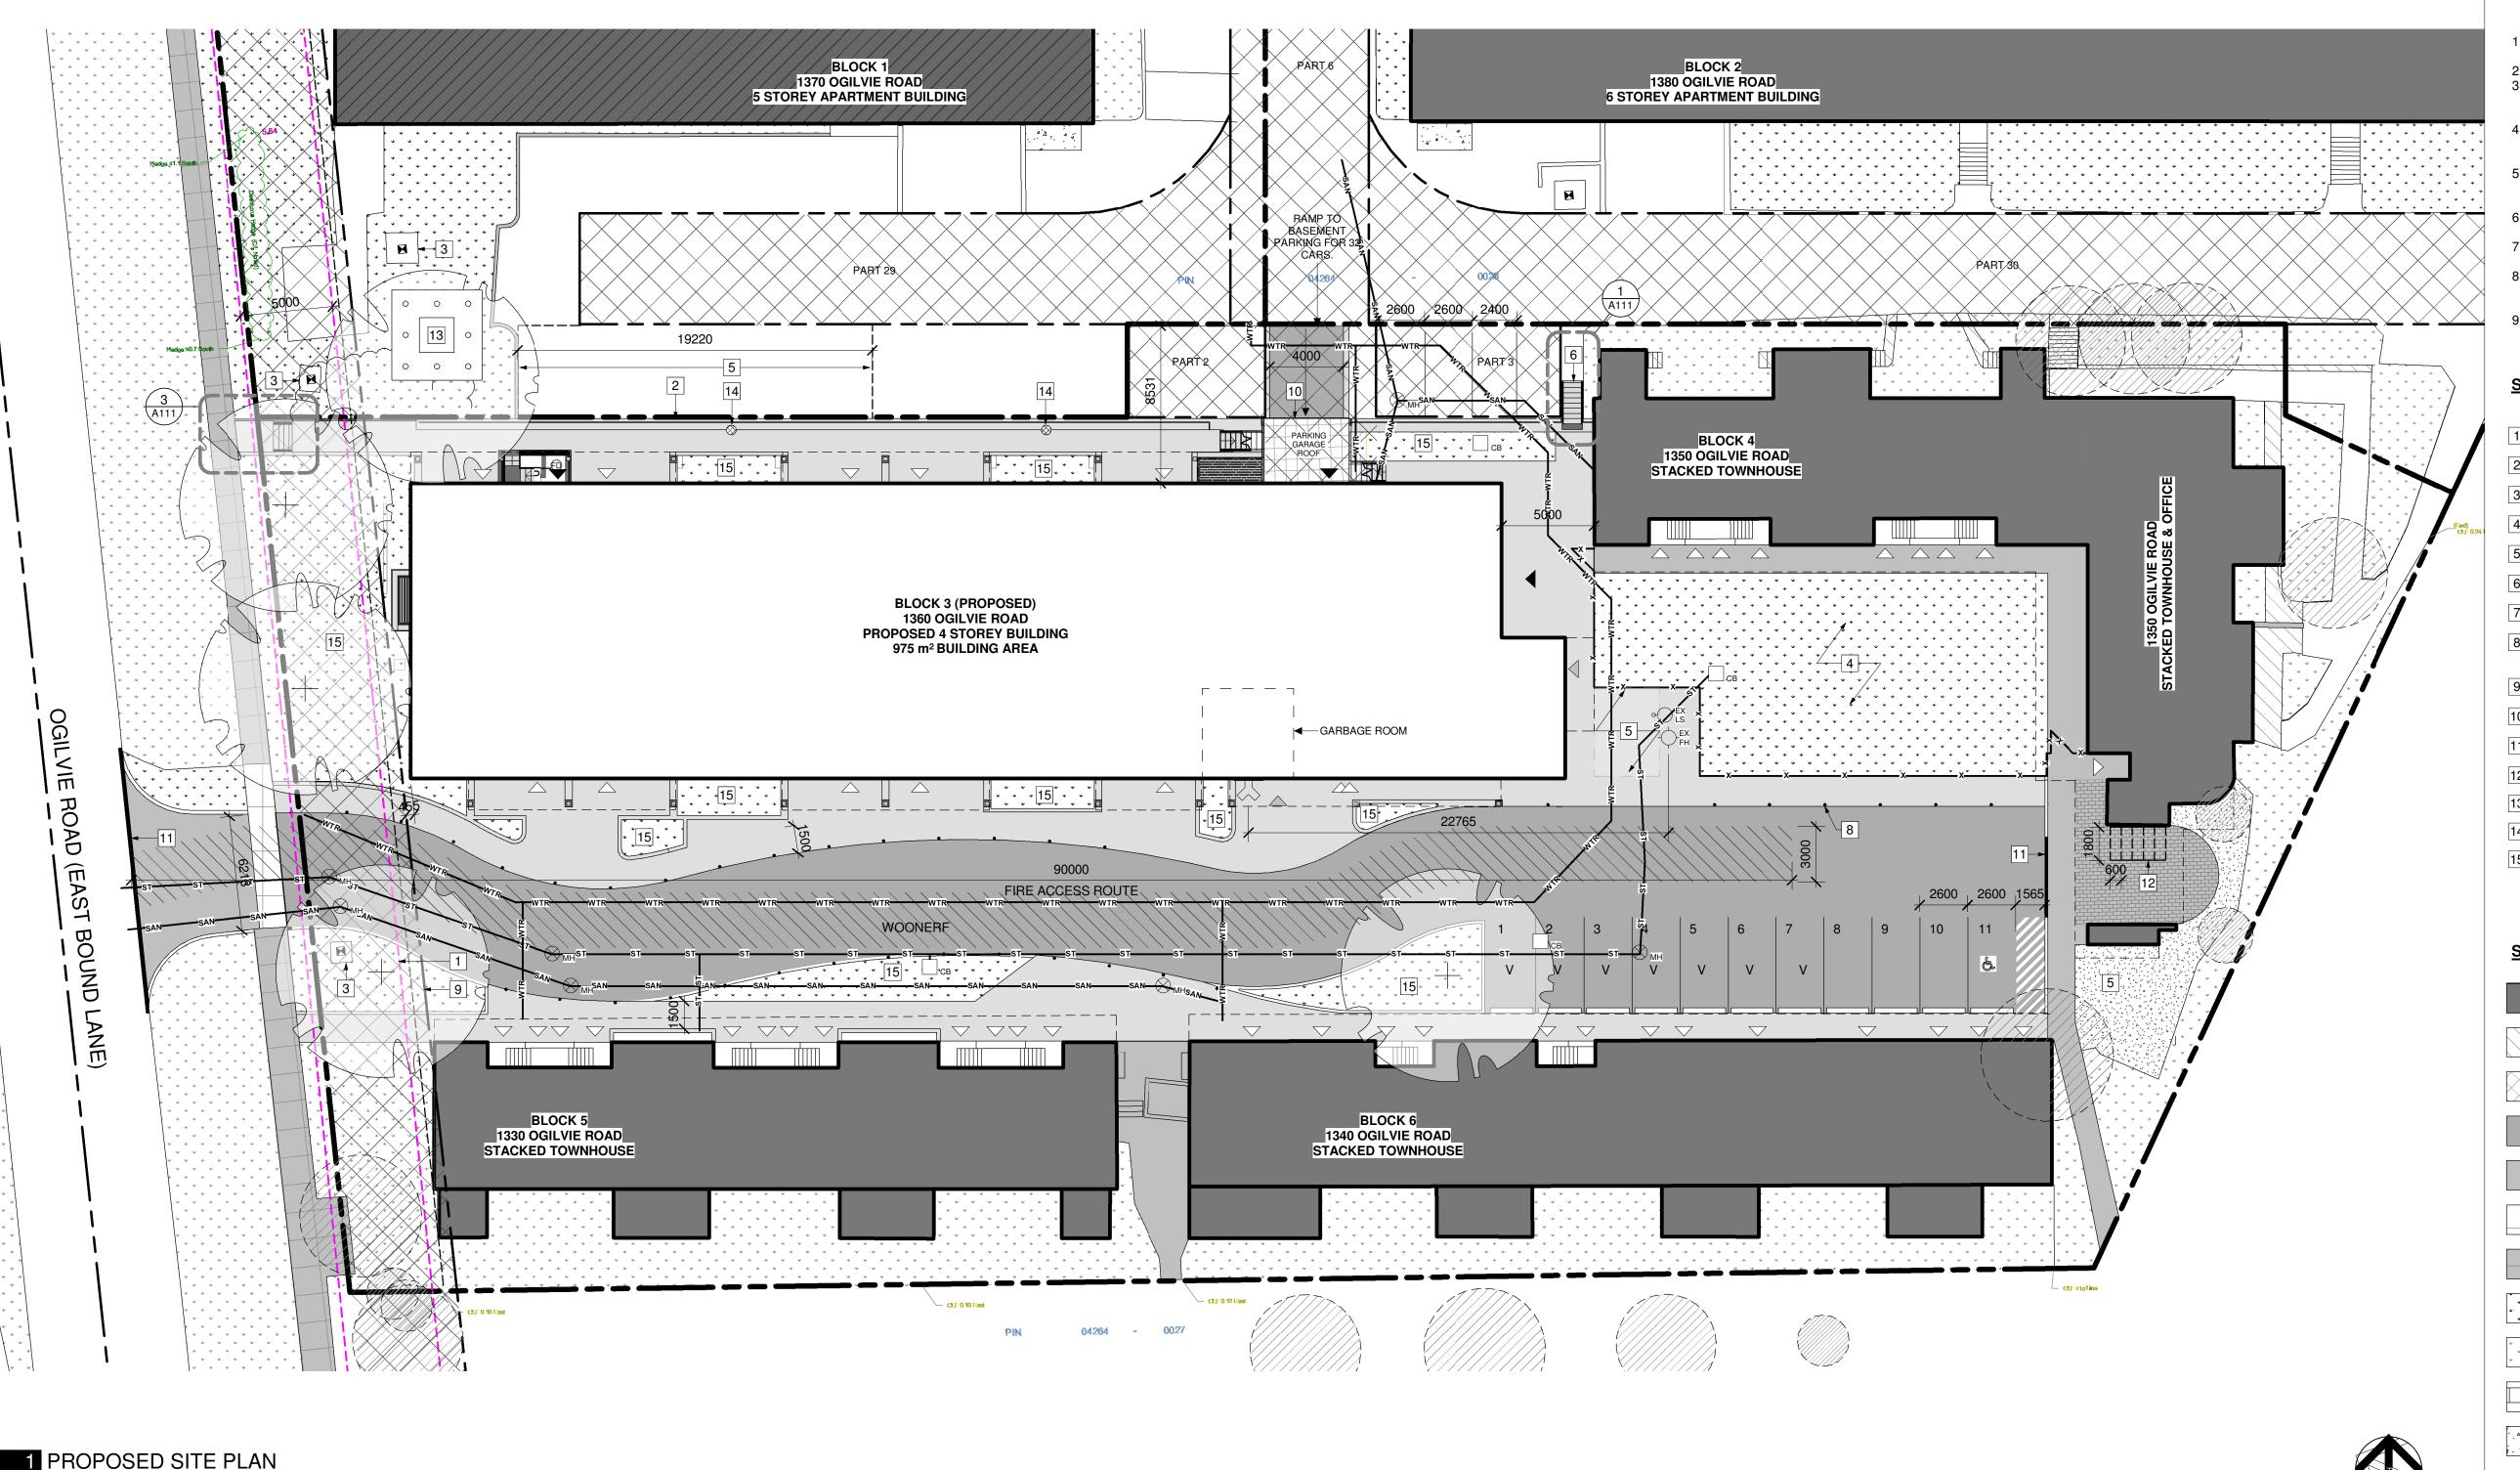

1 PROPOSED SITE PLAN

DEVELOPMENT INFO	ZONING INFO								
LEGAL DESCRIPTION	ZONING PROVISION	REQUIRED	PROVIDED	ZONING PROVISION	<u>REQUIRED</u>	PROVIDED	PARKING QUEING + LOADING	REQUIRED	PROVIDED -
BLOCKS C, D, AND L REGISTERED PLAN 4M-172 CITY OF OTTAWA	MIN. LOT WIDTH	No minimum	47.68m	GROUND FACADE ACTIVATION	The ground floor facade facing a public	Building is located within 6.1m of the	RESIDENTIAL SPACES	92	43
REFERENCE SURVEY	MIN. LOT AREA	No minimum	5323.54m ²	ACTIVATION	street of a building	front lot line. No	VISITOR SPACES	15	7
BASED ON INFORMATION FROM A SURVEY PREPARED BY ANNIS, O'SULLIVAN,	MIN. FRONT YARD SETBACK	Minimum: 0m	6.1m		located within 4.5 m o the front lot line must include: a minimum of	face Ogilvie Rd.	ACCESSIBLE PARKING	-	3
VOLLEBEKK LTD. DATED JULY 5, 2023	MIN. INTERIOR SIDE YARD	No minimum	N/A		one active entrance from each individual		BICYCLE PARKING	39	44
MUNICIPAL ADDRESS 1360 OGILVIE RD, OTTAWA, ON K1J 9M6	SETBACK MIN. REAR YARD SETBACK	7.5m	N/A		occupancy located immediately adjacent to the front lot line		DRIVEWAY WIDTH	3m @ single traffic lane	4m for single traffic lane,
SITE AREAS BETTER LIVING CO-OP 5323.54m ²	MAX. HEIGHT	40m	13.25m	MINIMUM GLAZING OF	50% of the surface	7.7 m2/ 72m2 =		6m @ double	driveway to parking garage
COMMUNITY WORKS 2558.69m ²	AMENITY AREA	462m2	552m ²	GROUND FLOOR	area of the ground	10.7% glazing		traffic lane	6m for double
BIRCHWOOD <u>5028.37m²</u> TOTAL 12,910.6m²	LANDSCAPED AREA	no minimum	349.5m ²	FACADE	floor façade facing Ogilvie, from the				traffic lane, parking lot
BUILDING AREA 975m ²	MIN. FRONTAGE	4.5m	4.3m		average grade up 4.5 metres, must be				"
GROSS FLOOR AREA 3,900m ²	FRONTAGE CALCULATION:	AMENITY BRI	EAKDOWN		comprised of transparent glazing				
BUILDING HEIGHT 14.15m , 4 STOREYS	43.5m OF BUILDING WALLS / 109.7m OF ENTIRE FRONTAGE = 39% OF		Amenity: 83m2 227m2		and active customer or resident entrance	or			
ZONE AM10 H(40)	FRONTAGE	Playground:	242m2		access doors				

	ACCOMO	DATIONS LI		NOTES:					
DWELLING UNIT TYPE		BLO	OCK		TOTAL	PARKING FIGURES IN TABLE REFLECT BLC			
	3(NEW)	4	5	6		SITE ONLY			
1-BEDROOM	26			0	26	2. TOTAL SITE PARKING: A. INCLUDING OFFICE, RESIDENT, AND			
2-BEDROOM	4	7	6	6	23	VISITOR PARKING SPACES: 170 SPACES			
3-BEDROOM	9	7	6	4	26	B. INLCUDING ONLY RESIDENT AND VISITOR; EXCLUDING OFFICE: 154 SPACES			
4-BEDROOM				1	1	EXCLOSING OTFICE: 104 OF NOES			
5-BEDROOM				1	1				
1-B(SENIOR)					0				
2-B(SENIOR)					0				
ТОТА	39	14	12	12	77				

DWELLING UNIT TYPE		BLC	OCK	ARKING LEG		TOTAL REQUIRED	TOTAL PARKING PROVIDED	
	3(NEW)	4	5	6	TOTAL	PARKING		
APARTMENT (1.2)	39				39	47		
STACKED (1.2)	0	14	12	12	38	46	36	
VISITOR PARKING (0.2)						15	7	
						108	total: 43	

AMENITY LEGEND									
	BLOCK				TOTAL	TOTAL REQUIRED	TOTAL AMENITY SPACE		
	3(NEW)	4	5	6	TOTAL	AMENITY SPACE (m2)	PROVIDED (m2)		
DWELLING UNITS	39	14	12	12	77	462	552		

SITE PLAN GENERAL NOTES:

- 1. ALL GENERAL SITE INFORMATION AND CONDITIONS COMPILED FROM EXISTING PLANS AND SURVEYS
 - 2. DO NOT SCALE THIS DRAWING B. REPORT ANY DISCREPANCIES PRIOR TO COMMENCING WORK. NO RESPONSIBILITY IS BORN BY THE CONSULTANT FOR
 - UNKNOWN SUBSURFACE CONDITIONS 4. CONTRACTOR TO CHECK AND VERIFY ALL DIMENSIONS ON SITE AND REPORT ANY ERRORS AND/OR OMISSIONS TO THE CONSULTANT
- 5. REINSTATE ALL AREAS AND ITEMS DAMAGED AS A RESULT OF CONSTRUCTION ACTIVITIES TO THE SATISFACTION OF THE CONSULTANT
- CONTRACTOR TO LAYOUT PLANTING BEDS, PATHWAYS ETC. TO APPROVAL OF CONSULTANT PRIOR TO ANY JOB EXCAVATION
- 7. THE ACCURACY OF THE POSITION OF UTILITIES IS NOT GUARANTEED - CONTRACTOR TO VERIFY PRIOR TO EXCAVATION 8. INDIVIDUAL UTILITY COMPANY MUST BE CONTACTED FOR CONFIRMATION OF UTILITY EXISTENCE AND LOCATION PRIOR TO
- ALL DISTURBED AREAS TO BE RESTORED TO ORIGINAL CONDITION OR BETTER UNLESS OTHERWISE NOTED

SITE PLAN KEYNOTES:

- OTTAWA HYDRO SETBACK / CLEARANCES
- NEW RETAINING WALL PER 1/A111
- EXISTING HYDRO TRANSFORMER ON CONCRETE PAD
- PLAYGROUND AREA (N.I.C)
- SNOW STORAGE
- NEW LANDSCAPE STAIR
- NOT IN USE
- BOLLLARDS ALONG PROPOSED WOONERF, REFER TO LANDSCAPE
- ROW EASEMENT
- LOCATION OF TRAFFIC SIGNAL
- DEPRESSED CURB
- NEW BIKE RACKS (5 TOTAL)
- NEW TRANSFORMER PER ELECTRICAL DOCUMENTS
- AREA DRAIN. REFER TO CIVIL DOCUMENTS
- SOFT LANDSCAPING PER LANDSCAPE

SITE PLAN LEGEND:

EXISTING BUILDING (NOT IN SCOPE)

FIRE ACCESS ROUTE

EXTENT OF EASEMENT

ASPHALT PAVING - NEW

ASPHALT PAVING - EXISTING

CONCRETE SIDEWALK - NEW

CONCRETE SIDEWALK - EXISTING

GRASS - NEW

GRASS - EXISTING

PAVER TYPE 1 - NEW

CONCRETE PAD

PROPERTY LINE

EASEMENT

FENCING PER LANDSCAPE

NEW DOMESTIC WATER **NEW SANITARY** _____ SAN _____

NEW STORM ____ sr ____

OTTAWA HYDRO SETBACK

NEW ELECTRICAL SERVICE BELOW GRADE

СВ CATCH BASIN --FH FIRE HYDRANT \bigotimes_{MH} MANHOLE

 $\stackrel{\checkmark}{\longrightarrow}$ SIAMESE CONNECTION 1360 OGILVIE ROAD GLOUCESTER, ON K1J 9M6

REDEVELOPMENT

CSV ARCHITECTS

sustainable design · conception écologique

613.564.8118

www.csv.ca

613-729-7242

ENGINEER

613-241-0030

613-722-5168

CIVIL ENGINEER

CIVIL ENGINEERS

115 Walgreen Road

info@mcintoshperry.com

McIntosh Perry

Carp, Ontario

613-836-2184

STAMP

NOTES

8 2025-03-17 Reissued for SPC

7 2025-02-19 Issued for Permit 6 2025-02-13 Permit Coordination 5 2024-11-08 Issued for 80% Review

4 2024-10-08 Issued for SPC

1 2024-07-19 Issued for 66%

CONSENT OF CSV ARCHITECTS.

CONSENT OF CSV ARCHITECTS.

SPECIFICATIONS.

CLIENT

OTTAWA

PROJECT

BLOCK 3

2. THE DRAWINGS, PRESENTATIONS AND

TO THIS PROJECT WITHOUT THE WRITTEN

REV DATE ISSUE

2024-10-07 Issued for Coordination 2 2024-07-15 Issued for SPC

1. OWNERSHIP OF THE COPYRIGHT OF THE DESIGN AND THE WORKS EXECUTED FROM THE DESIGN REMAINS WITH CSV ARCHITECTS, AND MAY NOT BE

REPRODUCED IN ANY FORM WITHOUT THE WRITTEN

SPECIFICATIONS AS INSTRUMENTS OF SERVICE ARE AND SHALL REMAIN THE PROPERTY OF CSV ARCHITECTS. THEY ARE NOT TO BE USED BY THE

CLIENT ON OTHER PROJECTS OR ON EXTENSIONS

3. THIS DRAWING IS TO BE READ IN CONJUNCTION WITH ALL OTHER PROJECT DRAWINGS AND

4. DO NOT SCALE DRAWINGS. CONTRACTOR SHALL BE RESPONSIBLE TO VERIFY DIMENSIONS ON SITE.

5. ALL WORK SHALL BE IN ACCORDANCE WITH THE ONTARIO BUILDING CODE AND ALL SUPPLEMENTS

AND APPLICABLE MUNICIPAL REGULATIONS.

BETTER LIVING

CO-OPERATIVE

ONTARIO, CANADA

address address

phone email

email@chorley.com

3332 Carling Avenue

Ottawa, Ontario K2H 5A8

STRUCTURAL ENGINEER

200, 1550 Carling Avenue

Ottawa, Ontario K1Z 8S8

MECHANICAL AND ELECTRICAL

Chorley + Bisset Consulting Engineers

Cunliffe & Associates

cunliffe@cunliffe.ca

250 City Centre Avenue

Ottawa, Ontario K1R 6K7

LANDSCAPE ARCHITECT James B. Lennox & Associates

190 O'Connor Street, Suite 100

Ottawa, Ontario,K2P 2R3


PROPOSED SITE PLAN

PROJECT NO: 2022-2040 DRAWN: KM APPROVED: PM

SCALE: As indicated DATE PRINTED: 2025-05-16 9:22:50 AM

REV

DRAWING NO. ₹ A110

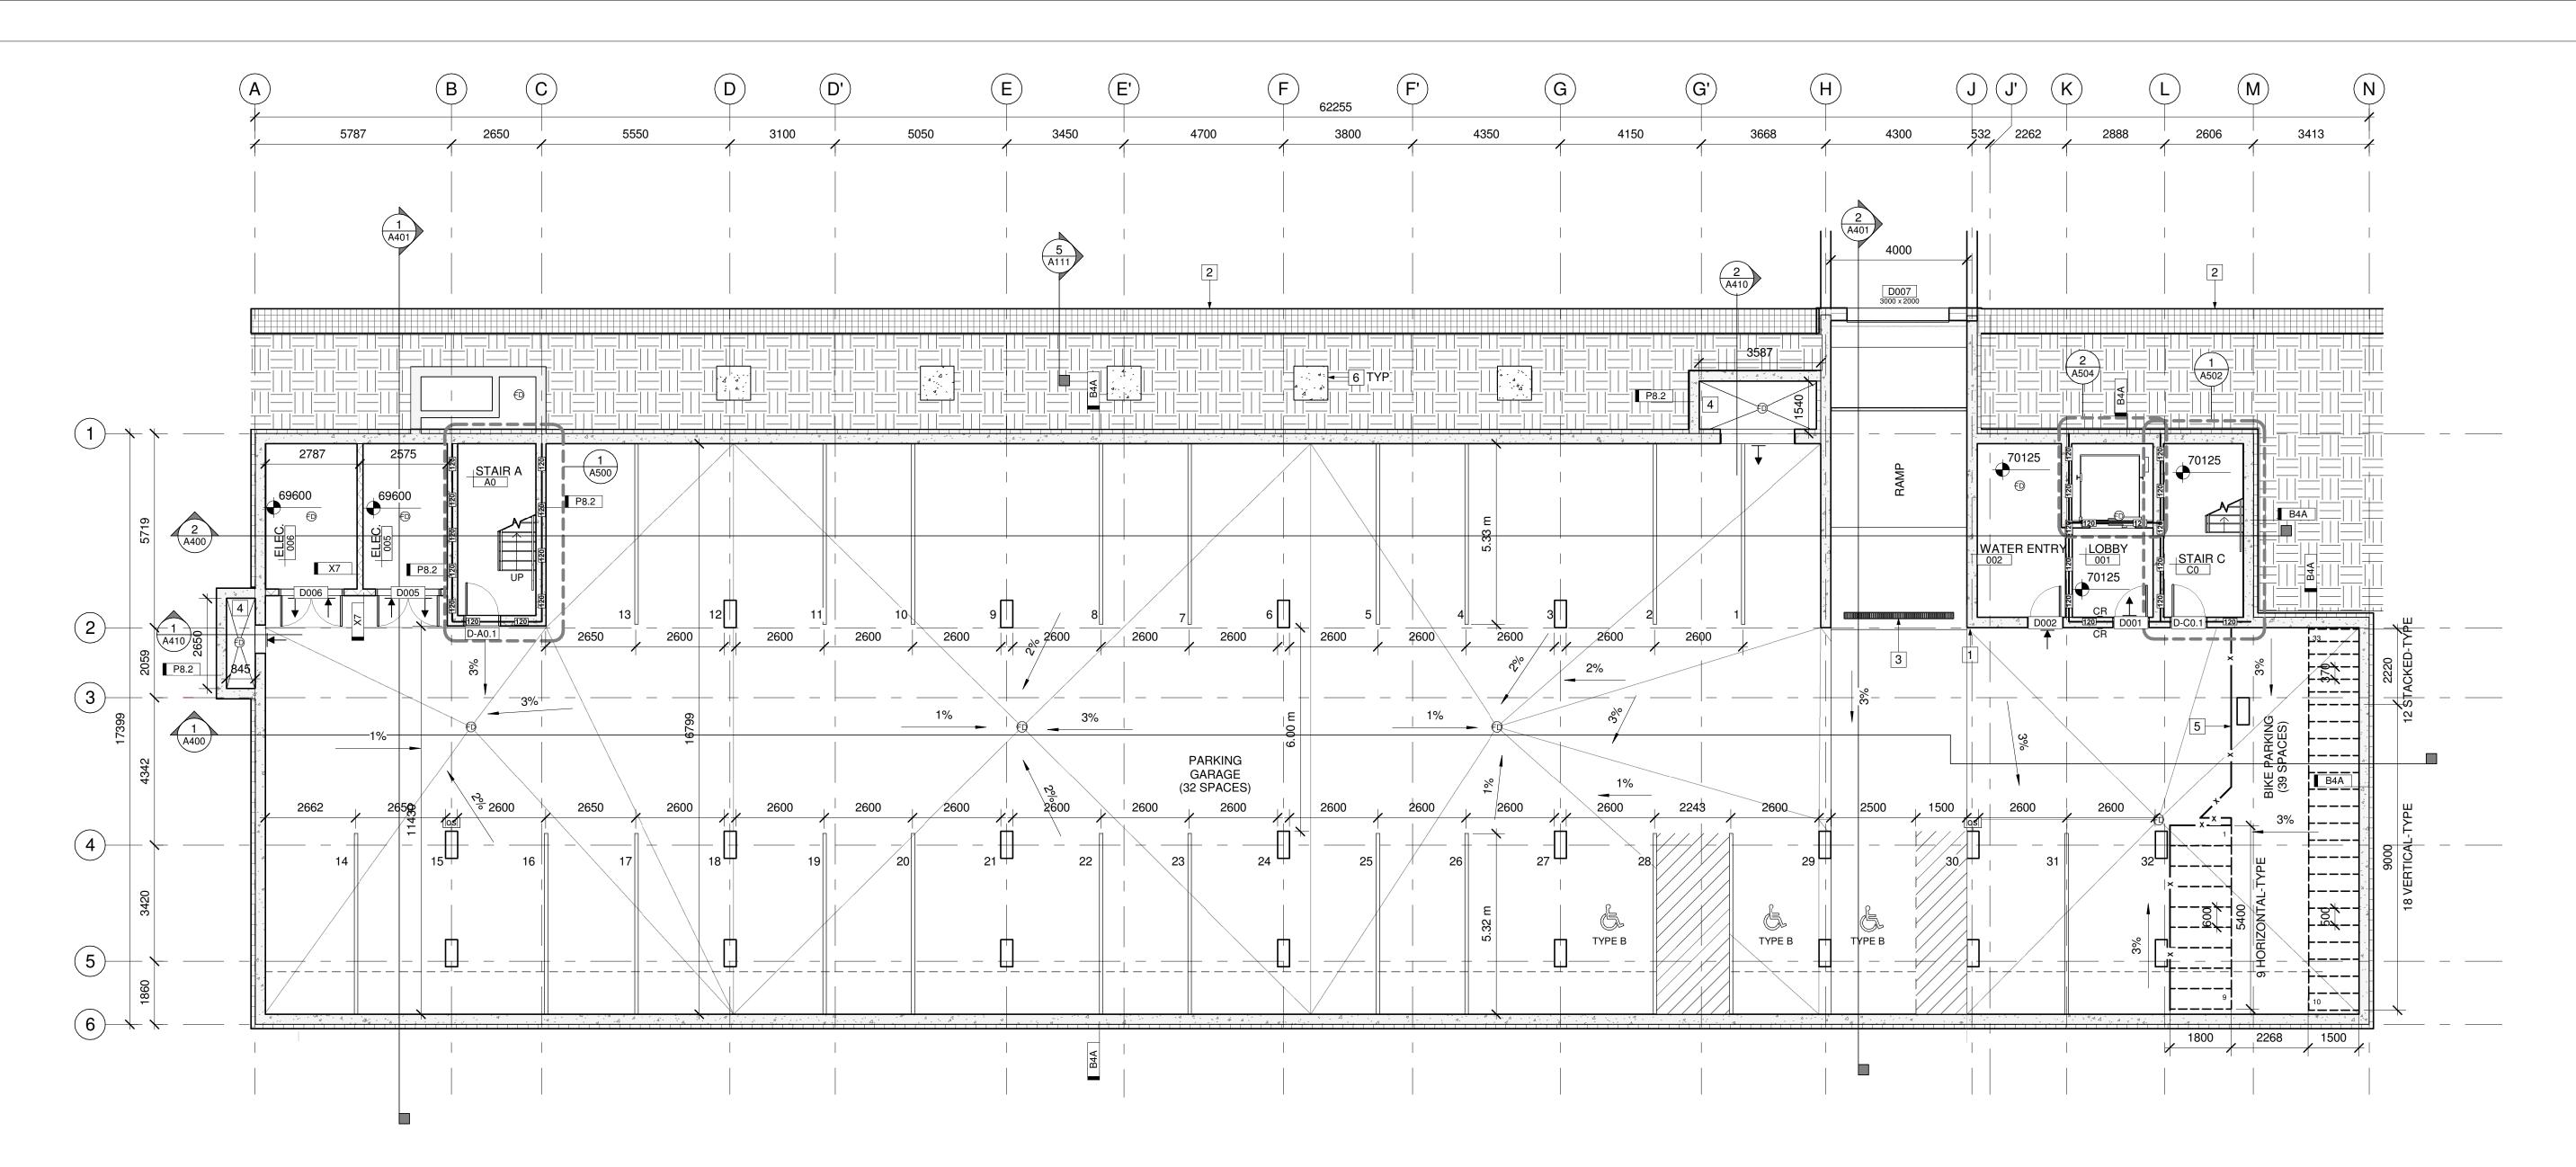

1 UNDERGROUND PARKING LEVEL

GENERAL REFERENCE PLAN NOTES:

1. ALL DIMENSIONS ARE TO FACE OF FRAMING UNLESS OTHERWISE NOTED.

2. ALL DOOR DIMENSIONS ARE TO THE CENTRE OR INSIDE OF FRAME. 3. ALL WINDOW DIMENSIONS ARE TO THE CENTER OR OUTSIDE OF FRAME.

UNDERGROUND PARKING PLAN KEYNOTES:

1 LOCATION OF TRAFFIC SIGNAL

2 PRE-ENGINEEREDE RETAINING WALL

TRENCH DRAIN, REFER TO MECHANICAL DOCUMENTS

4 AREAWAY

5 SECURE BIKE STORAGE. CHAINLINK FENCE W/ ACCESS DOOR. SECURE FENCE TO FLOOR SLAB AND TO U/S SLAB ABOVE

6 PIER FOOTING PER STRUCTURAL DOCUMENTS

LEGEND:

EARTH BACKFILL ACCESSIBLE PARKING AISLE — 0 MIN. FIRE RESISTANCE RATING 45 MIN. FIRE RESISTANCE RATING 60 MIN. FIRE RESISTANCE RATING

90 MIN. FIRE RESISTANCE RATING

DOOR CARD READER

FLOOR DRAIN, REFER TO MECHANICAL.

SENSOR, WALL INTAKE LOUVRE

EXHAUST LOUVRE

sustainable design · conception écologique

CSV ARCHITECTS

190 O'Connor Street, Suite 100 613.564.8118 Ottawa, Ontario,K2P 2R3 www.csv.ca

STRUCTURAL ENGINEER Cunliffe & Associates 200, 1550 Carling Avenue Ottawa, Ontario K1Z 8S8 613-729-7242 cunliffe@cunliffe.ca

MECHANICAL AND ELECTRICAL ENGINEER Chorley + Bisset Consulting Engineers 250 City Centre Avenue Ottawa, Ontario K1R 6K7 613-241-0030 email@chorley.com

LANDSCAPE ARCHITECT James B. Lennox & Associates 3332 Carling Avenue Ottawa, Ontario K2H 5A8 613-722-5168

CIVIL ENGINEER address address phone

email

CIVIL ENGINEERS McIntosh Perry 115 Walgreen Road Carp, Ontario 613-836-2184 info@mcintoshperry.com

STAMP

- 6 2025-03-17 Reissued for SPC 5 2025-02-19 Issued for Permit
- 4 2024-11-08 Issued for 80% Review 2 2024-07-15 Issued for SPC

1 2024-07-19 Issued for 66% REV DATE ISSUE

NOTES

1. OWNERSHIP OF THE COPYRIGHT OF THE DESIGN AND THE WORKS EXECUTED FROM THE DESIGN REMAINS WITH CSV ARCHITECTS, AND MAY NOT BE REPRODUCED IN ANY FORM WITHOUT THE WRITTEN CONSENT OF CSV ARCHITECTS. 2. THE DRAWINGS, PRESENTATIONS AND SPECIFICATIONS AS INSTRUMENTS OF SERVICE ARE AND SHALL REMAIN THE PROPERTY OF CSV ARCHITECTS. THEY ARE NOT TO BE USED BY THE CLIENT ON OTHER PROJECTS OR ON EXTENSIONS TO THIS PROJECT WITHOUT THE WRITTEN CONSENT OF CSV ARCHITECTS.

3. THIS DRAWING IS TO BE READ IN CONJUNCTION WITH ALL OTHER PROJECT DRAWINGS AND SPECIFICATIONS. 4. DO NOT SCALE DRAWINGS. CONTRACTOR SHALL BE RESPONSIBLE TO VERIFY DIMENSIONS ON SITE. 5. ALL WORK SHALL BE IN ACCORDANCE WITH THE ONTARIO BUILDING CODE AND ALL SUPPLEMENTS

AND APPLICABLE MUNICIPAL REGULATIONS.

CLIENT

OTTAWA

BETTER LIVING CO-OPERATIVE

ONTARIO, CANADA

PROJECT BLOCK 3 REDEVELOPMENT

1360 OGILVIE ROAD GLOUCESTER, ON K1J 9M6

UNDERGROUND

PARKING PLAN

PROJECT NO: 2022-2040 DRAWN: DF APPROVED: PM

1:100 DATE PRINTED: 3/17/2025 9:40:33 AM

REV

DRAWING NO. 7



ELEVATION NOTES:

CONTRACTOR TO COORDINATE WITH MANUFACTURER'S SPECIFICATIONS AND INSTALLATIONS GUIDELINES FOR ALL MATERIAL SEALING, TRANSITIONS, SEPARATIONS, FLASHING DETAILS, CONNECTIONS, ANCHORAGES, ETC. CONTRACTOR TO PROVIDE DETAIL DRAWINGS OR MOCK-UP FOR ARCHITECT'S REVIEW AND APPROVAL FOR ALL SPECIAL CONDITIONS NOT SHOWN IN THE CONTRACT DOCUMENTS.

ELEVATION KEYNOTES:

- 1 STOREFRONT WALL SYSTEM
- 2 CANOPY
- 3 JULIETTE BALCONY
- 4 PREFINISHED METAL FLASHING
- 5 ROOFTOP ACCESS
- 6 ELEVATOR OVERRUN
- 7 GARAGE DOOR
- 8 NEW LANDSCAPE STAIR C/W HANDRAIL AND GUARDRAIL
- 9 EMERGENCY EXIT STAIR
- 10 EXTERIOR LIGHT FIXTURE

ELEVATION LEGEND:

ACTUAL SPECIFIED MATERIALS.

HATCH PATTERNS SHOWN ARE FOR GRAPHIC PURPOSES ONLY AND SHOULD BE COORDINATED WITH

HATCH	SYMBOL	DESCRIPTION
		BRICK VENEER MANUFACTURER: COLOUR: BROWN
		ALUMINUM COMPOSITE PANEL MANUFACTURER: COLOUR: BLUE
		ALUMINUM COMPOSITE PANEL MANUFACTURER: COLOUR: WHITE
		WOOD SIDING MANUFACTURER: COLOUR: LIGHT OAK
		FASCIA MANUFACTURER:

COLOUR: GREY

CSV ARCHITECTS

sustainable design · conception écologique

613.564.8118 190 O'Connor Street, Suite 100 Ottawa, Ontario,K2P 2R3 www.csv.ca

STRUCTURAL ENGINEER Cunliffe & Associates 200, 1550 Carling Avenue Ottawa, Ontario K1Z 8S8 613-729-7242 cunliffe@cunliffe.ca

MECHANICAL AND ELECTRICAL **ENGINEER** Chorley + Bisset Consulting Engineers 250 City Centre Avenue Ottawa, Ontario K1R 6K7 613-241-0030 email@chorley.com

LANDSCAPE ARCHITECT James B. Lennox & Associates 3332 Carling Avenue Ottawa, Ontario K2H 5A8 613-722-5168

STAMP

- 4 2025-03-17 Reissued for SPC
- 3 2025-02-19 Issued for Permit 2 2024-11-08 Issued for 80% Review

1 2024-10-08 Issued for SPC REV DATE ISSUE

NOTES 1. OWNERSHIP OF THE COPYRIGHT OF THE DESIGN AND THE WORKS EXECUTED FROM THE DESIGN
AND THE WORKS EXECUTED FROM THE DESIGN
REMAINS WITH CSV ARCHITECTS, AND MAY NOT BE
REPRODUCED IN ANY FORM WITHOUT THE WRITTEN
CONSENT OF CSV ARCHITECTS.
2. THE DRAWINGS, PRESENTATIONS AND SPECIFICATIONS AS INSTRUMENTS OF SERVICE ARE AND SHALL REMAIN THE PROPERTY OF CSV ARCHITECTS. THEY ARE NOT TO BE USED BY THE CLIENT ON OTHER PROJECTS OR ON EXTENSIONS TO THIS PROJECT WITHOUT THE WRITTEN CONSENT OF CSV ARCHITECTS. 3. THIS DRAWING IS TO BE READ IN CONJUNCTION WITH ALL OTHER PROJECT DRAWINGS AND

SPECIFICATIONS. 4. DO NOT SCALE DRAWINGS. CONTRACTOR SHALL BE RESPONSIBLE TO VERIFY DIMENSIONS ON SITE. 5. ALL WORK SHALL BE IN ACCORDANCE WITH THE ONTARIO BUILDING CODE AND ALL SUPPLEMENTS AND APPLICABLE MUNICIPAL REGULATIONS.

CLIENT

BETTER LIVING CO-OPERATIVE

OTTAWA ONTARIO, CANADA

PROJECT

BLOCK 3 **REDEVELOPMENT**

1360 OGILVIE ROAD GLOUCESTER, ON K1J 9M6


NORTH ELEVATION

PROJECT NO: 2022-2040 DRAWN: DF APPROVED: DH As indicated

REV

DATE PRINTED: 3/25/2025 11:11:21 AM DRAWING NO. 7

A303

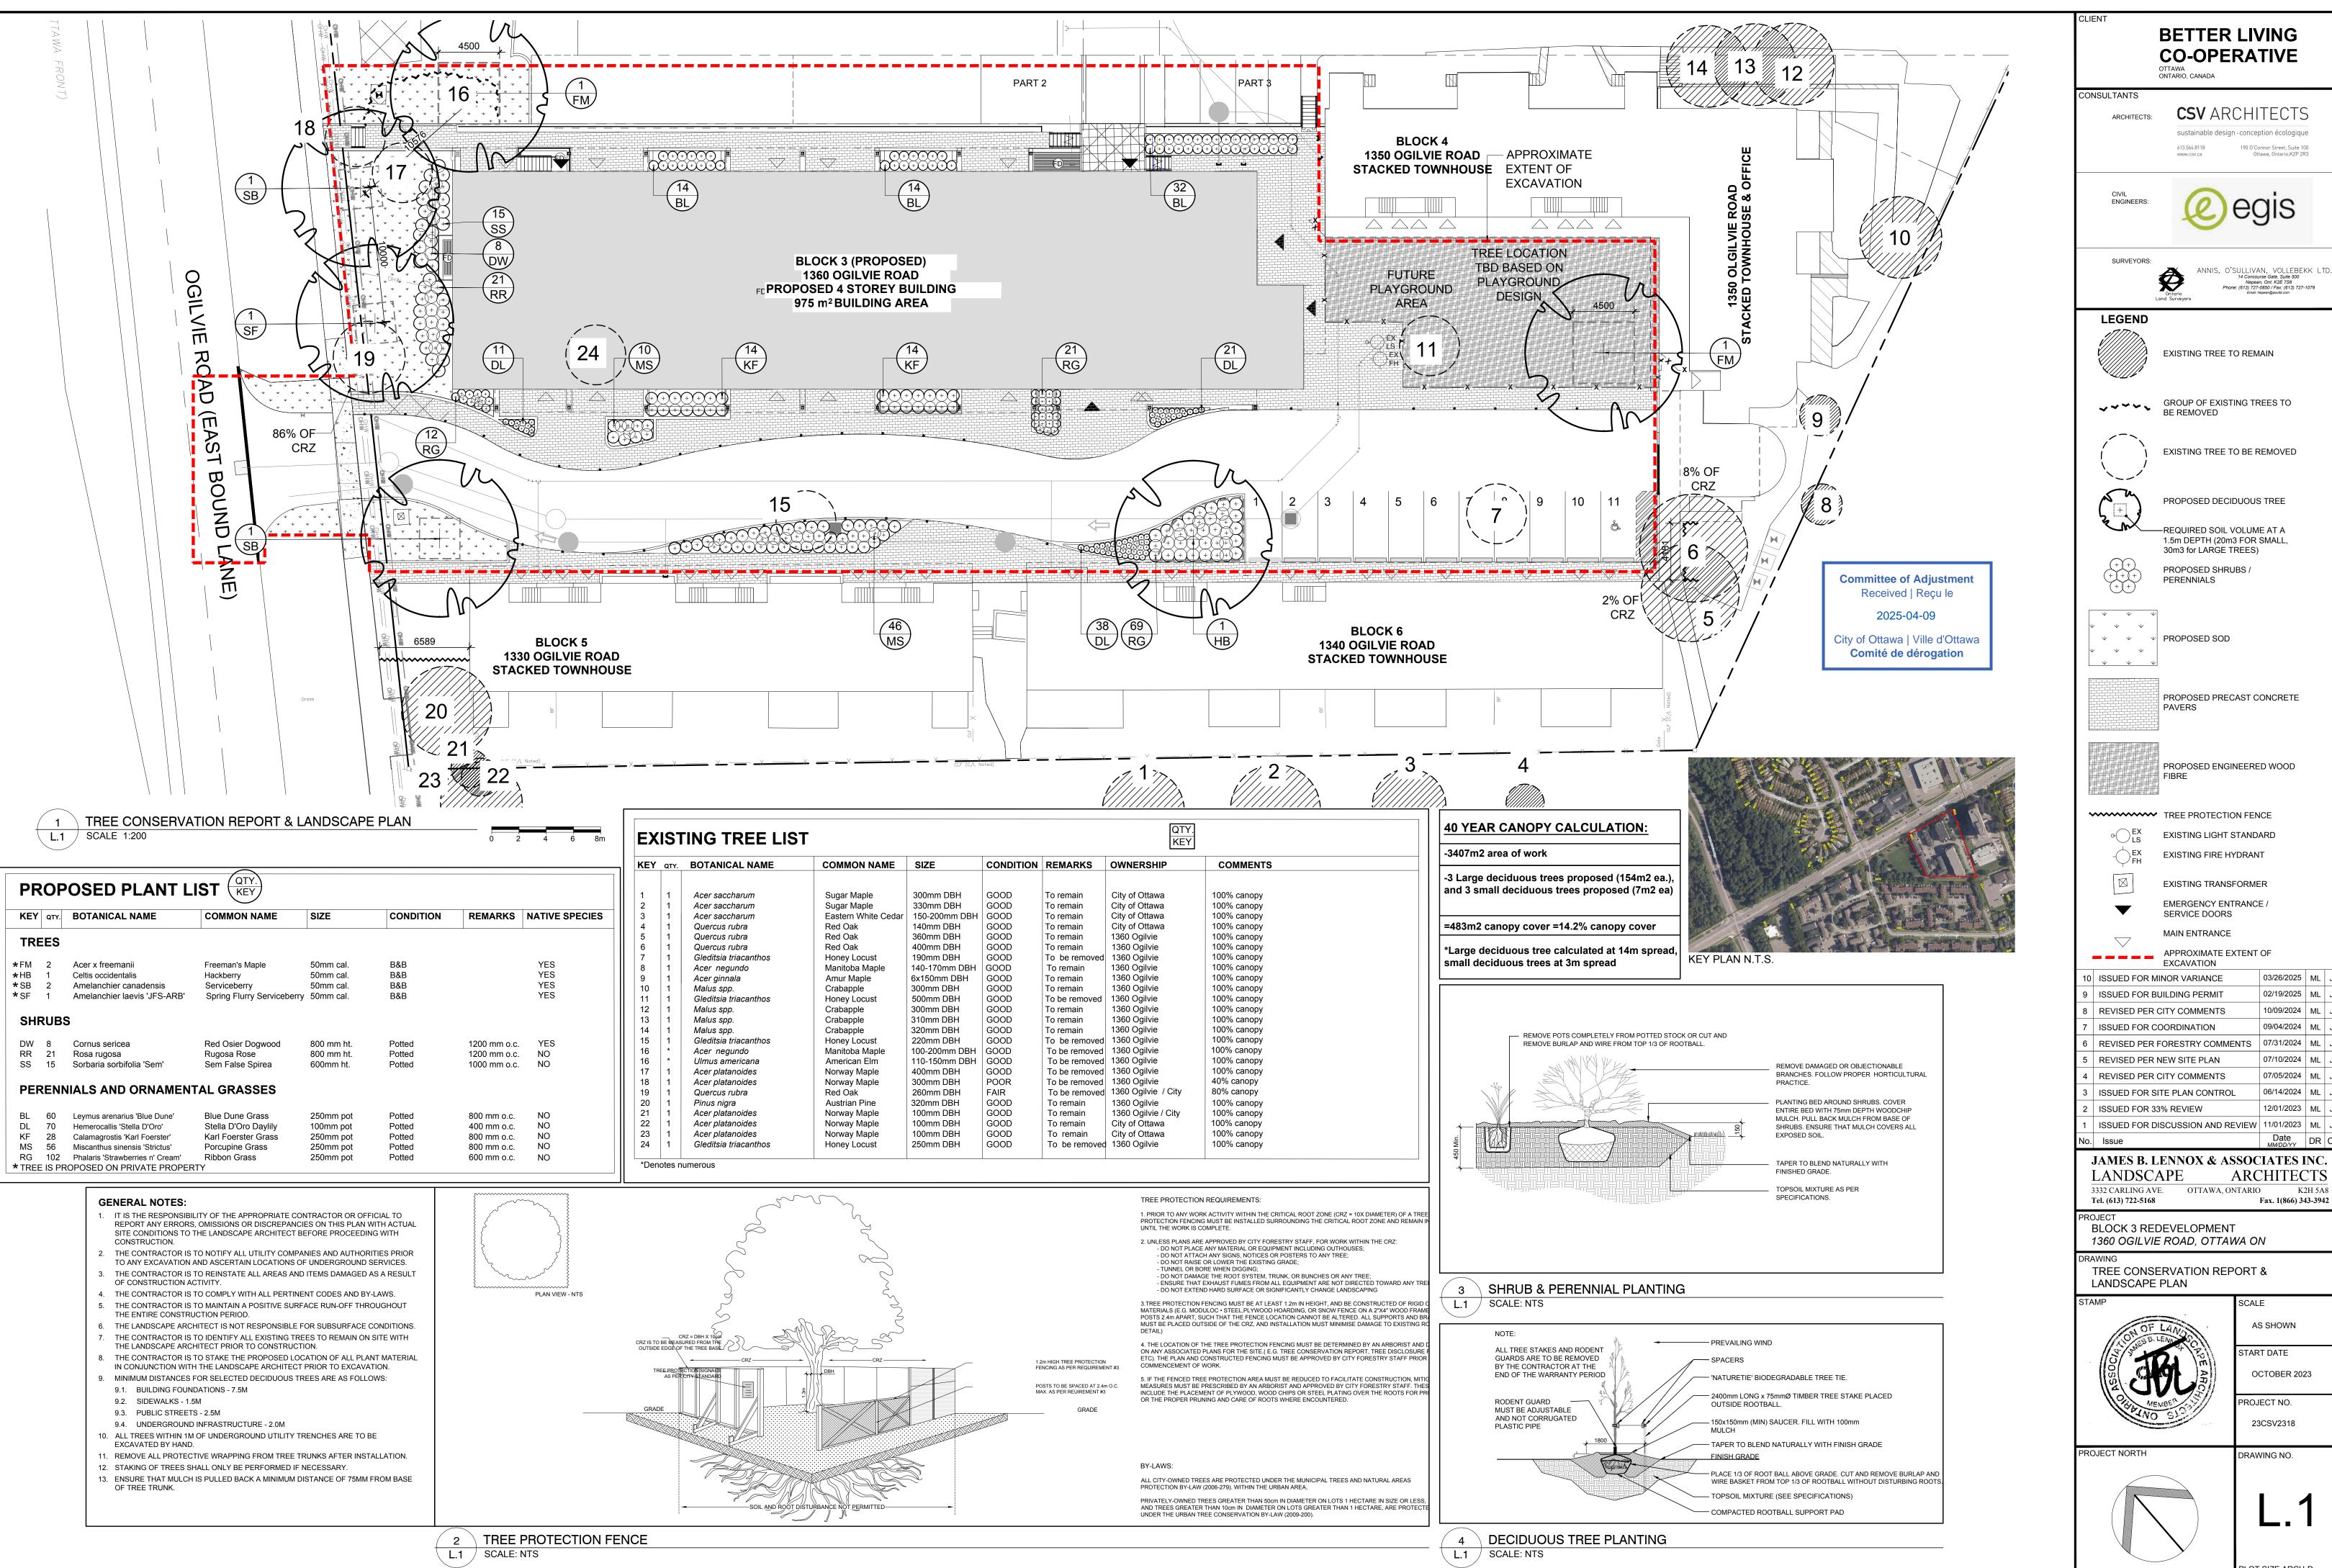

BETTER LIVING CO-OPERATIVE

CSV ARCHITECTS

sustainable design · conception écologique



ANNIS, O'SULLIVAN, VOLLEBEKK LTD.

14 Concourse Gate, Suite 500
Nepean, Ont. K2E 756
Phone: (61) 727-0850 / Fax: (613) 727-1079
Email: Nepean@aovitd.com

EXISTING TREE TO REMAIN

-REQUIRED SOIL VOLUME AT A 1.5m DEPTH (20m3 FOR SMALL

EXISTING TRANSFORMER

APPROXIMATE EXTENT OF

10	ISSUED FOR MINOR VARIANCE	03/26/2025	ML	J
9	ISSUED FOR BUILDING PERMIT	02/19/2025	ML	J
8	REVISED PER CITY COMMENTS	10/09/2024	ML	J
7	ISSUED FOR COORDINATION	09/04/2024	ML	J
6	REVISED PER FORESTRY COMMENTS	07/31/2024	ML	J
5	REVISED PER NEW SITE PLAN	07/10/2024	ML	J
4	REVISED PER CITY COMMENTS	07/05/2024	ML	J
3	ISSUED FOR SITE PLAN CONTROL	06/14/2024	ML	J
2	ISSUED FOR 33% REVIEW	12/01/2023	ML	J
1	ISSUED FOR DISCUSSION AND REVIEW	11/01/2023	ML	J
		Date		

JAMES B. LENNOX & ASSOCIATES INC. ARCHITECTS OTTAWA, ONTARIO K2H 5A8

> AS SHOWN TART DATE

OCTOBER 2023 ROJECT NO. 23CSV2318