

Ontario Email: Nepean@aovltd.com

and Surveyors Job No. 22430-21 Assad Bouayed Lt14 PL479600 R D2




Committee of Adjustment Received | Reçu le

2025-06-06

City of Ottawa | Ville d'Ottawa
Comité de dérogation



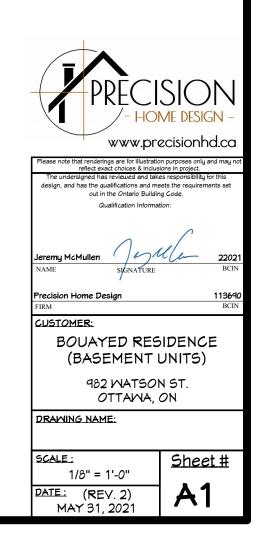





Please note that renderings are for illustration purposes only and may no reflect exact choices & inclusions in project.

The undersigned has reviewed and takes responsibility for this design and hap the unsilised ratios and makes the sequences.

Qualification Informatio

Jeremy McMuller

JULU-JRE

Precision Home Design

1136 BC

CUSTOMER:

BOUAYED RESIDENCE (BASEMENT UNITS)

982 WATSON ST. OTTAWA, ON

DRAWING NAME:

SCALE:

Sheet#

DATE: (REV. 2) MAY 31, 2021

A2

OWNER & BUILDER'S NOTE

THESE PLANS SHALL NOT BE USED FOR CONSTRUCTION UNTIL STAMPED AND SIGNED BY A QUALIFIED DESIGNER & THE LOCAL BUILDING DEPARTMENT. THE BUILDER IS EXPECTED TO FOLLOW THESE PLANS, APPLICABLE BUILDING CODES AND LOCAL ORDINANCES. HE SHALL VERIFY THAT SIT CONDITIONS ARE CONSISTENT WITH THESE PLANS BEFORE STARTING CONSTRUCTION. WHILE THESE PLANS ARE DRAWN TO SHOW THE PROPOSED WORK AS ACCURATELY AS POSSIBLE, SCHEMATIC DETAILS MAY BE USED IN SOME CASES FOR CLARITY. WORK NOT SPECIFICALLY DETAILED SHALL BE CONSTRUCTED TO THE SAME QUALITY AS SIMILAR WORK THAT IS DETAILED.

WRITTEN DIMENSIONS AND SPECIFIC NOTES SHALL TAKE PRECEDENCE OVER SCALED DIMENSIONS AND GENERAL NOTES. THE DESIGNER SHALL BE CONSULTED FOR CLARIFICATION IF SITE CONDITIONS ARE ENCOUNTERED THAT ARE DIFFERENT THAN SHOWN, IF DISCREPANCIES ARE FOUND IN THE PLANS OR NOTES, OR IF A QUESTION ARISES OVER THE INTENT OF THE PLANS OR NOTES.

THE DESIGNER ASSUMES NO RESPONSIBILITY FOR SCHEDULING, FABRICATION, CONSTRUCTION TECHNIQUES OR MATERIALS, OR QUANTITIES USED IN THE WORK. THE DESIGNER ASSUMES NO RESPONSIBILITY FOR FIELD CHANGES, SITE VARIANCES OR DISCREPANCIES NOT BROUGHT TO HIS HER ATTENTION FOR CLARIFICATION.

GENERAL NOTES

ALL WORK SHALL BE DONE IN ACCORDANCE WITH 2012 ONTARIO BUILDING CODE AND

FOUNDATION AND TRUSS DESIGN SHALL BE VERIFIED BY A QUALIFIED ENGINEER FOR COMPLIANCE WITH SITE REQUIREMENTS.

DIMENSIONS AND NOTES SHALL TAKE PRECEDENCE OVER THE SCALING OF DRAWINGS.

WALL DIMENSIONS ARE TO THE EXTERIOR OF FRAMING UNLESS NOTED OTHERWISE.

LUMBER COMING IN CONTACT WITH CONCRETE OR MASONRY SHALL BE TREATED OR PROTECTED WITH AN APPROVED VAPOR BARRIER.

CONTINUOUS CONTACT WITH THE GROUND SHALL BE TREATED TO A MINIMUM OF .60 CCA.

ALL FRAMING LUMBER TO BE #2 OR BETTER DF OR EQUIVALENT, UNLESS NOTED OTHERWISE

EXTERIOR AND INTERIOR MATERIALS AND FINISHES TO BE DETERMINED BY OWNER.

ALL REQUIRED SMOKE ALARMS NEED A VISUAL COMPONENT.

BLOCKING FOR NON-LOAD BEARING INTERIOR WALLS PARALLEL TO FLOOR JOISTS SHALL BE MIN 2×4 @ $4^{\circ}0^{\circ}$ O.C.

CHIMNEY HEIGHT SHALL BE DETERMINED USING A 10' RADIUS PLANE AND SHALL BE 2' HIGHER THAN ANY ROOF SURFACE 10' FROM THE CHIMNEY.

DOWNSPOUTS TO BE COLLECTED AND ROOF RUN OFF TO BE DIRECTED AWAY FROM STRUCTURE.

FINISH GRADE SHALL SLOPE AWAY FROM STRUCTURE MIN. 1/2" PER FOOT OF RUN FOR

SOIL PARAMETERS: BASED ON SOILS INDIGENOUS TO THE AREA: BEARING PRESSURE - 1600 PSF. (T5 kPa) LATERAL ACTIVE PRESSURE 35 PSF FLUID

SOIL-CONCRETE COEFFICIENT 0.35 SOIL PROFILE SD

BUILDING PERFORMANCE

HEAT LOSS CALCULATIONS SHALL COMPLY WITH THE REQUIREMENTS OF REGIONAL AND LOCAL CODES. SEE CALCULATIONS.

PORCHES AND GARAGE AREAS NOT INCLUDED IN LIVING AREA.

ALL EXHAUST FANS TO BE VENTED DIRECTLY TO THE EXTERIOR.

ALL PENETRATIONS OF THE BUILDING ENVELOPE SHALL BE SEALED WITH POLYURETHANE FOAM.

ALL COMBUSTION APPLIANCES WILL BE VENTED DIRECTLY TO THE EXTERIOR

FURNACE FIREBOX SHALL HAVE OUTSIDE COMBUSTION AIR SUPPLY PURSUANT TO REGIONAL AND LOCAL CODES.

ATTIC ACCESS:

A MINIMUM OF 22" \times 36". THERE SHALL BE 30" MIN. CLEARANCE AT OR ABOVE THE OPENING.

LOCATED IN A CORRIDOR, HALLWAY OR OTHER READILY ACCESSIBLE LOCATION. ATTICS WITH A MAXIMUM VERTICAL HEIGHT OF LESS THAN 30" WILL NOT REQUIRE ACCESS OPENINGS.

HATCHWAYS TO ATTIC OR ROOF SPACES SHALL BE FITTED WITH DOORS OR COVERS.

YENTILATION:

WHERE INSULATION IS INSTALLED BETWEEN A CEILING AND THE UNDERSIDE OF THE ROOF SHEATHING, A SPACE SHALL BE PROVIDED BETWEEN THE INSULATION AND THE SHEATHING, AND VENTS SHALL BE INSTALLED TO PERMIT THE MOVEMENT OF AIR FROM THE SPACE TO THE EXTERIOR.

ATTIC SHALL HAVE VENTILATION EQUAL TO 1 SQ. FOOT PER 150 SQ. FEET OF ATTIC SPACE. VENTILATION SHALL BE PROTECTED FROM SNOW AND RAIN. OPENINGS SHALL BE LOCATED TO PROVIDE CROSS VENTILATION.

UNDER FLOOR SPACES SHALL HAVE VENTILATION EQUAL TO ONE SQ. FOOT PER 150 SQ. FEET OF FLOOR SPACE, VENTS SHALL BE CAST INTO THE CONCRETE STEM WALLS AND COVERED WITH GALVANIZED WIRE SCREEN. VENTS SHALL BE LOCATED TO PROVIDE CROSS VENTILATION.

RAILING NOTES:

STAIRWAYS SHALL HAVE A MIN. WIDTH OF 35" MEASURED BETWEEN WALL FACES OR GUARDS

TREADS SHALL HAVE A MIN. DEPTH OF 9-1/4". STAIR TREADS MUST BE UNIFORM AND CAN NOT VARY FROM THE LARGEST TO THE SMALLEST BY MORE THAN 1/4".

STAIRWAYS SHALL HAVE MIN. 6'-5" OF HEADROOM AT THE NOSE OF THE STAIR.

STAIRWAYS SHALL HAVE AT LEAST ONE HANDRAIL LOCATED 34" TO 38" ABOVE THE NOSING OF TREADS AND LANDINGS. THE HAND GRIP PORTION OF HANDRAILS SHALL NOT BE LESS THAN 1-1/2" OR GREATER THAN 2" IN CROSS-

HANDRAILS SHALL BE CONTINUOUS THE FULL LENGTH OF THE STAIRS. THE ENDS OF HANDRAILS SHALL RETURN TO WALL OR TERMINATE INTO A NEWEL POST OR SAFETY TERMINAL.

STAIRWAYS HAVING LESS THAN 2 RISERS DO NOT REQUIRE A HAND RAIL.

36" MIN. HEIGHT GUARDRAILS SHALL BE PROVIDED FOR AT PORCHES, DECKS, BALCONIES, STAIRWAYS AND LANDINGS WHERE THE ADJACENT SURFACE IS LESS THAN 24" BELOW

RAILING AND GUARDRAIL BALUSTER SPACING SHALL BE NO GREATER THAN 4".

THE TRIANGULAR OPENINGS FORMED BY THE RISER, TREAD, AND BOTTOM OF GUARDRAIL SHALL NOT ALLOW A 4" DIAMETER SPHERE TO PASS THROUGH.

WINDOWS AND DOORS

MINDOMS SHALL BE DOUBLE PANE WITH VINYL FRAMES AND CONFORM TO CAN/CSA-A440 MANUFACTURER AND COLOR TO BE DETERMINED BY OWNER.

EVERY BEDROOM SHALL BE PROVIDED WITH AN EGRESS WINDOW WITH FINISH SILL HEIGHT NOT GREATER THAN 39" ABOVE THE FINISH FLOOR HEIGHT (EXCLUDING BASEMENTS) AND SHALL HAVE A MINIMUM OPENABLE AREA OF 3.8 SQ. FT. EGRESS WINDOWS SHALL NOT HAVE AN OPENABLE AREA LESS THAN 15" WIDE OR 24" HIGH.

SAFETY GLAZING SHALL BE PROVIDED IN DOORS AND ENCLOSURES FOR HOT TUBS, WHIRLPOOLS, SAUNAS, STEAM ROOMS, BATHTUBS, AND SHOWERS.

ALL EXTERIOR DOORS AND WINDOWS SHALL BE FINISHED WITH WEATHER RESISTANT COATINGS AND WEATHER STRIPPED.

DOORS BETWEEN GARAGE AND LIVING AREA SHALL BE 1-3/4" TIGHT FITTING SOLID CORE DOORS WITH A RATING OF 20 MINUTES. DOOR SHALL BE SELF CLOSING.

MAIN ENTRANCE DOORS TO DWELLING UNITS SHALL BE PROVIDED WITH, A DOOR VIEWER OR TRANSPARENT GLAZING IN THE DOOR, OR A SIDELIGHT.

		= 00=			m.o	DOOK SCHEDULE		
NUMBER	QIY	FL00R	Hועווא	HEIGHT		DESCRIPTION	AREA, ACTUAL (SQ FT)	COMMENTS
D01	2	0	18 "	96 "	20 1/2"X99 1/2"	HINGED-3 PANEL	12.0	
D02	10	0	30 "	96 "	32 1/2"X99 1/2"	HINGED-3 PANEL	20.0	
D03	2	0	72 "	96 "	74"X99"	4 DR. BIFOLD-DOOR P05	48.0	
D04	2	1	120 "	96 "	123"X98"	GARAGE-MESTFIELD STYLELINE III 8'	80.0	
D05	2	1	196 "	96 "	197"X97"	MULLED UNIT-HR	130.67	
D06	4	1	30 "	96 "	62"X100 1/2"	POCKET-3 PANEL	20.0	
DOT	4	1	36 "	80 "	39"X83 3/4"	EXT. HINGED-6 PANEL	20.0	
D08	2	1	48 "	96 "	50 1/2"X99 1/2"	DOUBLE HINGED-3 PANEL	32.0	
D09	2	1	56 "	96 "	57"X97"	MULLED UNIT-HR	37.33	
D10	8	2	30 "	96 "	32 1/2"X99 1/2"	HINGED-3 PANEL	20.0	
D11	2	2	30 "	96 "	62"X100 1/2"	POCKET-3 PANEL	20.0	
D12	6	2	60 "	96 "	62 1/2"X99 1/2"	DOUBLE HINGED-3 PANEL	40.0	
TOTALS:							1480.0	

DOOR SCHEDING

	WINDOW SCHEDULE											
NUMBER	QTY	FL00R	MIDTH	HEIGHT	R/O	DESCRIPTION	AREA, ACTUAL (SQ FT)	COMMENTS				
M01	6	0	72 "	24 "	73"X25"	LEFT SLIDING	12.0					
M02	4	1	24 "	84 "	25"X85"	FIXED GLASS	14.0					
M03	2	1	48 "	12 "	49"X13"	SINGLE AMNING	4.0					
M04	3	2	36 "	84 "	37"X85"	SINGLE CASEMENT-HL	21.0					
M05	3	2	36 "	84 "	37"X85"	SINGLE CASEMENT-HR	21.0					
M06	2	2	48 "	24 "	49"X25"	FIXED GLASS	8.0					
MOT	2	2	60 "	24 "	61"X25"	FIXED GLASS	10.0					
M08	4	2	66 "	84 "	67"X85"	MULLED UNIT-HR	38.5					
TOTALS:							452.0					


NOTES:

- 1. GRIDS AS PER ELEVATIONS
- 2. DOUBLE PANE WINDOWS / DOORS

REVISIONS	DATE
(REV.1) CHANGES FROM CITY DEFICIENCY LIST DATED JUNE 10/21	JUNE 15/21
(REV.2) CHANGES FROM CITY DEFICIENCY LIST DATED JULY 29/21	SEPT 9/21


			PRECIS - HOM www.prec
TABLE 3.1.1.2./ ZONE 1 - COMPLIANCE PACK		> 92%	Please note that renderings are for illustration preflect exact choices & inclusions The undersigned has reviewed and takes notesign, and has the qualifications and meets
COMPONENT	THERMAL	PACKAGE	out in the Ontario Building C Qualification Information
COMPONENT	VALUES	A2	
EILING w/ ATTIC SPACE		60	
EILING WIO ATTIC SPACE		31	Jeremy McMullen
EXPOSED FLOOR		12 + 18 C.I	NAME SIGNATURE
MALLS ABOYE GRADE		22 + 5 C.I.	/
BASEMENT WALLS	Ī ,,,,,	12 + 10 C.I.	Precision Home Design
OW GRADE SLAB ENTIRE	MIN. NOMINAL	10 C.I.	CUSTOMER:

COMPONENT	THERMAL	PACKAGE	
OOMI ONENI	VALUES	A2	
CEILING W/ ATTIC SPACE		60	
CEILING W/o ATTIC SPACE		31	
EXPOSED FLOOR		12 + 18 C.I	
WALLS ABOVE GRADE		22 + 5 C.I.	
BASEMENT WALLS		12 + 10 C.I.	
BELOW GRADE SLAB ENTIRE SURFACE > 600mm BELOW GRADE	MIN. NOMINAL 'R'	10 C.I.	
HEATED SLAB OR SLAB < 600mm BELOW GRADE		N/A	
EDGE OF BELOW GRADE SLAB < 600 mm BELOW GRADE		N/A	
WINDOWS AND SLIDING GLASS DOORS	ENERGY RATING	25	
SKYLIGHTS	MAX. U	0.49	
SPACE HEATING EQUIPMENT	MIN. AFUE	96 %	
HRV	MIN. SRE	75 %	
DOMESTIC WATER HEATER	MIN. EF	0.70	
	-		

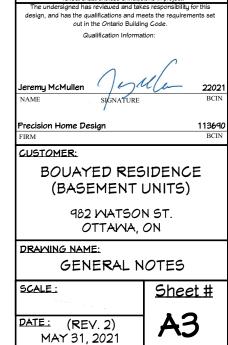

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ALL EXTERIOR DIMENSIONS ARE FROM CONCRETE

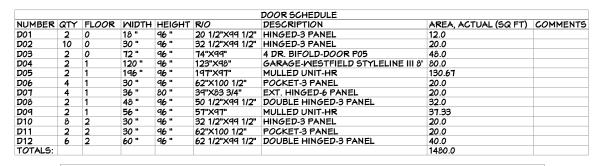

	MINDOM SCHEDULE										
NUMBER	QTY	FLOOR	MIDTH	HEIGHT	R/0	DESCRIPTION	AREA, ACTUAL (SQ FT)	COMMENTS			
M01	6	0	72 "	24 "	73"X25"	LEFT SLIDING	12.0				
M02	4	1	24 "	84 "	25"X85"	FIXED GLASS	14.0				
M03	2	1	48 "	12 "	49"X13"	SINGLE AMNING	4.0				
M04	3	2	36 "	84 "	37"X85"	SINGLE CASEMENT-HL	21.0				
M05	3	2	36 "	84 "	37"X85"	SINGLE CASEMENT-HR	21.0				
M06	2	2	48 "	24 "	49"X25"	FIXED GLASS	8.0				
MOT	2	2	60 "	24 "	61"X25"	FIXED GLASS	10.0				
M08	4	2	66 "	84 "	67"X85"	MULLED UNIT-HR	38.5				
TOTAL G.							452.0				

EXISTING GAS FURNACE TO PROVIDE HEATING FOR BOTH FLOORS. DUCTWORK SMOKE ALARM SHALL BE INSTALLED IN SUPPLY TRUNK WHERE ANY DUCTWORK PASSES THRU A FIRE SEPARATION.

> WRAP ENTIRE EXISTING FLOOR BEAM, POSTS AND DUCTWORK W/ 2 LAYERS 1/2" "TYPE X" DRYWALL

1hr

FLOOR FIRE AND SOUND RESISTANCE RATING: O.B.C. SB-3 FLOOR F9g (1h, STC= 51) 3/4" T&G O.S.B.GLUED AND SCREWED

PRE-ENG. OPEN WEB FLOOR JOISTS R14 BATT INSULATION RESILIENT CHANNEL @ 16" O.C 2 LAYERS 1/2" TYPE "X" GYPSUM BOARD

1hr


WALL FIRE AND SOUND RESISTANCE RATING: O.B.C. SB-3 WALL W4d (1h, STC= 53)

1 LAYER 1/2" TYPE "X" GYPSUM BOARD 2x4 OR 2x6 @ 24" O.C. STUD WALL R14 BATT INSULATION RESILIENT CHANNEL @ 24" O.C 2 LAYERS 1/2" TYPE "X" GYPSUM BOARD


1hr

MALL FIRE AND SOUND RESISTANCE RATING: O.B.C. SB-3 WALL W13b (1hr, STC= 57)

2 ROWS 2x4 @ 16" O.C. (STUDS STAGGERED) w/ 1" AIRSPACE BETWEEN R14 BATT INSULATION ON BOTH SIDES 1 LAYER 1/2" TYPE "X" GYPSUM BOARD EACH SIDE

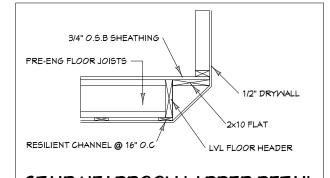

STAIR HEADROOM LADDER DETAIL

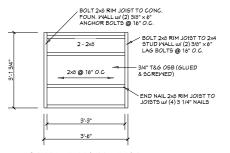

STAIR LANDING FRAMING / CONNECTION DETAIL



reflect exact choices & inclusions in project.

The undersigned has reviewed and takes responsibility for this design, and has the qualifications and meets the requirements set out in the Ontario Building Code.

Qualification Information:

Jeremy McMullen

Precision Home Design

CUSTOMER:

BOUAYED RESIDENCE (BASEMENT UNITS)

982 WATSON ST. OTTAWA, ON

DRAWING NAME:


FOUNDATION PLAN

<u>5CALE :</u> 1/8" = 1'-0"

Sheet #


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PATE: (REV. 2)
MAY 31, 2021



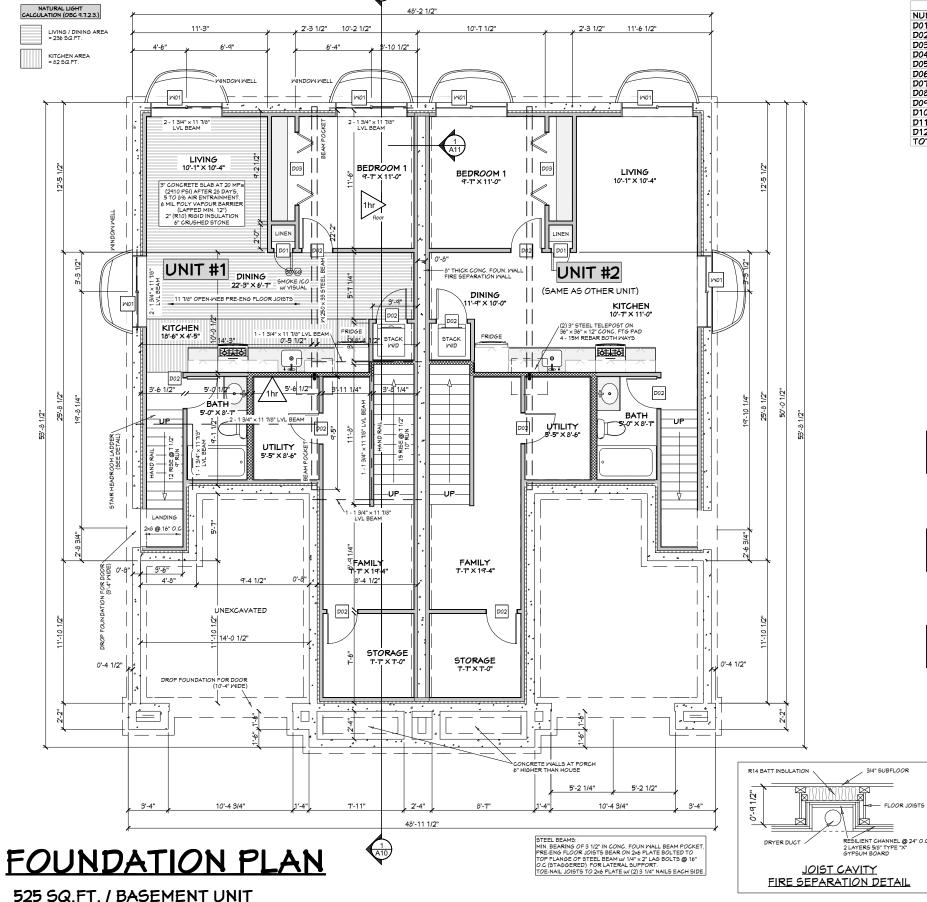

ALL INTERIOR DIMENSIONS ARE FROM FRAMING

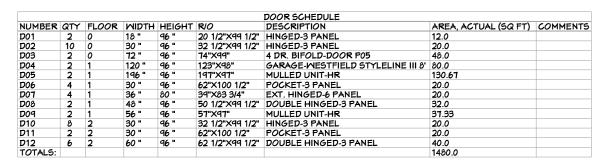

	MINDOM SCHEDULE										
NUMBER	QTY	FL00R	MIDTH	HEIGHT	R/O	DESCRIPTION	AREA, ACTUAL (SQ FT)	COMMENTS			
M01	6	0	72 "	24 "	73"X25"	LEFT SLIDING	12.0				
M02	4	1	24 "	84 "	25"X85"	FIXED GLASS	14.0				
M03	2	1	48 "	12 "	49"X13"	SINGLE AMNING	4.0				
M04	3	2	36 "	84 "	37"X85"	SINGLE CASEMENT-HL	21.0				
M05	3	2	36 "	84 "	37"X85"	SINGLE CASEMENT-HR	21.0				
M06	2	2	48 "	24 "	49"X25"	FIXED GLASS	8.0				
MOT	2	2	60 "	24 "	61"X25"	FIXED GLASS	10.0				
M08	4	2	66 "	84 "	67"X85"	MULLED UNIT-HR	38.5				
TOTALS:							452.0				

1hr

FLOOR FIRE AND SOUND RESISTANCE RATING: O.B.C. SB-3 FLOOR F9g (1h, STC= 51)

3/4" T&G O.S.B GLUED AND SCREWED PRE-ENG. OPEN WEB FLOOR JOISTS R14 BATT INSULATION RESILIENT CHANNEL @ 16" O.C 2 LAYERS 1/2" TYPE "X" GYPSUM BOARD

WALL FIRE AND SOUND RESISTANCE RATING: O.B.C. SB-3 WALL W4d (1h, STC= 53)

1 LAYER 1/2" TYPE "X" GYPSUM BOARD 2x4 OR 2x6 @ 24" O.C. STUD WALL R14 BATT INSULATION RESILIENT CHANNEL @ 24" O.C 2 LAYERS 1/2" TYPE "X" GYPSUM BOARD



WALL FIRE AND SOUND RESISTANCE RATING: O.B.C. SB-3 WALL W13b (1hr, STC= 57)

2 ROMS 2x4 @ 16" O.C. (STUDS STAGGERED) w/ 1" AIRSPACE BETMEEN R14 BATT INSULATION ON BOTH SIDES 1 LAYER 1/2" TYPE "X" GYPSUM BOARD EACH SIDE

GARAGE WALLS PROTECTED FROM GAS & EXHAUST FUMES W/ AIR BARRIER W/ ALL JOINTS TAPED AND SEALED TIGHT. DOORS WILL BE TIGHT FITTING AND WEATHER STRIPPED TO PREVENT PASSING OF GASSES & EXHAUST FUMES. AS WELL AS EQUIPPED W/ A SELF CLOSING DEVICE.



design, and has the qualifications and meets the requirements set

out in the Ontario Building Code.

Precision Home Design

113690

22021

CUSTOMER:

BOUAYED RESIDENCE (BASEMENT UNITS)

> 982 WATSON ST. OTTAMA, ON

DRAWING NAME:


GROUND FLOOR PLAN

SCALE:

Sheet #

DATE: (REV. 2) MAY 31, 2021

1/8" = 1'-0"

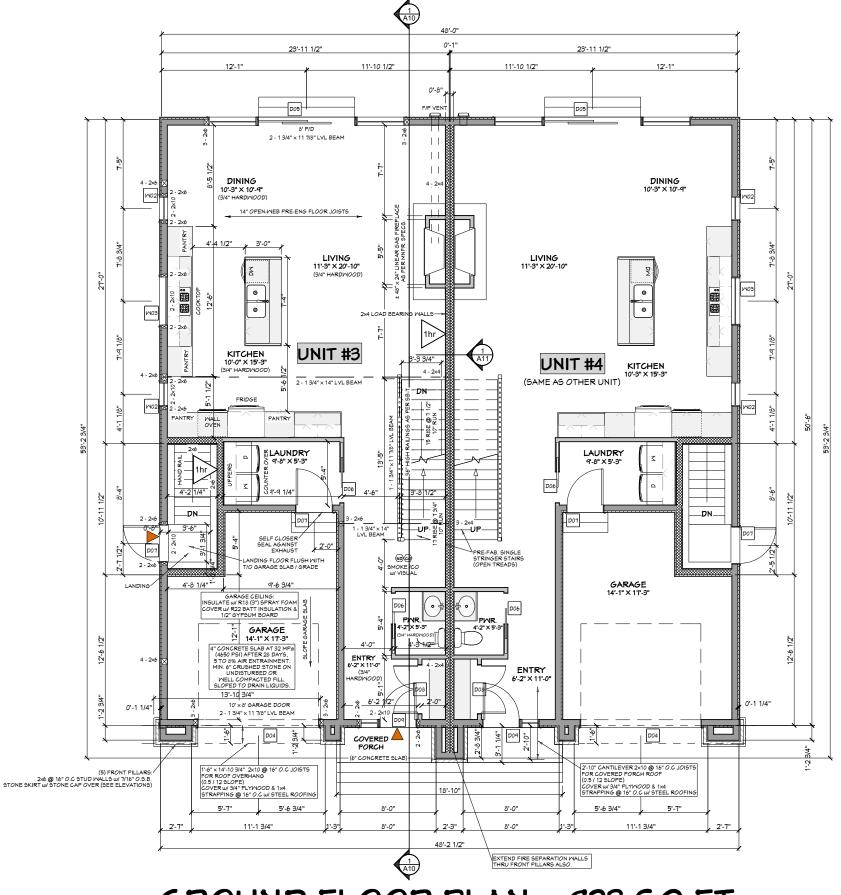


GROUND FLOOR PLAN = 923 SQ.FT.


SECOND FLOOR = 1164 SQ.FT. TOTAL = 2087 SQ.FT.




ALL INTERIOR DIMENSIONS ARE FROM FRAMING

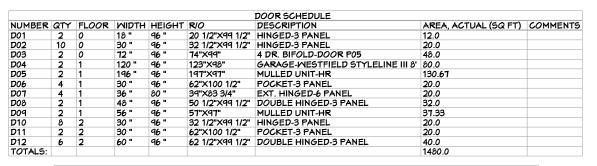

	MINDOM SCHEDULE										
NUMBER	QTY	FL00R	MIDTH	HEIGHT	R/O	DESCRIPTION	AREA, ACTUAL (SQ FT) C	OMMENTS			
M01	6	0	72 "	24 "	73"X25"	LEFT SLIDING	12.0				
M02	4	1	24 "	84 "	25"X85"	FIXED GLASS	14.0				
M03	2	1	48 "	12 "	49"X13"	SINGLE AWNING	4.0				
M04	3	2	36 "	84 "	37"X85"	SINGLE CASEMENT-HL	21.0				
M05	3	2	36 "	84 "	37"X85"	SINGLE CASEMENT-HR	21.0				
M06	2	2	48 "	24 "	49"X25"	FIXED GLASS	8.0				
MOT	2	2	60 "	24 "	61"X25"	FIXED GLASS	10.0				
M08	4	2	66 "	84 "	67"X85"	MULLED UNIT-HR	38.5				
TOTALS:							452.0				

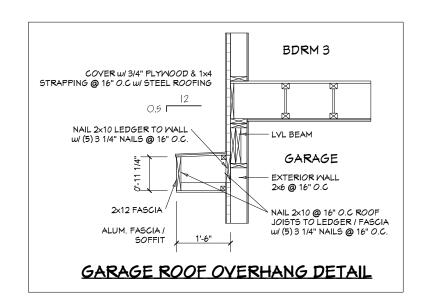

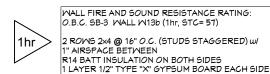

GARAGE WALLS PROTECTED FROM GAS & EXHAUST FUMES W/ AIR BARRIER W/ ALL JOINTS TAPED AND SEALED TIGHT. DOORS WILL BE TIGHT FITTING AND WEATHER STRIPPED TO PREVENT PASSING OF GASSES & EXHAUST FUMES. AS WELL AS EQUIPPED W/ A SELF CLOSING DEVICE.



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The undersigned has reviewed and takes responsibility for this design, and has the qualifications and meets the requirements set out in the Ontario Building Code.

SIGNATURE BCIN
Home Design 113690

Precision Home Design
FIRM

CUSTOMER:

BOUAYED RESIDENCE (BASEMENT UNITS)

982 WATSON ST. OTTAWA, ON

DRAWING NAME:

SECOND FLOOR PLAN


5CALE: 1/8" = 1'-0"

DATE: (REV. 2)

MAY 31, 2021


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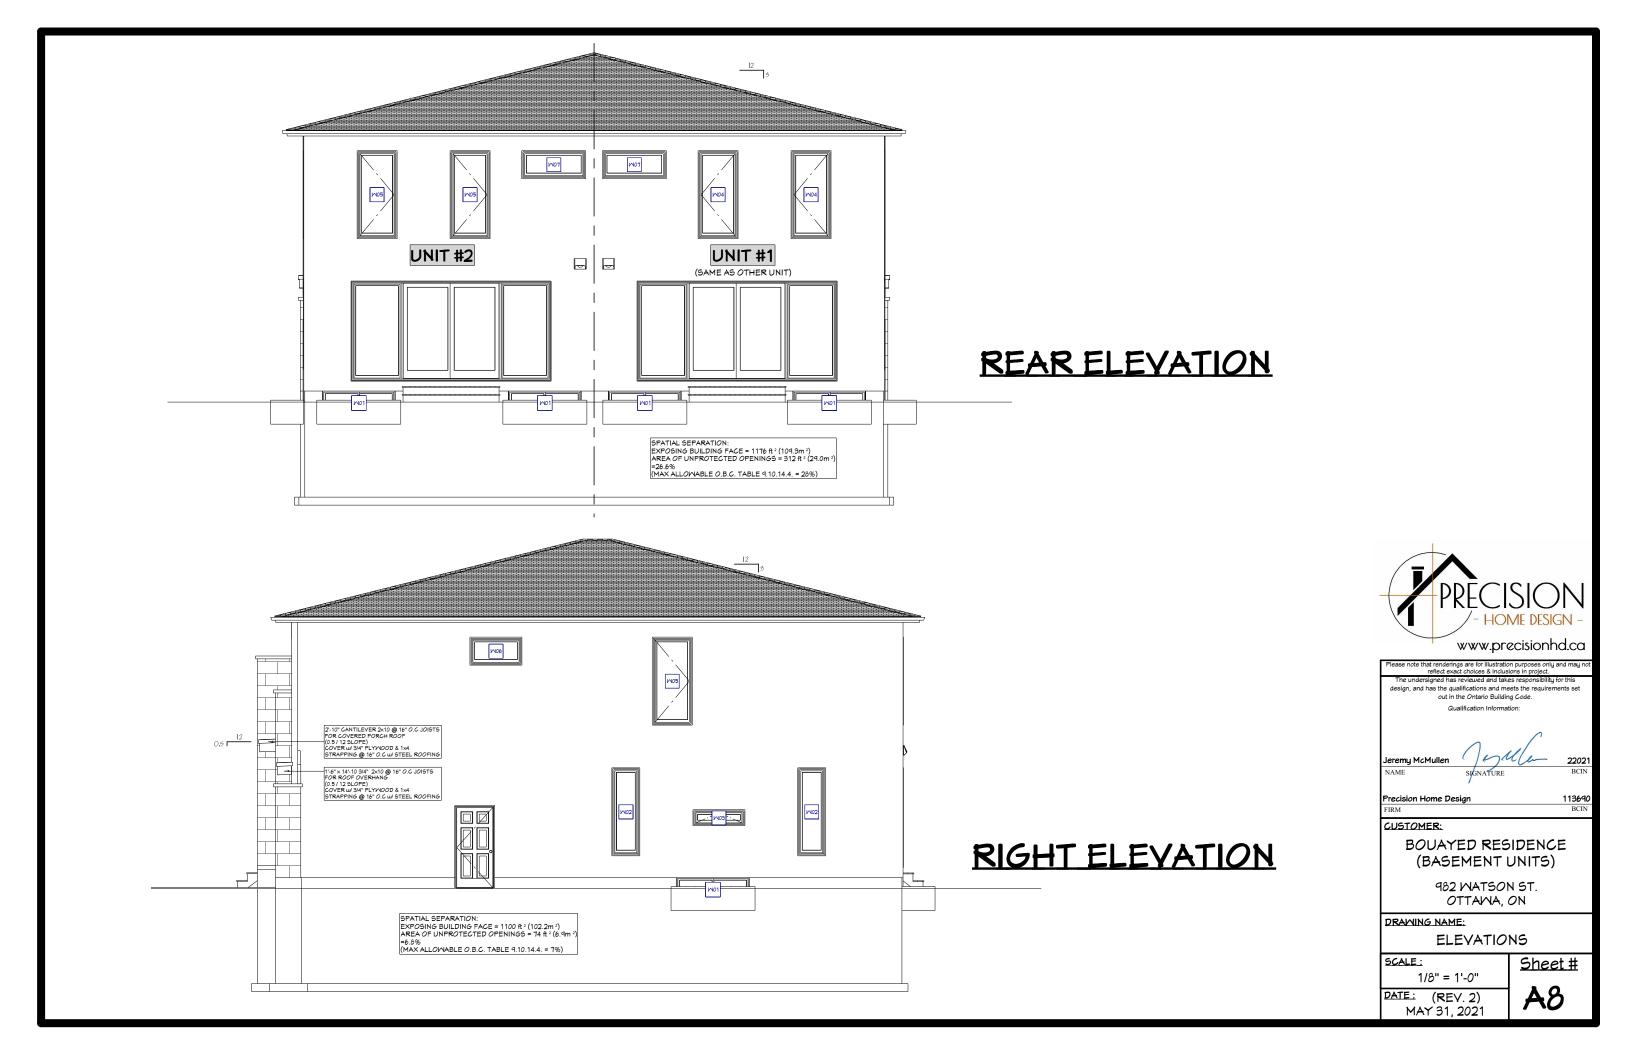
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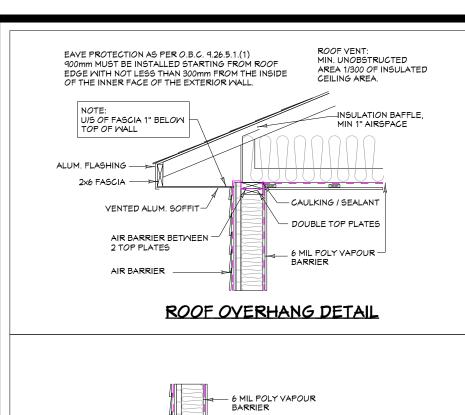



SECOND FLOOR PLAN = 1164 SQ.FT.

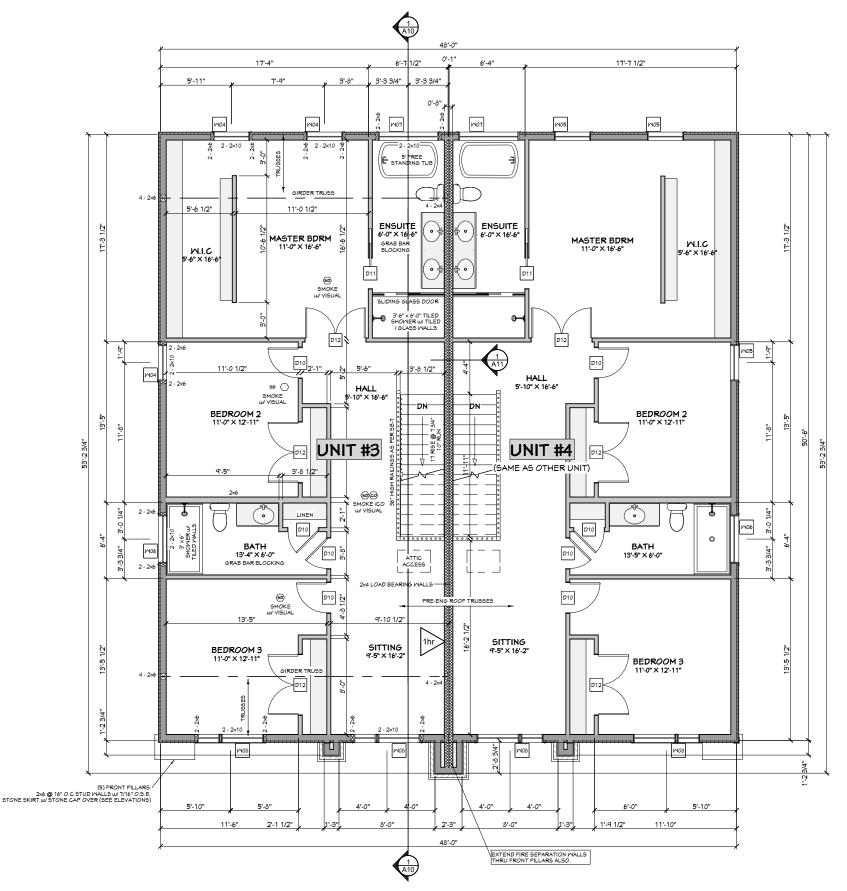
GROUND FLOOR = 923 SQ.FT. TOTAL = 2087 SQ.FT.






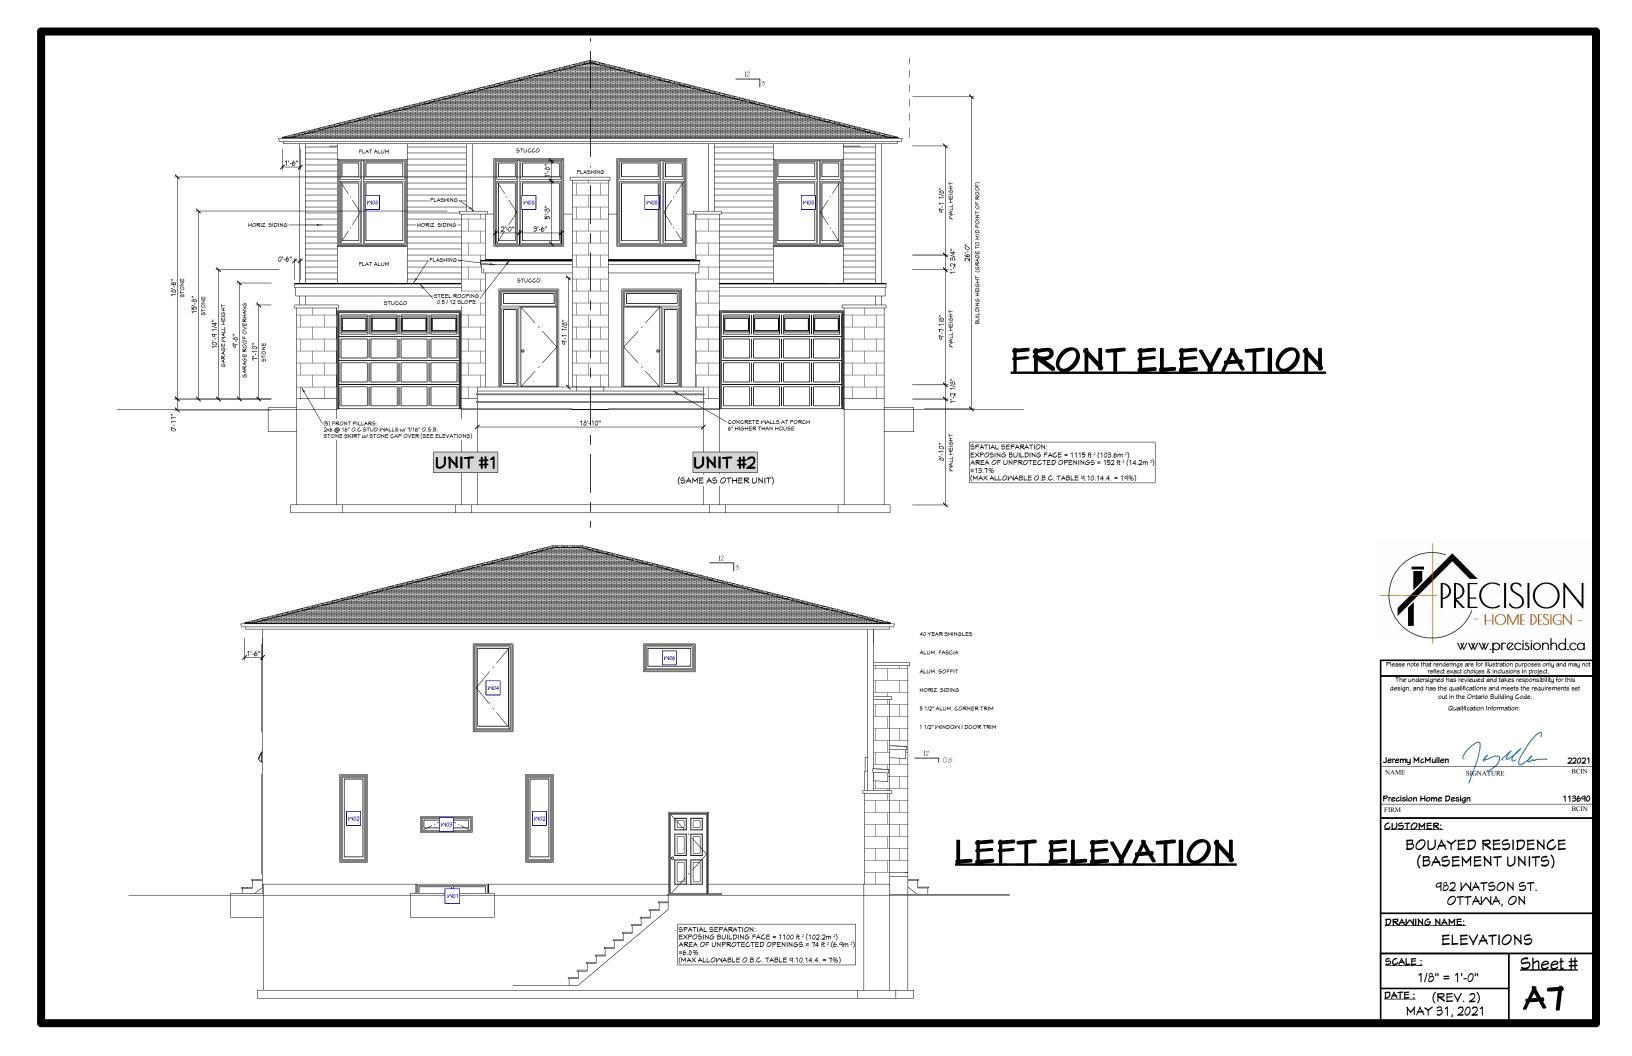


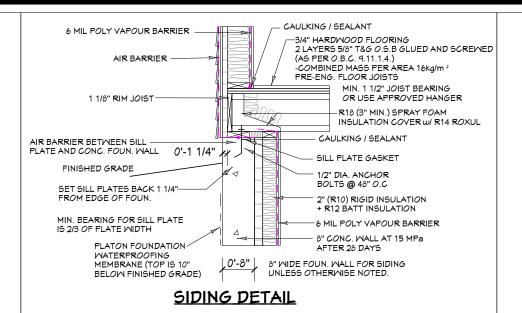


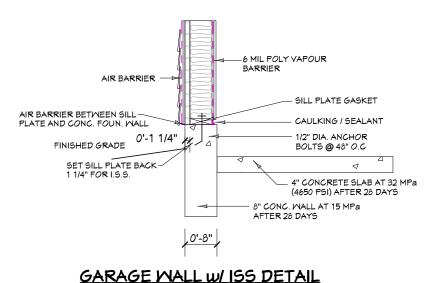

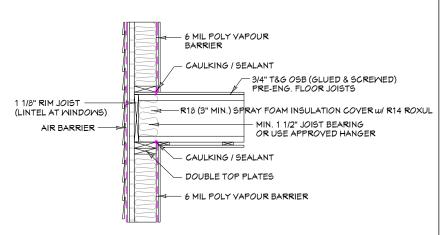



2 STOREY / KNEEWALL SIDING DETAIL

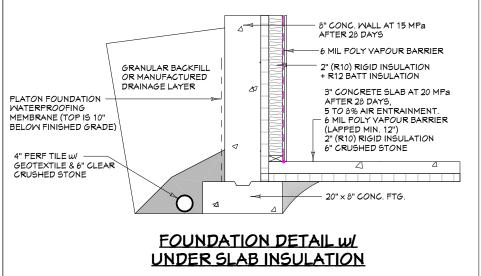

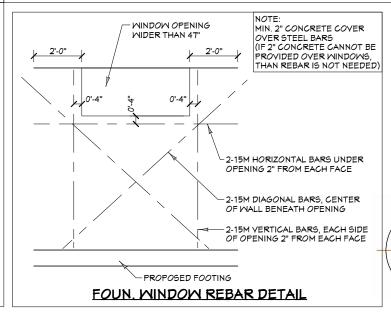



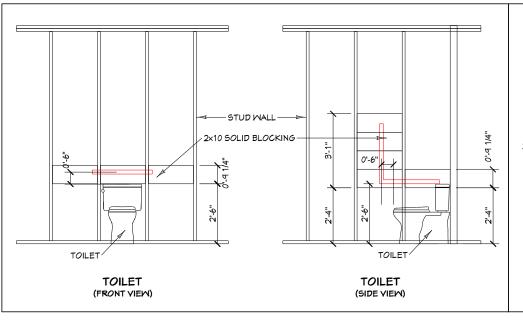

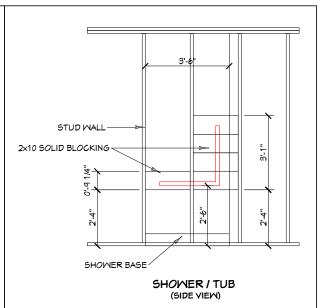

TYPICAL GRAB BAR BLOCKING

Flease note that renderings are for illustration purposes only and may not reflect exact choices & inclusions in project.

The undersigned has reviewed and takes responsibility for this design, and has the qualifications and meets the requirements set out in the Ontario Building Code.

Qualification Information:

Jeremy McMullen

SIGNATURE

Precision Home Design

113640

FIRM

BCIN

CUSTOMER:

BOUAYED RESIDENCE
(BASEMENT UNITS)

982 WATSON ST.
OTTAWA, ON

DRAWING NAME:


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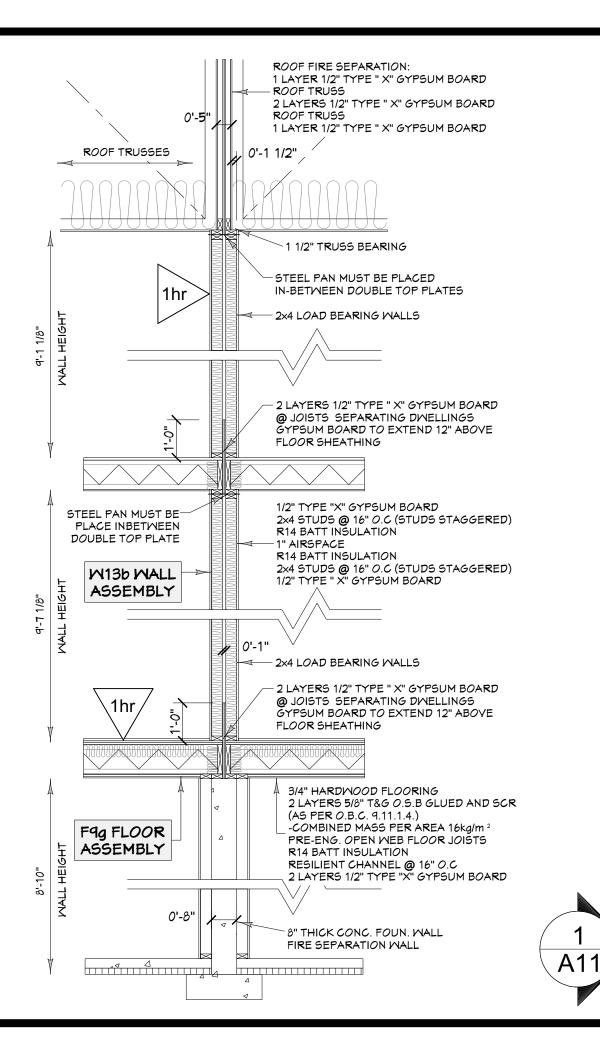
SCALE:

Sheet #

DATE: (REV. 2)
MAY 31, 2021

A 9



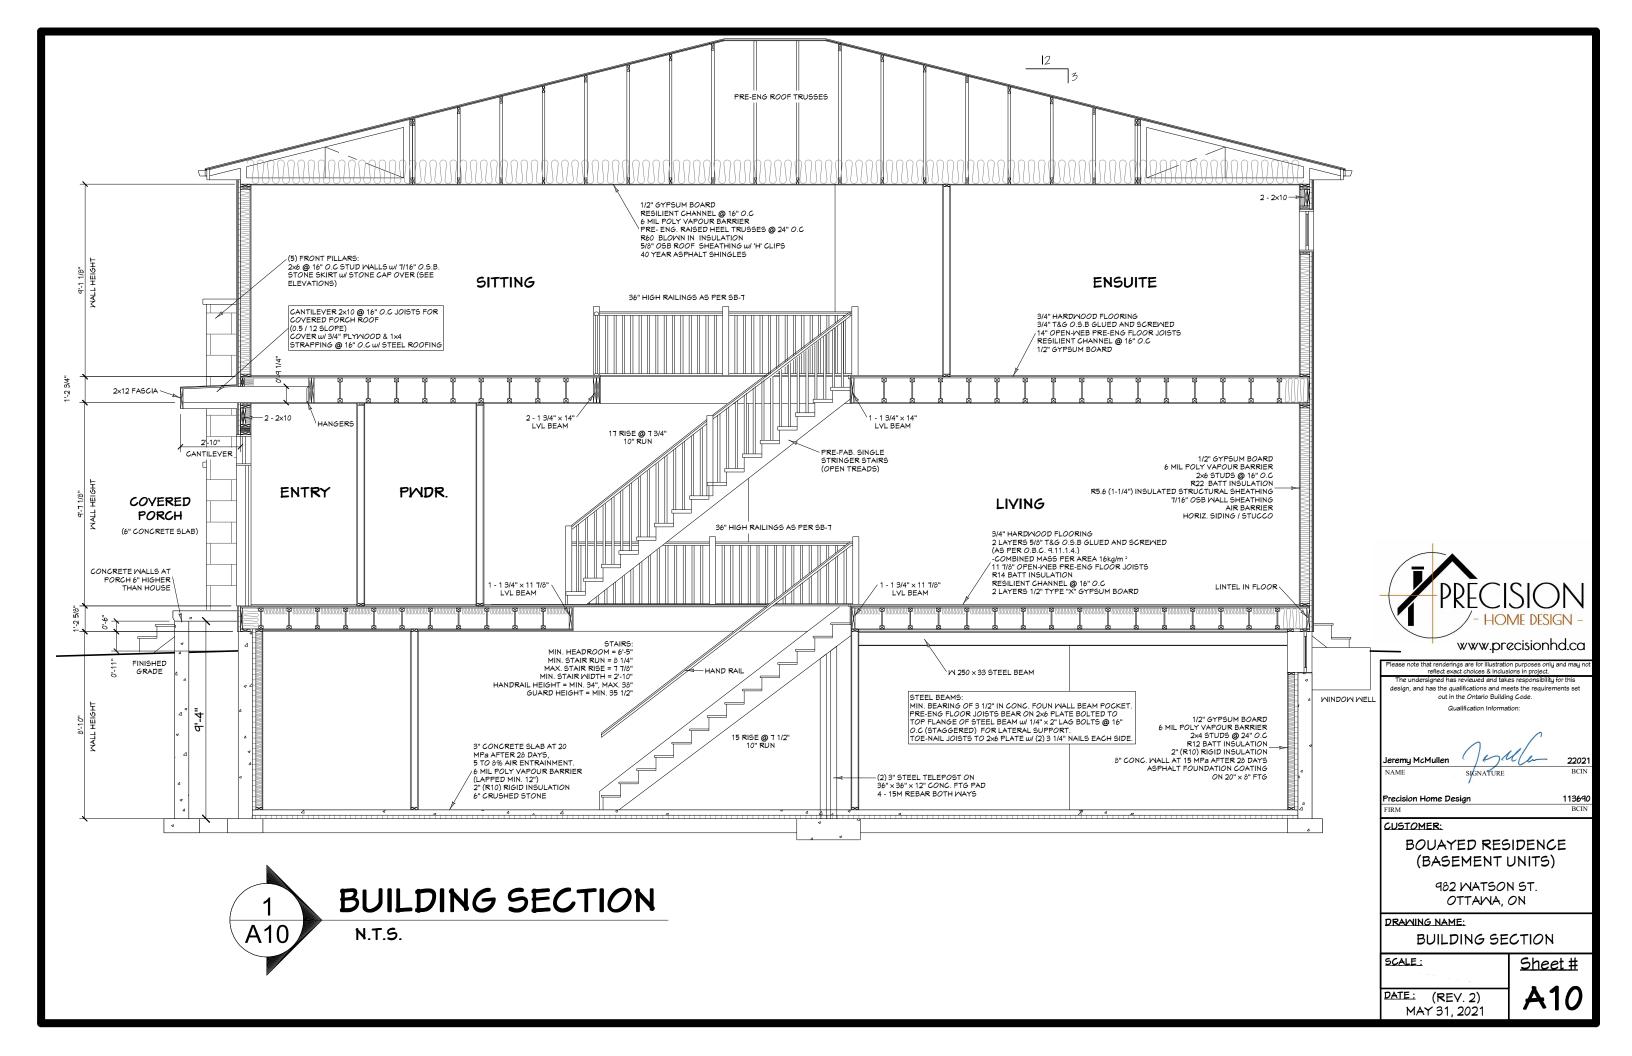



design, and has the qualifications and meets the requirements set out in the Ontario Building Code.

WALL FIRE AND SOUND RESISTANCE RATING: O.B.C. SB-3 WALL W13b (1hr, STC= 57)

2 ROMS 2x4 @ 16" O.C. (STUDS STAGGERED) w/

1 LAYER 1/2" TYPE "X" GYPSUM BOARD EACH SIDE

R14 BATT INSULATION ON BOTH SIDES

WALL SECTION

1" AIRSPACE BETWEEN

N.T.S.

1hr

Precision Home Design

113690

CUSTOMER:

BOUAYED RESIDENCE (BASEMENT UNITS)

> 982 WATSON ST. OTTAMA, ON


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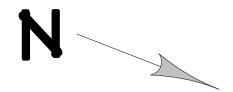
WALL SECTION

SCALE:

Sheet #

DATE: (REV. 2) MAY 31, 2021



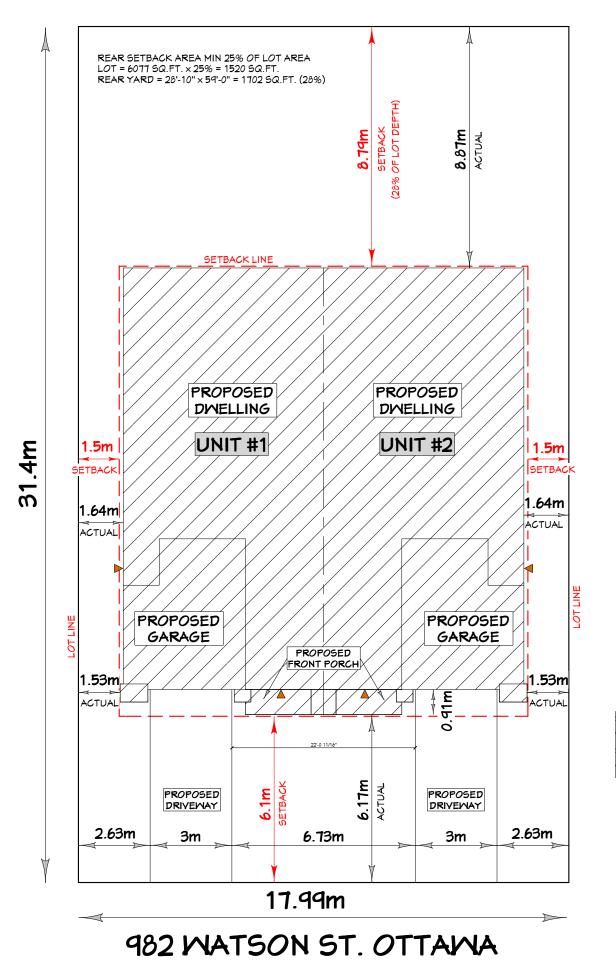

R2G ZONE
"SEMI-DETACHED"
MIN LOT WIDTH = 7.5m
MIN LOT AREA = 225 sq.m.
MAX. BLDG. HEIGHT = 8m
MIN. FRONT YARD = 6m
MIN. REAR YARD = 28% LOT DEPTH
MIN. INT. YARD = 1.2m

FRONT YARD "SOFT LANDSCAPED AREA"

TOTAL AREA OF FRONT YARD = 119.4 sq.m

FRONT YARD SOFT LANDSCAPED AREA = 76.3 sq.m

TOTAL = 63.9 % (MIN 35%)



Please note that renderings are for illustration purposes only and may n reflect exact choices & inclusions in project.

The undersigned has reviewed and takes responsibility for this design, and has the qualifications and meets the requirements set out in the Ontario Building Code.

Jeremy McMullen

SIGNATURE

Precision Home Design FIRM

ign 113**69**(BCIN

CUSTOMER:

BOUAYED RESIDENCE (BASEMENT UNITS)

982 WATSON ST. OTTAWA, ON


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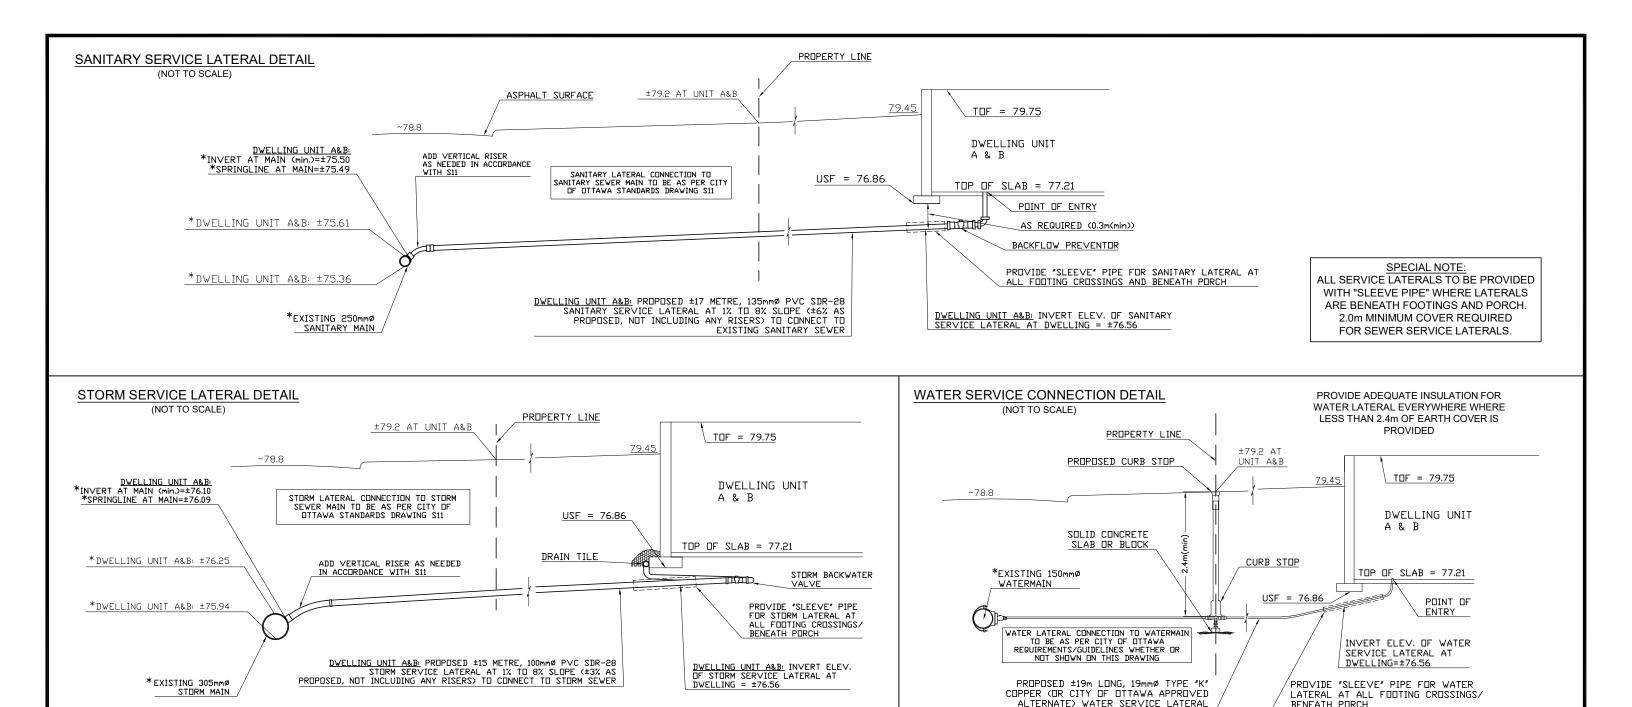
SITE PLAN

SCALE:

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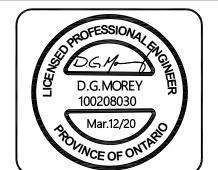
DATE: (REV. 2) MAY 31, 2021 A12



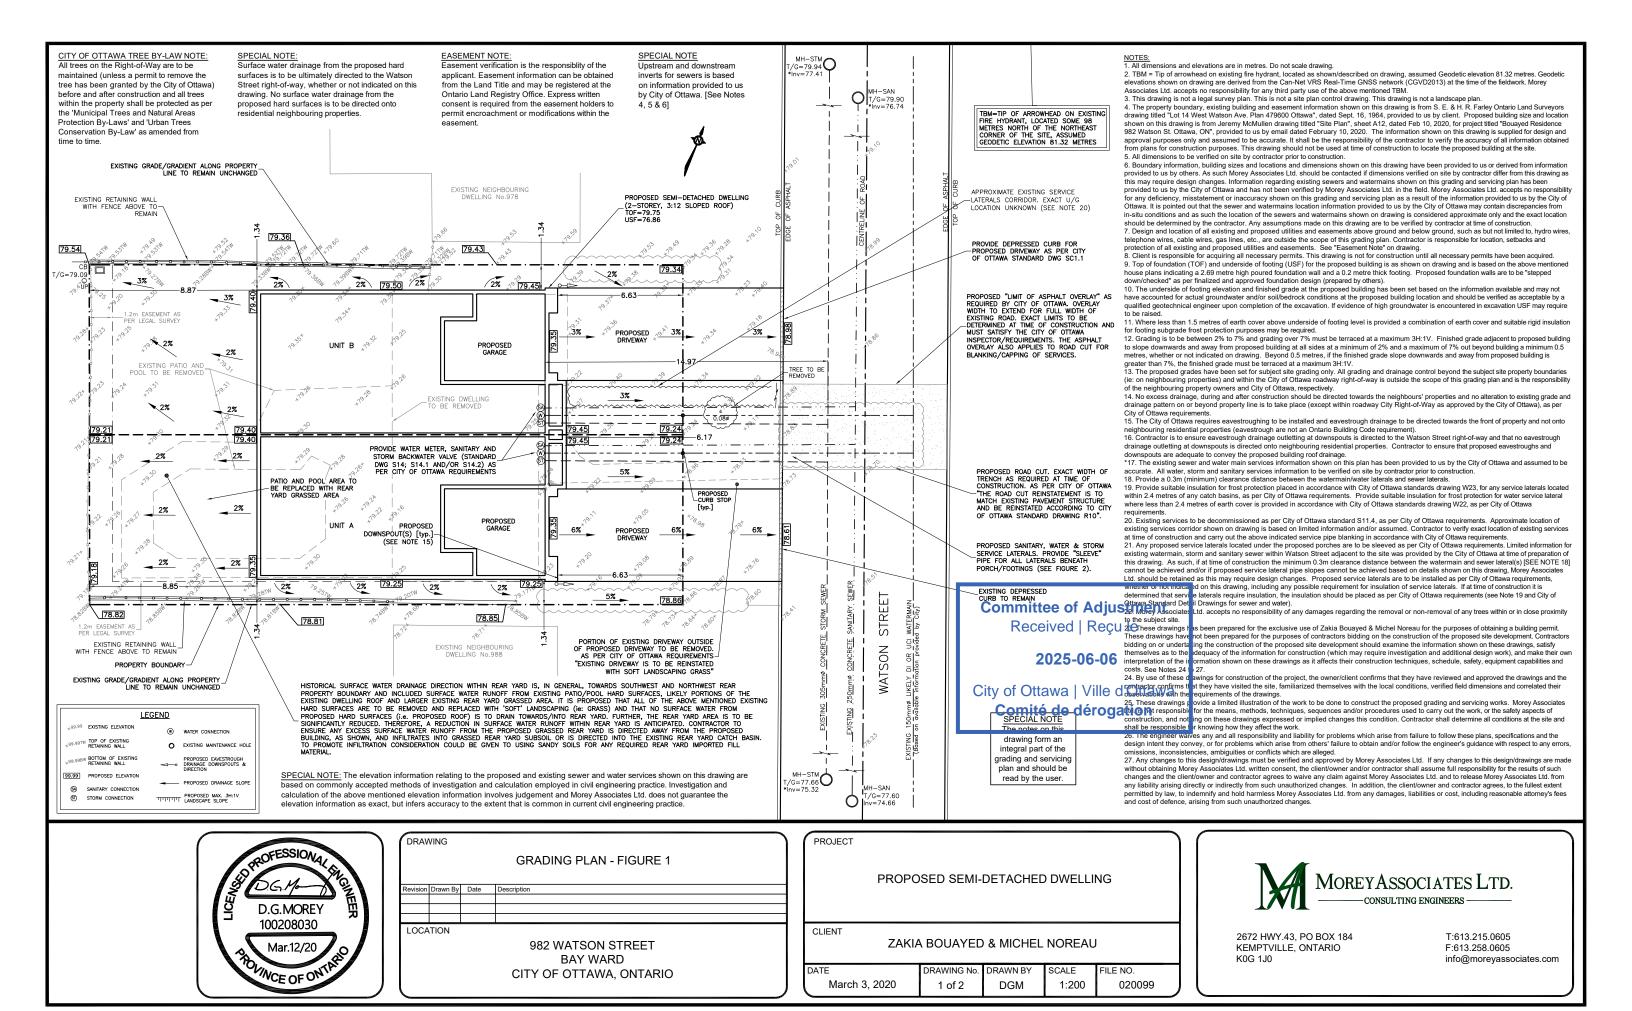

Revision Drawn By Date Description

SPECIAL NOTE: The elevation information relating to the proposed and existing sewer and water services shown on this drawing are based on commonly accepted methods of investigation and calculation employed in civil engineering practice. Investigation and calculation of the above mentioned elevation information involves judgement and Morey Associates Ltd. does not guarantee the elevation information as exact, but infers accuracy to the extent that is common in current civil engineering practice.



DRAWING

SERVICING DETAILS - FIGURE 2

LOCATION

982 WATSON STREET **BAY WARD** CITY OF OTTAWA, ONTARIO PROJECT

PROPOSED SEMI-DETACHED DWELLING

CLIENT

ZAKIA BOUAYED & MICHEL NOREAU

DRAWING No. DRAWN BY SCALE FILE NO. March 3, 2020 2 of 2 DGM NTS 020099



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