

4 SITE PLAN-ROOF LEVEL

STE PLAN GENERAL NOTES

TANKING AND PLAN AND

WHERE POSSBLE TREES ARE TO BE PROTECTED FROM CONTRUCTION

SITE LOCATION


ASP-I


N.I.S.

SITE STATISTICS				
7ONING	TM9 H(15)			
201110	TRADITIONAL MAIN STREET ZONE		ZONE	
COVERAGE CALCULATIONS	SM	SF	ACRES	
TOTAL SITE AREA	5008.0	53905.6	1.238	
BUILDING AREA	1840.7	19812.6	1.236	
salaring cortaining as a percentage of property and	uilding coverage as a percentage of property area 36.75%			
SETBACKS	REQ'D (m)	PROVIDED (m)		
MAX FRONT YARD	3.0	2.00		
MIN REAR YARD	10.0	17.95		
MIN REAR 45d ANGULAR PLANE	12.85	13.15		
MIN SIDE YARD SECTION 197(3)(d)	3.0	3.45		
MIN INTERIOR SIDE, ABUTTING A RESIDENTIAL ZONE	7.5	10.15		
WIDTH OF LANDSCAPE STRIP				
(i) ABUTING A RESIDENTIAL, MAY BE REDUCED TO 1m WHERE A MINIMUM 1.4m HIGH OPAQUE FENCE IS PROVIDED	1m	1.43m /This requirement has been met by keepin the existing cedar hedg which is playing the rok of 1.4m high opaque fence.		
(ii) IN ALL OTHER CASES	NO MIN	VARIES (1.5m to 2m)		
HEIGHT OF BUILDING	MAX	PROVIDED		
(MEASURED TO T/O ROOF DECK)	15m	13.72m		
GROSS FLOOR AREA (GFA) WITHOUT BALCONIES	SM	SF		
GROUND FLOOR	1,101.54	11,856.9		
SECOND FLOOR	1,840.65	19,812.6		
THIRD FLOOR	1,840.65	19,812.6		
FOURTH FLOOR	1,753.00	18,869.1		
TOTAL GFA	6,535.8	70,351.2		
				
PARKING REQUIREMENTS	REQ'D	PROVIDED		
Residential use	71	70	-	
1.0 PARKING/UNIT VISITOR PARKING-0.2 PARKING /UNIT	14.2	72 15	-	
	1	-		
TOTAL NO. OF SPACES	85	87		
BIKE RACKS 0.5 PARKING/UNIT		la i		
0.5 PARKING/UNII	35.5	36	ļ.,	
Aminities REQUIREMENTS Residential use	REQ'D	PROVIDED		
6 sq m /UNIT	426	458.29		
ACCESSIBLE PARKING	REQ'D	PROVIDED		
20-99 PARKING SPACES, THEN 1 ACCESSIBLE SPACE REQ'D	1	1		
	REQ'D	PROVIDED		
DRIVEWAYS AND AISLE REQUIREMENTS	(MIN)			
DRIVEWAYS AND AISLE REQUIREMENTS TWO-WAY DRIVEWAY TWO-WAY PARKING AISLE	(MIN) 6.7	6.7		



IN THE TAMZONE, A VEHICLE LOADING SPACE IS REQUIRED FOR USES THAT HAVE A GFA OF 1000 SQ M OR MORE

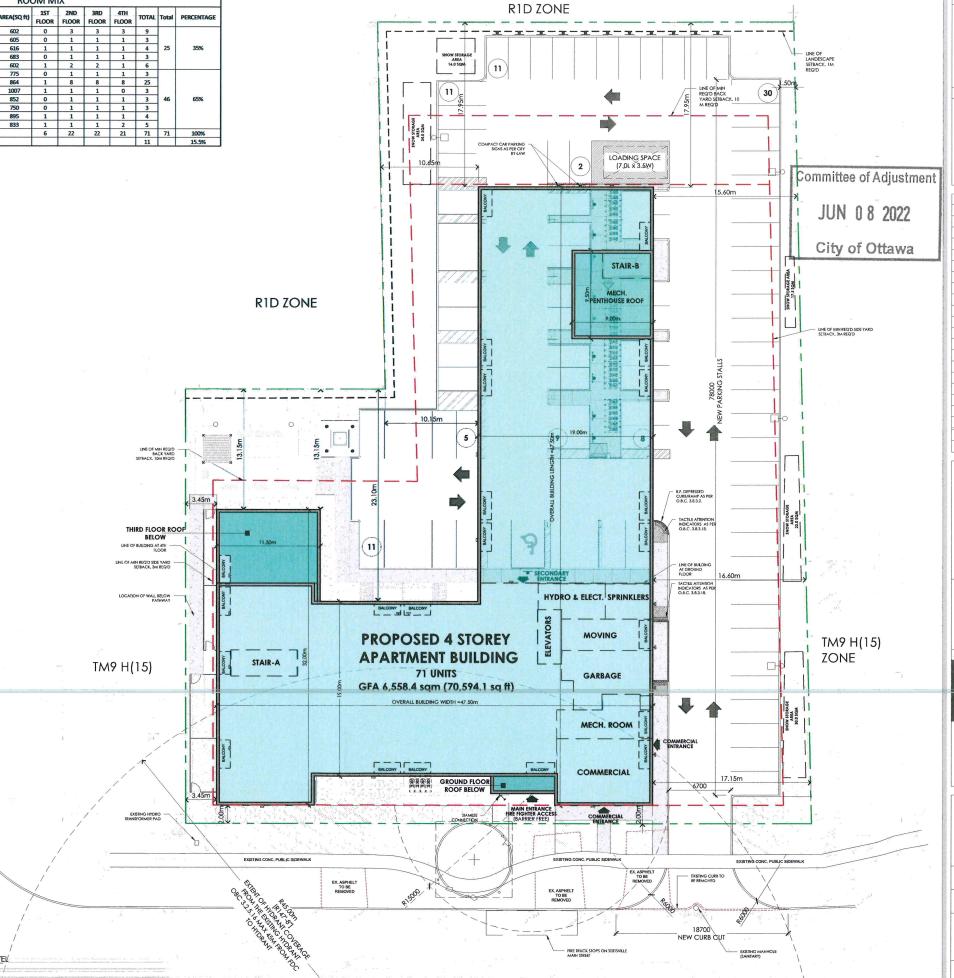

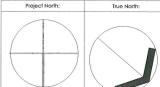

Key Plan:

1 22/03/18 Issued for Site plan Application AB
No. Date: Issue/Revision By:
Drawing Issues/Revisions:

Note:

ALL DIMENSIONS AND INFORMATION SHOWN ON THESE DRAWNGS MUST CHECKED AND YERRIED ON SITE AND ANY DISCREPANCES REPORTED TO ASCHITECT PRIOR TO CONSTRUCTION AND FABRICATION OF ITS COMPONENTS. SHOULD DISSING CONDITIONS OF SERVICES BE FOUND TO VARY FROM THAT INDICATED ON THE DRAWINGS, THE ARCHITECT MUST BE MOSTIFETH MUSTAGES.

FEATURES OF CONSTRUCTION NOT FULLY SHOWN ARE ASSUMED TO

unless specifically noted otherwise on the Drawings, no Provision has been made in the Design For Conditions occurring During Construction. If shall be the Responsibility of the Contractor To Provide All Niccessary Bracting, shorings, sheet piling or other Tempforary Supports, To Sarguard Late Stating or Adjacting.

ALL DRAWINGS AND RELATED DOCUMENTS SHALL REMAIN THE PROF AND COPYRIGHT OF MATAJ ARCHITECTS INC.



MATAJ ARCHITECTS INC

Architect's Stamp

TAJARCHITECTS

STITTSVILLE

APARTMENT BUILDING
1364-1370 Stittsville Main St, Stittsville,
ON K2S 1V4

Sheet Title:

SITE PLAN -ROOF LEVEL


Design By: EM	Drawn By: SF	Approved By:
Scale: 1:200	Date: 22-03-25	Project No.: 21-061


awina No:


ASP-1

Drawing Series:

SITE PLAN APPLICATION

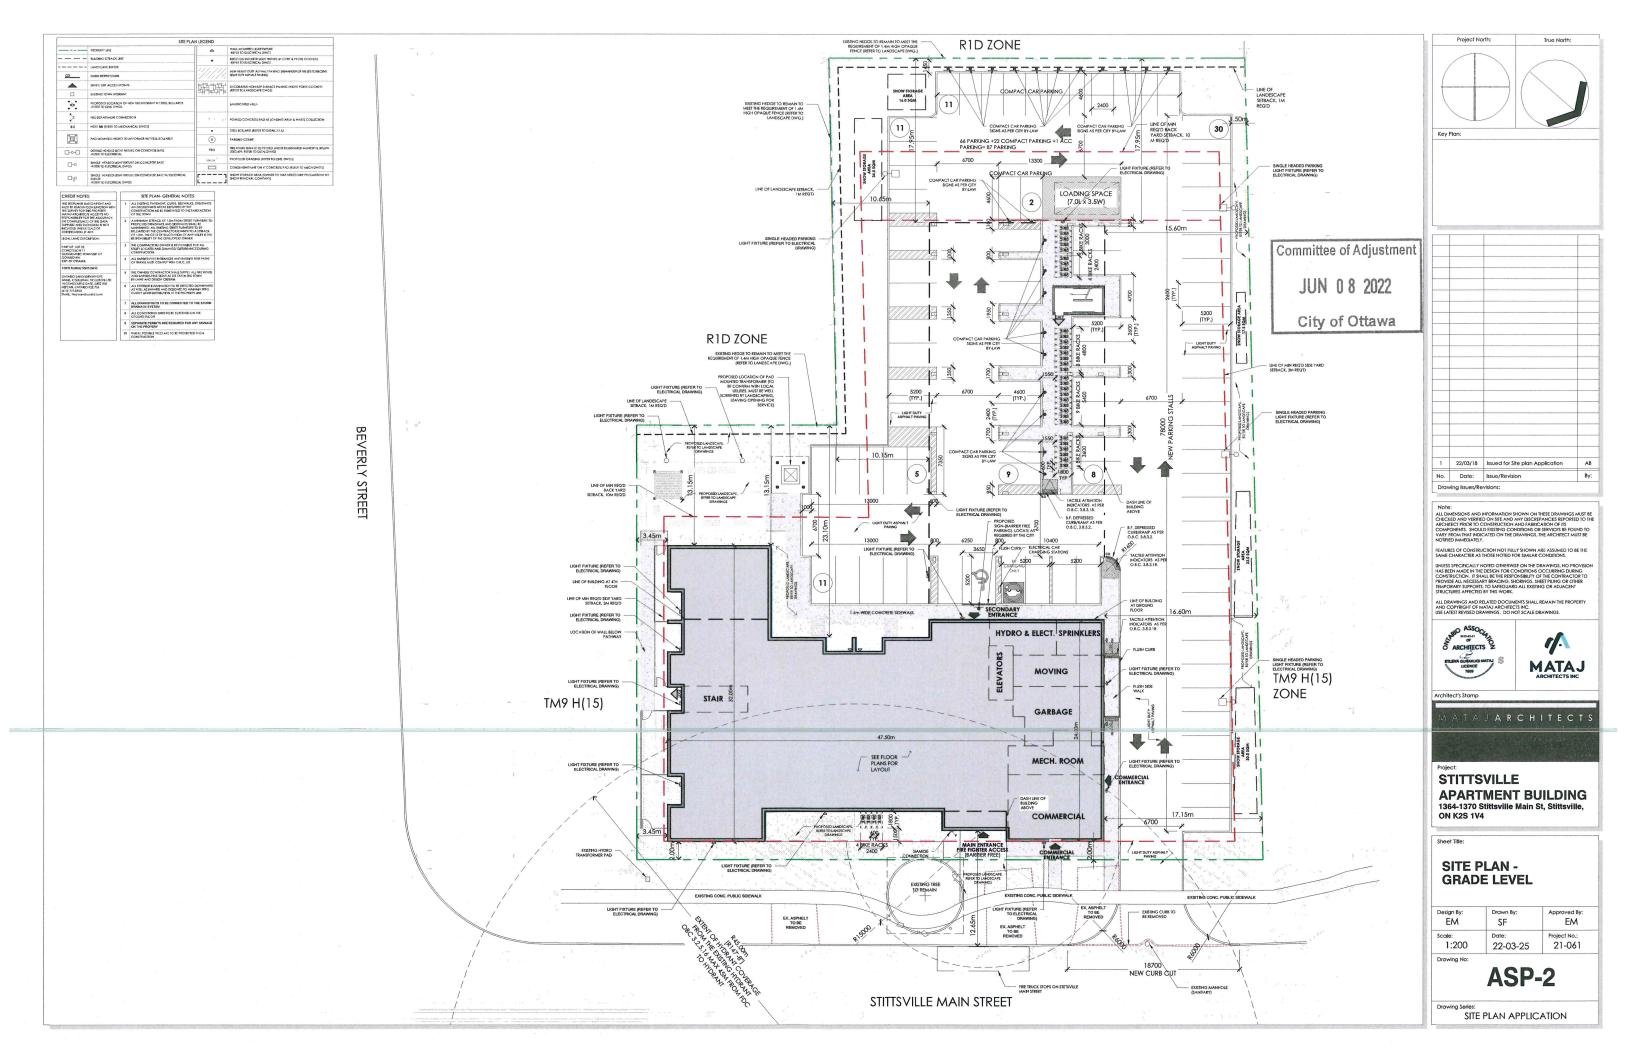

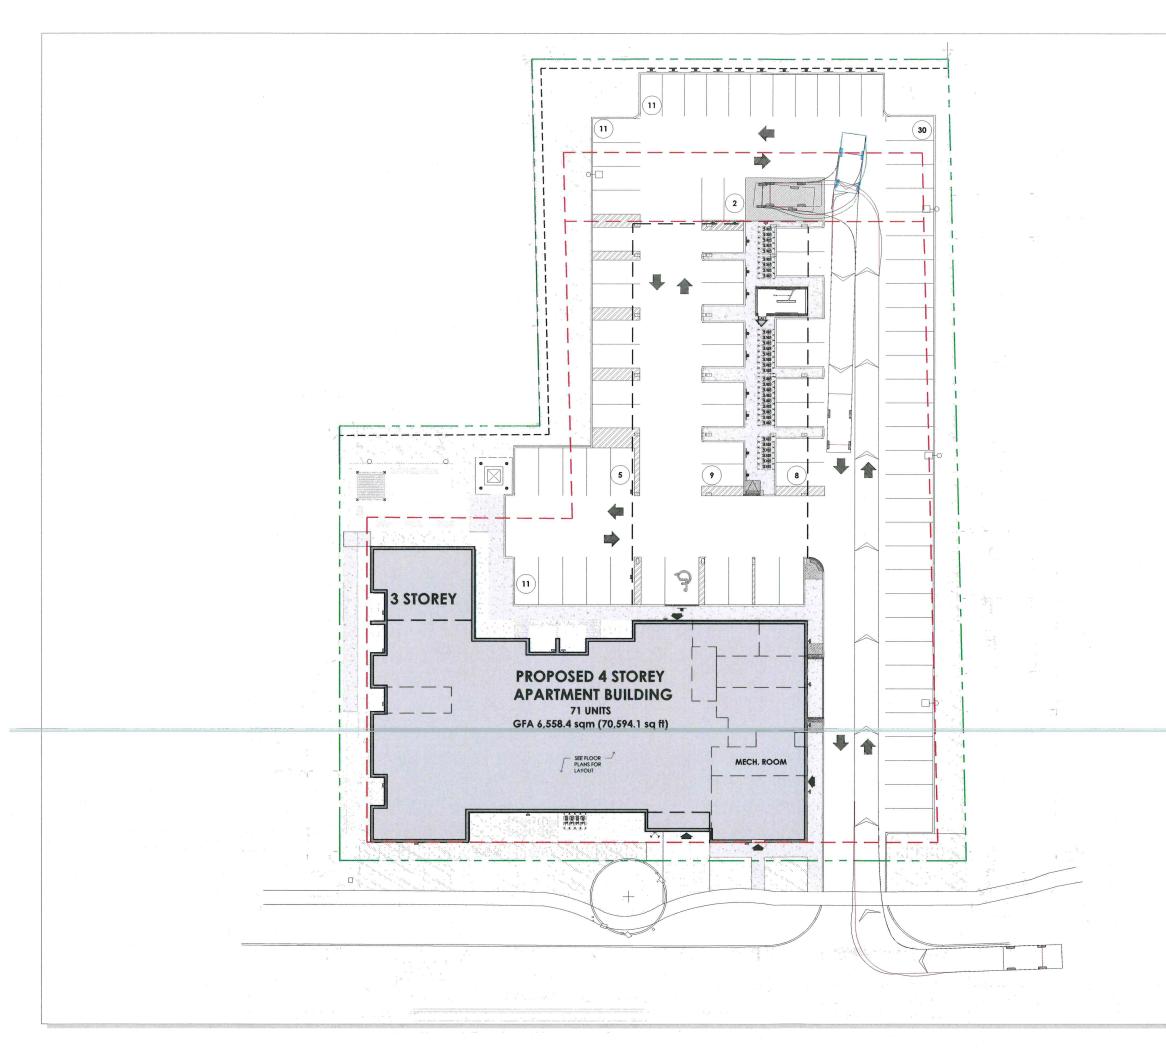

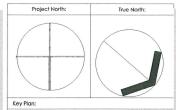

Committee of Adjustment

JUN 08 2022

City of Ottawa

No.	Date:	Issue/Revision	Ву
1	22/03/18	Issued for Site plan Application	AE
			+
			+
			+
			+
			+
			-
			+-
			+-
			+-
			T-
			+
			T

Note:

ALL DIMENSIONS AND INFORMATION SHOWN ON THESE DRAWINGS MUST BE CHECKED AND VERSIED ON SITE AND ANY DISCREPANCES REPORTED TO THE AND ANY DISCREPANCES REPORTED TO THE ACCHIECT PRIOR TO CONSTILLION AND FASSACIATION OF ITS COMPONENTS. SHOULD EXISTING CONTINUOUS OR SERVICES BE FOUND TO WARY PROM HAT ROBIGATED ON THE DRAWINGS. THE ARCHITECT MUST BE

FEATURES OF CONSTRUCTION NOT FULLY SHOWN ARE ASSUMED TO BE SAME CHARACTER AS THOSE NOTED FOR SIMILAR CONDITIONS.

INIESS SPECIFICALLY NOTED OTHERWISE ON THE DRAWNGS, NO PROVISION AS BEEN AND. IN THE DESIGN FOR CONDITION OCCURRING DURING CONSTRUCTION. IT SHALL BE THE RESPONSIBILITY OF THE CONTRACTOR TO PROVIDE ALL NECESSARY BRACKING. SHORMOS, SHEET PILING OR OTHER IEMPORARY SUPPORTS, TO SAFEGUARD ALL EXISTING OR ADJACENT STRUCTURES ARE STRUCTURES. ARECTED BY THIS WORK.

ALL DRAWINGS AND RELATED DOCUMENTS SHALL REMAIN THE PROPE AND COPYRIGHT OF MATAJ ARCHITECTS INC. USE LATEST REVISED DRAWINGS. DO NOT SCALE DRAWINGS.





Architect's Stam

JARCHITECTS

Project:

STITTSVILLE

APARTMENT BUILDING
1364-1370 Stittsville Main St, Stittsville,
ON K2S 1V4

Sheet Titl


SITE PLAN-LOADING SPACE TRUCK MANEUVERING


Design By:	SF	Approved By:
Scale: 1:200	Date: 22-03-25	Project No.: 21-061

Drawing

ASP-3

Drawing Series:
SITE PLAN APPLICATION

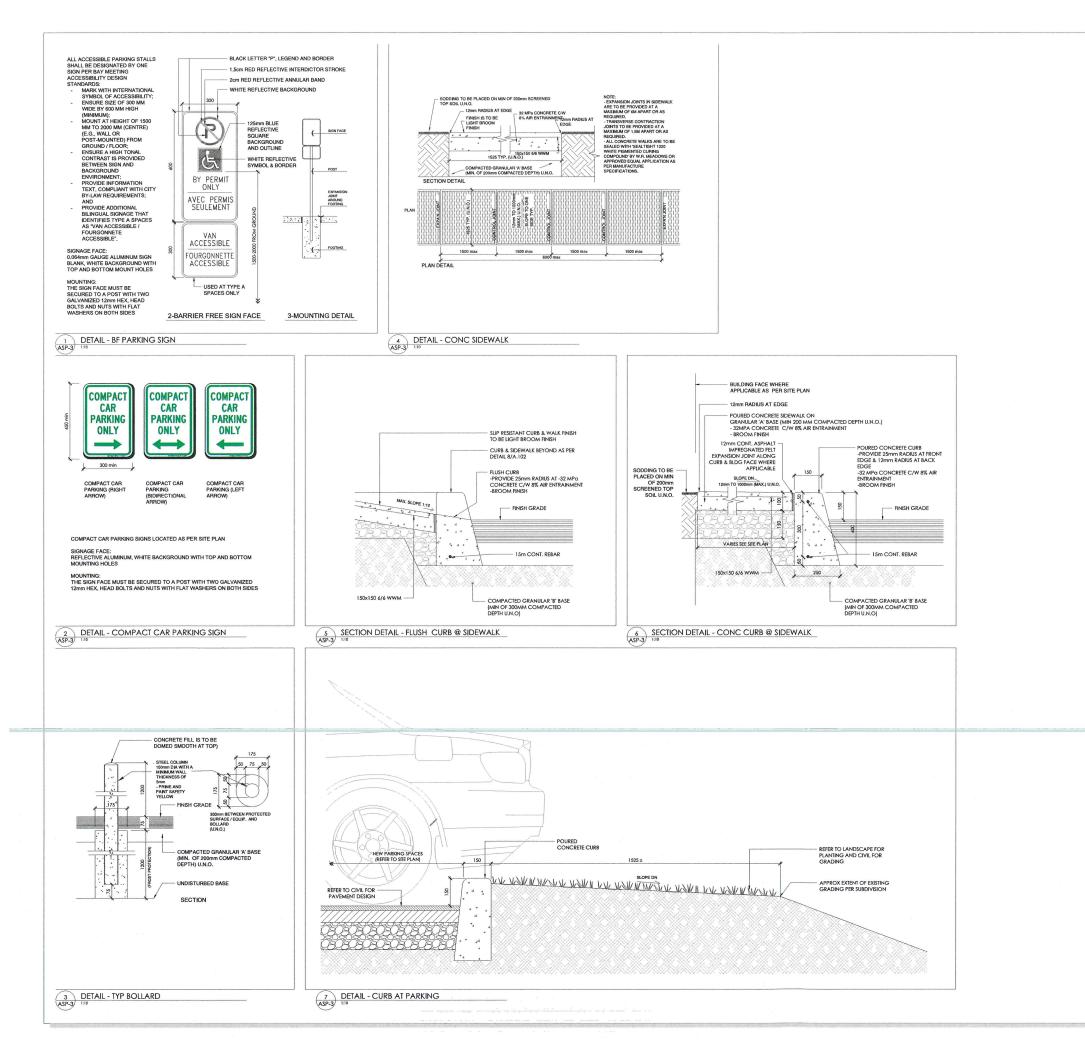

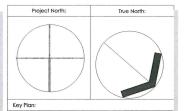

Committee of Adjustment

JUN 08 2022

City of Ottawa



Note:

INSIONS AND INFORMATION SHOWN ON THESE DRAWNIGS MUST BY O AND VERRIED ON SITE AND ANY DISCREPANCES REPORTED TO THE CT PRIOR TO CONSTRUCTION AND FABRICATION OF ITS NEMTS. SHOULD EXISTING CONDITIONS OR SERVICES BE FOUND TO ON THAT INDICATED ON THE DRAWINGS, THE ARCHITECT MUST BE

FEATURES OF CONSTRUCTION NOT FULLY SHOWN ARE ASSUMED TO BE

INLESS SPECIFICALLY NOTED OTHERWISE ON THE DRAWINGS, NO PROVIS HAS BEEN MADE IN THE DESIGN FOR CONDITIONS OCCURRING DURING CONSTRUCTION. IT SHALL BE THE REPONSIBILITY OF THE CONTRACTOR TO REVUIDE ALL NECESSARY BRACING, SHORINGS, SHEET PRING OR OTHER HEMPORARY SURPORTS, TO SAFGUARD ALL EXISTING OR ADJACENT

AND COPYRIGHT OF MATAJ ARCHITECTS INC.

USE LATEST REVISED DRAWINGS. DO NOT SCALE DRAWINGS.





Architect's Stamp

ARCHITECT

roject:

STITTSVILLE

APARTMENT BUILDING
1364-1370 Stittsville Main St, Stittsville,
ON K2S 1V4

Sheet Title:

SITE PLAN-DETAILS

	Design By: EM	Drawn By: SF	Approved By:
	Scale: 1:10	Date: 22-03-25	Project No.: 21-061

Drawing No:

ASP-4

Drawing Serie

SITE PLAN APPLICATION