

/ Committee / Committee of Adjustment June 2, 2022
City of Ottawa

COMMON COMPOSITION NOTES:


- PROVIDE COMPRESSIBLE FOAM GASKET BETWEEN METAL AND CONCRETE. • SET BOTTOM TRACK IN COUBLE CONTINUOUS BEAD OF SEALANT. SILL AND TOP PLATE IN CONTINUOUS SEALANT. • PROVIDE FIRE-RATED ACOUSTICAL SEALANTS TO
 - CLOSE PERIMETER (TOP, BOTTOM, VERTICAL INTERSECTS) JOINTS AND OPENINGS WHERE MECHANICAL, PLUMBING, ELECTRICAL OR OTHER DEVICES PENETRATE THROUGH SOUND RATED
- PROVIDE GWB ON FINISHED SIDE ONLY AT CHASES/FURRED SITUATIONS.
- PROVIDE MOISTURE RESISTANT (MR) GWB AT ALL WET AREAS AND AREAS PRONE TO MOISTURE. PROVIDE 16" CEMENT BOARD IN WASHROOM AREAS, JANITOR'S CLOSET, WHERE TILE ARE TO BE APPLIED.
- PROVIDE PLYWOOD BACKING/WOOD BLOCKING WHERE REQUIRED. • COORDINATE ALL WINDOW AND DOOR ROUGH
- OPENINGS WITH SCHEDULE AND MANUFACTURER INSTALLATION DETAILS AND RECOMMENDATIONS.

FINISH SCHEDULE:

2

(4)

- (1) CEMFORT CEMENT PANELS, OR EQUIV., COLOUR "CAMBRIDGE WHITE"
- © CEMFORT CEMENT PANELS, OR EQUIV., ACCENT COLOUR "REGENT GREY"
- 3 PREFINISHED METAL SIDING EQUIV TO IDEAL ROOFING 22 GAUGE CORRUGATED 7/8" C-360 COLOUR TO ARCHITECTS APPROVAL
- CLEAR ANODIZED, THERMALLY BROKEN FRAMES, C/W CLEAR DOUBLE GLAZED HERMETICALLY SEALED LITES
- PREFINISHED METAL FLASHING COLOUR TO ARCHITECTS APPROVAL

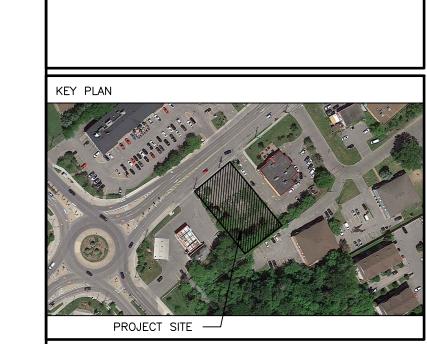


ALL CONTRACTORS TO VERIFY ALL DIMENSIONS ON SITE AND TO REPORT ALL ERRORS AND/OR OMISSIONS TO THE ARCHITECT.

ALL CONTRACTORS MUST COMPLY WITH ALL CODES

AND BYLAWS AND OTHER AUTHORITIES HAVING JURISDICTION OVER THE WORK.

DO NOT SCALE DRAWINGS.

THIS DRAWING MAY NOT BE USED FOR CONSTRUCTION UNTIL SIGNED BY THE ARCHITECT. COPYRIGHT RESERVED.

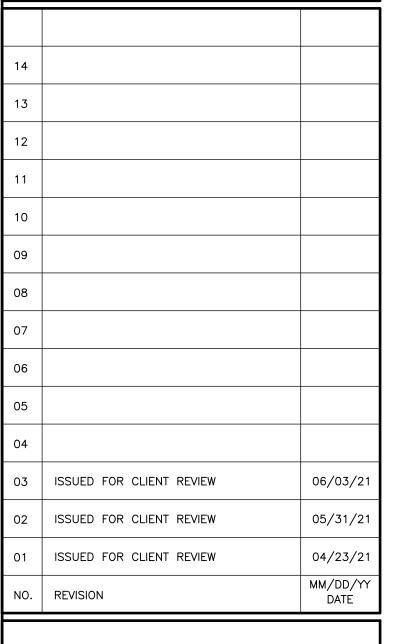

WOODMAN ARCHITECT

201-4 BEECHWOOD AVENUE, OTTAWA, ONTARIO, CANADA KIL8LS TEL: 613 228 9850. FAX 613 228 9848. mailbox@woodmanarchitect.co

CONSULTANTS: STRUCTURAL

MECHANICAL -ELECTRICAL -

PROJECT:

1994 ST. JOSEPH, OTTAWA, ON

WEST & EAST

ELEVATION

03 JUNE, 2021 AS SHOWN DRAWING NO. A.S., S.E RAWN BY

A201

3.75 TOP OF 2ND LEVEL SUBFLOOR

EAST ELEVATION

0.20 GROUND FLOOR


0.00 GRADE

REVIEWED BY R.J.W., R.W

18575

NORTH ELEVATION (A200)

3/16"=1'-0"

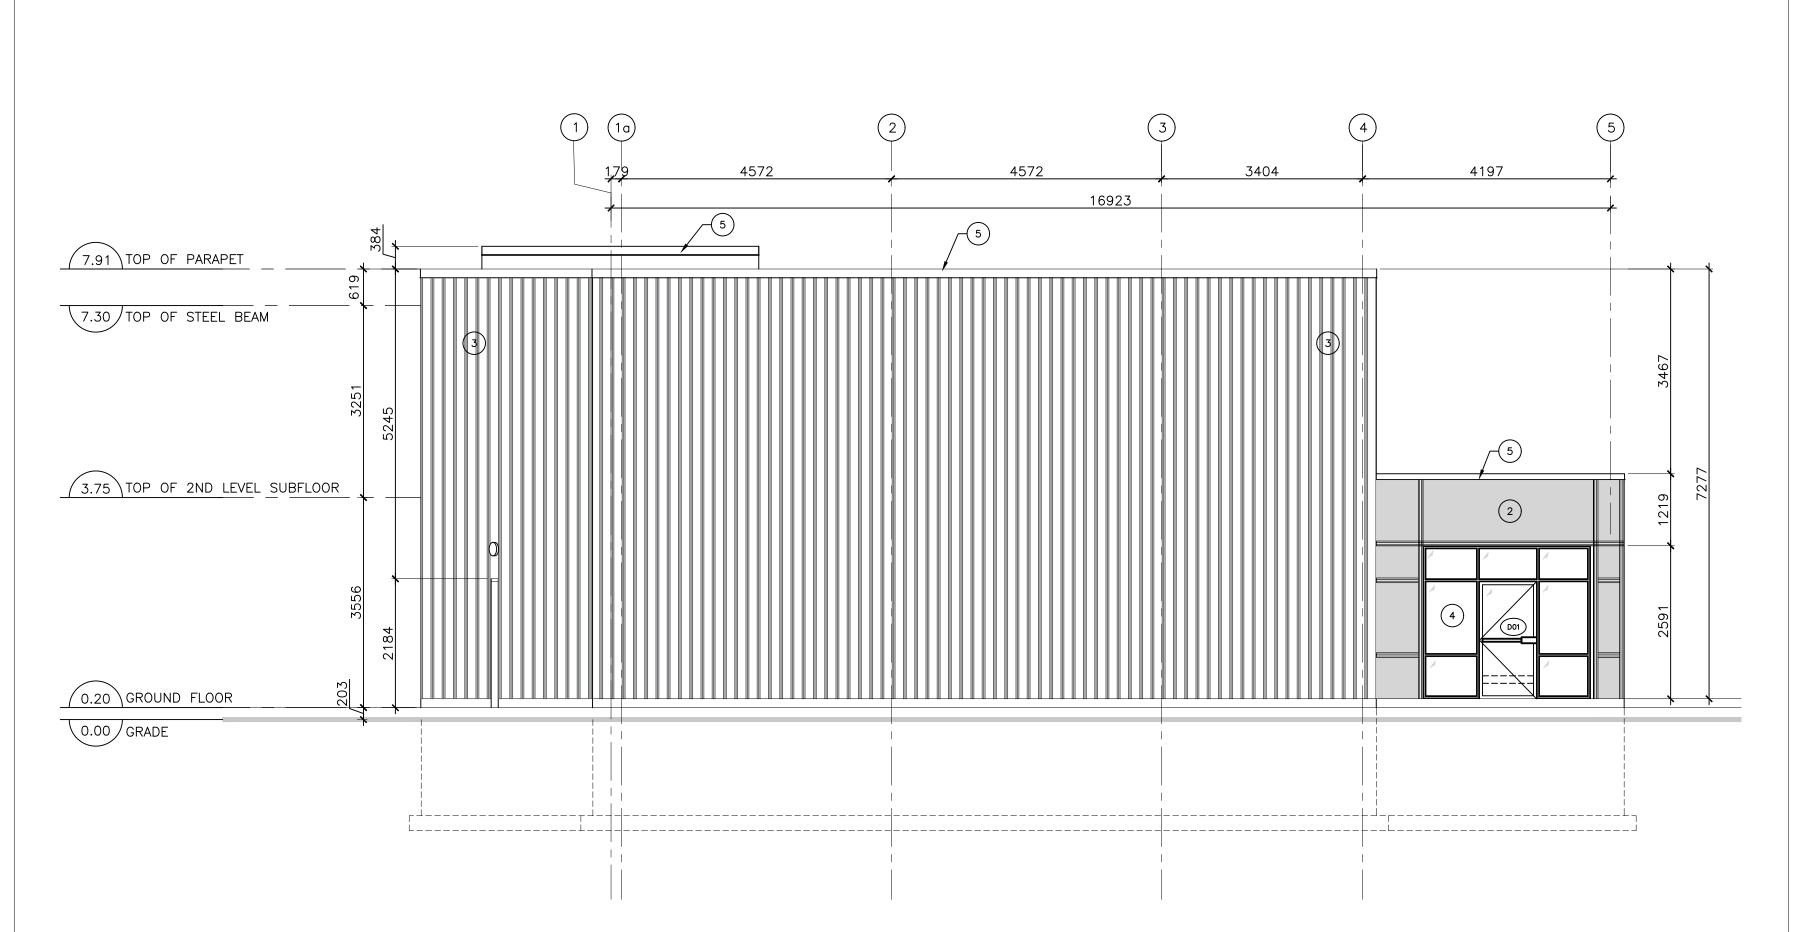

CONSTRUCTION NOTES:

ROOF COMPOSITION:

FLAT ROOF / TERRACE BASED ON ASSEMBLY (F28d) OF SB-3 (OBC 2012)

-2" SLOPED RIGID INSULATION -2 PLY MOD. BIT ROOFING MEMBRANE (WRAP UP

AND OVER PARAPET) -5/8" PLYWOOD ON TAPERED WOOD SLEEPERS, 2% SLOPE TO DRAIN/SCUPPER.

-ENGG. JOIST, SEE STRUCTURAL DWGS FOR REQUIREMENTS.

- R50min. ROXUL INSULATION WITHIN FRAMING

-6mil. POLY VAPOUR BARRIER 1/8" HAT CHANNELS AT 16" O.C. • 2 LAYERS %" SHEETROCK FIRECODE CORE GYPSUM PANELS (EXTERIOR GRADE GWB OR DENS-GLASS GOLD SHEATHING AT EXTERIOR CONDITIONS), PANELS SCREW ATTACH, JOINTS STAGGER AND FINISH • SEAL ALL GAPS AND PENETRATIONS W/ FIRE-RATED

WALL COMPOSITION:



TYPICAL NEW FOUNDATION WALL -2" RIDID INSULATION (CONTINUOUS BELOW GRADE) -SELF-ADHERING WATERPROOFING MEMBRANE ON -POURED CONCRETE

-1/2" THICK METAL CLADDING + 2" "Z" GIRT

ACOUSTICAL SEALANTS, CONTINUOUS




TYPICAL EXTERIOR WALL (NON-COMBUSTIBLE CONSTRUCTION) -BASED ON ASSEMBLY (S10a) OF SB-3 (OBC 2012) -7/8" CORRUGATED METAL CLADDING

-AİR BARRIER. -2" ROXUL CAVITY ROCK OR APPROVED EQUIVALENT EXTERIOR INSULATION (CONTINUOUS)

-1 LAYER ₹ EXTERIOR GRADE TYPE "X" GYPSUM BOARD. -6" STEEL STUDS @ 16" O.C. -5.5" ROXUL AFB BATT INSULATION.

-VAPOUR BARRIER -1 LAYER § TYPE "X" GYPSUM BOARD

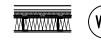


TYPICAL EXTERIOR WALL (COMBUSTIBLE CONSTRUCTION) -BASED ON ASSEMBLY (EW1a) OF SB-3 (OBC 2012) -1/2" THICK METAL CLADDING + 2" "Z" GIRT OR 3 1/2" THICK STONE/BRICK VENEER (REFER TO ELEVATIONS FOR MATERIAL LOCATIONS)

-AIR BARRIER. -2" ROXUL CAVITY ROCK OR APPROVED EQUIVALENT EXTERIOR INSULATION (CONTINUOUS) -1/2" EXTERIOR GRADE PLYWOOD

-6" STEEL STUDS @ 16" O.C. -5.5" ROXUL AFB BATT INSULATION.

-VAPOUR BARRIER -1 LAYER §" TYPE "X" GYPSUM BOARD

PARTITION COMPOSITION:

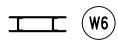

TYPICAL INTERIOR PARTITION
-1/2" G.B. ON BOTH SIDES

-1/2" G.B. ON BOTH SIDES (1/2" CIMENT BRD WHERE TILES ARE TO BE APPLIED) -2" X 6" STEEL STUD @ 16" O.C.

TYPICAL DEMISING WALL/CORRIDOR PARTITION CONSTRUCTION

<u>(F.R.R. : 1hr per ULC Des W317)</u> • 1 LAYER %" SHEETROCK FIRECODE CORE GYPSUM PANELS STC REPORT • 4" THERMAFIBER SAFB, FULL WIDTH AND HEIGHT OF CAVITY

#TL07-019 • 1 LAYER %" QuietRock 525 PANELS Thr RATED • SEAL ALL GAPS AND PENETRATIONS W/ FIRE-RATED ACOUSTICAL SEALANTS, CONTINUOUS, BOTH SIDES • PRIME AND PAINT FINISH (CORRIDOR SIDE)

> TYPICAL INTERIOR LOAD BEARING CONCRETE WALL CONSTRUCTION (F.R.R. : 1hr) ELEVATOR SHAFT WALL ?

• 1 LAYER %" GYPSUM BOARD (TYPE X) • 8" POURED CONCRETE • 1 LAYERS %" GYPSUM BOARD (TYPE X)

• SEAL ALL GAPS AND PENETRATIONS W/ FIRE-RATED ACOUSTICAL SEALANTS, CONTINUOUS, BOTH SIDES PRIME AND PAINT FINISH (CORRIDOR SIDE)

FLOOR COMPOSITION:



TYPICAL CONCRETE SLAB ON GRADE

• FLOOR FINISH: PAINT AND SEAL. SEE ALSO FINISH SCHEDULE. STC:N/A • 5" POURED CONCRETE FLOOR C/W STEEL MESH AND REINFORCING PER STRUCTURAL DWGS.

• VAPOUR BARRIER • R15 RIGID INSULATION FIRST METER AT PERIMETER, R5

BALANCE. • 2" SAND • 4" GRAVEL

COMPACTED FILL

TYPICAL FLOOR CONSTRUCTION (SB-3 WOOD FLOOR JOISTS ASSEMBLY No F28g)

• 5/8" OSB SUBFLOOR, STC:51 • WOOD FLOOR FR 1hr RATED REQUIREMENTS. • WOOD FLOOR FRAMING, REFER TO STRUCTURAL DWGS FOR

• 8"ROXUL INSULATION IN FLOOR CAVITY. • RESILIENT CHANNELS SPACED AT 16" O/C. • 1/2" TYPE X GYPSUM BOARD.

• SEAL ALL GAPS AND PENETRATIONS W/ FIRE-RATED ACOUSTICAL SEALANTS, CONTINUOUS.

AT SOFFIT CONDITION. -FILL FLOOR FRAMING CAVITY. -2" RIGID INSULATION BELOW FLOOR FRAMING. -PREFINISHED METAL VENTED SOFFIT.

COMMON COMPOSITION NOTES:

• PROVIDE COMPRESSIBLE FOAM GASKET

BETWEEN METAL AND CONCRETE. • SET BOTTOM TRACK IN COUBLE CONTINUOUS BEAD OF SEALANT. SILL AND TOP PLATE IN

CONTINUOUS SEALANT. • PROVIDE FIRE-RATED ACOUSTICAL SEALANTS TO CLOSE PERIMETER (TOP, BOTTOM, VERTICAL INTERSECTS) JOINTS AND OPENINGS WHERE MECHANICAL, PLUMBING, ELECTRICAL OR OTHER DEVICES PENETRATE THROUGH SOUND RATED

• PROVIDE GWB ON FINISHED SIDE ONLY AT

CHASES/FURRED SITUATIONS. • PROVIDE MOISTURE RESISTANT (MR) GWB AT ALL WET AREAS AND AREAS PRONE TO MOISTURE. PROVIDE %6" CEMENT BOARD IN

WASHROOM AREAS, JANITOR'S CLOSET, WHERE TILE ARE TO BE APPLIED. • PROVIDE PLYWOOD BACKING/WOOD BLOCKING

WHERE REQUIRED. • COORDINATE ALL WINDOW AND DOOR ROUGH OPENINGS WITH SCHEDULE AND MANUFACTURER INSTALLATION DETAILS AND RECOMMENDATIONS.

FINISH SCHEDULE:

(1) CEMFORT CEMENT PANELS, OR EQUIV., COLOUR "CAMBRIDGE WHITE"

2 CEMFORT CEMENT PANELS, OR EQUIV., ACCENT COLOUR "REGENT GREY"

PREFINISHED METAL SIDING EQUIV TO IDEAL ROOFING 22 GAUGE CORRUGATED 7/8" C-360 COLOUR TO ARCHITECTS APPROVAL

CLEAR ANODIZED, THERMALLY BROKEN FRAMES, C/W CLEAR DOUBLE GLAZED HERMETICALLY SEALED LITES

PREFINISHED METAL FLASHING COLOUR TO ARCHITECTS APPROVAL



KEY PLAN


STAMP

ALL CONTRACTORS TO VERIFY ALL DIMENSIONS ON SITE AND TO REPORT ALL ERRORS AND/OR OMISSIONS TO THE ARCHITECT.

ALL CONTRACTORS MUST COMPLY WITH ALL CODES AND BYLAWS AND OTHER AUTHORITIES HAVING JURISDICTION OVER THE WORK.

DO NOT SCALE DRAWINGS.

THIS DRAWING MAY NOT BE USED FOR CONSTRUCTION UNTIL SIGNED BY THE ARCHITECT. COPYRIGHT RESERVED.

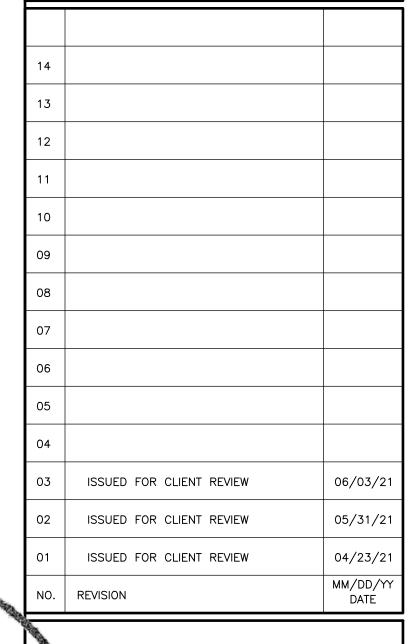

WOODMAN ARCHITECT

ASSOCIATES LTD.

TEL: 613 228 9850. FAX 613 228 9848. mailbox@woodmanarchitect.co

CHWOOD AVENUE, OTTAWA, ONTARIO, CANADA KIL8LS

Committee of Adjustment

June 2, 2022

CONSULTAN STRUCTURA MECHANIC L

CLECTRIC L

PRO LCT:

1994 ST. JOSEPH, OTTAWA, ON

NORTH & SOUTH ELEVATION

03 JUNE, 2021 AS SHOWN DRAWING NO. RAWN BY A.S., S.E REVIEWED BY R.J.W., R.\

A200 # 18575



