

Received June 9, 2022



FRONT ELEVATION

SCALE: 3/16" = 1'-0"

## GENERAL NOTES:

1. THE GENERAL CONTRACTOR SHALL CHECK AND VERIFY ALL DIMENSIONS AND REPORT ALL ERRORS AND OMISSIONS TO THE CONSULTANT.
2. ALL WORK AND MATERIALS TO BE IN COMPLIANCE WITH ALL CODES, REGULATIONS, AND BY-LAWS.
3. FOOTINGS DESIGNED FOR 2000 P.S.F. ASSUMED BEARING. BEARING STRATA, GRANULAR MATERIAL AND COMPACTION TO BE INSPECTED AND APPROVED BY SOILS CONSULTANT PRIOR TO POURING CONCRETE.
4. DO NOT SCALE THE DRAWINGS.


NO.	DESCRIPTION & DATE
1	
REVISIONS	

JOB TITLE:  
PROPOSED TWO  
STOREY SFD  
101 CHIPPEWA  
OTTAWA ONT.SHEET TITLE:  
FRONT ELEVATION

SCALE: AS SHOWN	DWG NO.
DRAWN: CS	A1.4
CHECKED:	
DATE: JAN 2022	
PRINT DATE:	



SALE: AS SHOWN	DWG NO.
AWN: CS	A2.4
ECKED:	
TE: JAN 2022	
NT DATE:	

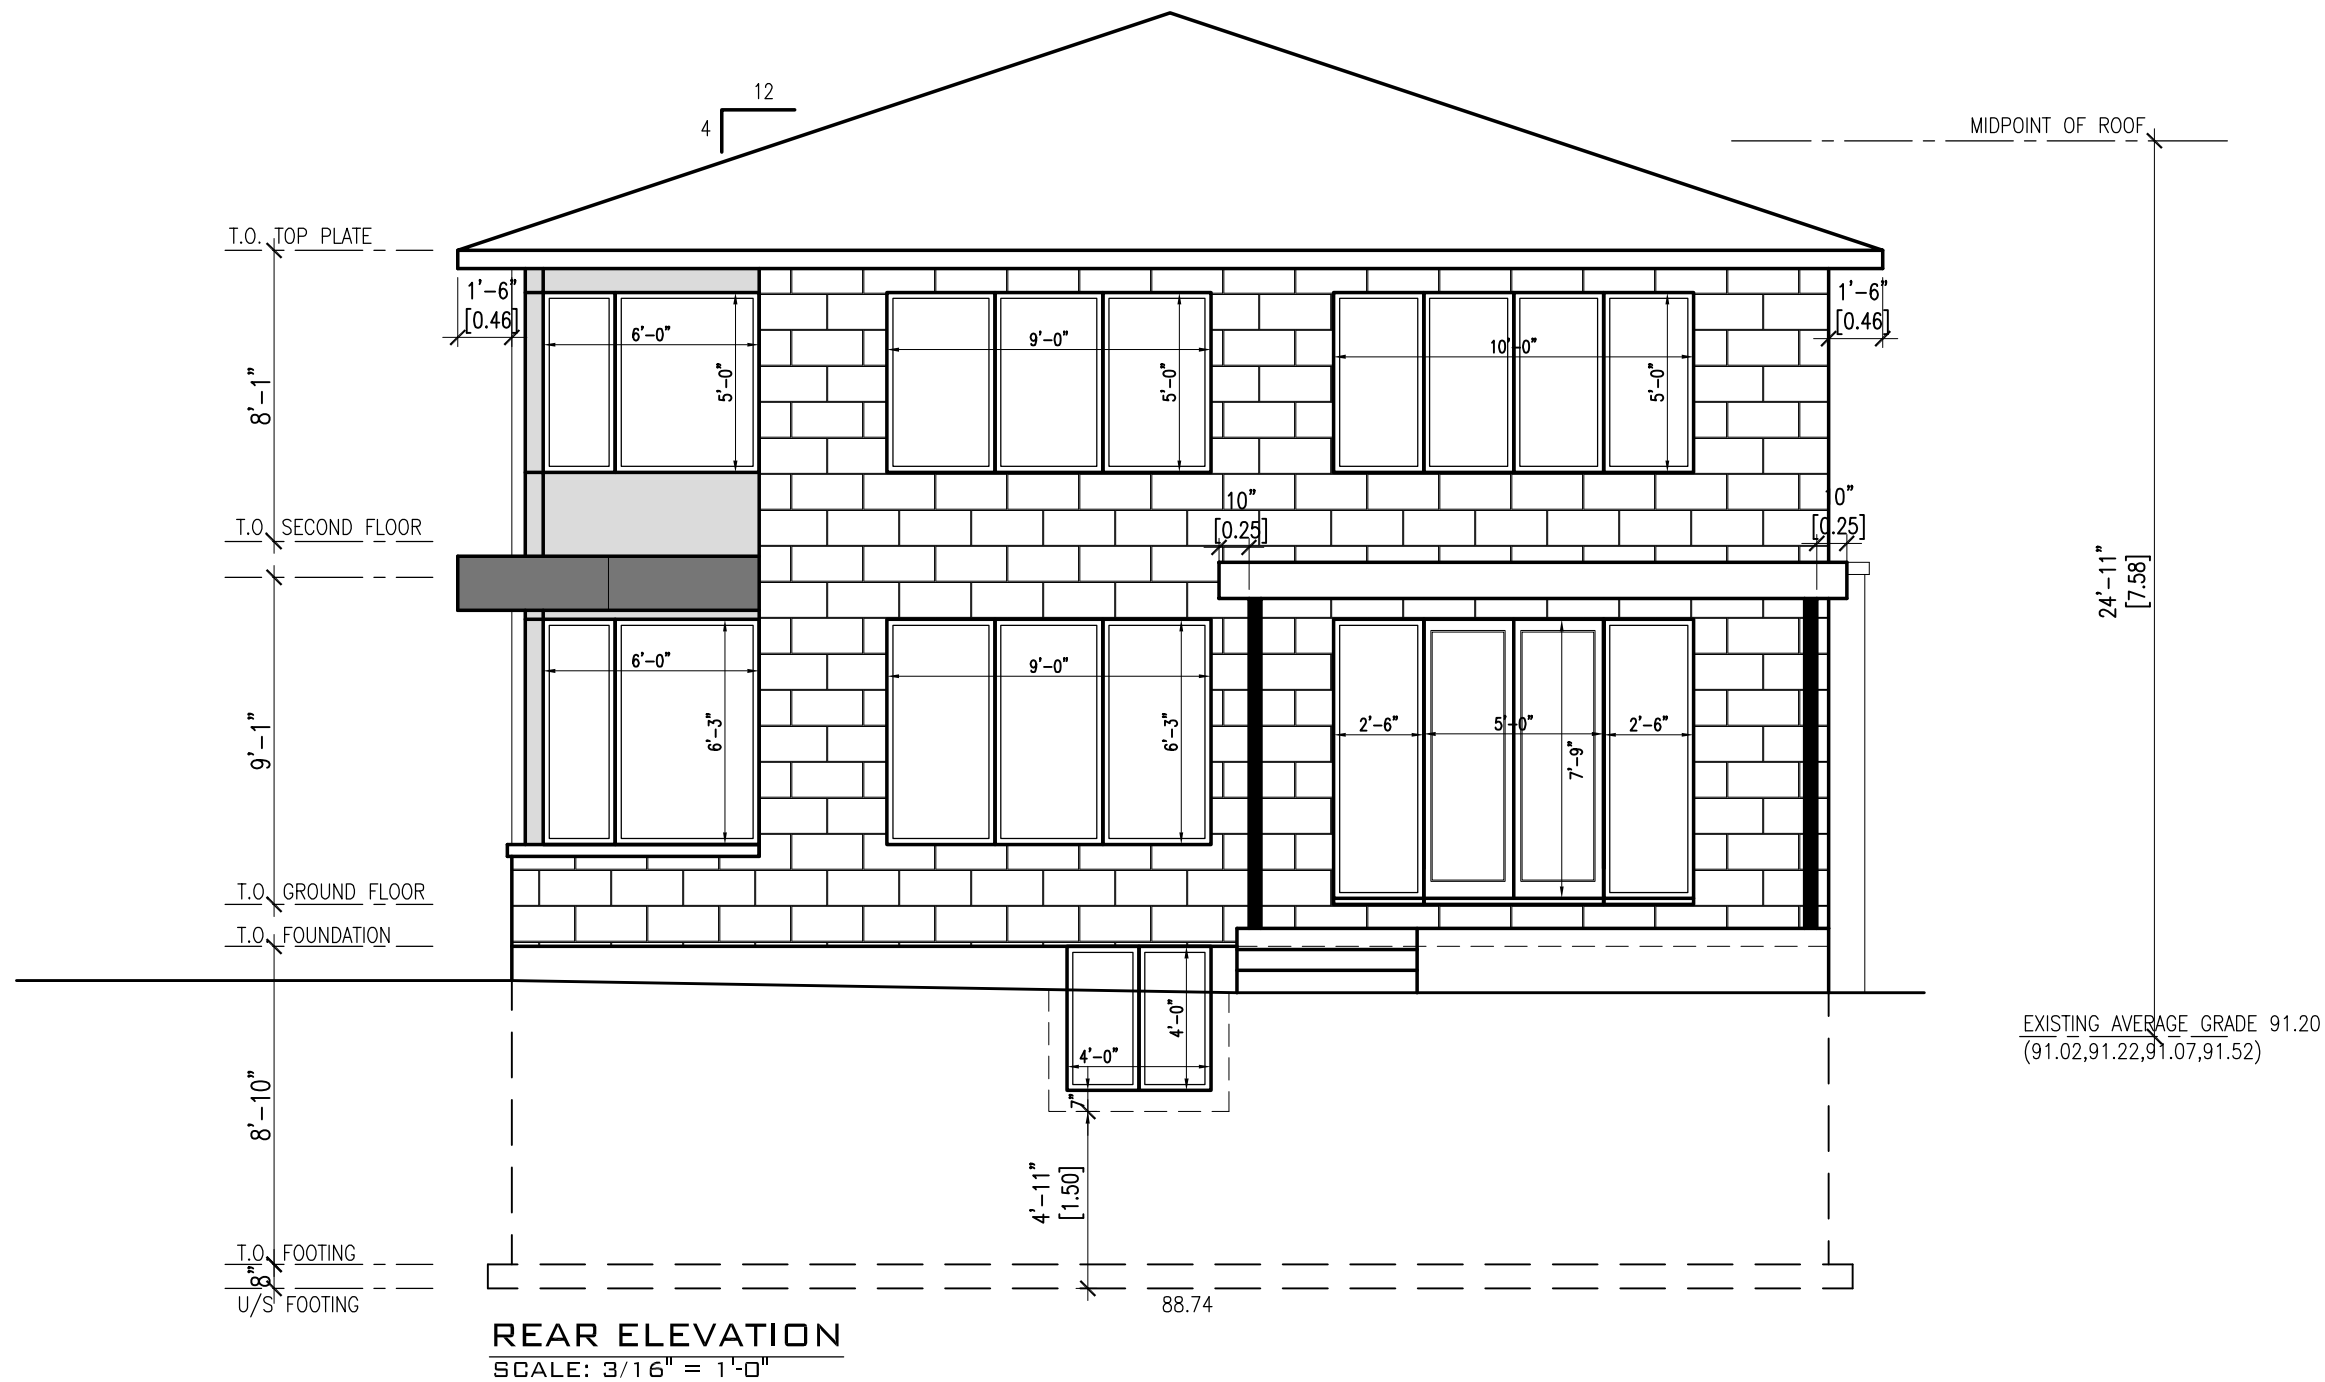

## GENERAL NOTES:

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1	
NO.	DESCRIPTION & DATE
REVISIONS	

## JOB TITLE:

PROPOSED TWO  
STOREY SFD  
101 CHIPPEWA  
OTTAWA ONT.

## SHEET TITLE:

REAR ELEVATION

SCALE: AS SHOWN

DWG NO.

DRAWN: CS

CHECKED:

DATE: JAN 2022

PRINT DATE:

A3.4



LEFT SIDE ELEVATION  
SCALE:  $\frac{3}{16}'' = 1'-0''$

SCALE: AS SHOWN	DWG NO.
DRAWN: CS	A4.4
CHECKED:	
DATE: JAN 2022	
PRINT DATE:	