




DRAWINGS LIST

SHEET NUMBER	SHEET NAME
A0.0	TITLE PAGE
A0.1	SITE SURVEY
A0.2	SITE SURVEY W/ SITE PLAN
A0.3	SITE PLAN
A1.0	SOUTH AND WEST E EVATION
A1.1	NOATH AND SAST ELEVATION
A2.0	BASEMENT FLOOR PLAN
A2.1	GROUND FLOOR PLAN
A2.2	RRACE LOCK LAN
A2.3	
A2.4	OOF PLAN
A3.0	SECTION THRU "A" - "B"
A4.0	WALL SECTIONS T-327 2021
A4.1	WALL SECTIONS 4-6
A4.2	WALL DETAILS
A5.0	WINDOW DETAILS
A5.1	ROUF DETAILS
A6.0	STAIR I DETAILS
A6.1	STAIN 2 DETAILS
A7.0	OTHER BLCW-UP DETAILS
A8.0	SCHEDULES OF DOORS, WINDOWS AND ROOMS

PROJECT DATA:

REQUIRED in the	R1 FF Zone	PROPOSED TYP	ICAL DWELLING
LOT AREA LOT WIDTH BLDG. HEIGHT LOT COVERAGE SETBACKS:	: 8.50m	(LOT - AZONNING TYPE LOT AREA LOT WIDTH LOT DEPTH	,
FRONT YARD REAR YARD SIDE YARD	: 6.00m : Varies : total is 2.1 with one yard, no less than 0.94	SETBACKS FRONT YARD REAR YARD SIDE YARD LOT COVERAGE FOOTPRINT BLDG. HEIGHT GROSS AREA	: 8.274m : 1.4m : 145.73 (34%) : 8.50

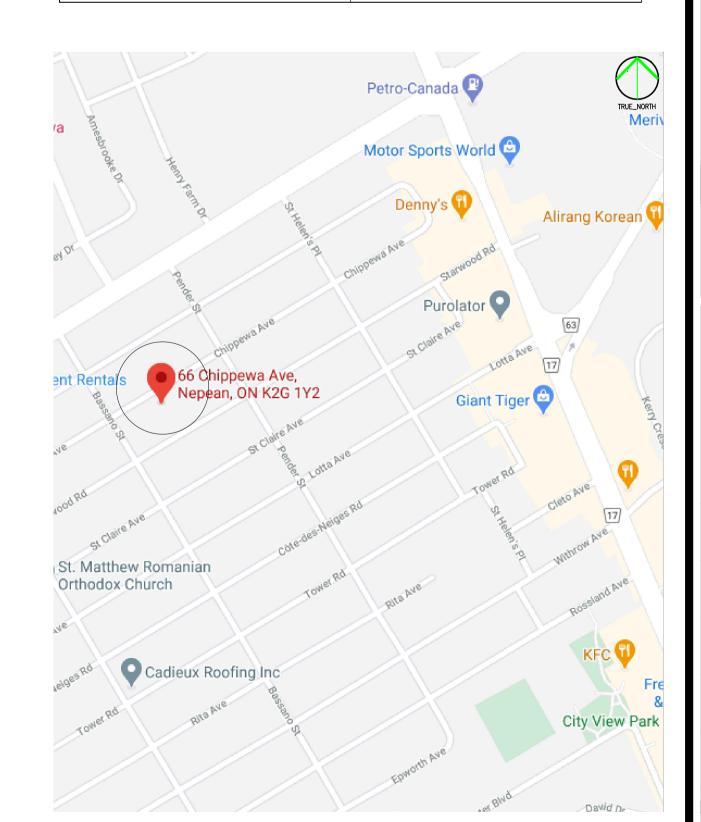

LOCATION PLAN





200-1645 RUSSELL ROAD OTTAWA, ONTARIO K1G 4G5 T: 613.228.7190 F: 613.228.8690 ANGELOMSPADOLA@GMAIL.COM

1	ISSUED FOR CLIENTS REVIEW	2020 12 03
2	CLIENTS REVIEW FOR THE MEETING	2020 12 15
3	ISSUED FOR CLIENTS REVIEW	2020 12 17
4	ISSUED FOR PLANNERS COMMENTS	2020 12 21
5	ISSUED FOR PLANNERS COMMENTS	2021 01 19
6	ISSUED FOR CLIENTS APPROVAL	2021 03 23
7	ISSUED FOR COMMITTEE OF ADJUSTMENT (COA)	2021 04 19
8		
^		

GENERAL NOTES:

- 1. THE CONTRACTOR SHALL CHECK AND VERIFY ALL DIMENSIONS AND REPORT ALL ERRORS AND OMISSIONS TO THE BEFORE PROCEEDING WITH THE WORK.
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- BY THE ARCHITECT. NOT TO BE SCALED OR REPRODUCED WITHOUT WRITTEN PERMISSION.


CONSULTANTS:

Private Residence


66 Chippewa, Nepean Ottawa, Ontario

PERSPECTIVES DRAWINGS LIST PROJECT DATA LOCATION PLAN


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PROJ. #:	XXX
DRAWN BY:	VR
CHECKED BY:	AMS

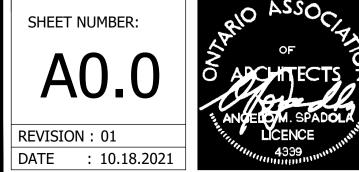


PERSPECTIVES

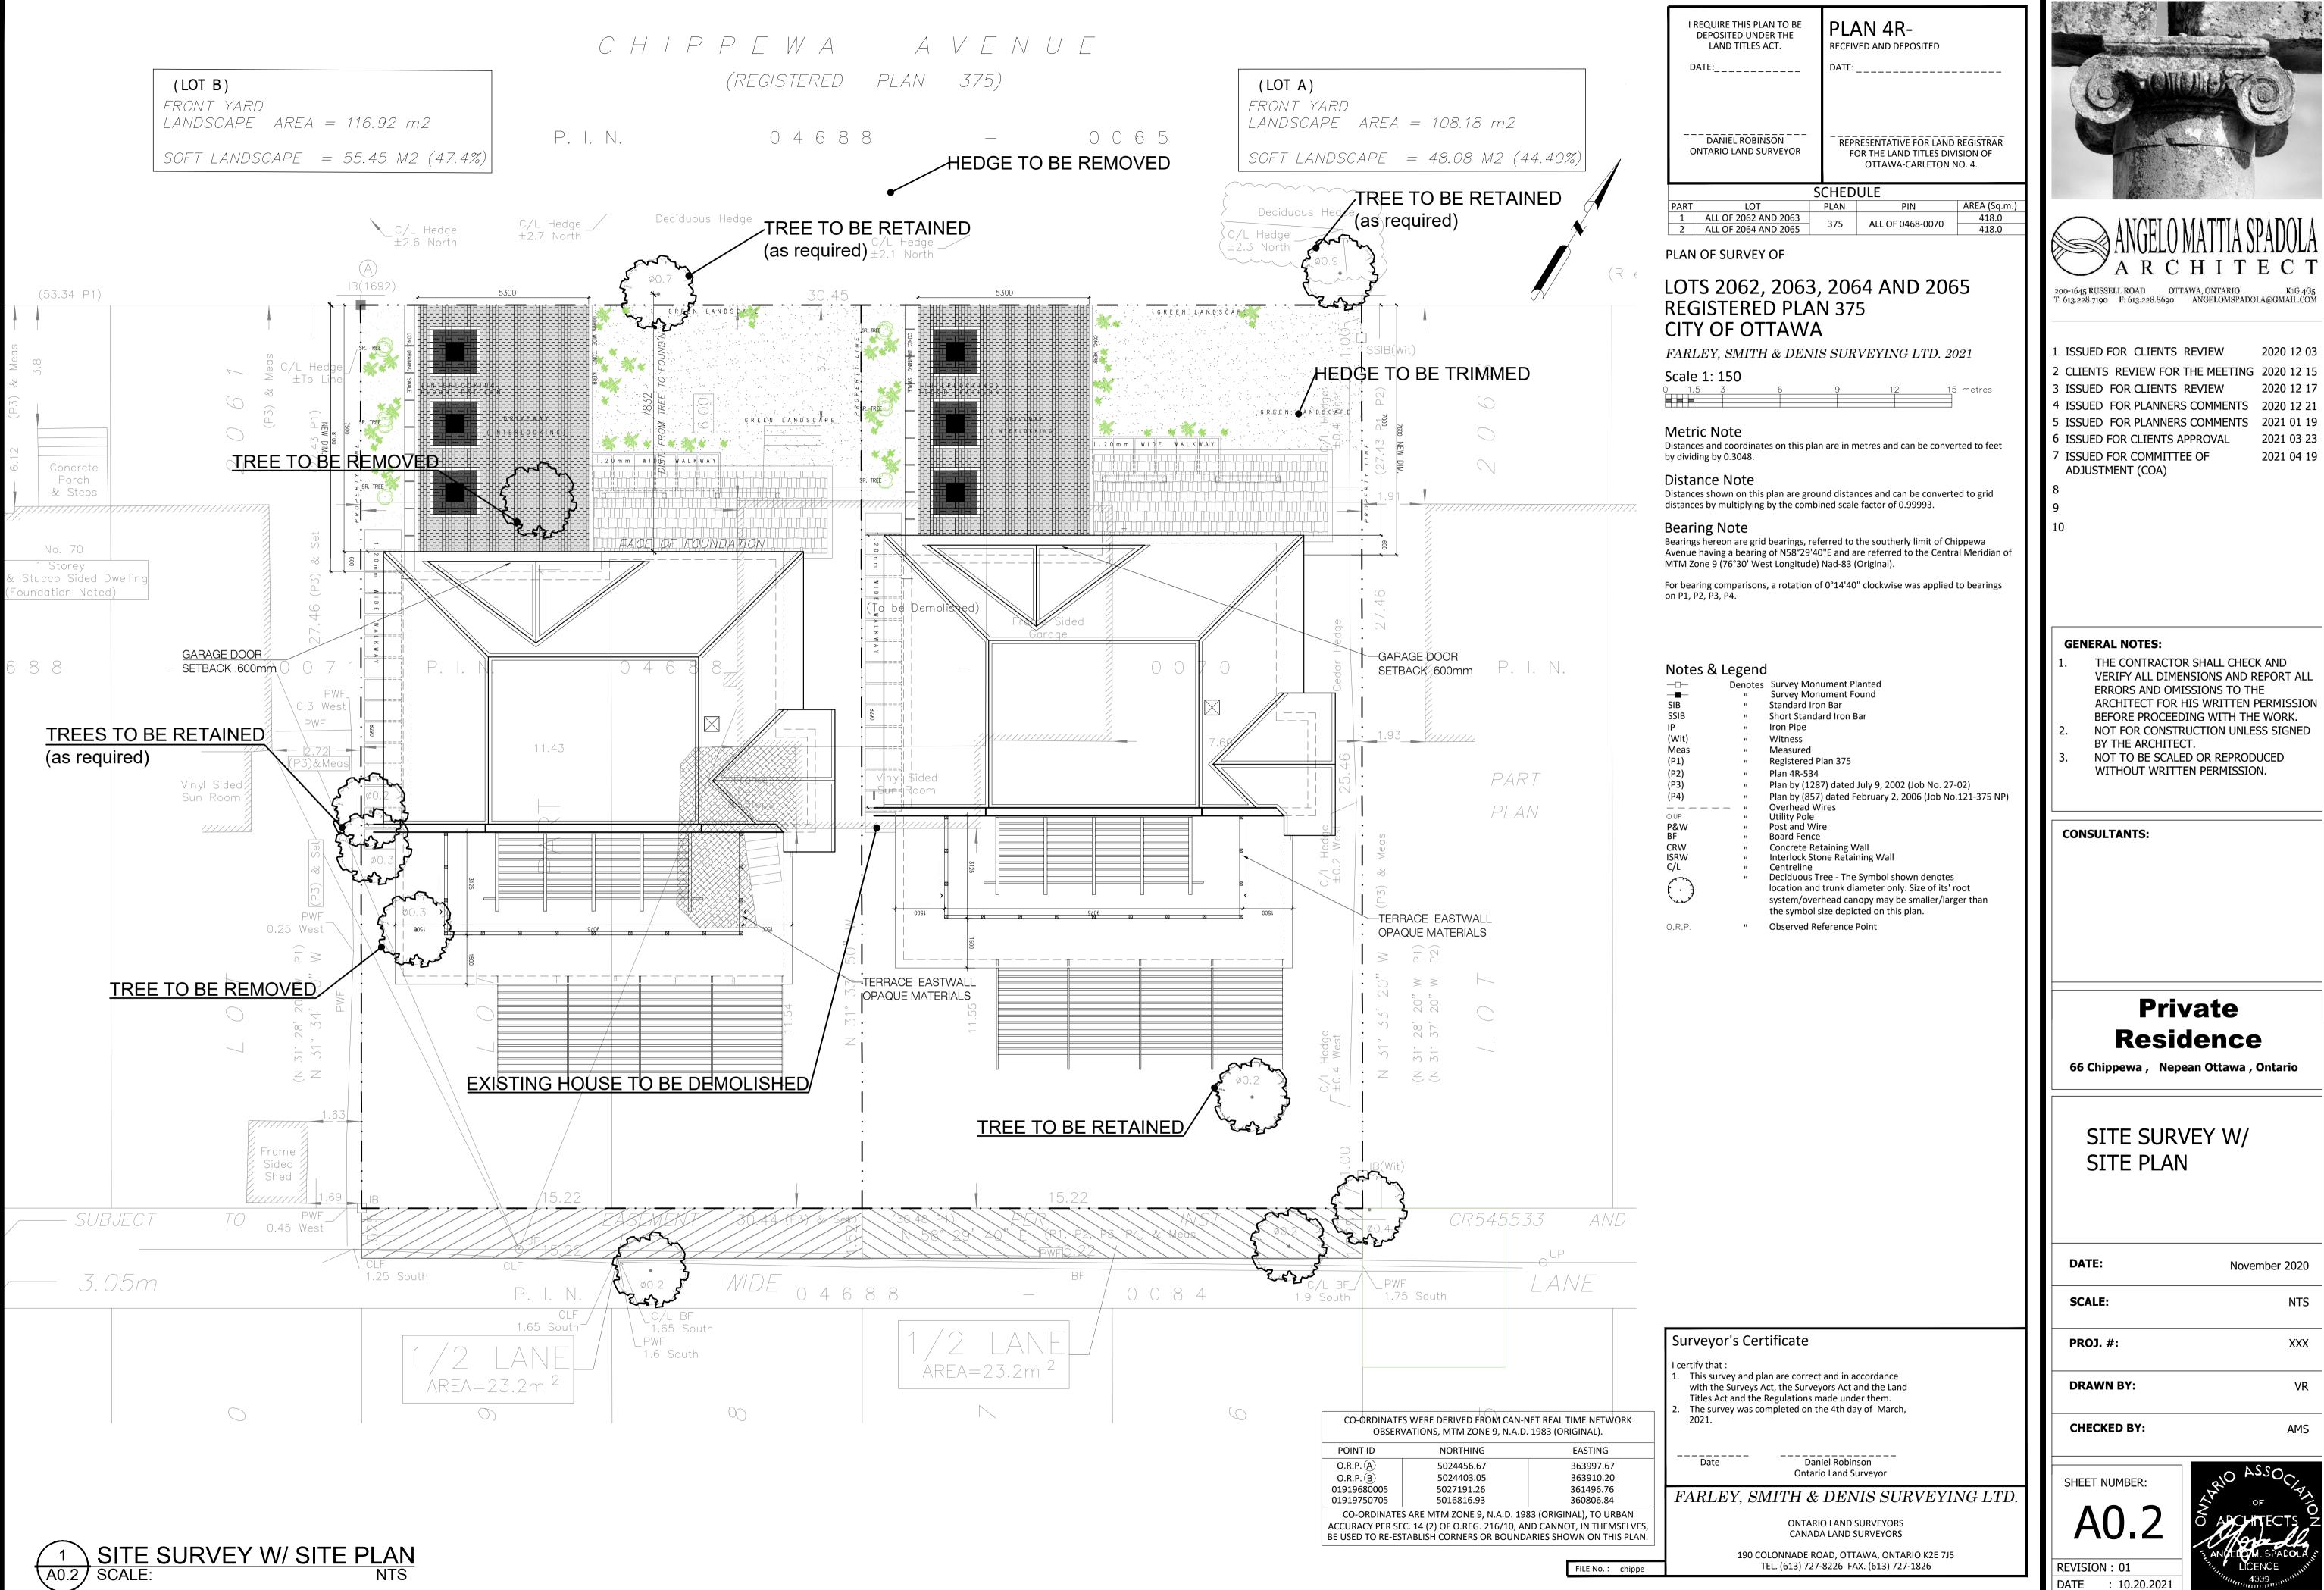



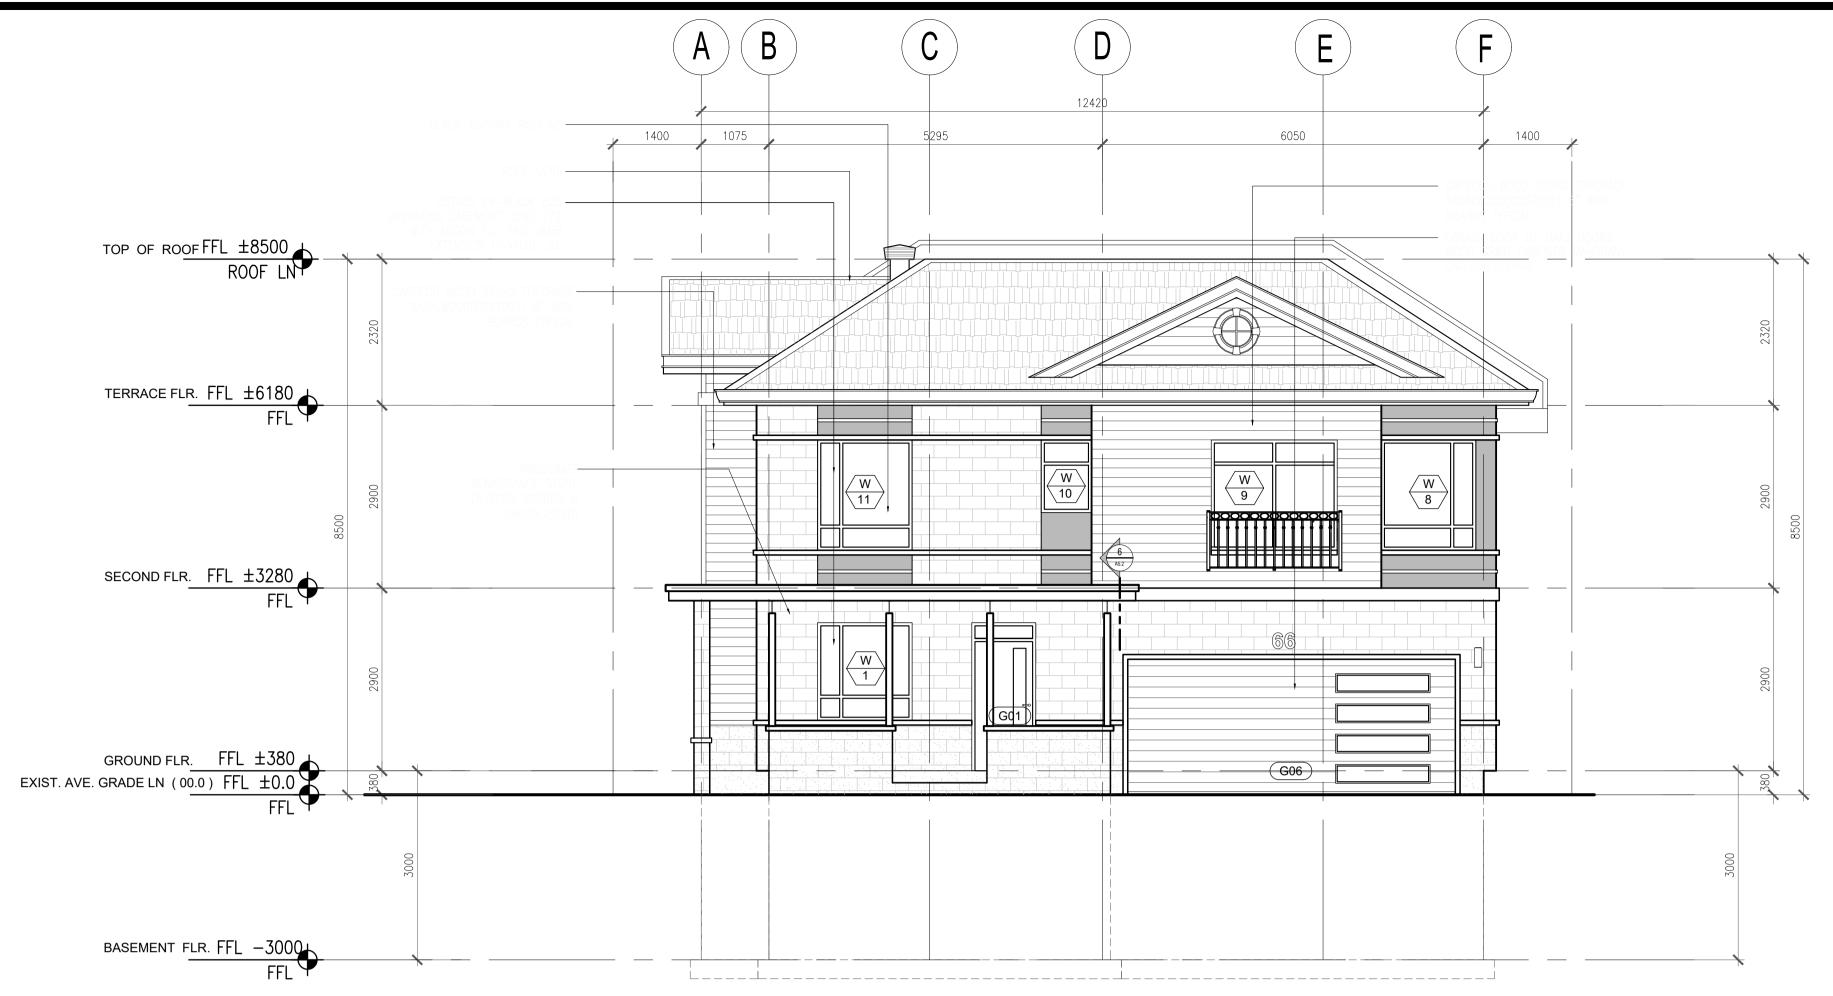

O1 SOUTH ELEVATION
A1.0 SCALE: 1:60 M

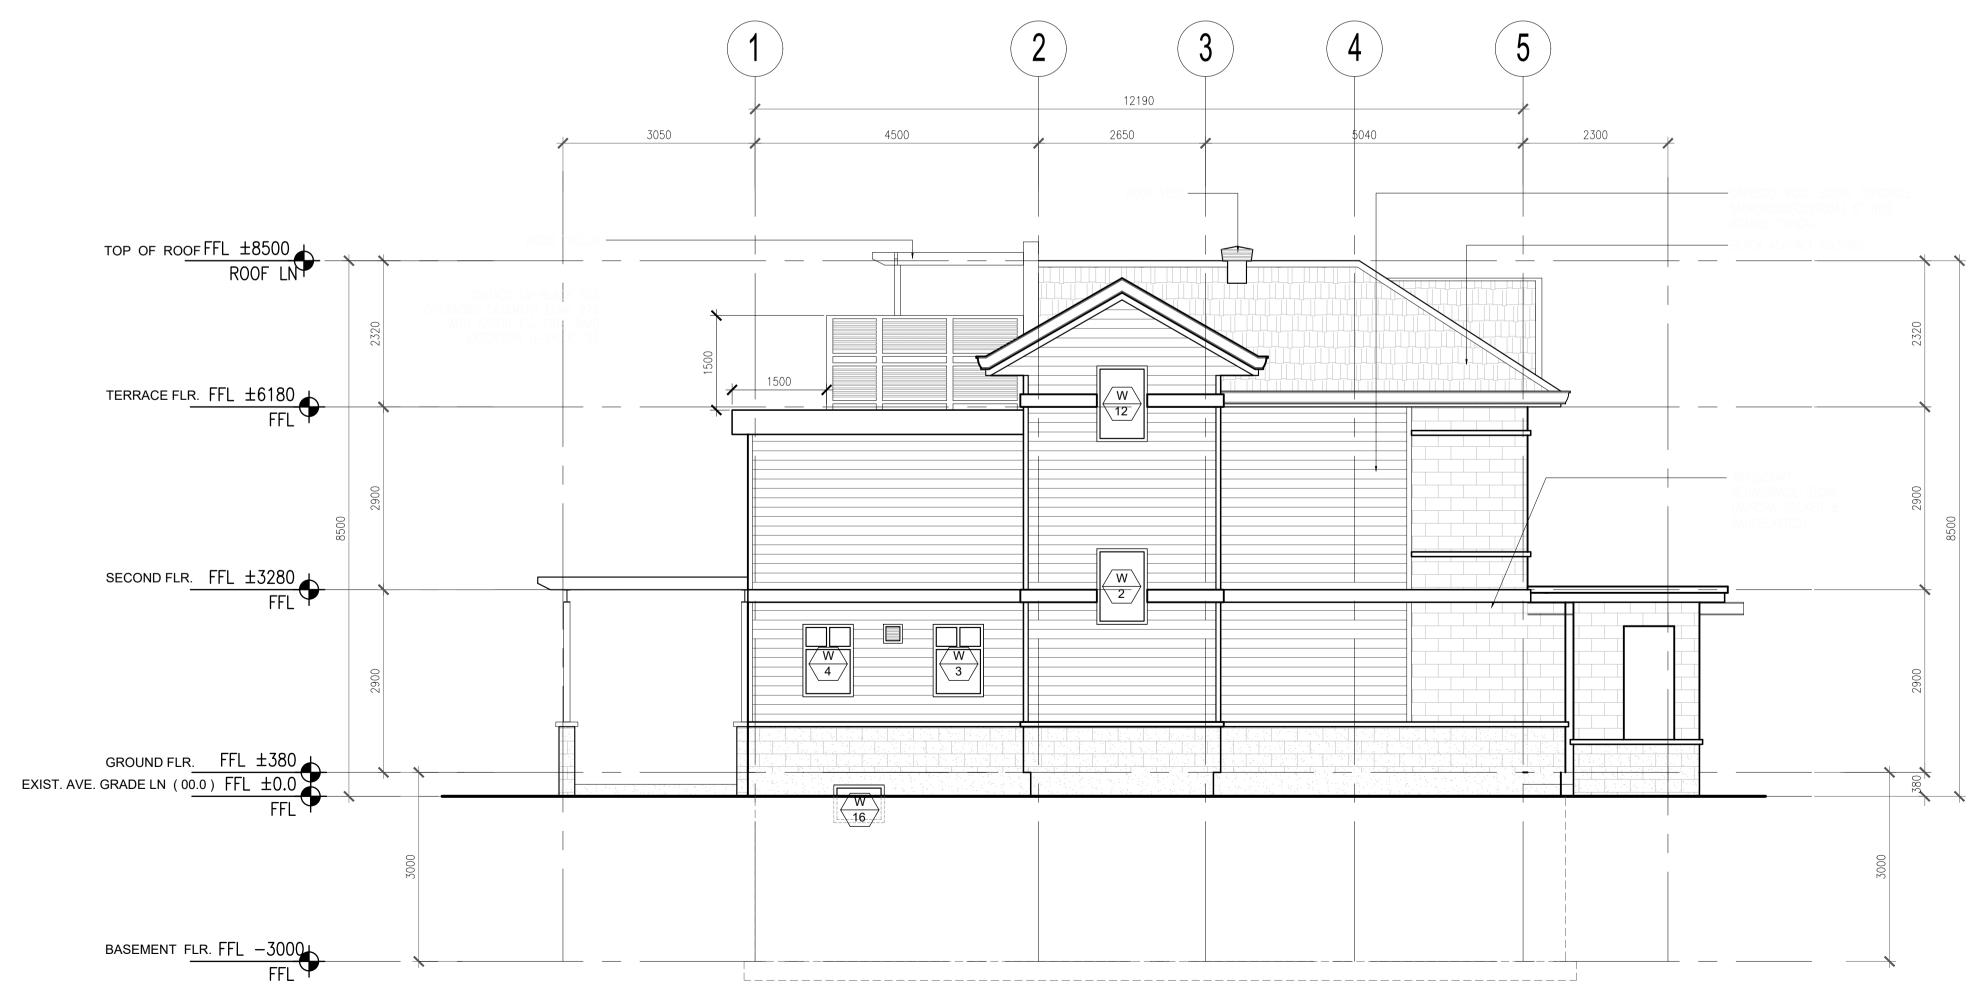

ANGELO MATTIA SPADOLA A R C H I T E C T

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ADJUSTMENT (COA)

GENERAL NOTES:

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CONSULTANTS:

Private Residence

66 Chippewa, Nepean Ottawa, Ontario

SOUTH & WEST ELEVATION

DATE:	November 2020
SCALE:	1 :60
PROJ. #:	XXX
DRAWN BY:	VR

SHEET NUMBE

CHECKED BY:

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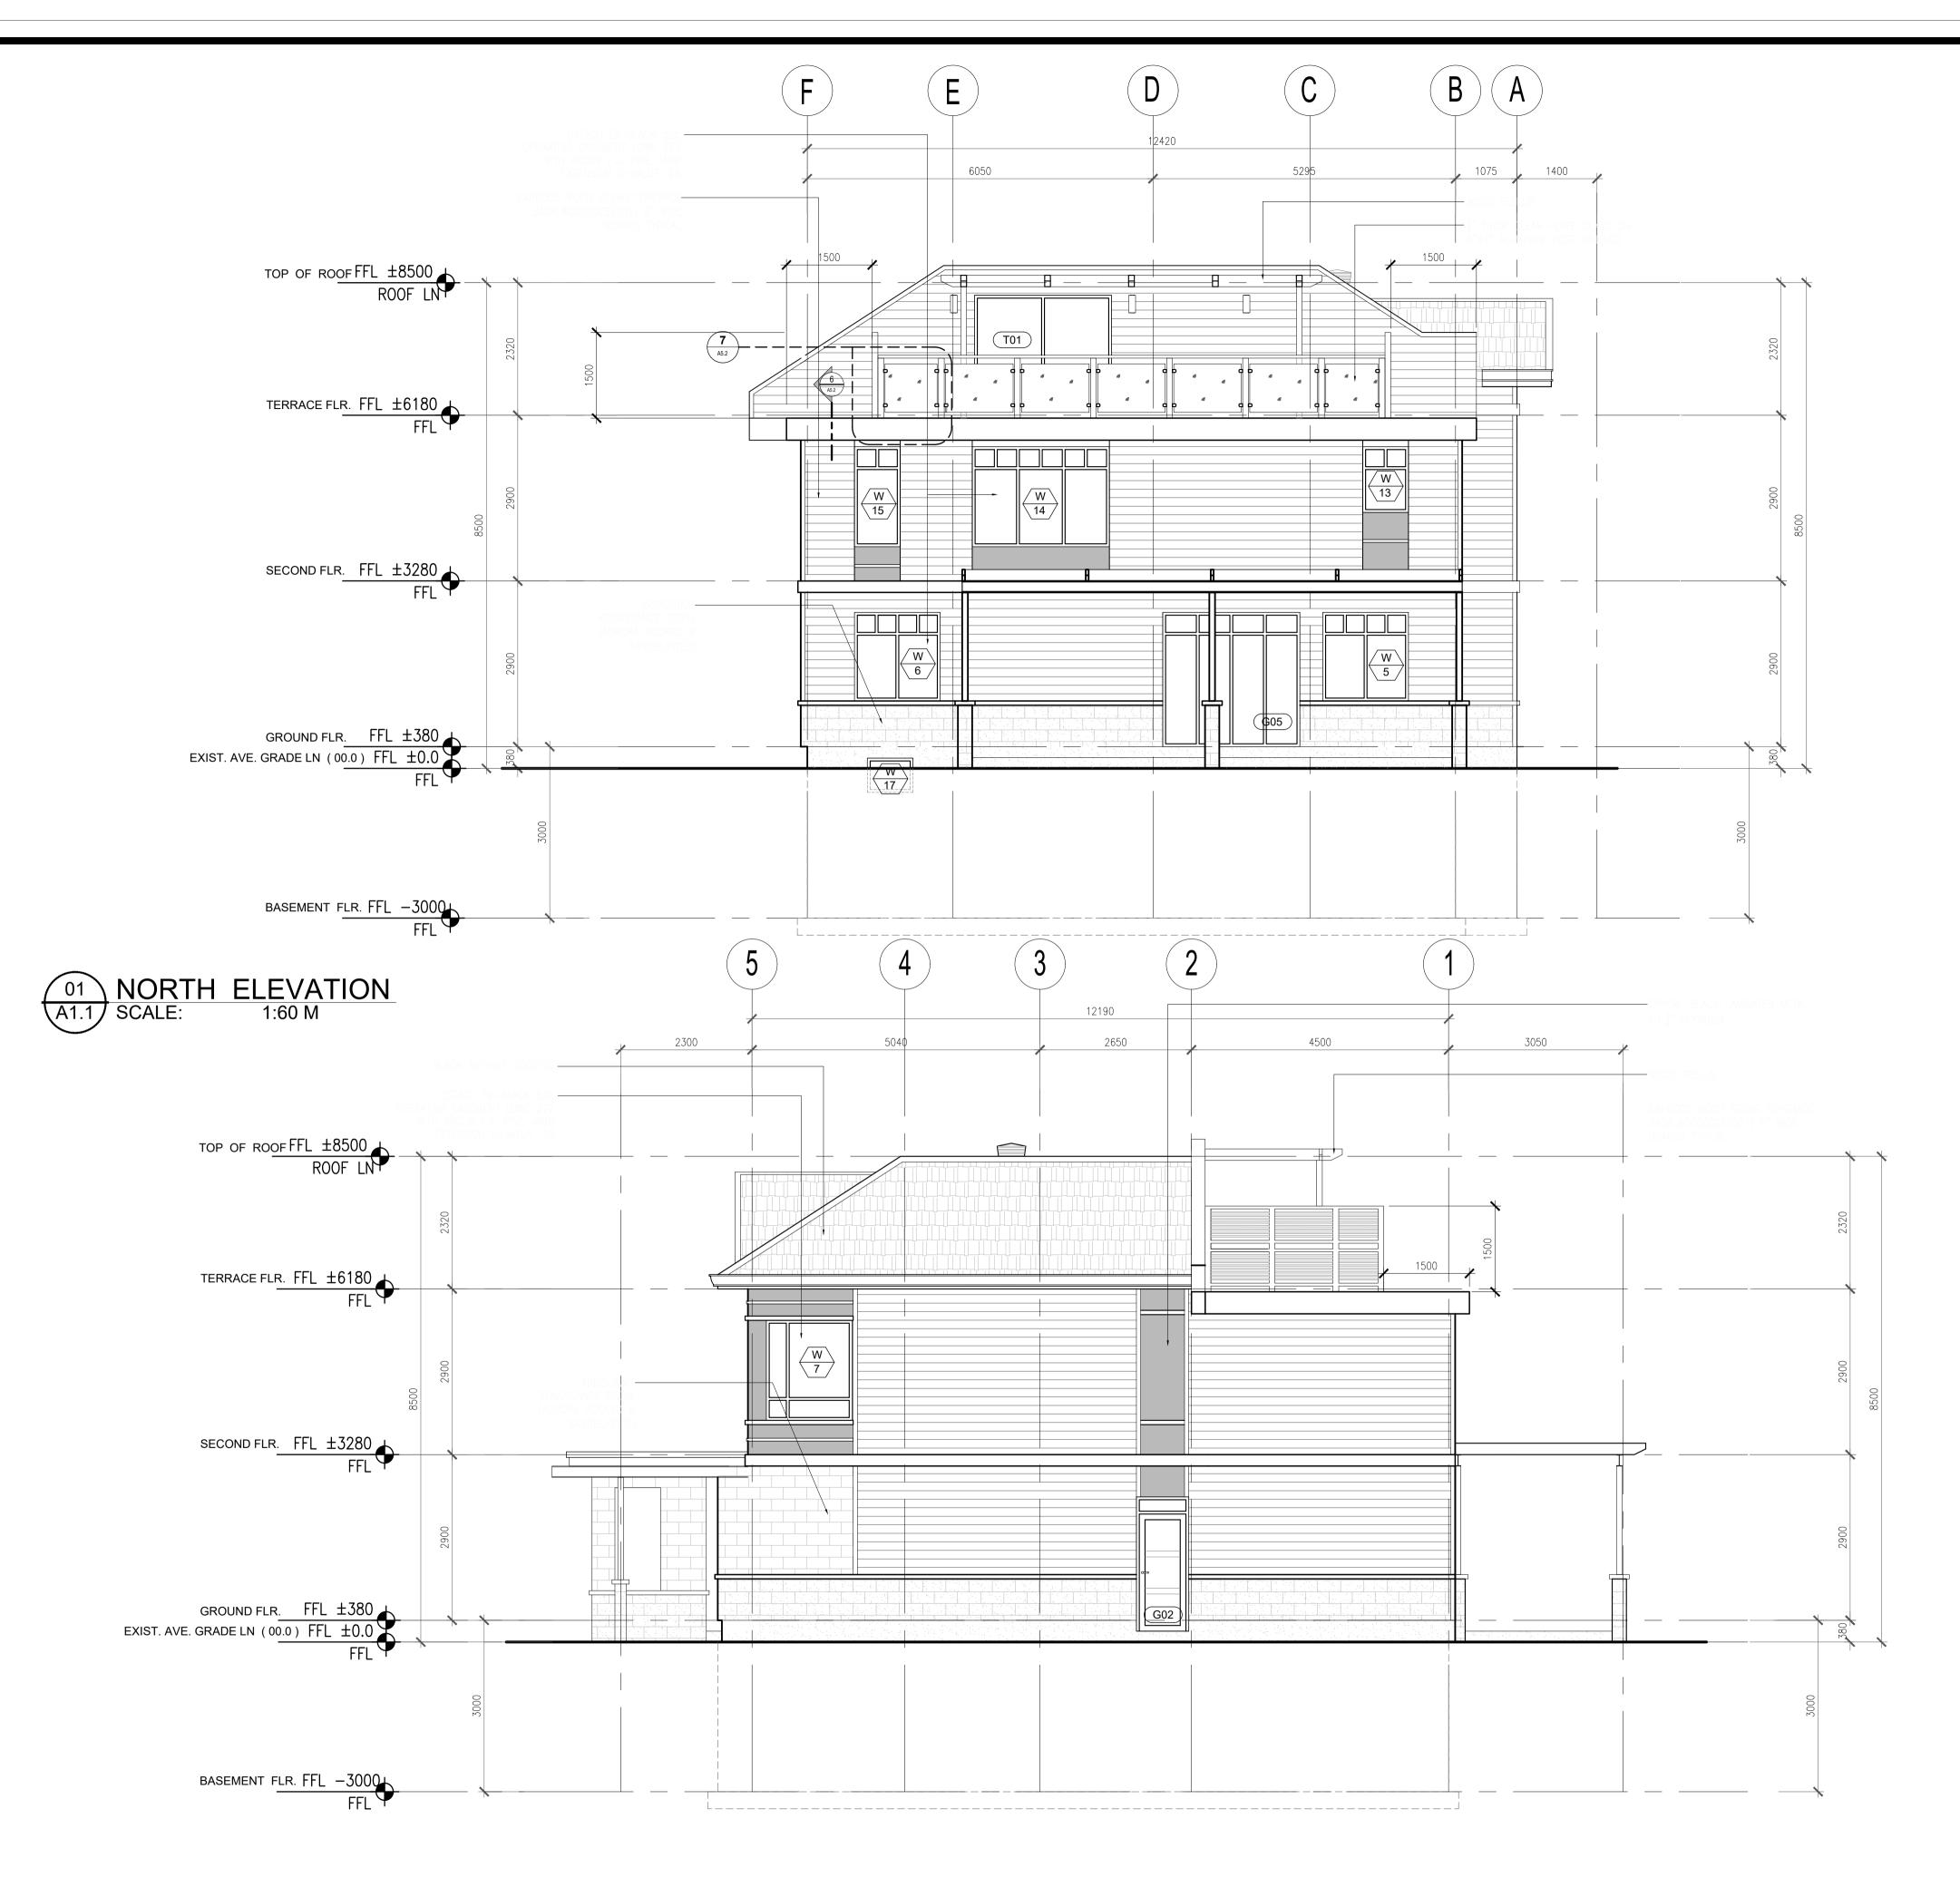
REVISION: 01

DATE: 10.20.2021



WEST ELEVATION
A1.0 SCALE: 1:60 M

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2021 04 19

7 ISSUED FOR COMMITTEE OF ADJUSTMENT (COA) 8

GENERAL NOTES:

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CONSULTANTS:

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66 Chippewa, Nepean Ottawa, Ontario

NORTH & EAST ELEVATION


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DRAWN BY:	VR

CHECKED BY:

A1.1

DATE : 10.20.2021




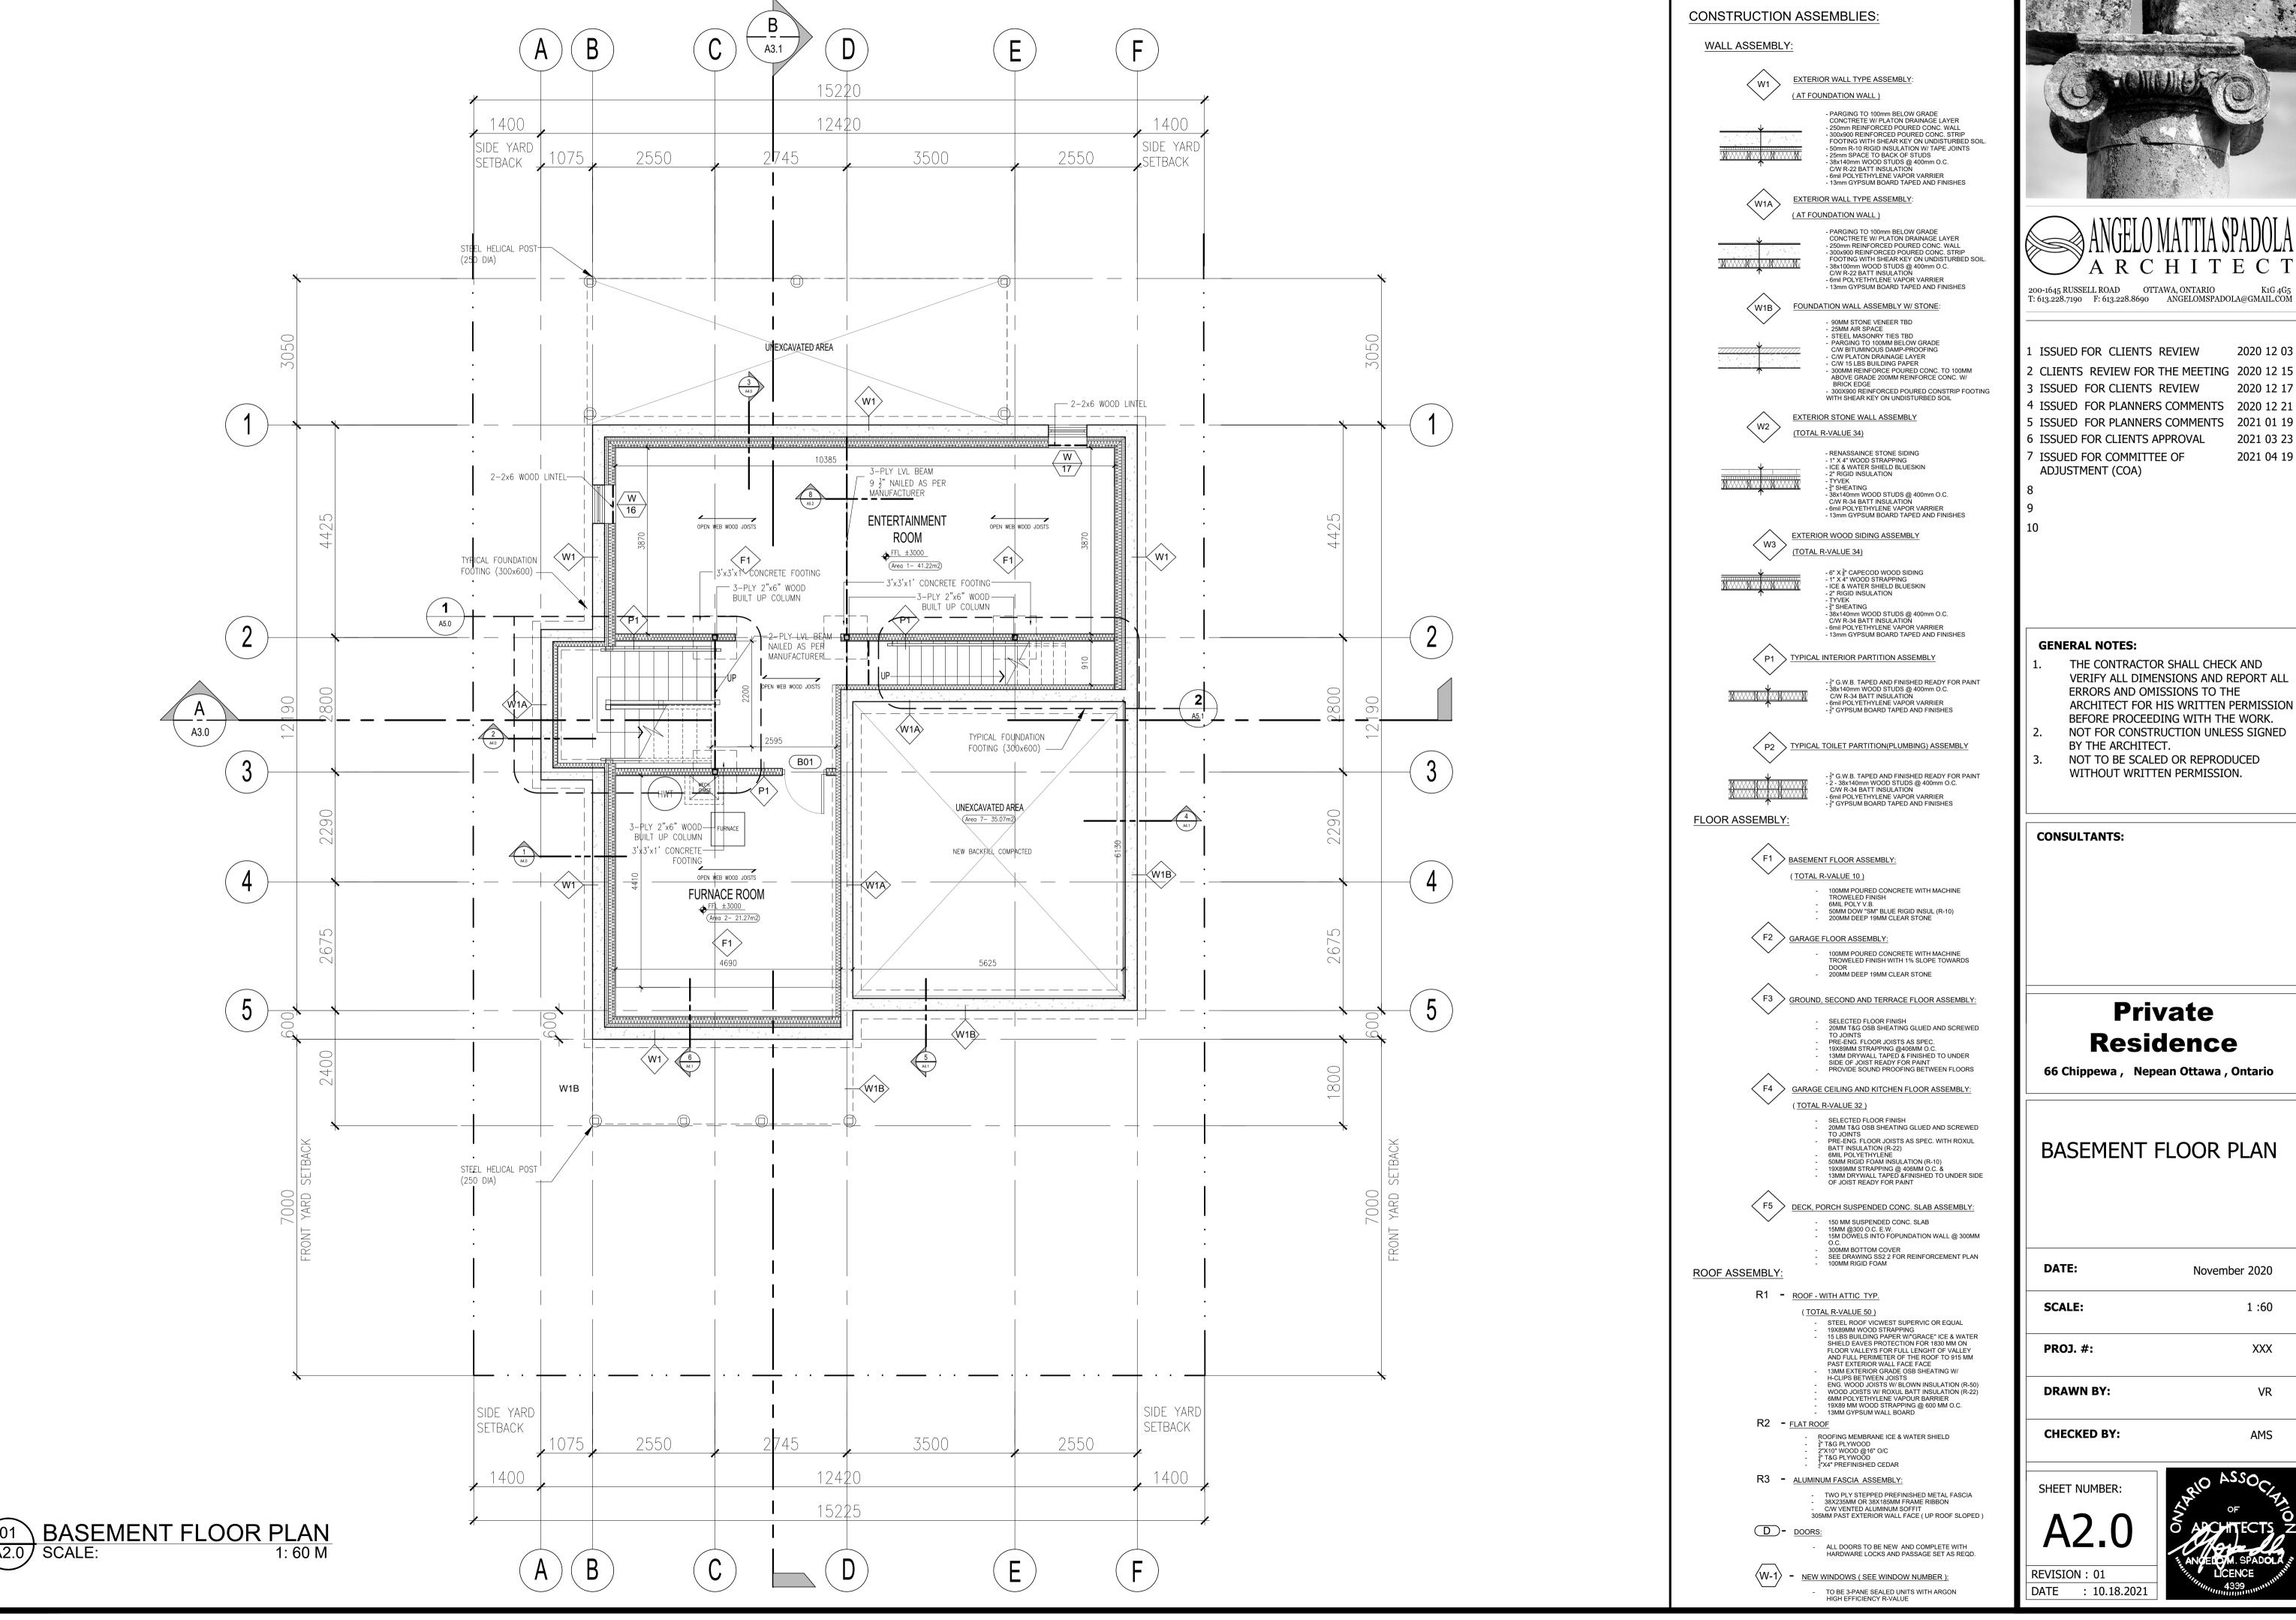






2020 12 03 2020 12 17 2021 03 23 2021 04 19

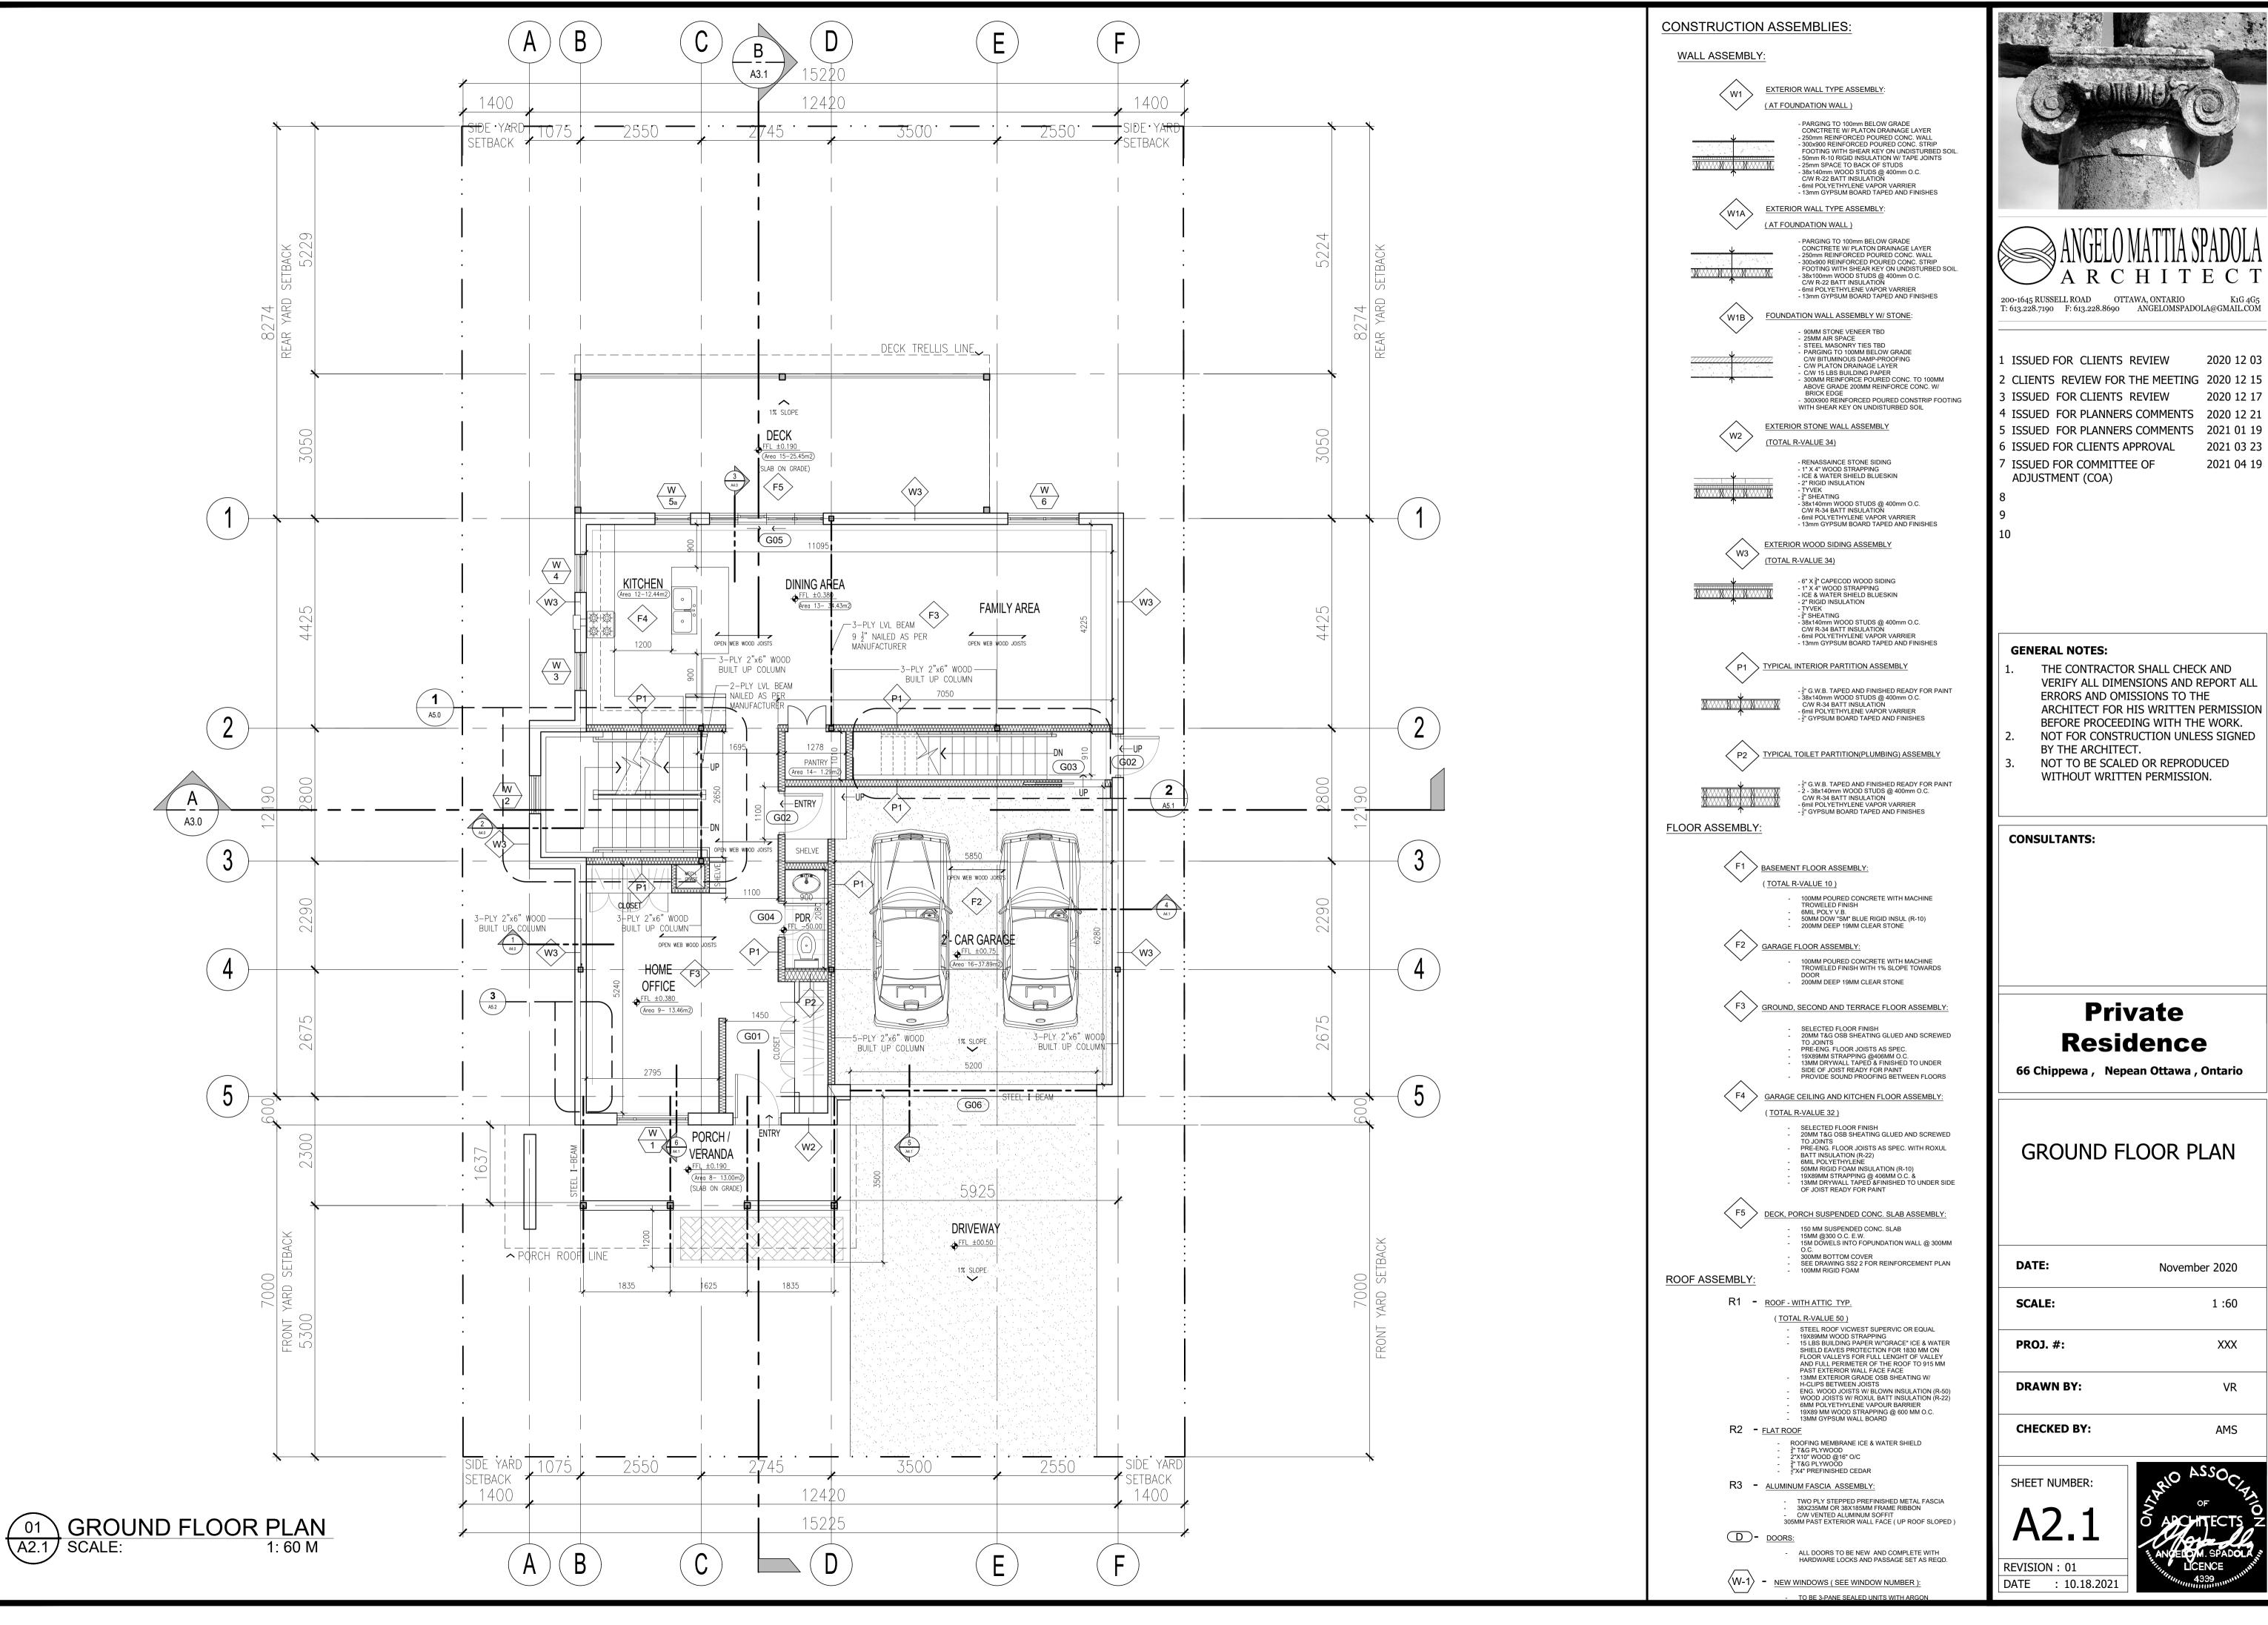

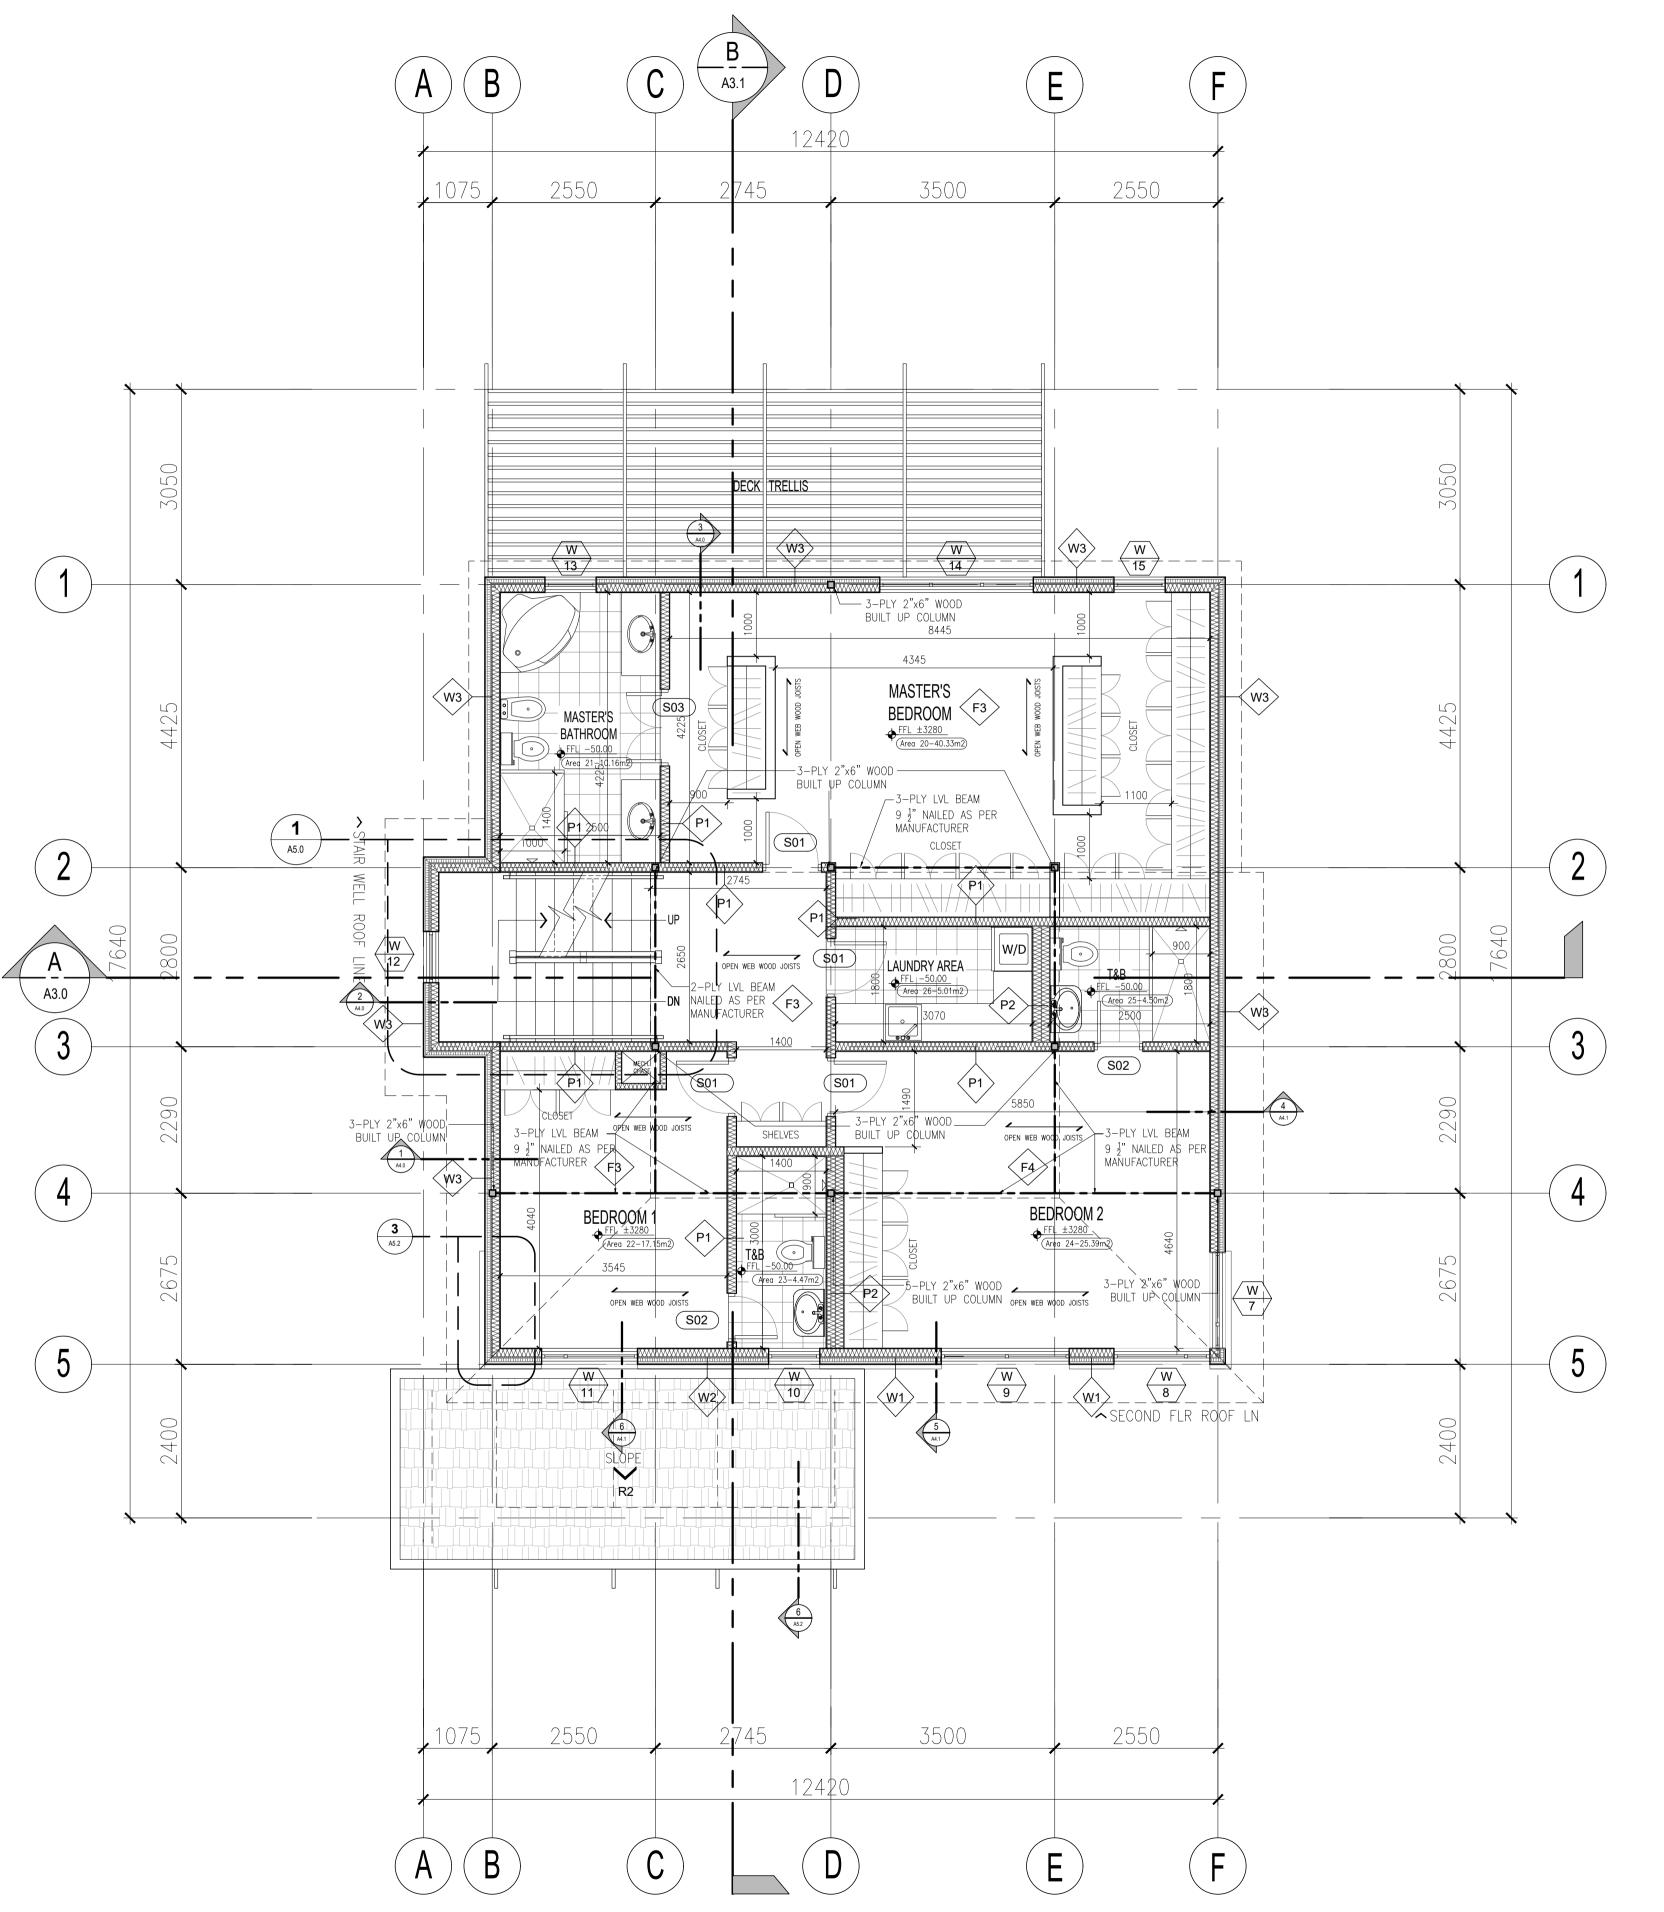


CONSTRUCTION ASSEMBLIES:

WALL ASSEMBLY:



EXTERIOR WALL TYPE ASSEMBLY: (AT FOUNDATION WALL)

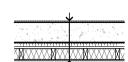


- PARGING TO 100mm BELOW GRADE CONCTRETE W/ PLATON DRAINAGE LAYER - 250mm REINFORCED POURED CONC. WALL - 300x900 REINFORCED POURED CONC. STRIP FOOTING WITH SHEAR KEY ON UNDISTURBED SOIL.

- 50mm R-10 RIGID INSULATION W/ TAPE JOINTS

- 25mm SPACE TO BACK OF STUDS - 38x140mm WOOD STUDS @ 400mm O.C. C/W R-22 BATT INSULATION - 6mil POLYETHYLENE VAPOR VARRIER - 13mm GYPSUM BOARD TAPED AND FINISHES



EXTERIOR WALL TYPE ASSEMBLY: (AT FOUNDATION WALL)

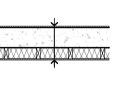


- PARGING TO 100mm BELOW GRADE CONCTRETE W/ PLATON DRAINAGE LAYER - 250mm REINFORCED POURED CONC. WALL - 300x900 REINFORCED POURED CONC. STRIP FOOTING WITH SHEAR KEY ON UNDISTURBED SOIL. - 38x100mm WOOD STUDS @ 400mm O.C. C/W R-22 BATT INSULATION - 6mil POLYETHYLENE VAPOR VARRIER - 13mm GYPSUM BOARD TAPED AND FINISHES



FOUNDATION WALL ASSEMBLY W/ STONE:

90MM STONE VENEER TBD

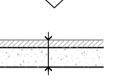


- 90MM GIONE VEHICLE TED - 25MM AIR SPACE - STEEL MASONRY TIES TBD - PARGING TO 100MM BELOW GRADE C/W PLATON DRAINAGE LAYER C/W 15 LBS BUILDING PAPER 300MM REINFORCE POURED CONC. TO 100MM ABOVE GRADE 200MM REINFORCE CONC. W/ BRICK EDGE - 300X900 REINFORCED POURED CONSTRIP FOOTING WITH SHEAR KEY ON UNDISTURBED SOIL



EXTERIOR STONE WALL ASSEMBLY (TOTAL R-VALUE 34)

EXTERIOR WOOD SIDING ASSEMBLY

- 3 SHEATING

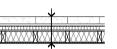

- RENASSAINCE STONE SIDING - 1" X 4" WOOD STRAPPING - ICE & WATER SHIELD BLUESKIN 2" RIGID INSULATION - TYVEK - ³/₄" SHEATING - 3" SHEATING - 38x140mm WOOD STUDS @ 400mm O.C. C/W R-34 BATT INSULATION - 6mil POLYETHYLENE VAPOR VARRIER - 13mm GYPSUM BOARD TAPED AND FINISHES



- 6" X 🖁" CAPECOD WOOD SIDING - 1" X 4" WOOD STRAPPING - ICE & WATER SHIELD BLUESKIN 2" RIGID INSULATION



> TYPICAL INTERIOR PARTITION ASSEMBLY - ½" G.W.B. TAPED AND FINISHED READY FOR PAINT - 38x140mm WOOD STUDS @ 400mm O.C. C/W R-34 BATT INSULATION

6mil POLYETHYLENE VAPOR VARRIER $-\frac{1}{2}$ " GYPSUM BOARD TAPED AND FINISHES



 $-\frac{1}{2}$ " G.W.B. TAPED AND FINISHED READY FOR PAINT 2 - 38x140mm WOOD STUDS @ 400mm O.C. C/W R-34 BATT INSULATION 6mil POLYETHYLENE VAPOR VARRIER 1 GYPSUM BOARD TAPED AND FINISHES

FLOOR ASSEMBLY:

(TOTAL R-VALUE 10)

> 100MM POURED CONCRETE WITH MACHINE TROWELED FINISH 6MIL POLY V.B. 50MM DOW "SM" BLUE RIGID INSUL (R-10) 200MM DEEP 19MM CLEAR STONE

 \langle F2 \rangle GARAGE FLOOR ASSEMBLY:

100MM POURED CONCRETE WITH MACHINE TROWELED FINISH WITH 1% SLOPE TOWARDS 200MM DEEP 19MM CLEAR STONE



SELECTED FLOOR FINISH 20MM T&G OSB SHEATING GLUED AND SCREWED TO JOINTS
PRE-ENG. FLOOR JOISTS AS SPEC. PRE-ENG. FLOOR JOISTS AS SPEC.

19X89MM STRAPPING @406MM O.C.

13MM DRYWALL TAPED & FINISHED TO UNDER

SIDE OF JOIST READY FOR PAINT

PROVIDE SOUND PROOFING BETWEEN FLOORS



SELECTED FLOOR FINISH 20MM T&G OSB SHEATING GLUED AND SCREWED ZOMM 1 KB OSB SHEATING GLUED AND SCREWED TO JOINTS
PRE-ENG, FLOOR JOISTS AS SPEC. WITH ROXUL
BATT INSULATION (R-22)
6MIL POLYETHYLENE
50MM RIGID FOAM INSULATION (R-10) 19X89MM STRAPPING @ 406MM O.C. & 13MM DRYWALL TAPED &FINISHED TO UNDER SIDE OF JOIST READY FOR PAINT



O.C. 300MM BOTTOM COVER SEE DRAWING SS2 2 FOR REINFORCEMENT PLAN 100MM RIGID FOAM ROOF ASSEMBLY:

R1 - ROOF - WITH ATTIC TYP.

(TOTAL R-VALUE 50) STEEL ROOF VICWEST SUPERVIC OR EQUAL STEEL ROOF VICWEST SUPERVIC OR EQUAL
19X89MM WOOD STRAPPING
15 LBS BUILDING PAPER W/"GRACE" ICE & WATER
SHIELD EAVES PROTECTION FOR 1830 MM ON
FLOOR VALLEYS FOR FULL LENGHT OF VALLEY
AND FULL PERIMETER OF THE ROOF TO 915 MM
PAST EXTERIOR WALL FACE FACE
13MM EXTERIOR GRADE OSB SHEATING W/
H-CLIPS BETWEEN JOISTS
ENG. WOOD JOISTS W/ BLOWN INSULATION (R-50)
WOOD JOISTS W/ ROXUL BATT INSULATION (R-22)
6MM POL YETHYL ENE VAPOUR BABBLIER

6MM POLYETHYLENE VAPOUR BARRIER 19X89 MM WOOD STRAPPING @ 600 MM O.C. 13MM GYPSUM WALL BOARD

R2 - FLAT ROOF

ROOFING MEMBRANE ICE & WATER SHIELD ³/₄" T&G PLYWOOD 2"X10" WOOD @16" O/C ³/₄" T&G PLYWOOD

R3 - ALUMINUM FASCIA ASSEMBLY:

TWO PLY STEPPED PREFINISHED METAL FASCIA 38X235MM OR 38X185MM FRAME RIBBON - C/W VENTED ALUMINUM SOFFIT 305MM PAST EXTERIOR WALL FACE (UP ROOF SLOPED)

D- DOORS:

ALL DOORS TO BE NEW AND COMPLETE WITH







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ADJUSTMENT (COA)

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CONSULTANTS:

Private Residence

66 Chippewa, Nepean Ottawa, Ontario

SECOND FLOOR PLAN


DATE:	November 2020
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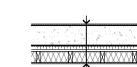


CONSTRUCTION ASSEMBLIES:

WALL ASSEMBLY:



EXTERIOR WALL TYPE ASSEMBLY: (AT FOUNDATION WALL)

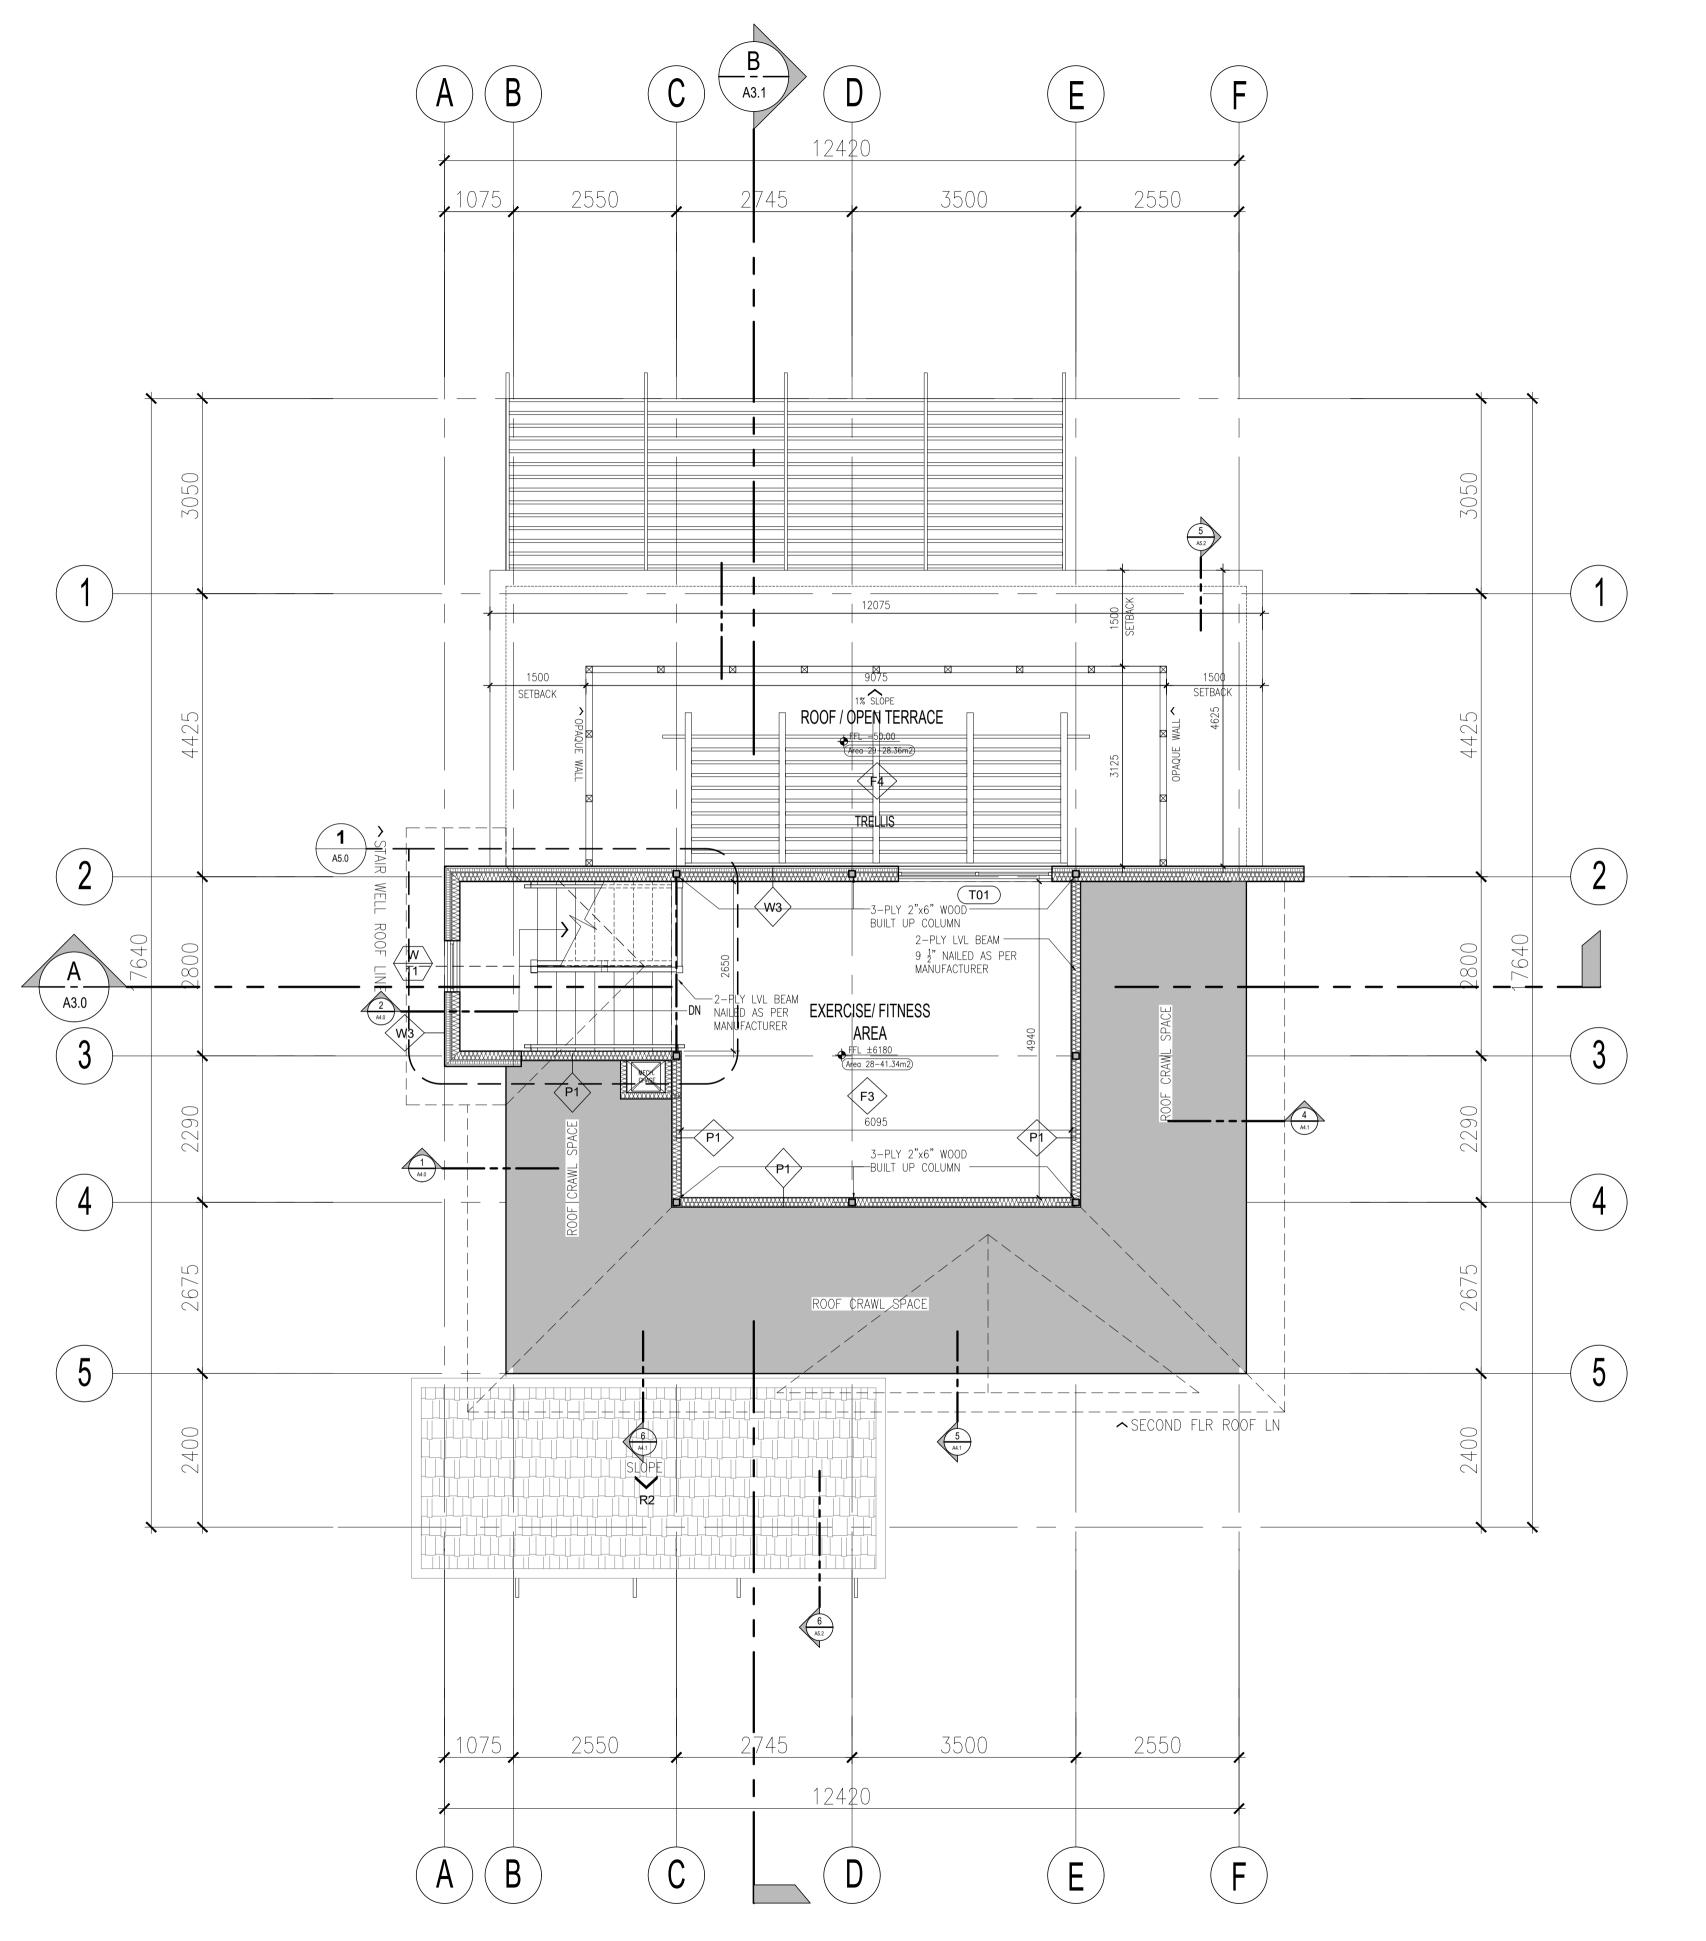


- PARGING TO 100mm BELOW GRADE CONCTRETE W/ PLATON DRAINAGE LAYER - 250mm REINFORCED POURED CONC. WALL - 300x900 REINFORCED POURED CONC. STRIP FOOTING WITH SHEAR KEY ON UNDISTURBED SOIL.

- 50mm R-10 RIGID INSULATION W/ TAPE JOINTS

- 25mm SPACE TO BACK OF STUDS - 38x140mm WOOD STUDS @ 400mm O.C. C/W R-22 BATT INSULATION - 6mil POLYETHYLENE VAPOR VARRIER - 13mm GYPSUM BOARD TAPED AND FINISHES



EXTERIOR WALL TYPE ASSEMBLY: (AT FOUNDATION WALL)

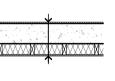


- PARGING TO 100mm BELOW GRADE CONCTRETE W/ PLATON DRAINAGE LAYER - 250mm REINFORCED POURED CONC. WALL - 300x900 REINFORCED POURED CONC. STRIP FOOTING WITH SHEAR KEY ON UNDISTURBED SOIL. - 38x100mm WOOD STUDS @ 400mm O.C. C/W R-22 BATT INSULATION - 6mil POLYETHYLENE VAPOR VARRIER - 13mm GYPSUM BOARD TAPED AND FINISHES



FOUNDATION WALL ASSEMBLY W/ STONE:

90MM STONE VENEER TBD

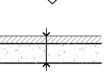


- 90MM GIONE VEHICLE TED - 25MM AIR SPACE - STEEL MASONRY TIES TBD - PARGING TO 100MM BELOW GRADE C/W BITUMINOUS DAMP-PROOFING

C/W PLATON DRAINAGE LAYER CW 15 LBS BUILDING PAPER
 300MM REINFORCE POURED CONC. TO 100MM ABOVE GRADE 200MM REINFORCE CONC. W/BRICK EDGE - 300X900 REINFORCED POURED CONSTRIP FOOTING WITH SHEAR KEY ON UNDISTURBED SOIL



EXTERIOR STONE WALL ASSEMBLY (TOTAL R-VALUE 34)

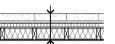

- 1" X 4" WOOD STRAPPING - ICE & WATER SHIELD BLUESKIN 2" RIGID INSULATION - TYVEK - ³/₄" SHEATING - 3" SHEATING - 38x140mm WOOD STUDS @ 400mm O.C. C/W R-34 BATT INSULATION - 6mil POLYETHYLENE VAPOR VARRIER - 13mm GYPSUM BOARD TAPED AND FINISHES

- RENASSAINCE STONE SIDING



- 6" X 🖁" CAPECOD WOOD SIDING - 1" X 4" WOOD STRAPPING - ICE & WATER SHIELD BLUESKIN 2" RIGID INSULATION - 3 SHEATING -4 3HEATH WOOD STUDS @ 400mm O.C. -38x140mm WOOD STUDS @ 400mm O.C. -6MI POLYETHYLENE VAPOR VARRIER

P2 > TYPICAL TOILET PARTITION(PLUMBING) ASSEMBLY

EXTERIOR WOOD SIDING ASSEMBLY

- 13mm GYPSUM BOARD TAPED AND FINISHES > TYPICAL INTERIOR PARTITION ASSEMBLY



- ½" G.W.B. TAPED AND FINISHED READY FOR PAINT - 38x140mm WOOD STUDS @ 400mm O.C. C/W R-34 BATT INSULATION 6mil POLYETHYLENE VAPOR VARRIER $-\frac{1}{2}$ " GYPSUM BOARD TAPED AND FINISHES



 $-\frac{1}{2}$ " G.W.B. TAPED AND FINISHED READY FOR PAINT - 2 - 38x140mm WOOD STUDS @ 400mm O.C. C/W R-34 BATT INSULATION - 6mil POLYETHYLENE VAPOR VARRIER 1 GYPSUM BOARD TAPED AND FINISHES

FLOOR ASSEMBLY:

F1 BASEMENT FLOOR ASSEMBLY: (TOTAL R-VALUE 10)

100MM POURED CONCRETE WITH MACHINE TROWELED FINISH 6MIL POLY V.B. 50MM DOW "SM" BLUE RIGID INSUL (R-10) 200MM DEEP 19MM CLEAR STONE

\langle F2 \rangle GARAGE FLOOR ASSEMBLY:

100MM POURED CONCRETE WITH MACHINE TROWELED FINISH WITH 1% SLOPE TOWARDS

200MM DEEP 19MM CLEAR STONE



SELECTED FLOOR FINISH 20MM T&G OSB SHEATING GLUED AND SCREWED TO JOINTS
PRE-ENG. FLOOR JOISTS AS SPEC. 19X89MM STRAPPING @406MM O.C. 13MM DRYWALL TAPED & FINISHED TO UNDER SIDE OF JOIST READY FOR PAINT PROVIDE SOUND PROOFING BETWEEN FLOORS



ZOMM 1 KB OSB SHEATING GLUED AND SCREWED TO JOINTS
PRE-ENG, FLOOR JOISTS AS SPEC. WITH ROXUL
BATT INSULATION (R-22)
6MIL POLYETHYLENE
50MM RIGID FOAM INSULATION (R-10) 19X89MM STRAPPING @ 406MM O.C. & 13MM DRYWALL TAPED &FINISHED TO UNDER SIDE OF JOIST READY FOR PAINT



DECK, PORCH SUSPENDED CONC. SLAB ASSEMBLY: 150 MM SUSPENDED CONC. SLAB 15MM @300 O.C. E.W. 15M DOWELS INTO FOPUNDATION WALL @ 300MM

O.C. 300MM BOTTOM COVER SEE DRAWING SS2 2 FOR REINFORCEMENT PLAN 100MM RIGID FOAM

ROOF ASSEMBLY:

R1 - ROOF - WITH ATTIC TYP. (TOTAL R-VALUE 50)

STEEL ROOF VICWEST SUPERVIC OR EQUAL STEEL ROOF VICWEST SUPERVIC OR EQUAL
19X89MM WOOD STRAPPING
15 LBS BUILDING PAPER W/"GRACE" ICE & WATER
SHIELD EAVES PROTECTION FOR 1830 MM ON
FLOOR VALLEYS FOR FULL LENGHT OF VALLEY
AND FULL PERIMETER OF THE ROOF TO 915 MM
PAST EXTERIOR WALL FACE FACE
13MM EXTERIOR GRADE OSB SHEATING W/
H-CLIPS BETWEEN JOISTS
ENG. WOOD JOISTS W/ BLOWN INSULATION (R-50)
WOOD JOISTS W/ ROUL BATT INSULATION (R-22)
6MM POL YETHYL FOR VAPOUR BABRIER

6MM POLYETHYLENE VAPOUR BARRIER 19X89 MM WOOD STRAPPING @ 600 MM O.C. 13MM GYPSUM WALL BOARD

R2 - FLAT ROOF


ROOFING MEMBRANE ICE & WATER SHIELD ³/₄" T&G PLYWOOD 2"X10" WOOD @16" O/C ³/₄" T&G PLYWOOD

R3 - ALUMINUM FASCIA ASSEMBLY:

TWO PLY STEPPED PREFINISHED METAL FASCIA 38X235MM OR 38X185MM FRAME RIBBON - CW VENTED ALUMINUM SOFFIT
305MM PAST EXTERIOR WALL FACE (UP ROOF SLOPED)

D- DOORS:

ALL DOORS TO BE NEW AND COMPLETE WITH

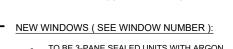





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CONSULTANTS:

Private Residence

66 Chippewa, Nepean Ottawa, Ontario

TERRACE FLOOR PLAN

DATE: November 2020 **SCALE:** 1:60 XXX PROJ. #: **DRAWN BY:** VR

SHEET NUMBER:


CHECKED BY:

REVISION: 01

DATE : 10.18.2021





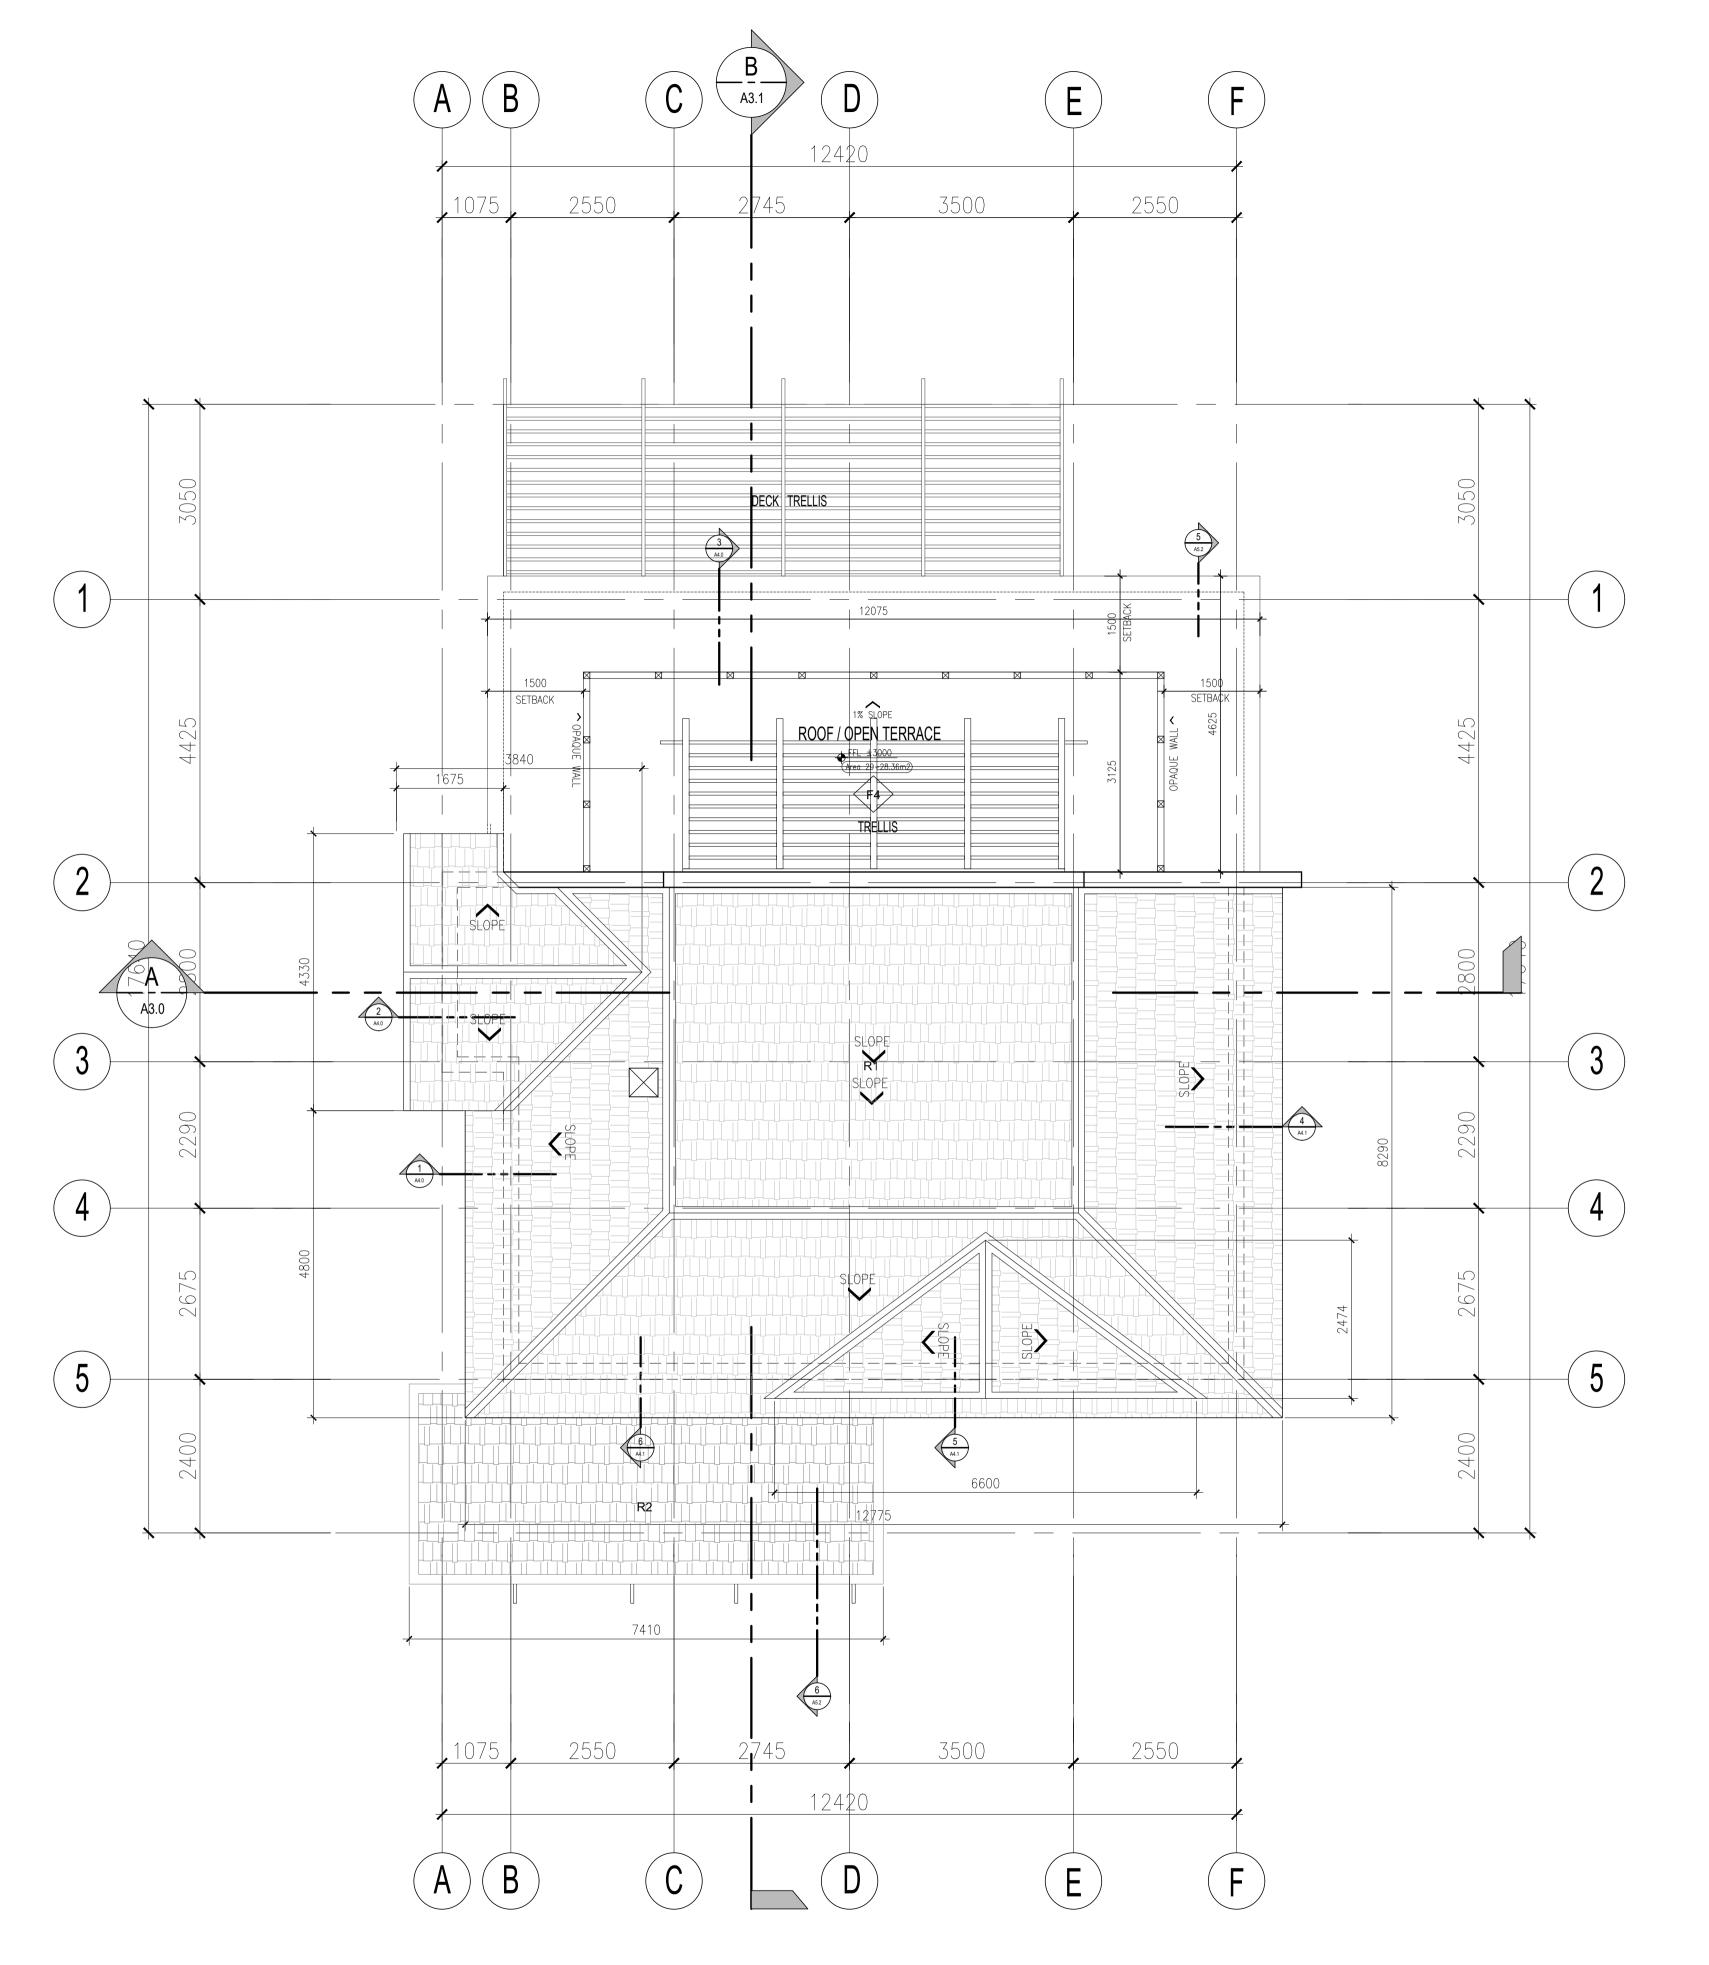


CONSTRUCTION ASSEMBLIES:

WALL ASSEMBLY:



EXTERIOR WALL TYPE ASSEMBLY: (AT FOUNDATION WALL)

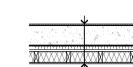


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- 50mm R-10 RIGID INSULATION W/ TAPE JOINTS

- 25mm SPACE TO BACK OF STUDS - 38x140mm WOOD STUDS @ 400mm O.C. C/W R-22 BATT INSULATION - 6mil POLYETHYLENE VAPOR VARRIER - 13mm GYPSUM BOARD TAPED AND FINISHES



EXTERIOR WALL TYPE ASSEMBLY: (AT FOUNDATION WALL)

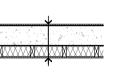


- PARGING TO 100mm BELOW GRADE
CONCTRETE W/ PLATON DRAINAGE LAYER
- 250mm REINFORCED POURED CONC. WALL
- 300x900 REINFORCED POURED CONC. STRIP
FOOTING WITH SHEAR KEY ON UNDISTURBED SOIL. - 38x100mm WOOD STUDS @ 400mm O.C. C/W R-22 BATT INSULATION - 6mil POLYETHYLENE VAPOR VARRIER - 13mm GYPSUM BOARD TAPED AND FINISHES



FOUNDATION WALL ASSEMBLY W/ STONE:

90MM STONE VENEER TBD

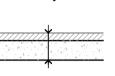


- 90MM GIONE VEHICLE TED - 25MM AIR SPACE - STEEL MASONRY TIES TBD - PARGING TO 100MM BELOW GRADE C/W BITUMINOUS DAMP-PROOFING

C/W PLATON DRAINAGE LAYER CW 15 LBS BUILDING PAPER
 300MM REINFORCE POURED CONC. TO 100MM ABOVE GRADE 200MM REINFORCE CONC. W/BRICK EDGE - 300X900 REINFORCED POURED CONSTRIP FOOTING WITH SHEAR KEY ON UNDISTURBED SOIL



EXTERIOR STONE WALL ASSEMBLY (TOTAL R-VALUE 34)

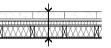

- 1" X 4" WOOD STRAPPING - ICE & WATER SHIELD BLUESKIN 2" RIGID INSULATION - TYVEK - ³/₄" SHEATING - 3" SHEATING - 38x140mm WOOD STUDS @ 400mm O.C. C/W R-34 BATT INSULATION - 6mil POLYETHYLENE VAPOR VARRIER - 13mm GYPSUM BOARD TAPED AND FINISHES

- RENASSAINCE STONE SIDING



- 6" X 🖁" CAPECOD WOOD SIDING - 1" X 4" WOOD STRAPPING - ICE & WATER SHIELD BLUESKIN 2" RIGID INSULATION - TYVEK - ¾" SHEATING -4 3HEATH WOOD STUDS @ 400mm O.C. -38x140mm WOOD STUDS @ 400mm O.C. -6MI POLYETHYLENE VAPOR VARRIER

EXTERIOR WOOD SIDING ASSEMBLY

> TYPICAL INTERIOR PARTITION ASSEMBLY



- ½" G.W.B. TAPED AND FINISHED READY FOR PAINT - 38x140mm WOOD STUDS @ 400mm O.C. C/W R-34 BATT INSULATION - 6mil POLYETHYLENE VAPOR VARRIER $-\frac{1}{2}$ " GYPSUM BOARD TAPED AND FINISHES

- 13mm GYPSUM BOARD TAPED AND FINISHES



 $-\frac{1}{2}$ " G.W.B. TAPED AND FINISHED READY FOR PAINT - 2 - 38x140mm WOOD STUDS @ 400mm O.C. C/W R-34 BATT INSULATION - 6mil POLYETHYLENE VAPOR VARRIER 1 GYPSUM BOARD TAPED AND FINISHES

FLOOR ASSEMBLY:

F1 BASEMENT FLOOR ASSEMBLY: (TOTAL R-VALUE 10)

100MM POURED CONCRETE WITH MACHINE TROWELED FINISH 6MIL POLY V.B. 50MM DOW "SM" BLUE RIGID INSUL (R-10) 200MM DEEP 19MM CLEAR STONE



 \langle F2 \rangle GARAGE FLOOR ASSEMBLY:

100MM POURED CONCRETE WITH MACHINE TROWELED FINISH WITH 1% SLOPE TOWARDS 200MM DEEP 19MM CLEAR STONE



 \langle F3 angle ground, second and terrace floor assembly:

SELECTED FLOOR FINISH 20MM T&G OSB SHEATING GLUED AND SCREWED TO JOINTS
PRE-ENG, FLOOR JOISTS AS SPEC.
19X89MM STRAPPING @406MM O.C.
13MM DRYWALL TAPED & FINISHED TO UNDER
SIDE OF JOIST READY FOR PAINT
PROVIDE SOUND PROOFING BETWEEN FLOORS



SELECTED FLOOR FINISH 20MH 7LG OSB SHEATING GLUED AND SCREWED ZOMM 1 KB OSB SHEATING GLUED AND SCREWED TO JOINTS
PRE-ENG, FLOOR JOISTS AS SPEC. WITH ROXUL
BATT INSULATION (R-22)
6MIL POLYETHYLENE
50MM RIGID FOAM INSULATION (R-10) 19X89MM STRAPPING @ 406MM O.C. & 13MM DRYWALL TAPED &FINISHED TO UNDER SIDE OF JOIST READY FOR PAINT



 \langle F5 \rangle <u>DECK, PORCH SUSPENDED CONC. SLAB ASSEMBLY:</u> 150 MM SUSPENDED CONC. SLAB 15MM @300 O.C. E.W. 15M DOWELS INTO FOPUNDATION WALL @ 300MM

O.C. 300MM BOTTOM COVER SEE DRAWING SS2 2 FOR REINFORCEMENT PLAN 100MM RIGID FOAM

ROOF ASSEMBLY:

R1 - ROOF - WITH ATTIC TYP.

(TOTAL R-VALUE 50)

STEEL ROOF VICWEST SUPERVIC OR EQUAL STEEL ROOF VICWEST SUPERVIC OR EQUAL
19X89MM WOOD STRAPPING
15 LBS BUILDING PAPER W/"GRACE" ICE & WATER
SHIELD EAVES PROTECTION FOR 1830 MM ON
FLOOR VALLEYS FOR FULL LENGHT OF VALLEY
AND FULL PERIMETER OF THE ROOF TO 915 MM
PAST EXTERIOR WALL FACE FACE
13MM EXTERIOR GRADE OSB SHEATING W/
H-CLIPS BETWEEN JOISTS
ENG. WOOD JOISTS W/ BLOWN INSULATION (R-50)
WOOD JOISTS W/ ROUL BATT INSULATION (R-22)
6MM POL YETHYL FOR VAPOUR BABRIER 6MM POLYETHYLENE VAPOUR BARRIER 19X89 MM WOOD STRAPPING @ 600 MM O.C. 13MM GYPSUM WALL BOARD

R2 - FLAT ROOF

ROOFING MEMBRANE ICE & WATER SHIELD ³/₄" T&G PLYWOOD 2"X10" WOOD @16" O/C ³/₄" T&G PLYWOOD

R3 - ALUMINUM FASCIA ASSEMBLY:

TWO PLY STEPPED PREFINISHED METAL FASCIA 38X235MM OR 38X185MM FRAME RIBBON - CW VENTED ALUMINUM SOFFIT
305MM PAST EXTERIOR WALL FACE (UP ROOF SLOPED) D- DOORS:

ALL DOORS TO BE NEW AND COMPLETE WITH

NEW WINDOWS (SEE WINDOW NUMBER): TO BE 3 DANE SEALED LINITS WITH ADO



200-1645 RUSSELL ROAD OTTAWA, ONTARIO K1G 4G5 T: 613.228.7190 F: 613.228.8690 ANGELOMSPADOLA@GMAIL.COM

ISSUED FOR CLIENTS REVIEW 2020 12 03 2 CLIENTS REVIEW FOR THE MEETING 2020 12 15 3 ISSUED FOR CLIENTS REVIEW 2020 12 17 4 ISSUED FOR PLANNERS COMMENTS 2020 12 21 5 ISSUED FOR PLANNERS COMMENTS 2021 01 19 6 ISSUED FOR CLIENTS APPROVAL 2021 03 23 7 ISSUED FOR COMMITTEE OF 2021 04 19

GENERAL NOTES:

ADJUSTMENT (COA)

THE CONTRACTOR SHALL CHECK AND VERIFY ALL DIMENSIONS AND REPORT ALL ERRORS AND OMISSIONS TO THE ARCHITECT FOR HIS WRITTEN PERMISSION BEFORE PROCEEDING WITH THE WORK. NOT FOR CONSTRUCTION UNLESS SIGNED

BY THE ARCHITECT. NOT TO BE SCALED OR REPRODUCED WITHOUT WRITTEN PERMISSION.

CONSULTANTS:

Private Residence

66 Chippewa, Nepean Ottawa, Ontario

ROOF PLAN

DATE: November 2020 **SCALE:** 1:60 XXX PROJ. #: **DRAWN BY:** VR

SHEET NUMBER:


CHECKED BY:

DATE : 10.18.2021

REVISION: 01





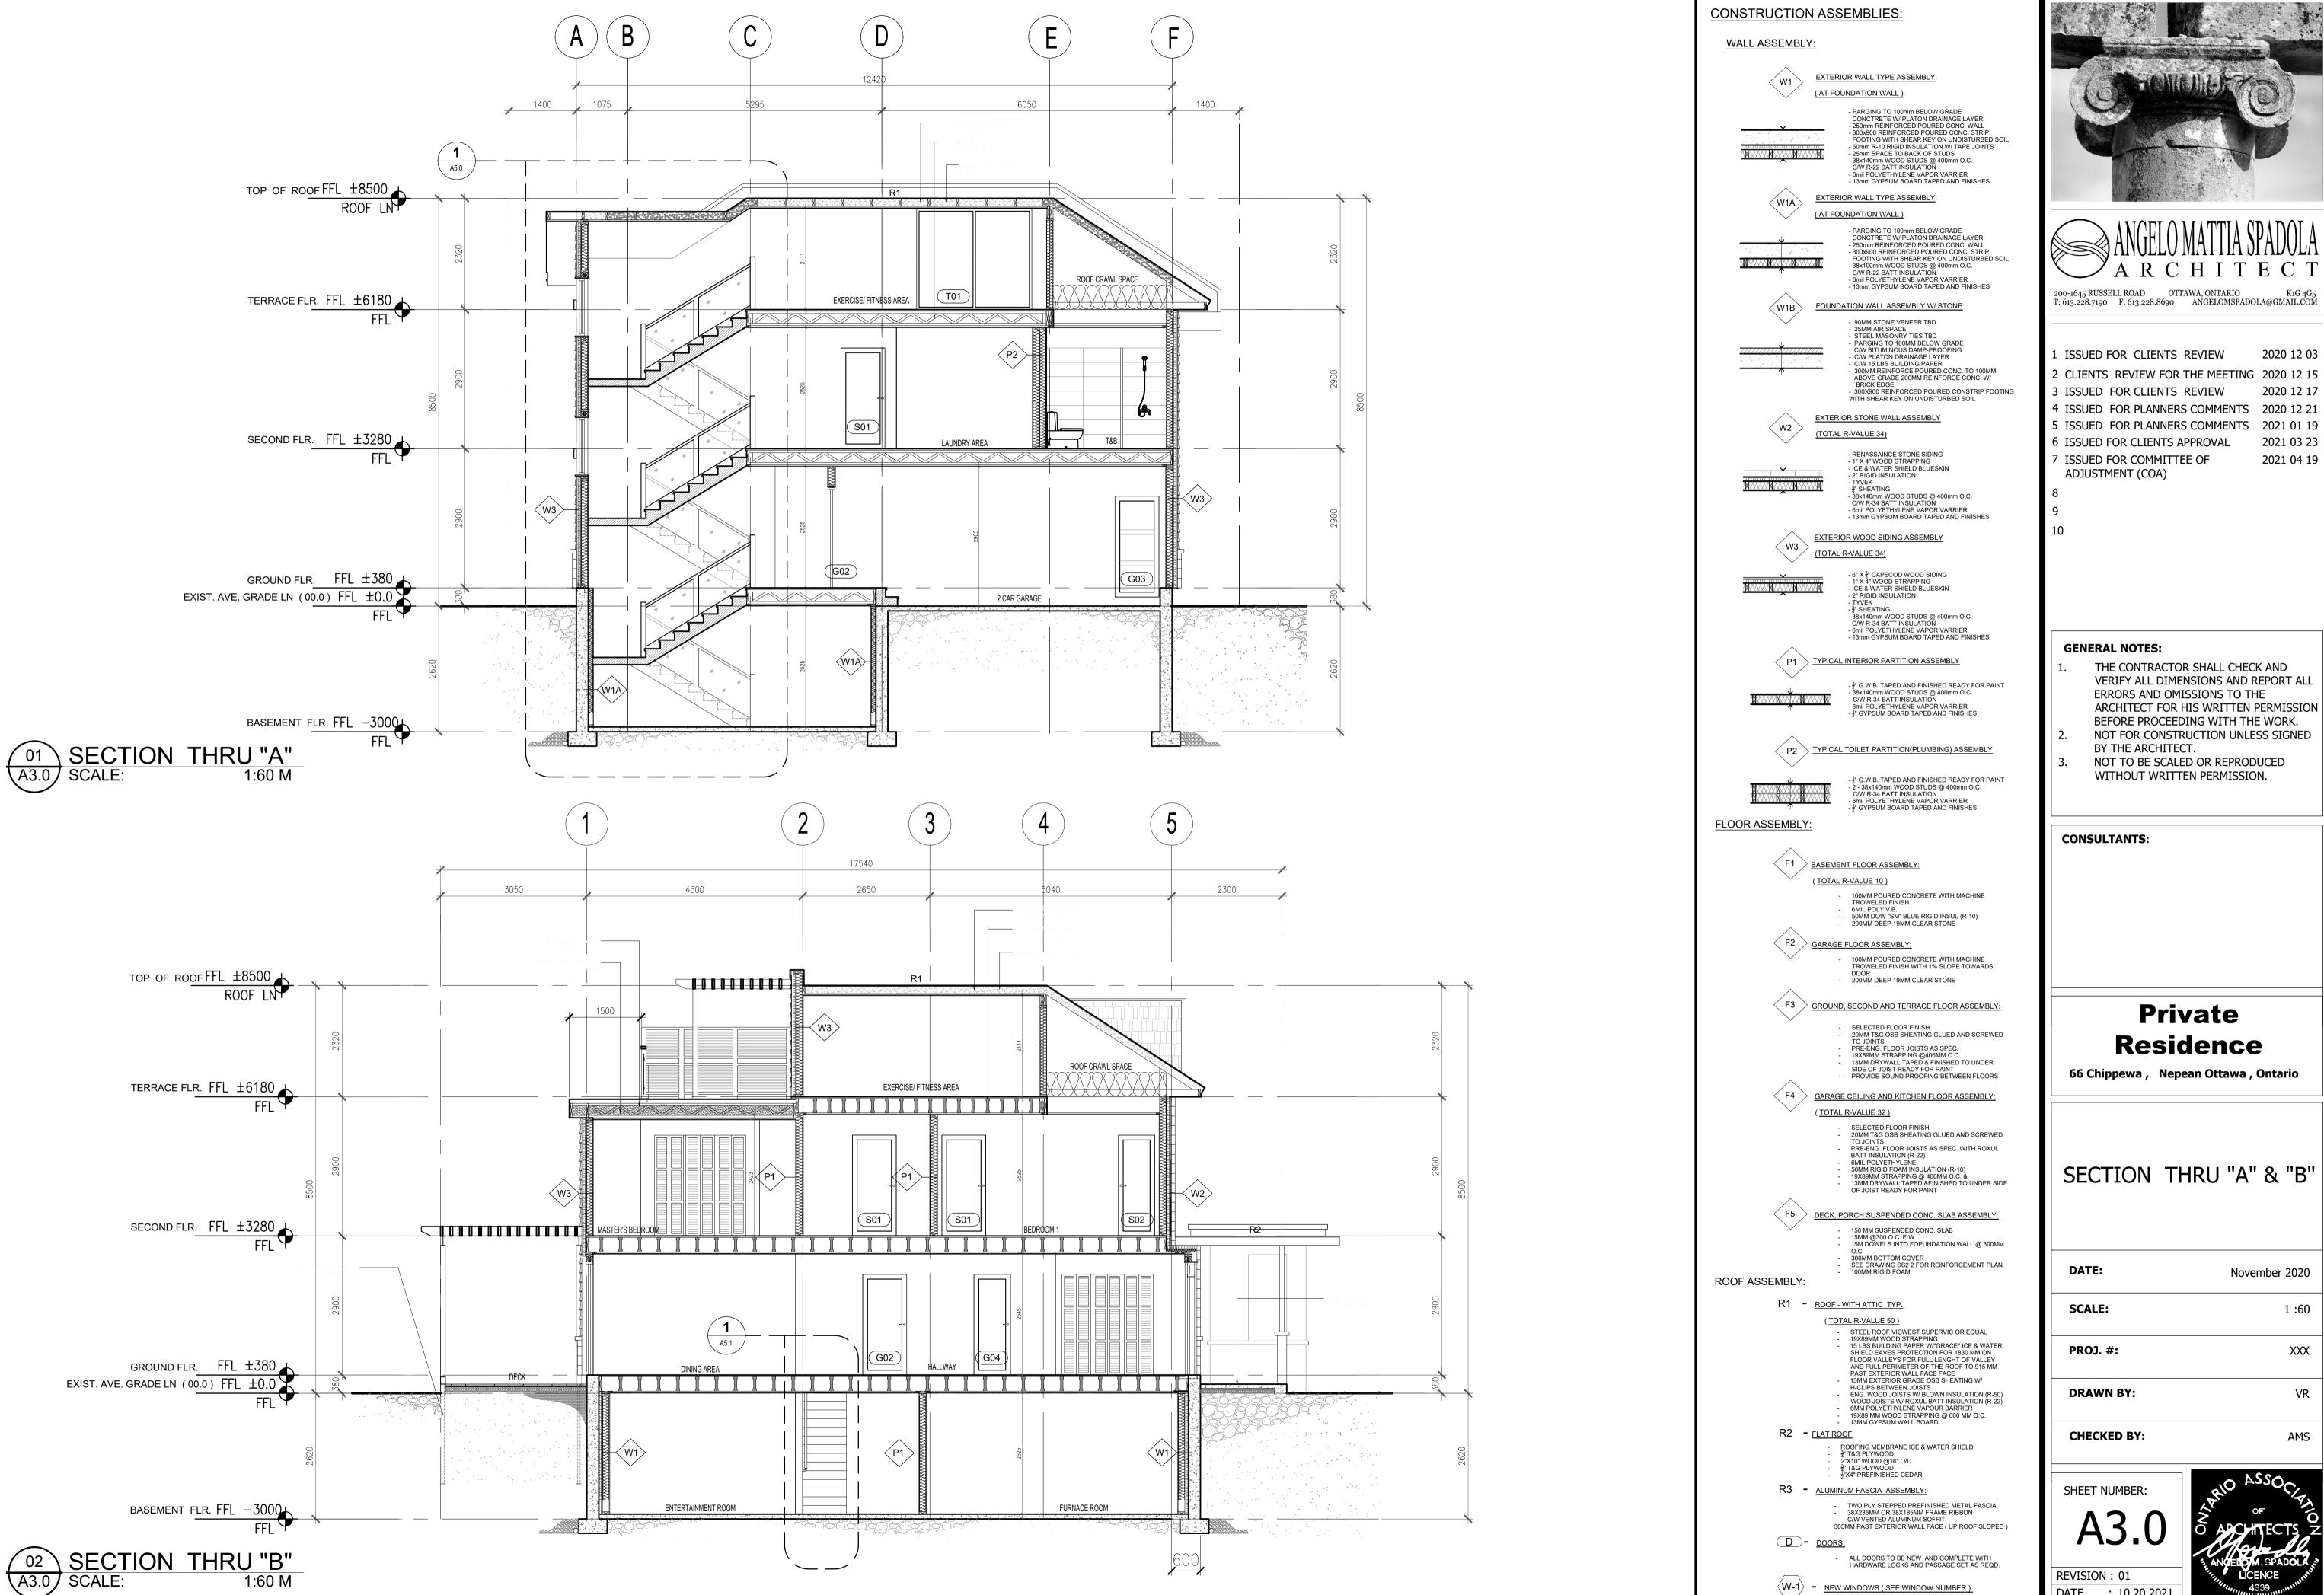

2020 12 17

DATE : 10.20.2021

TO BE 3-PANE SEALED UNITS WITH ARGON

